

**REGION OF PEEL
EMIL V. KOLB CENTRE
PEEL REGIONAL POLICE FACILITY
INTERIOR RENOVATION PROJECT**

180 DERRY ROAD EAST, MISSISSAUGA, ON L5T 2Y5



CLIENT
REGION OF PEEL

ARCHITECT / INTERIOR DESIGNER
NGA ARCHITECTS

STRUCTURAL ENGINEER
STEPHENSON ENGINEERING

MECHANICAL ENGINEER
EXP SERVICES INC.

ELECTRICAL ENGINEER
EXP SERVICES INC.

SECURITY / IT CONSULTANT
EXP SERVICES INC.

AUDIO / VISUAL CONSULTANT
EXP SERVICES INC.

QUANTITY SURVEYOR
ALPHA COST CONSULTANTS INC.

HARDWARE CONSULTANT
ASSA ABLOY OPENING SOLUTIONS

DRAWING LIST

ARCHITECTURAL

A001	DRAWING LIST, KEY PLAN, GENERAL NOTES AND DETAIL
A002	OVERALL BASEMENT,GROUND FLOOR, SECOND FLOOR & THIRD FLOOR PLAN
A003	BUILDING CODE SUMMARY
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A101	PARTIAL SECOND FLOOR & THIRD FLOOR PLAN-DEMOLITION
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A203	STC PLANS - NEW
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A501	INTERIOR ELEVATIONS BASEMENT FLOOR SHOWER WASHROOM
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A503	INTERIOR ELEVATIONS GROUND FLOOR/SECOND FLOOR WASHROOM
A504	INTERIOR ELEVATIONS SECOND/THIRD FLOOR WASHROOM
A505	INTERIOR ELEVATIONS THIRD FLOOR WASHROOM
A506	INTERIOR ELEVATIONS MILLWORK KEY PLANS
A507	INTERIOR ELEVATIONS MILLWORK DETAILS
A508	INTERIOR ELEVATIONS MILLWORK DETAILS
A509	INTERIOR ELEVATIONS MILLWORK DETAILS
A510	INTERIOR ELEVATIONS MILLWORK DETAILS
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A900	PHASING PLAN
A901	PHASING PLAN
	SAMPLE BOARD

STRUCTURAL

REFER TO STRUCTURAL DRAWINGS

MECHANICAL


REFER TO MECHANICAL DRAWINGS

ELECTRICAL

REFER TO ELECTRICAL DRAWINGS

ACCESSORIES LEGEND AND MOUNTING HEIGHTS SCHEDULE







NOTE:
1. THE DIMENSIONS ON THIS LEGEND TAKE PRECEDENT OVER ANY CONFLICTS WITHIN THE DRAWINGS.
2. PROVIDE ALL REQUIRED REINFORCING WITHIN PARTITION AS NECESSARY.

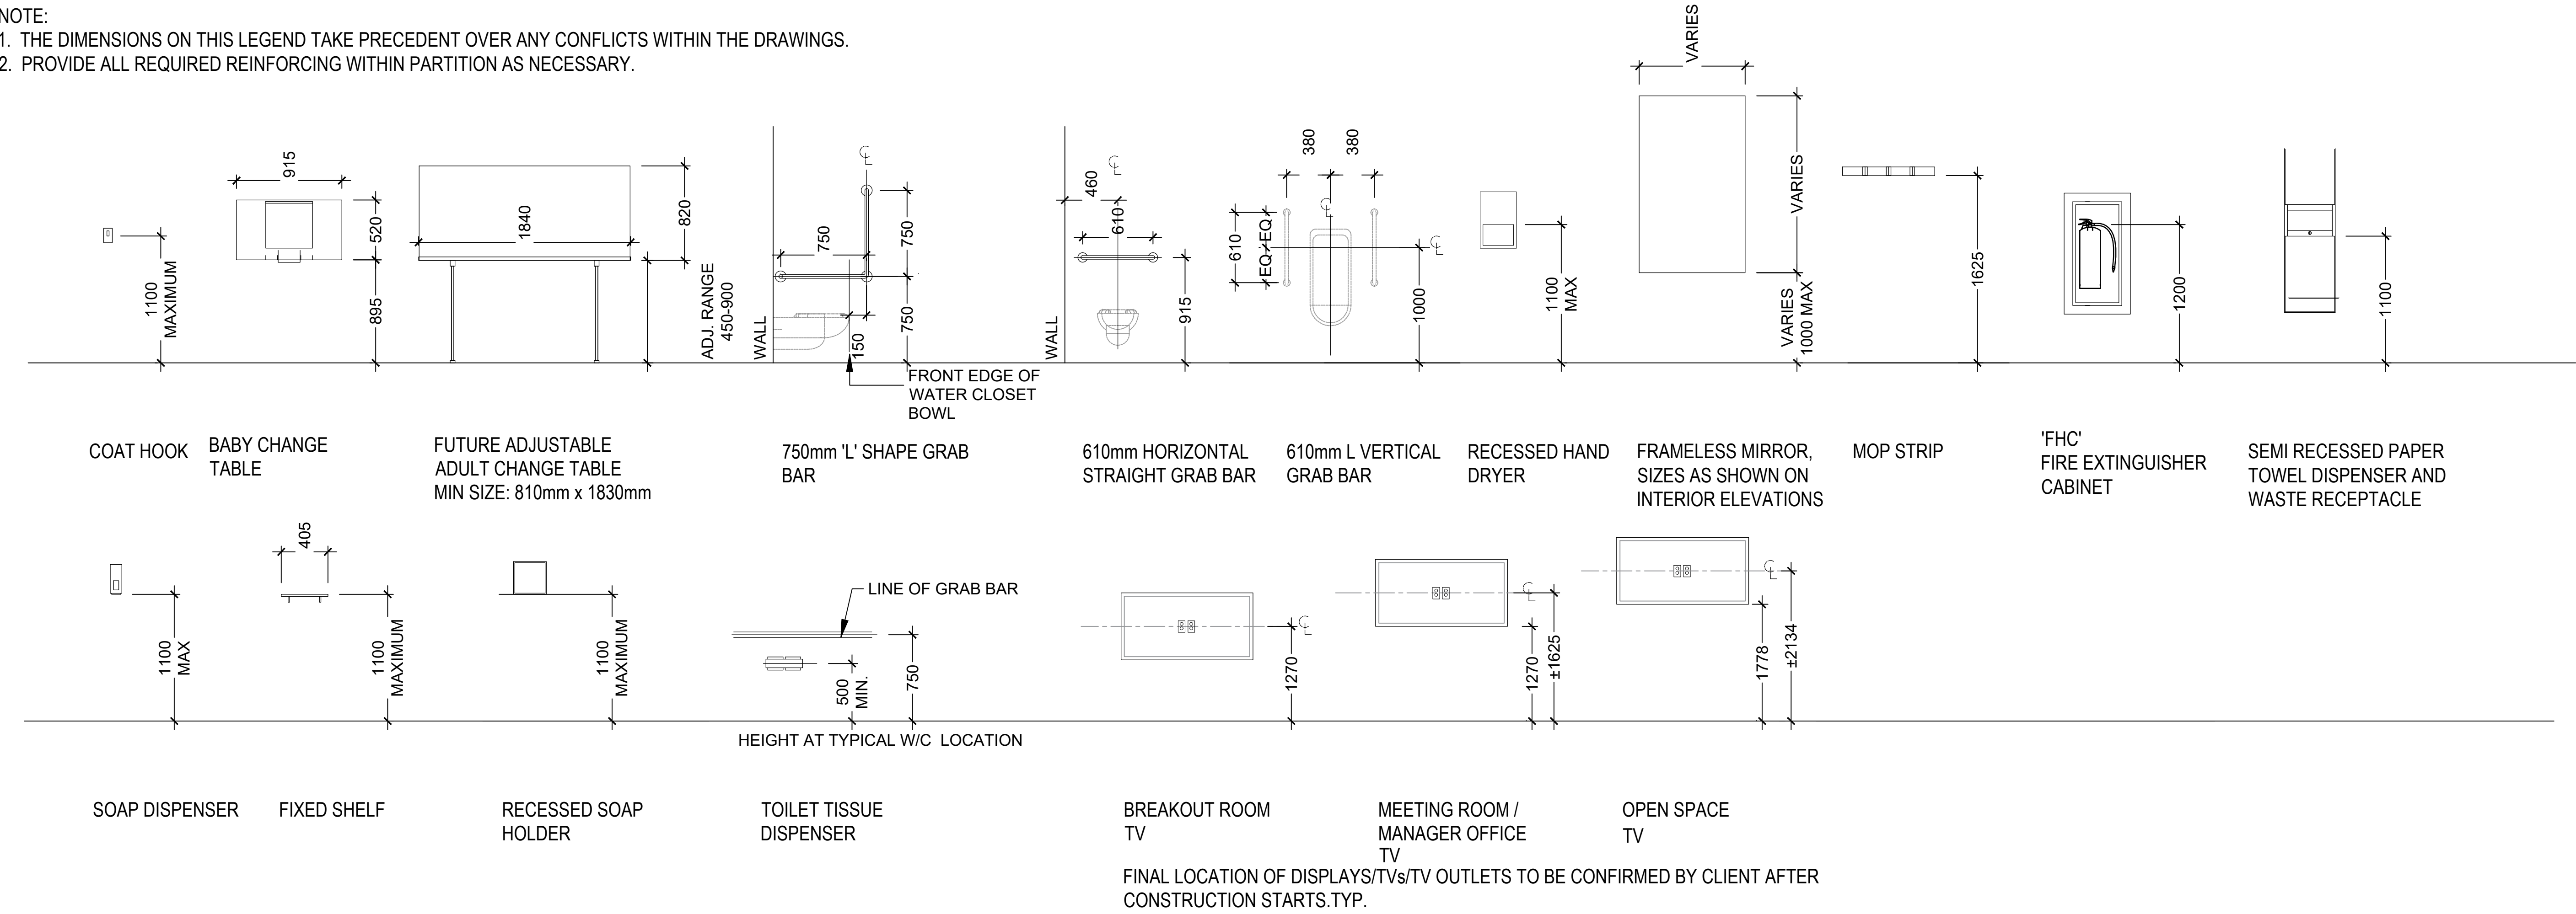




BACKING/REINFORCING SCHEDULE

GENERAL NOTES

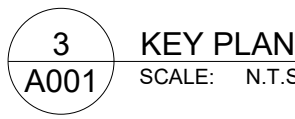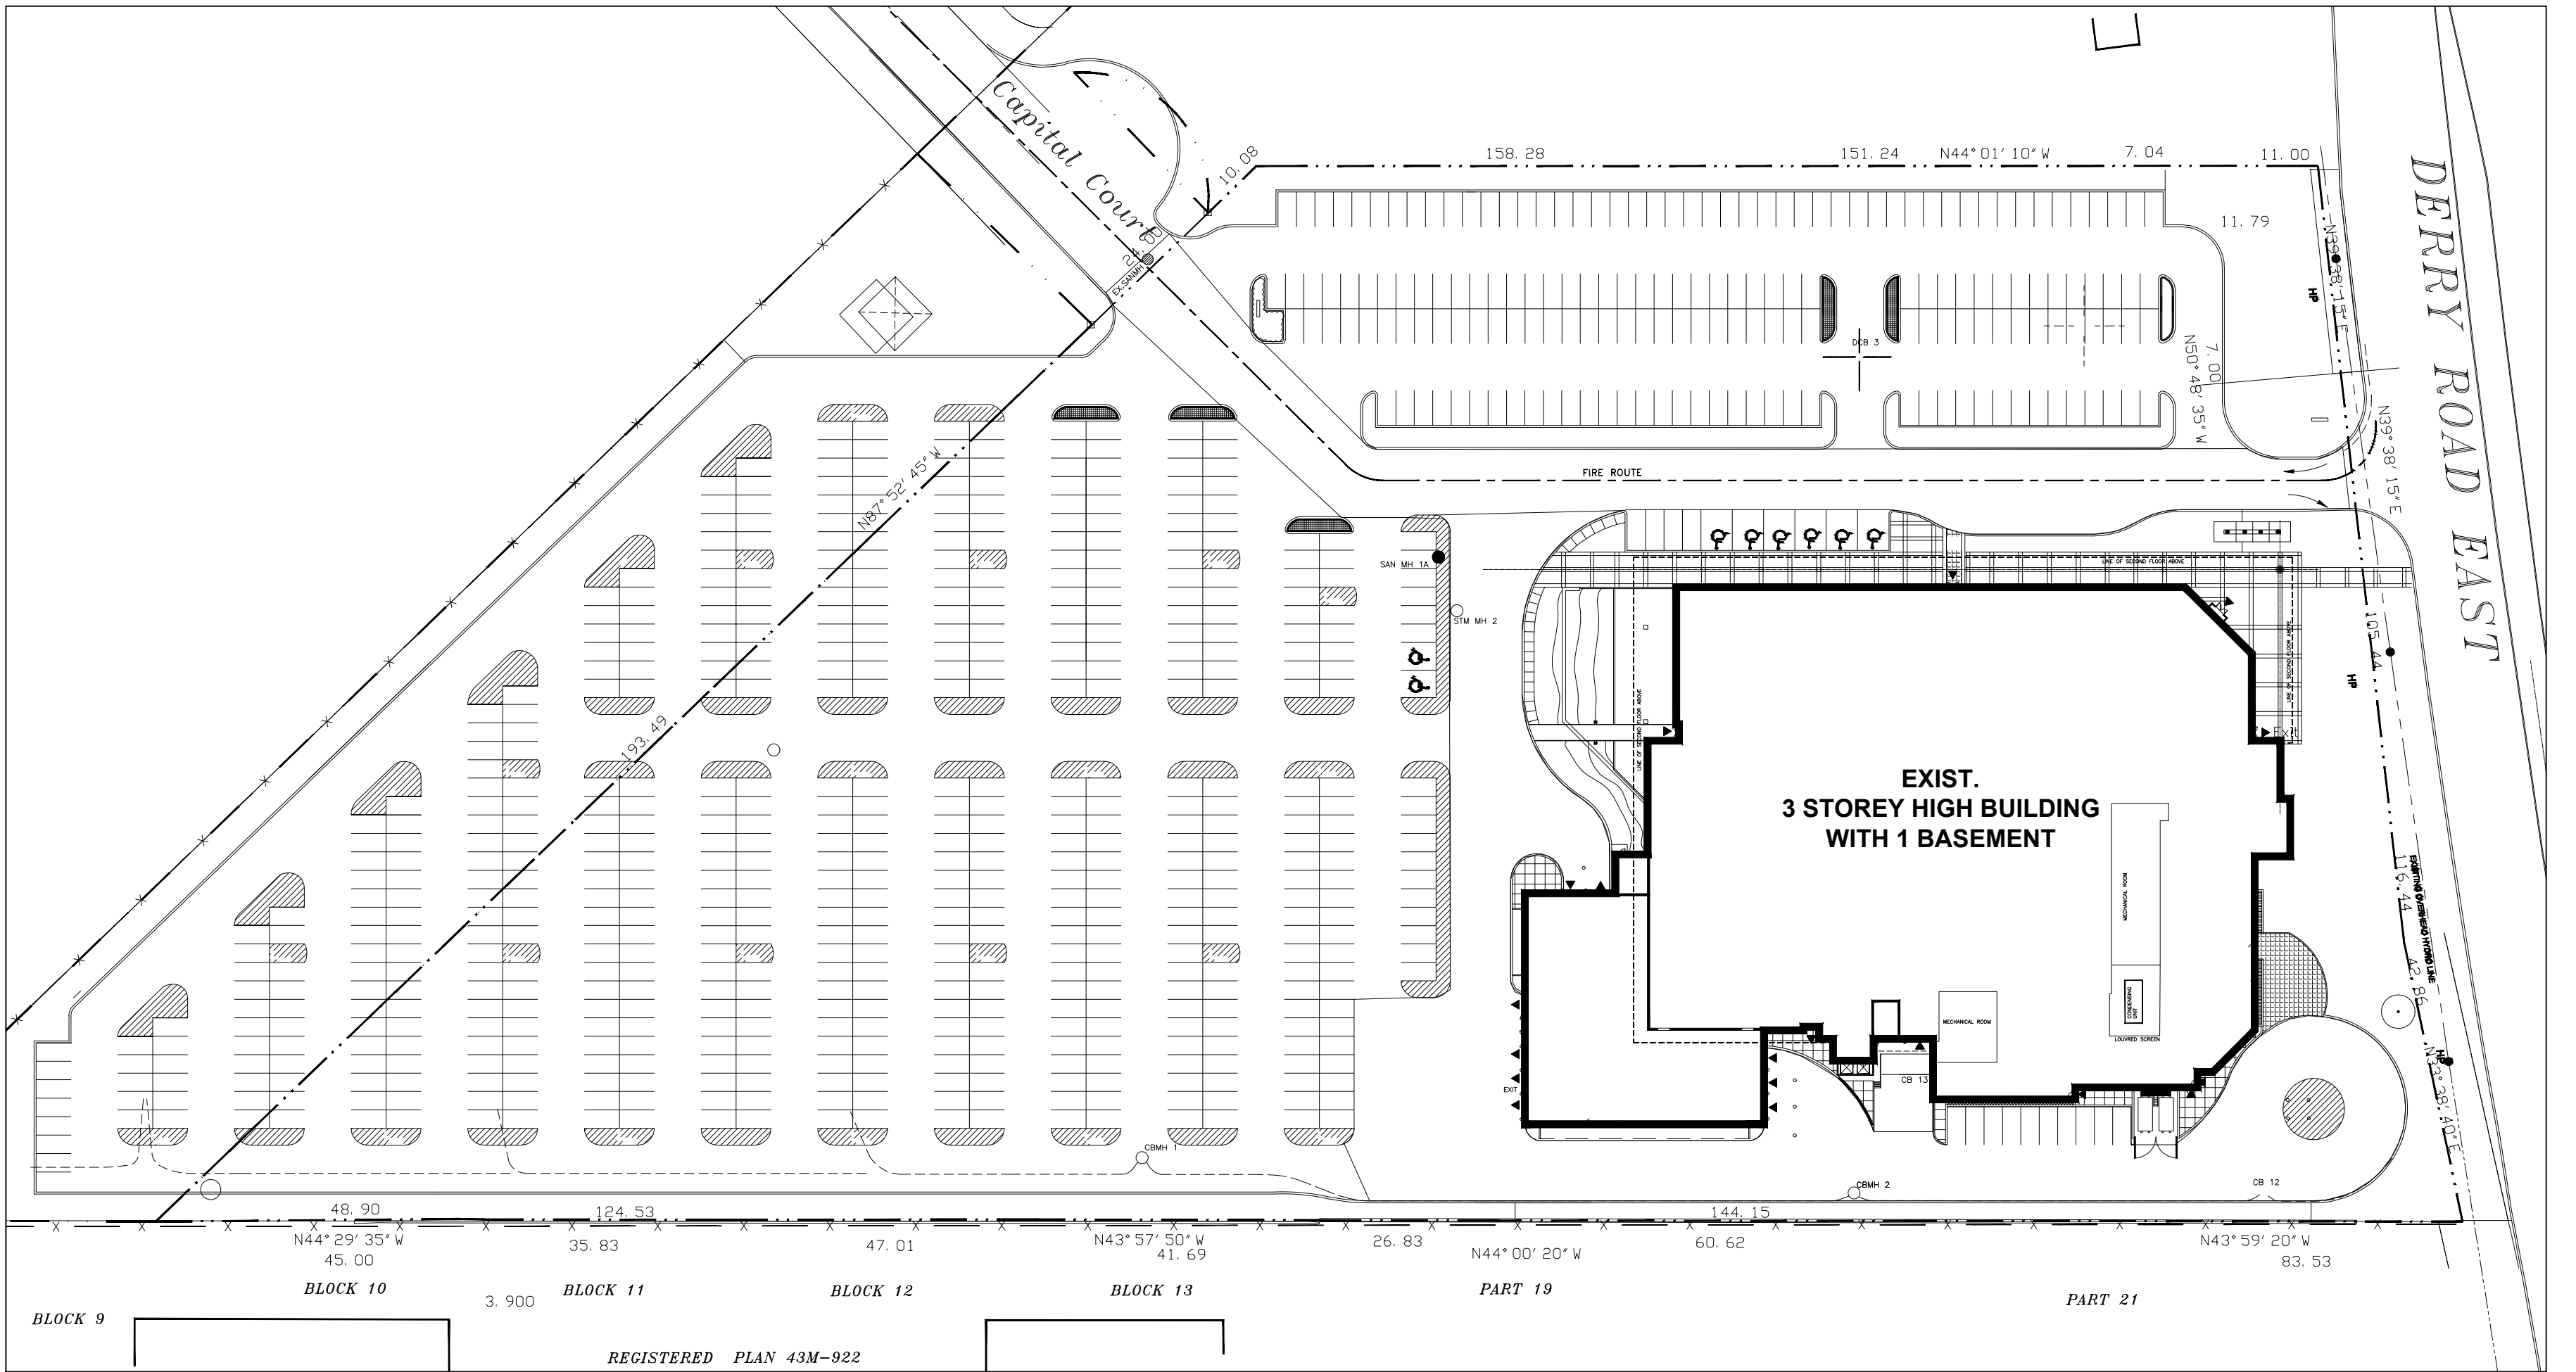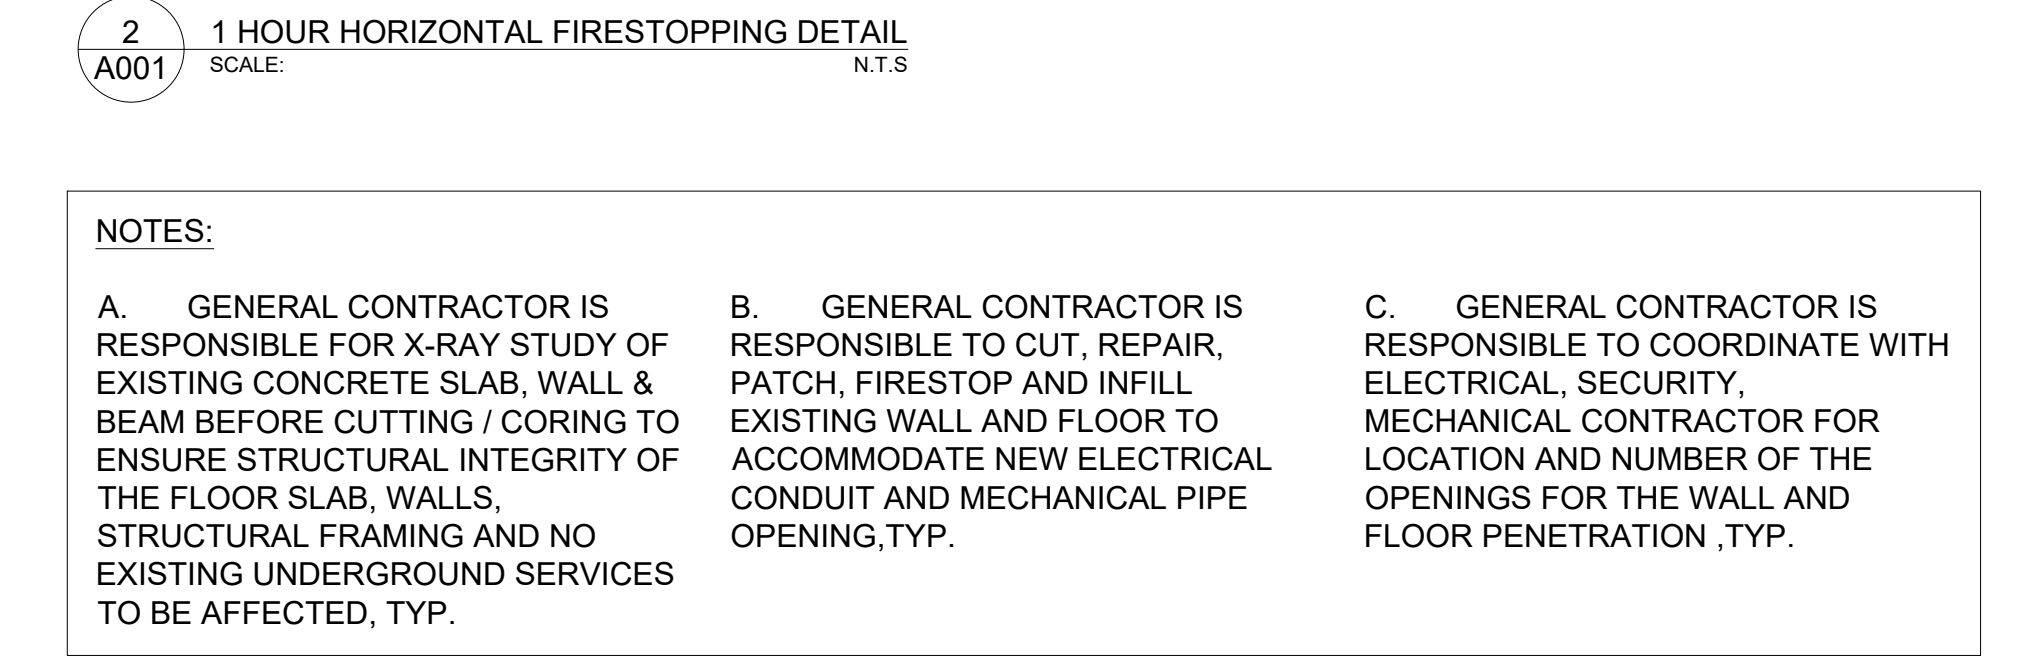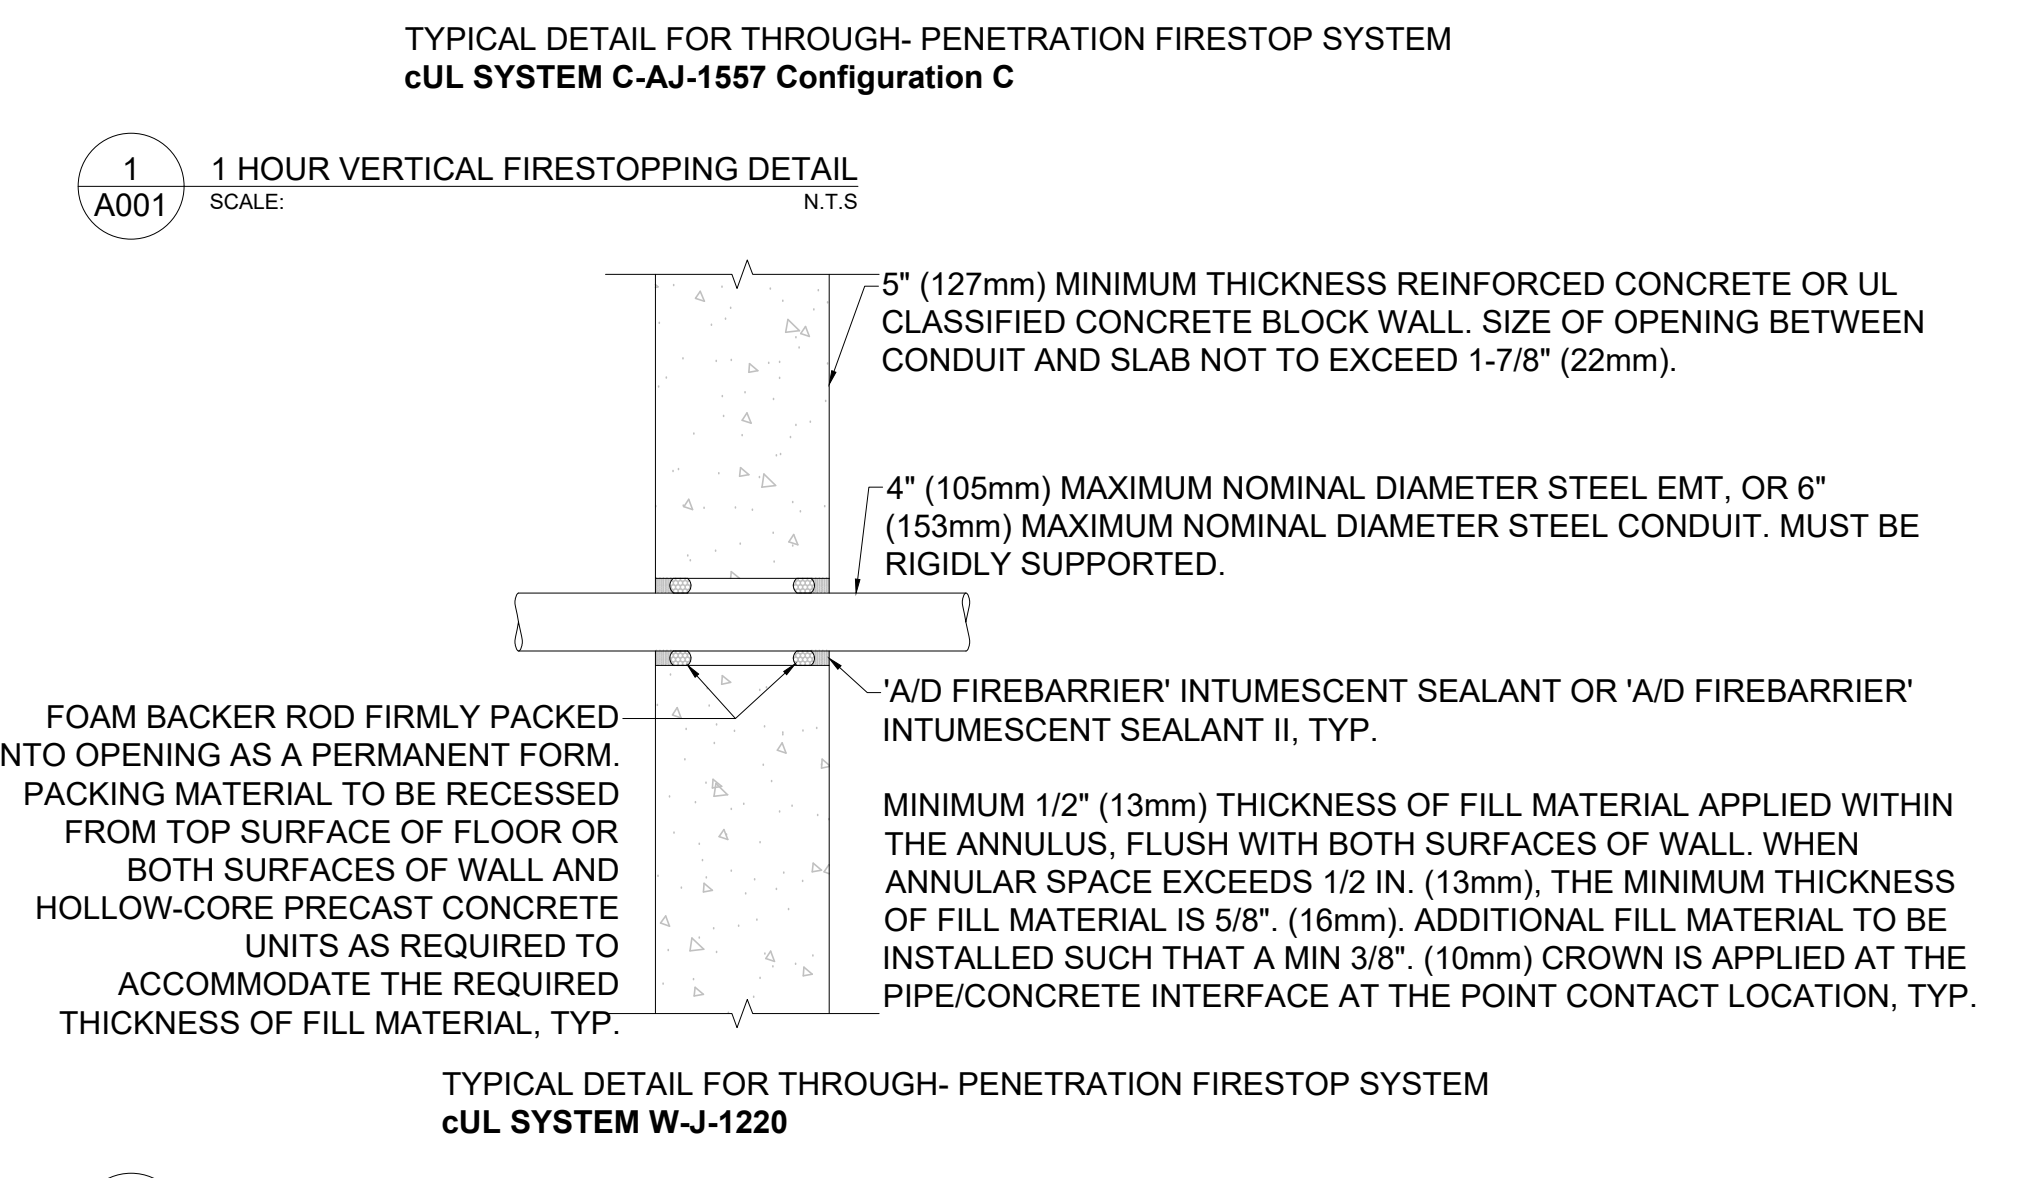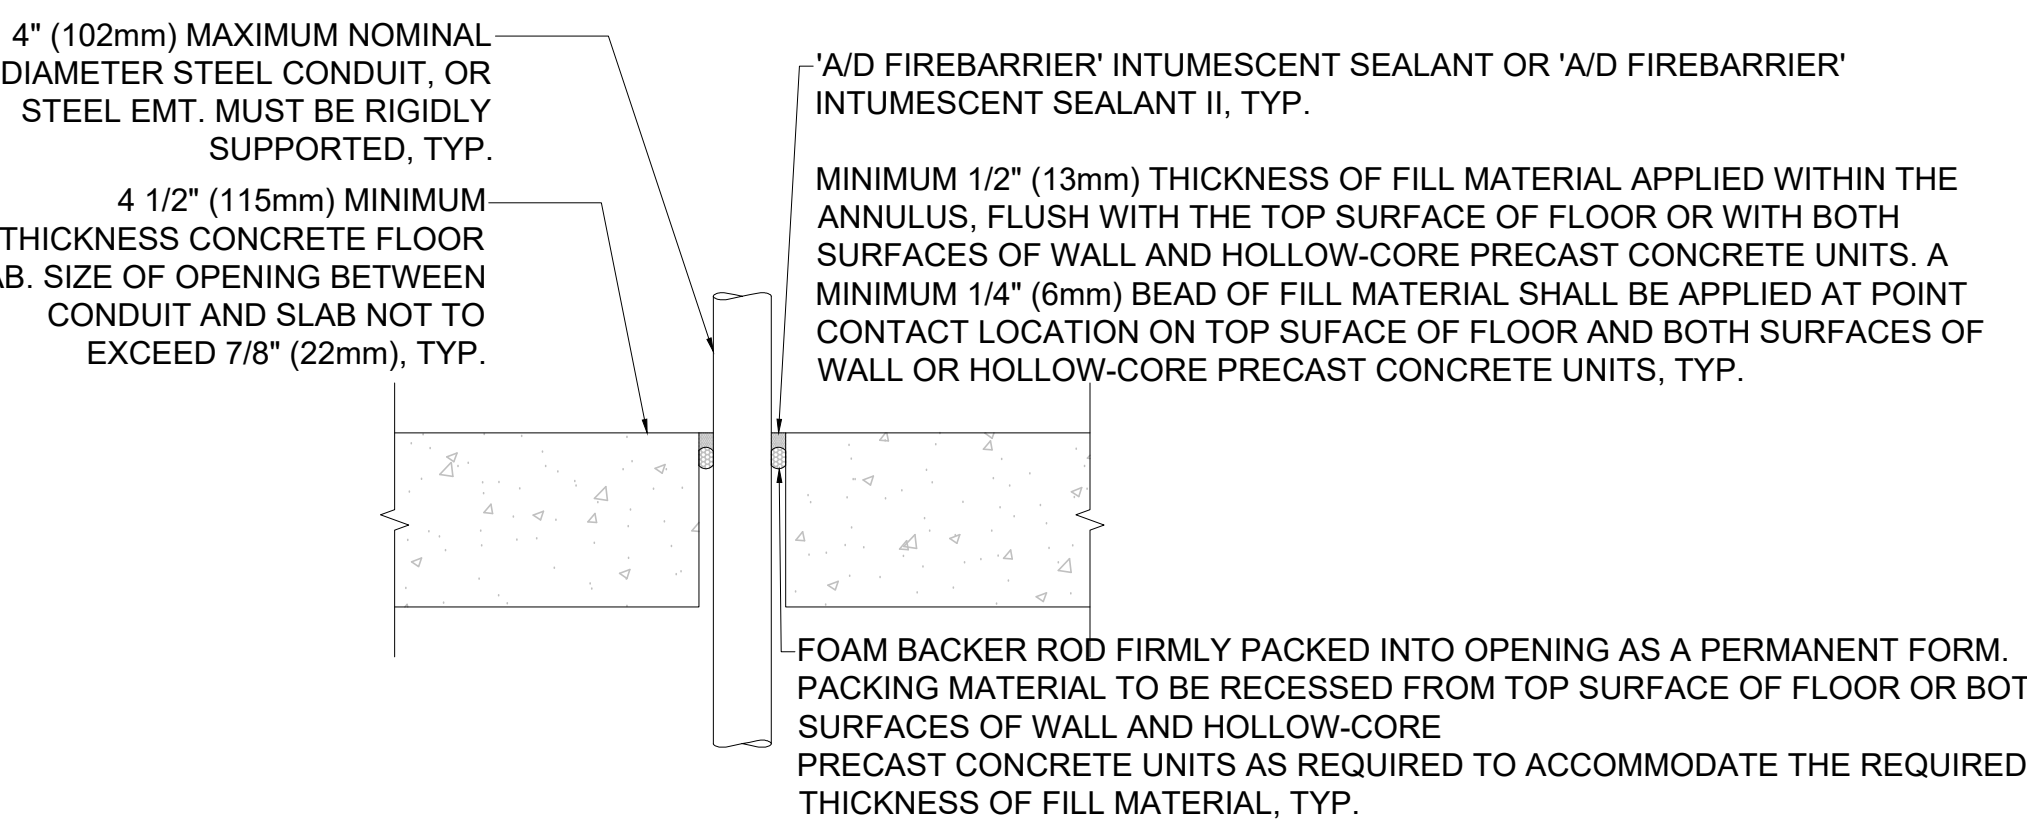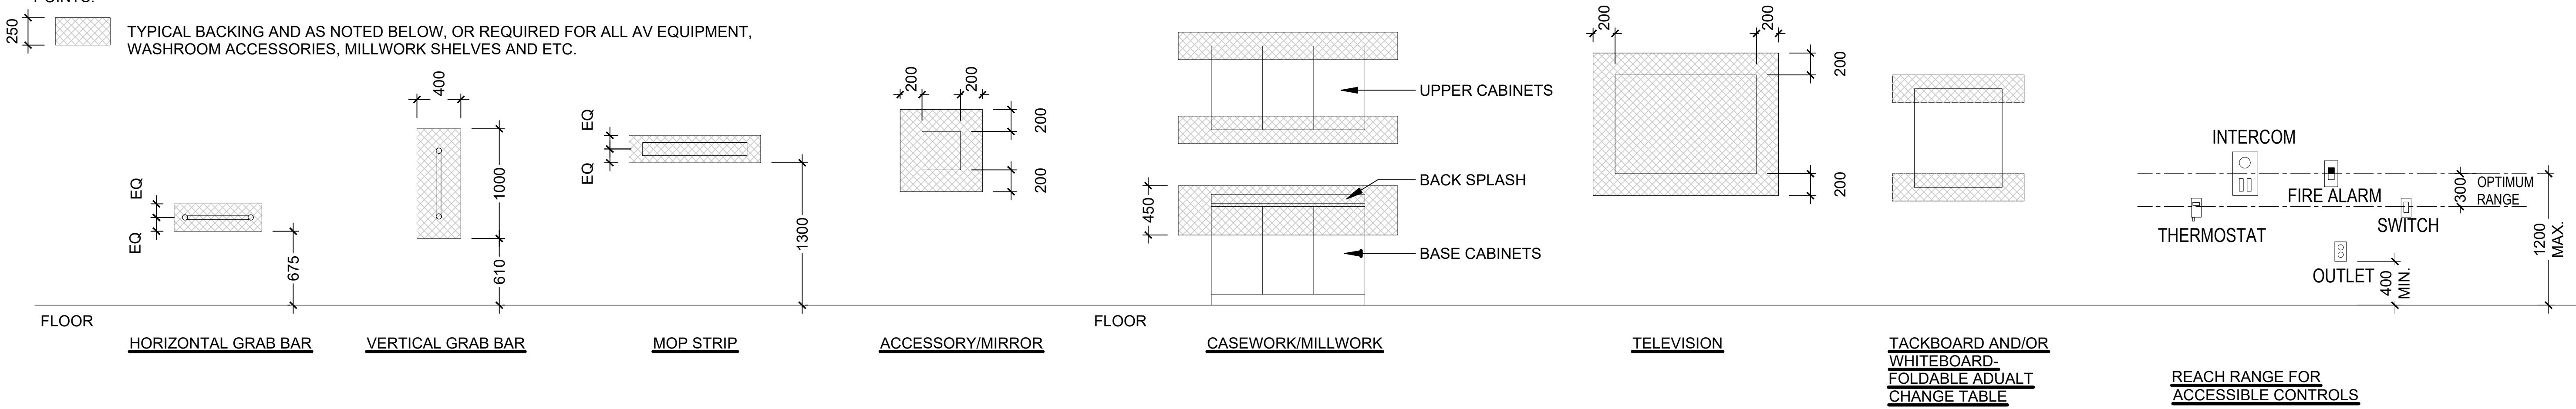- INDICATES LOCATION OF IN-WALL BACKING OF 1 LAYER 19mm PLYWOOD AND WOOD BLOCKING AND BRACING AS REQUIRED.
 - DIMENSIONED WIDTHS ARE MINIMUMS ONLY - EXTEND BACKING ONE STUD SPACE BEYOND EDGES OF ANCHOR POINTS.
- TYPICAL BACKING AND AS NOTED BELOW, OR REQUIRED FOR ALL AV EQUIPMENT, WASHROOM ACCESSORIES, MILLWORK SHELVES AND ETC.




5.	ISSUED FOR TENDER	2026.05.01
4.	ISSUED FOR BUILDING PERMIT	2026.04.08
3.	ISSUED FOR FINAL CLIENT REVIEW	2026.03.31
2.	ISSUED FOR PRELIMINARY REVIEW	2026.01.09
1.	ISSUED FOR DESIGN DEVELOPMENT CLIENT REVIEW	2026.10.24
NO.	DESCRIPTION	DATE
REVISIONS		
PROJECT		
 REGION OF PEEL		
EMIL V. KOLB CENTRE PEEL REGIONAL POLICE FACILITY INTERIOR RENOVATION PROJECT 180 DERRY ROAD EAST, MISSISSAUGA, ON L5T 2Y5		
 NCA ARCHITECTS		
The consultant shall check and verify all dimensions and report any discrepancies to the client. The client shall be responsible for any discrepancies which may exist in the drawing. Do not scale dimensions from the drawing. All dimensions shall be as shown on the drawing. All dimensions shall be in millimeters unless otherwise specified.		
STRUCTURAL CONSULTANT Stephenson Engineering MECHANICAL CONSULTANT EXP Services Inc. ELECTRICAL CONSULTANT EXP Services Inc.		
SHEET TITLE DRAWING LIST, SITE PLAN, GENERAL NOTES & DETAILS		
SHEET NO. A001	DRAWN BY CC	CHECKED RN
PROJECT NO.	SCALE	AS NOTED

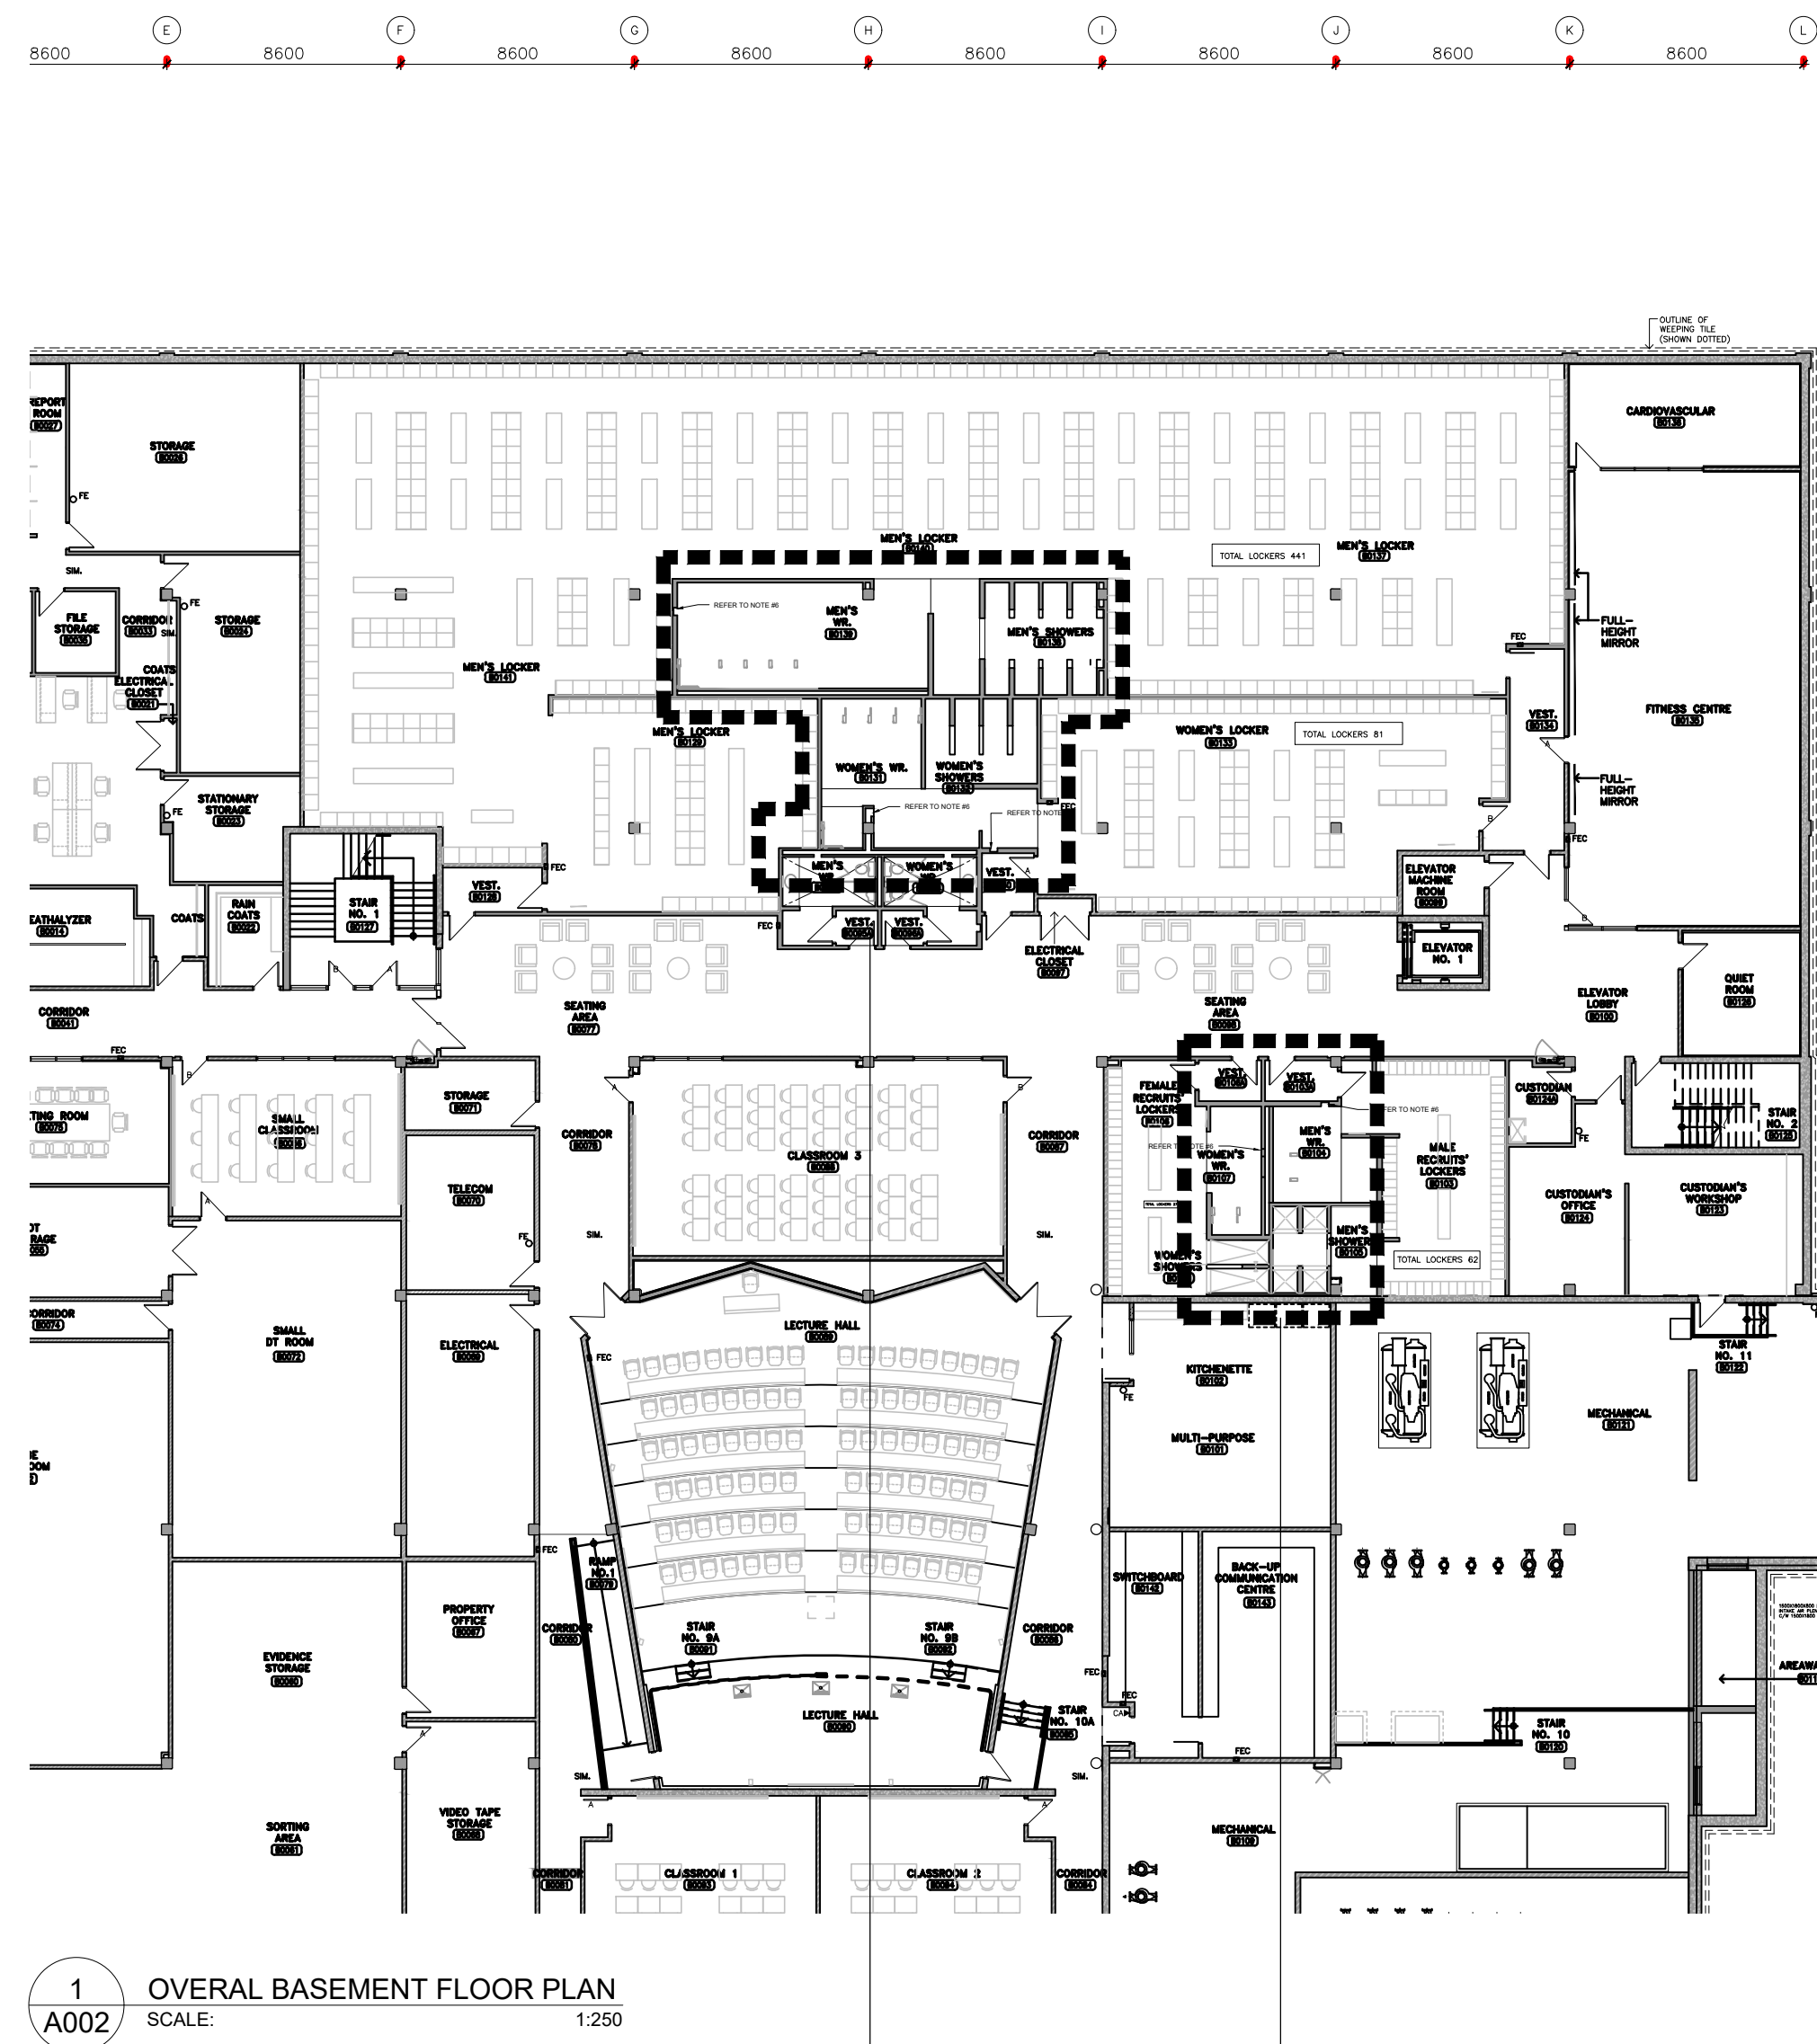

1 OVERALL BASEMENT FLOOR PLAN
SCALE: 1/250

1... 1... 1... 1... 1...
A100 A101 A200 A201 A300

1... 1... 1... 1... 1...
A100 A101 A200 A201 A300

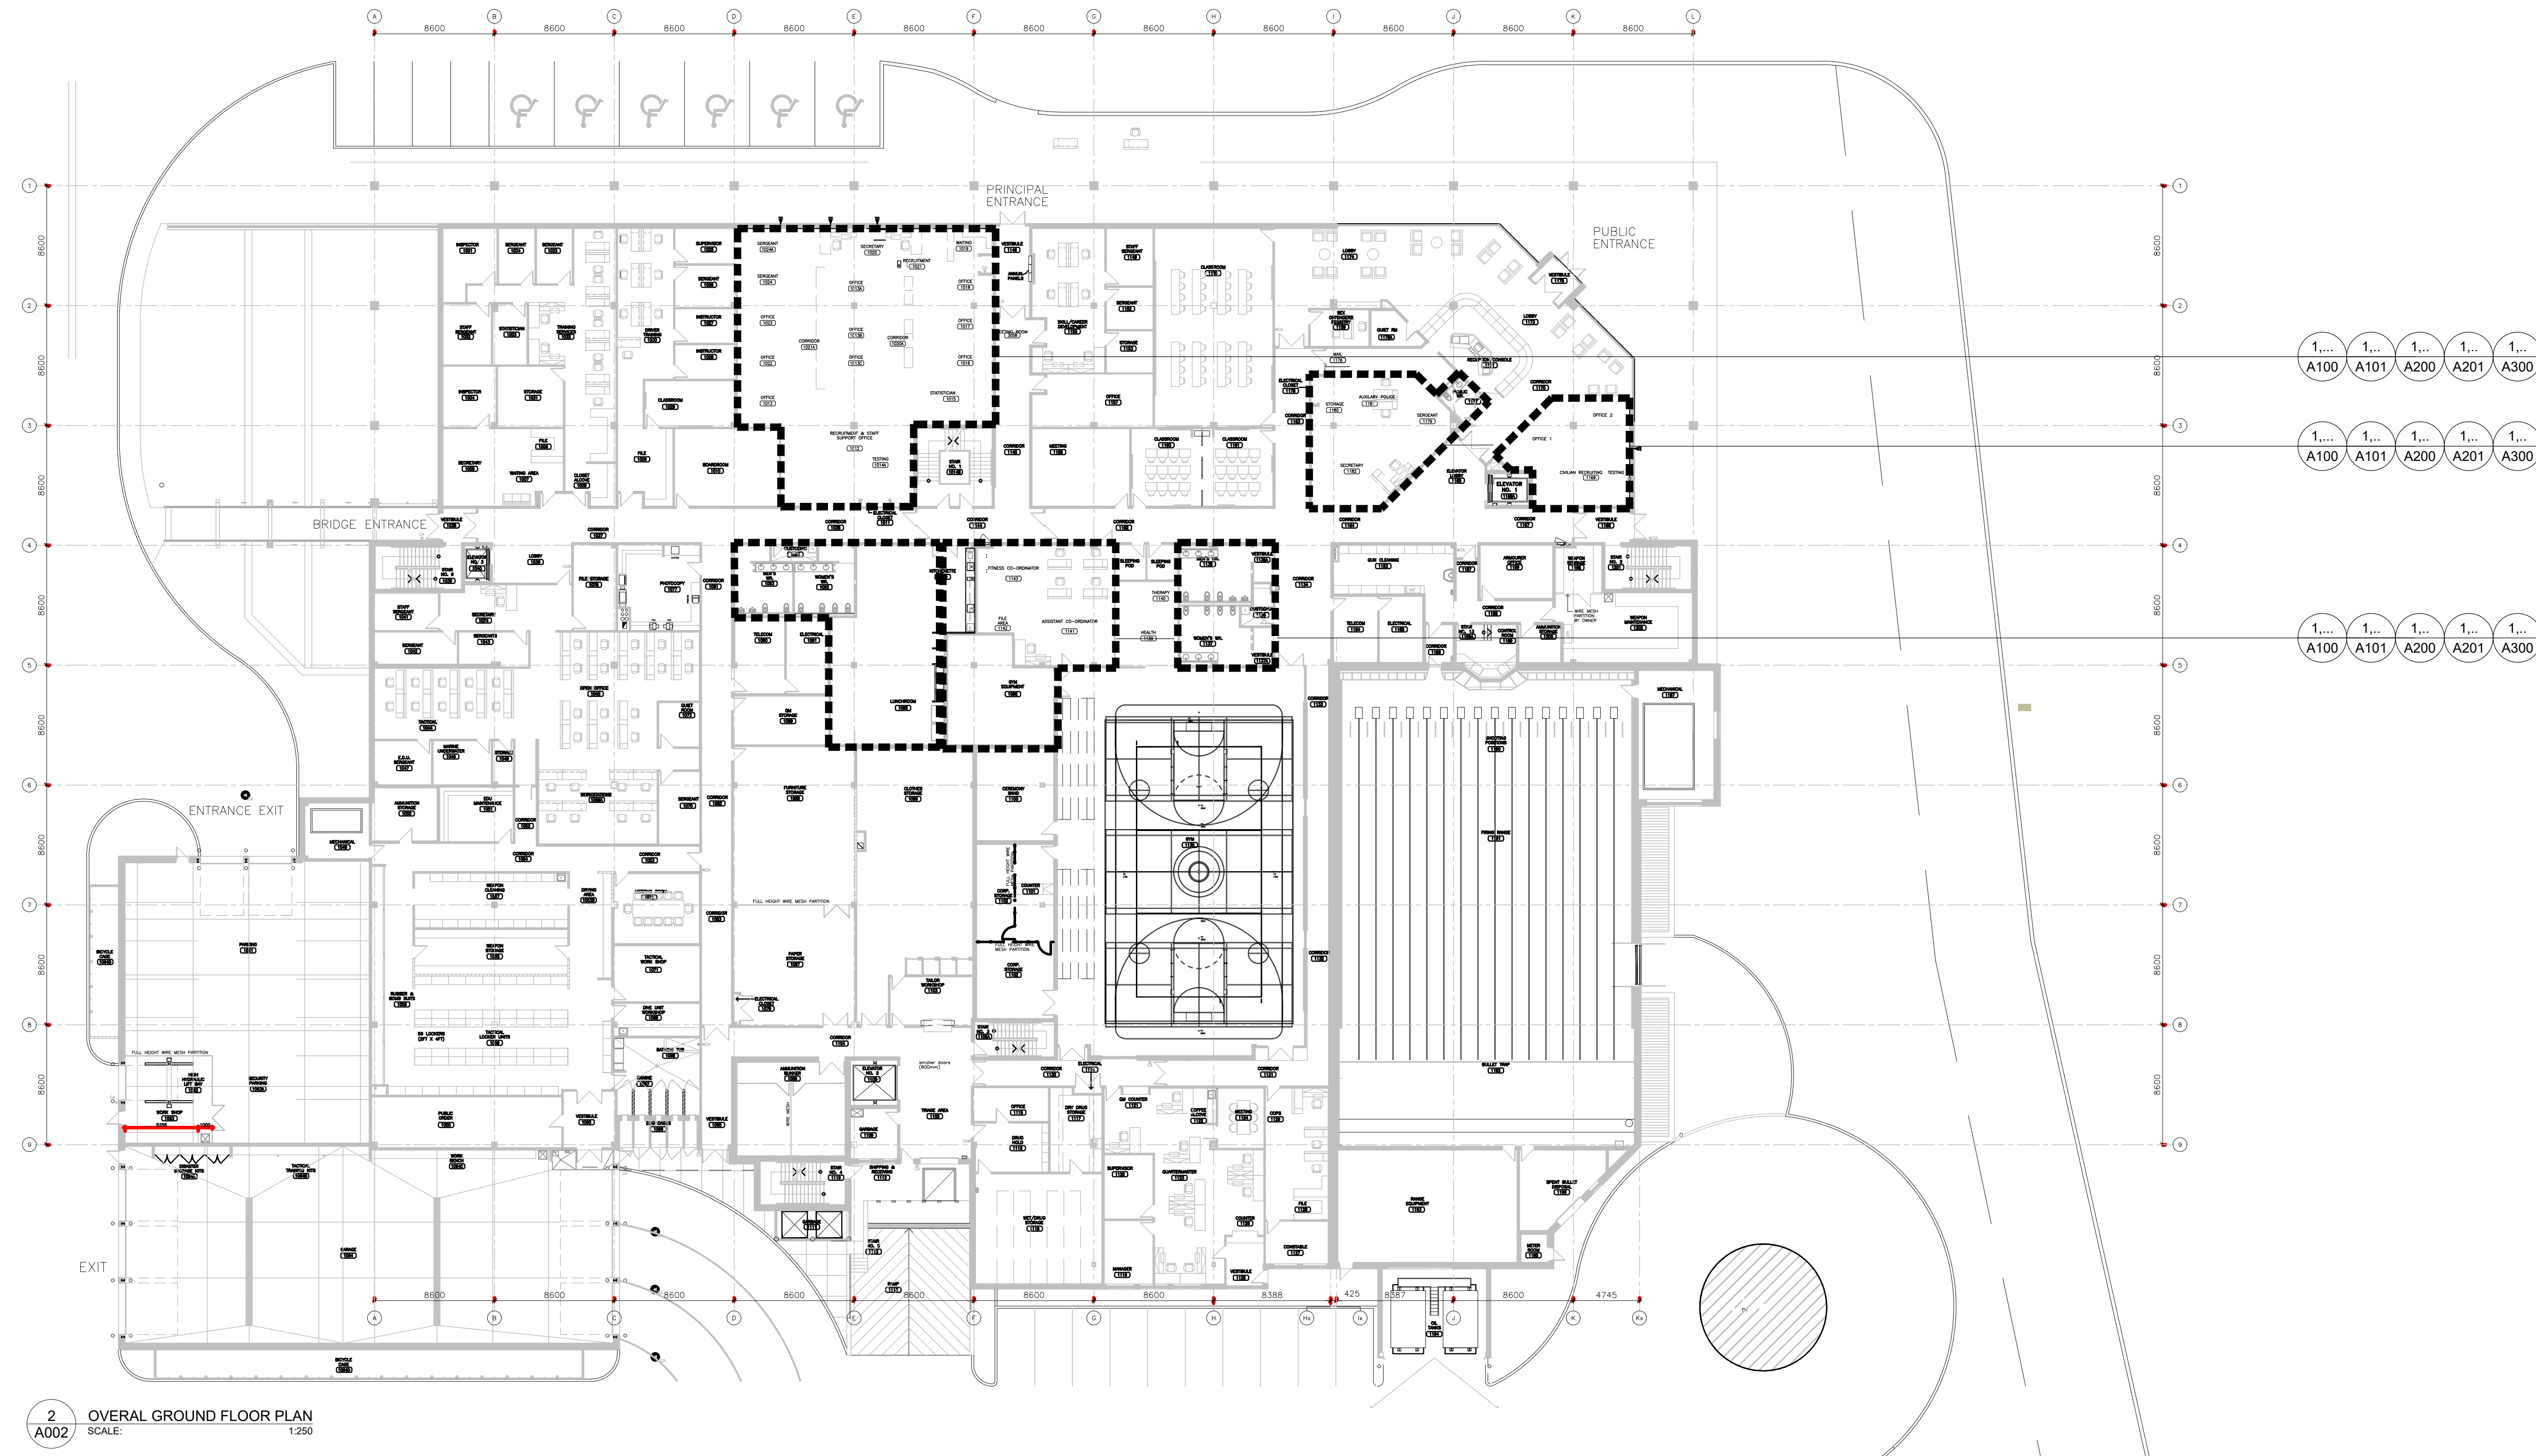


2 OVERALL GROUND FLOOR PLAN
SCALE: 1/250

1... 1... 1... 1... 1...
A100 A101 A200 A201 A300

1... 1... 1... 1... 1...
A100 A101 A200 A201 A300

1... 1... 1... 1... 1...
A100 A101 A200 A201 A300

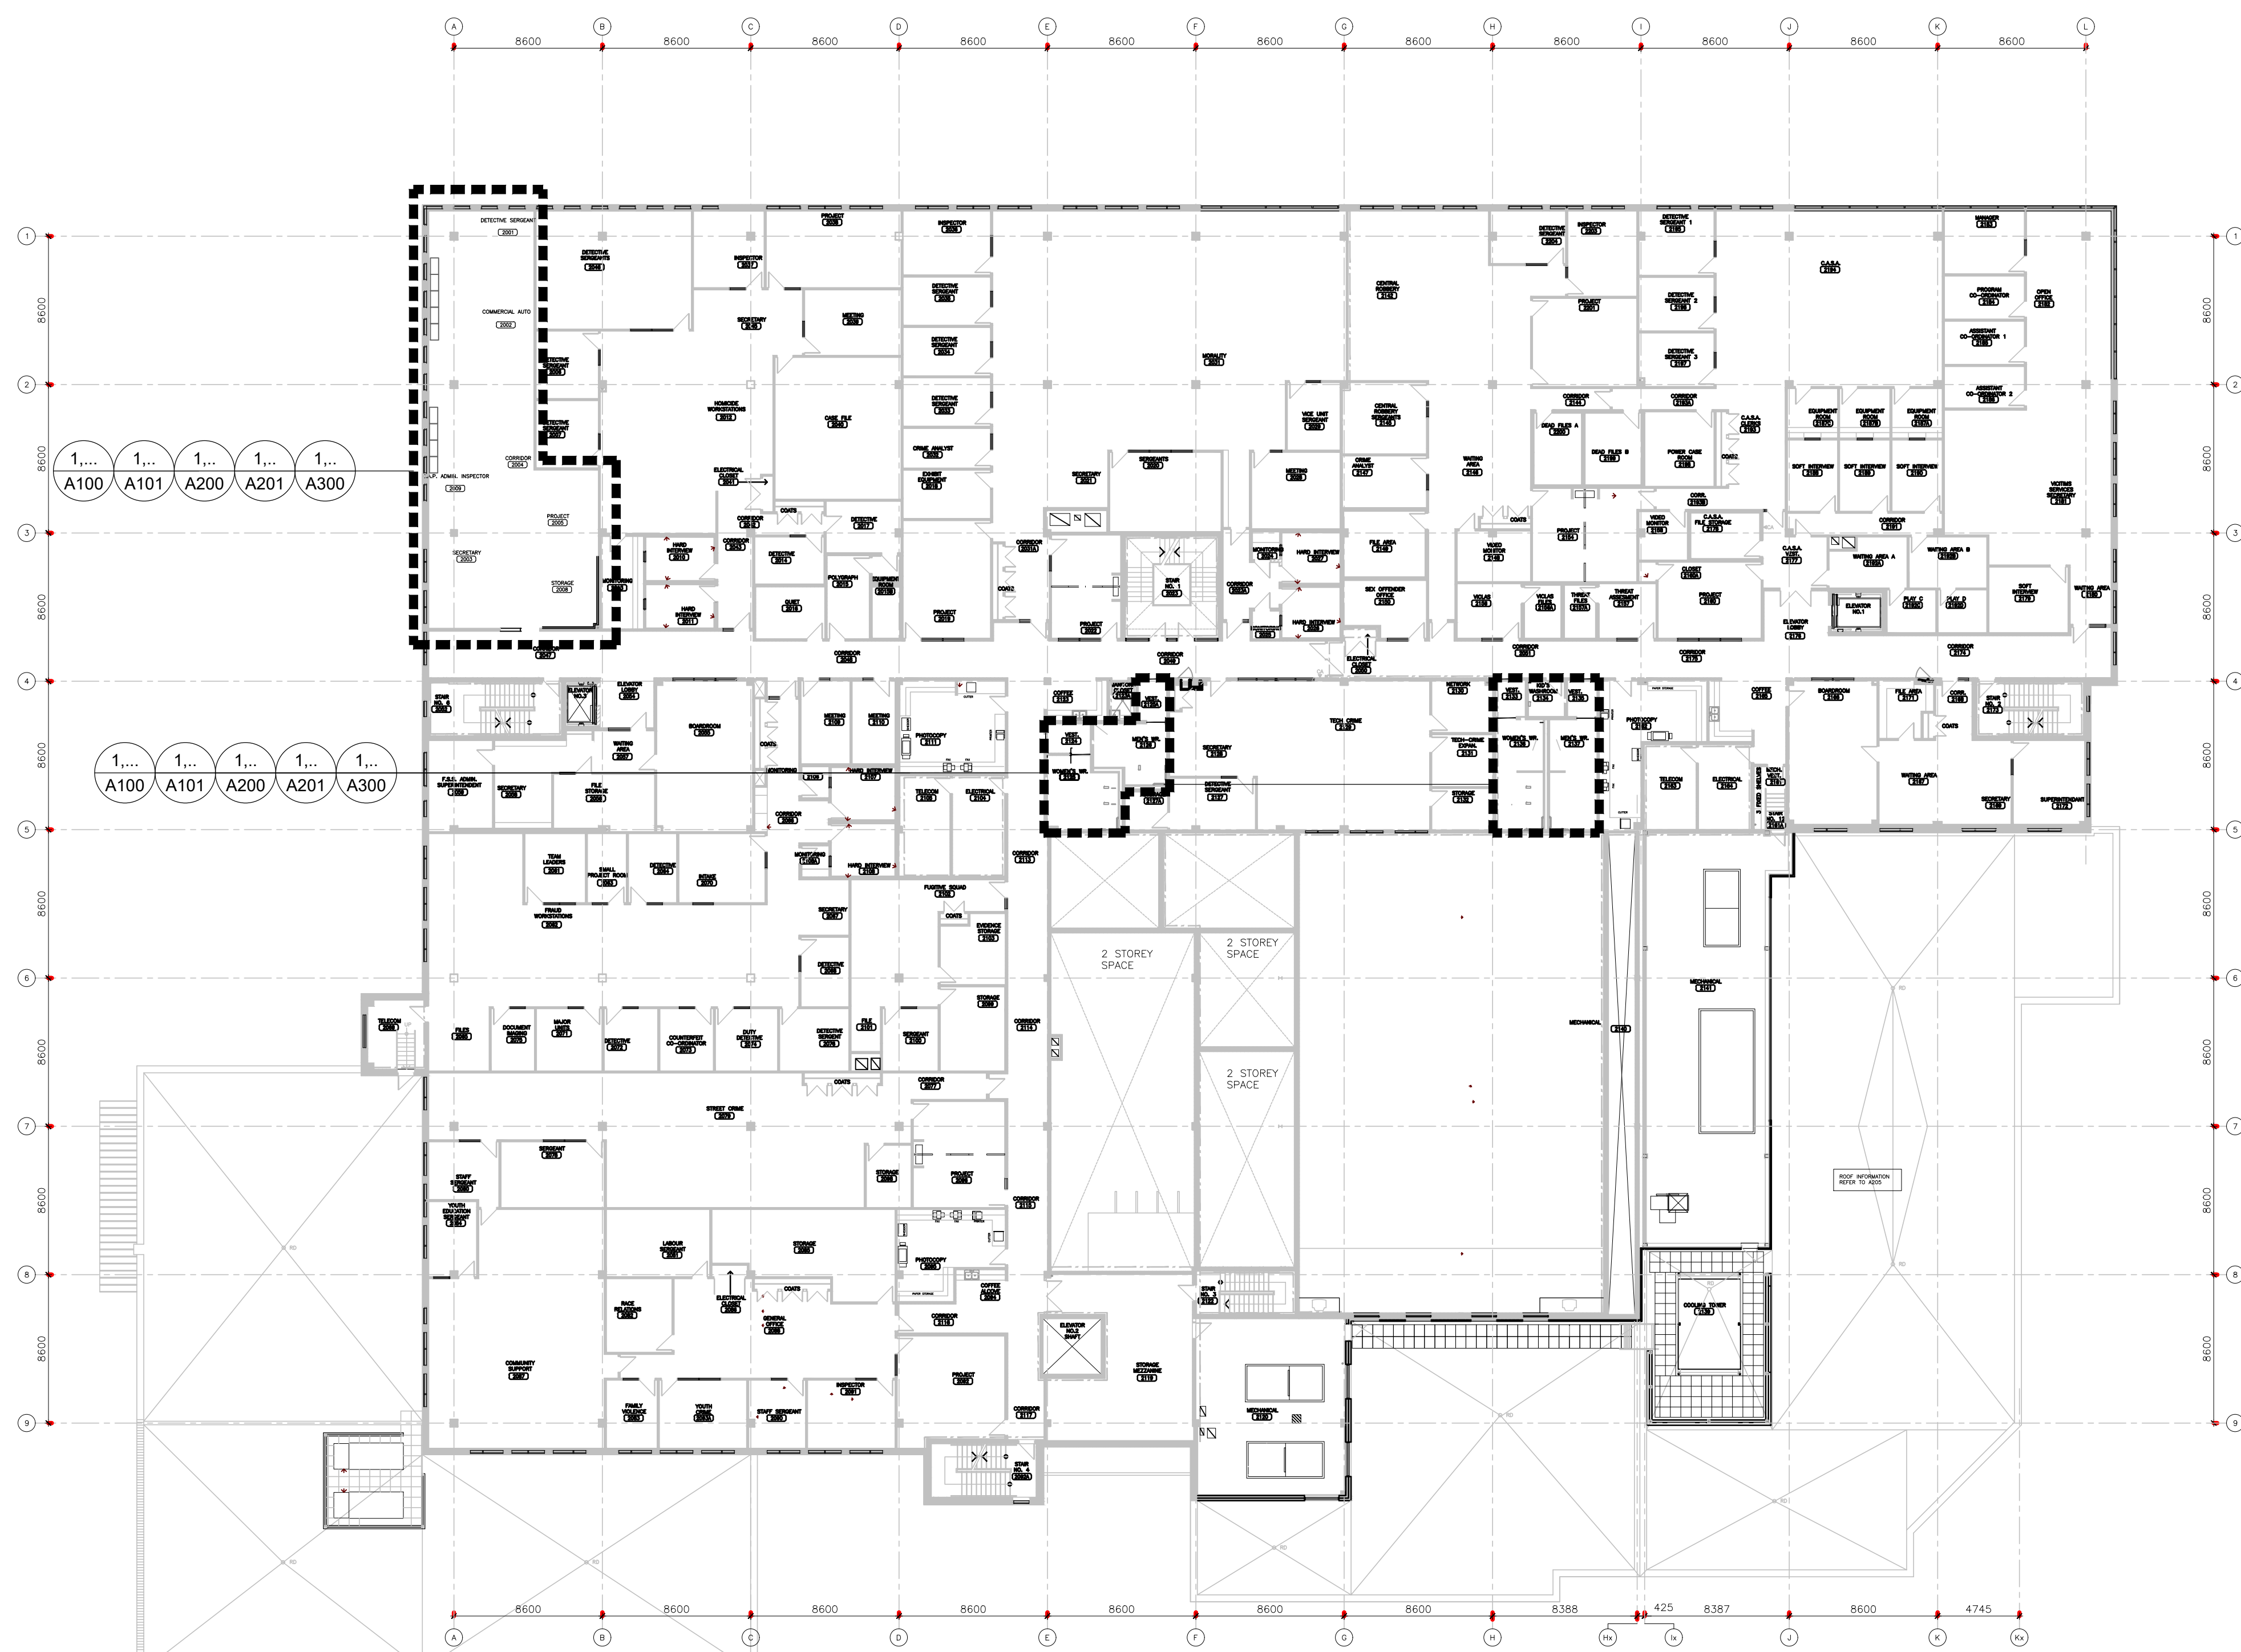

3 OVERALL SECOND FLOOR PLAN
SCALE: 1/250

1... 1... 1... 1... 1...
A100 A101 A200 A201 A300



4 OVERALL THIRD FLOOR PLAN
SCALE: 1/250

1... 1... 1... 1... 1...
A100 A101 A200 A201 A300

1... 1... 1... 1... 1...
A100 A101 A200 A201 A300

4	ISSUED FOR TENDER	2026.05.01
3	ISSUED FOR BUILDING PERMIT	2026.04.08
2	ISSUED FOR 100% CLIENT REVIEW	2026.03.31
1	ISSUED FOR 65% CLIENT REVIEW	2026.01.09
NO.	DESCRIPTION	DATE

REVISIONS

PROJECT



REGION OF PEEL


EMIL V. KOLB CENTRE
PEEL REGIONAL POLICE FACILITY
181 DERRY ROAD EAST, MISSISSAUGA, ON L5T 2Y5






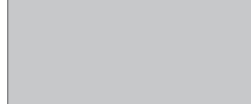
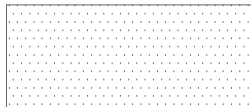



STRUCTURAL CONSULTANT
Stephenson Engineering
WESTBOROUGH CONSULTANT
EXP Services Inc.
ELECTRICAL CONSULTANT
EXP Services Inc.

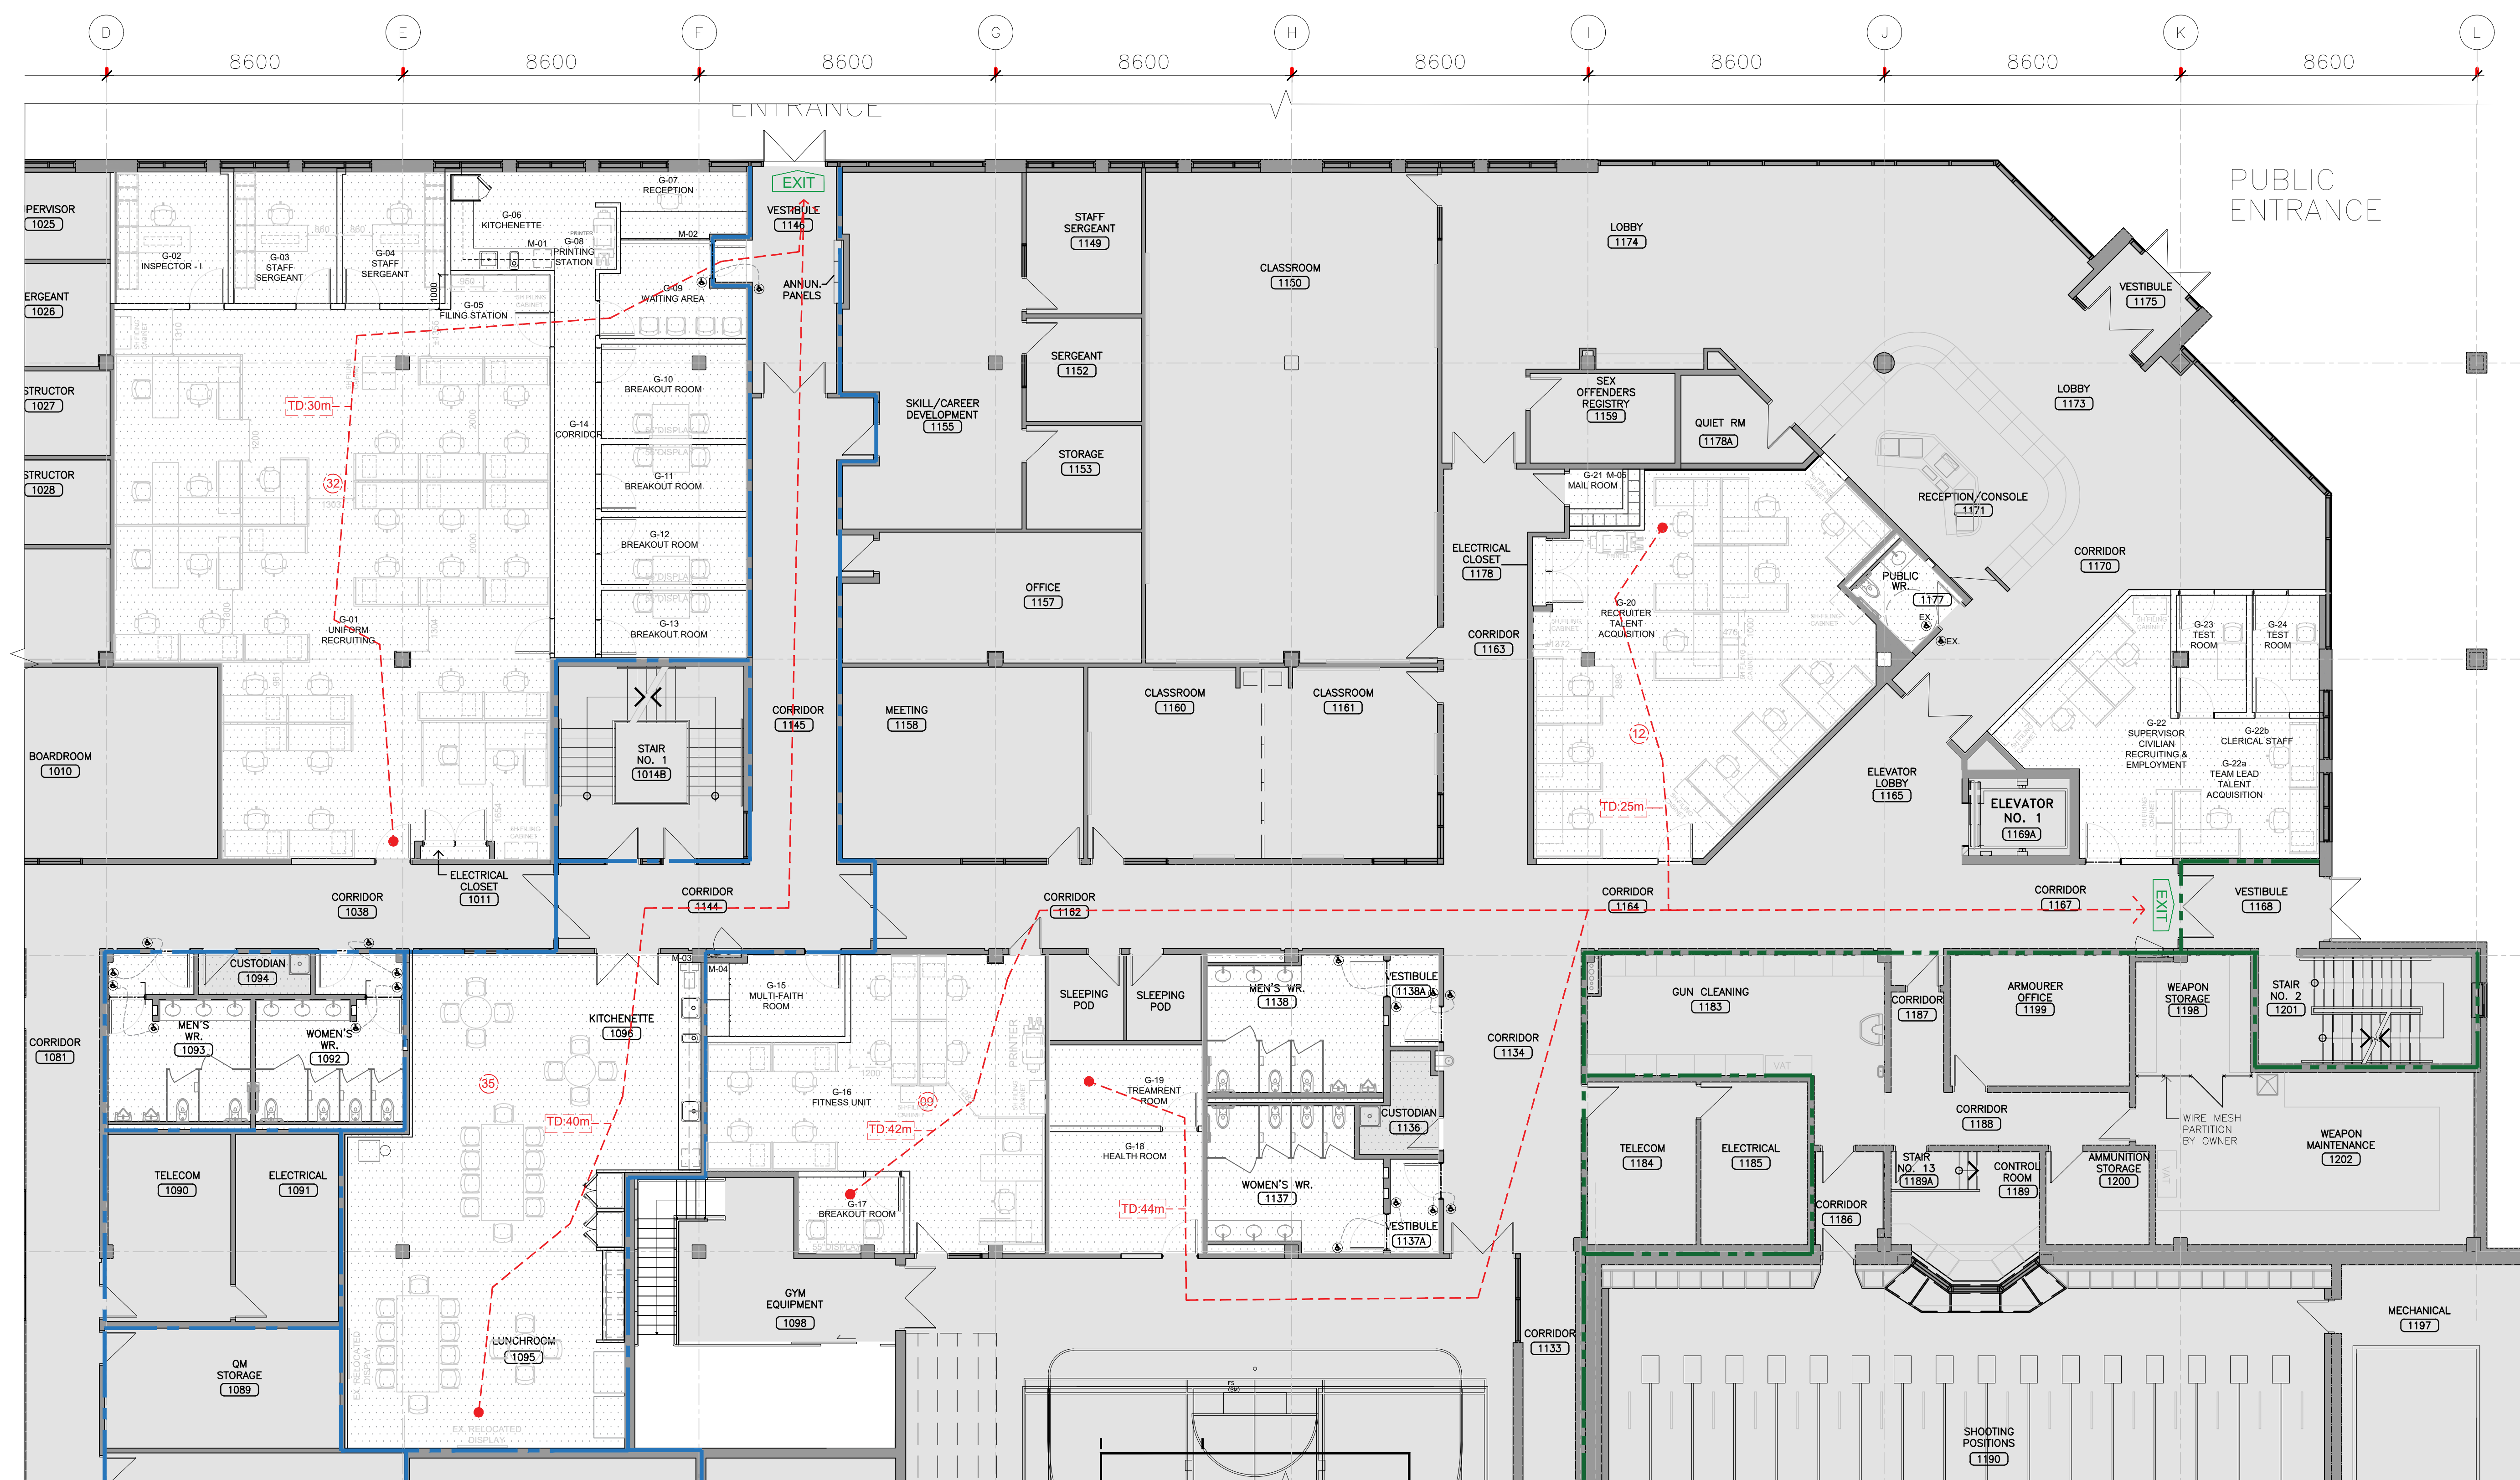
SHEET TITLE
OVERALL GROUND FLOOR,
SECOND FLOOR &
THIRD FLOOR PLAN

SHEET NO. A002
DRAWN BY CC
CHECKED RN
PROJECT NO.
SCALE AS NOTED



OBC SUMMARY LEGEND	
	TRAVEL DISTANCE/DIRECTION OF EXITING
	EXISTING EXIT SIGN
	NON-RATED SMOKE SEPARATION, NEW SMOKE SEALED SEPARATION REFER TO A200 & A201
	EXISTING/NEW 1 HR FIRE SEPARATION
	EXISTING 2 HRs FIRE SEPARATION
	OUTSIDE SCOPE OF WORK
	EXTENT OF NEW SCOPE
	OCCUPANT LOAD

OBC DATA MATRIX			
1.	Project Description:	Project Description: Interior Alteration/Renovation	
2.	Major Occupancies:	Group D (Office Area)	3.1.2.1.(1)
3.	Building Area:	6,793 m2	1.1.3.2
4.	Gross Area:	24,528m2	1.1.3.2
5.	Number of Storeys:	3	3.2.1.1 1.1.3.2
6.	Height of Building:	13 m	
7.	Number of Streets:	3	3.2.2.10 3.2.5
8.	Building Classification:	3.2.2.49, Group D, Any Height, Any Area.	3.2.2.20-83
9.	Sprinkler System Required:	Yes, entire building	3.2.2.20-83 3.2.1.5 3.2.2.17
10.	Standpipe Required:	Yes	3.2.9
11.	Fire Alarm Required:	Yes	3.2.4
12.	Water Service /Supply is Adequate:	Yes	
13.	High Building:	No	3.2.6
14.	Permitted Construction:	Non-Combustible	3.2.2.20-83
15.	Mezzanine Area:	N/A	3.2.1.1.(3)-(8)
16.	Occupan Load:	EXISTING	3.1.1.6
17.	Barrier-free Design:	EXISTING	3.8
18.	Hazardous Substances:	No	3.3.1.2.(1) 3.3.1.19(1)

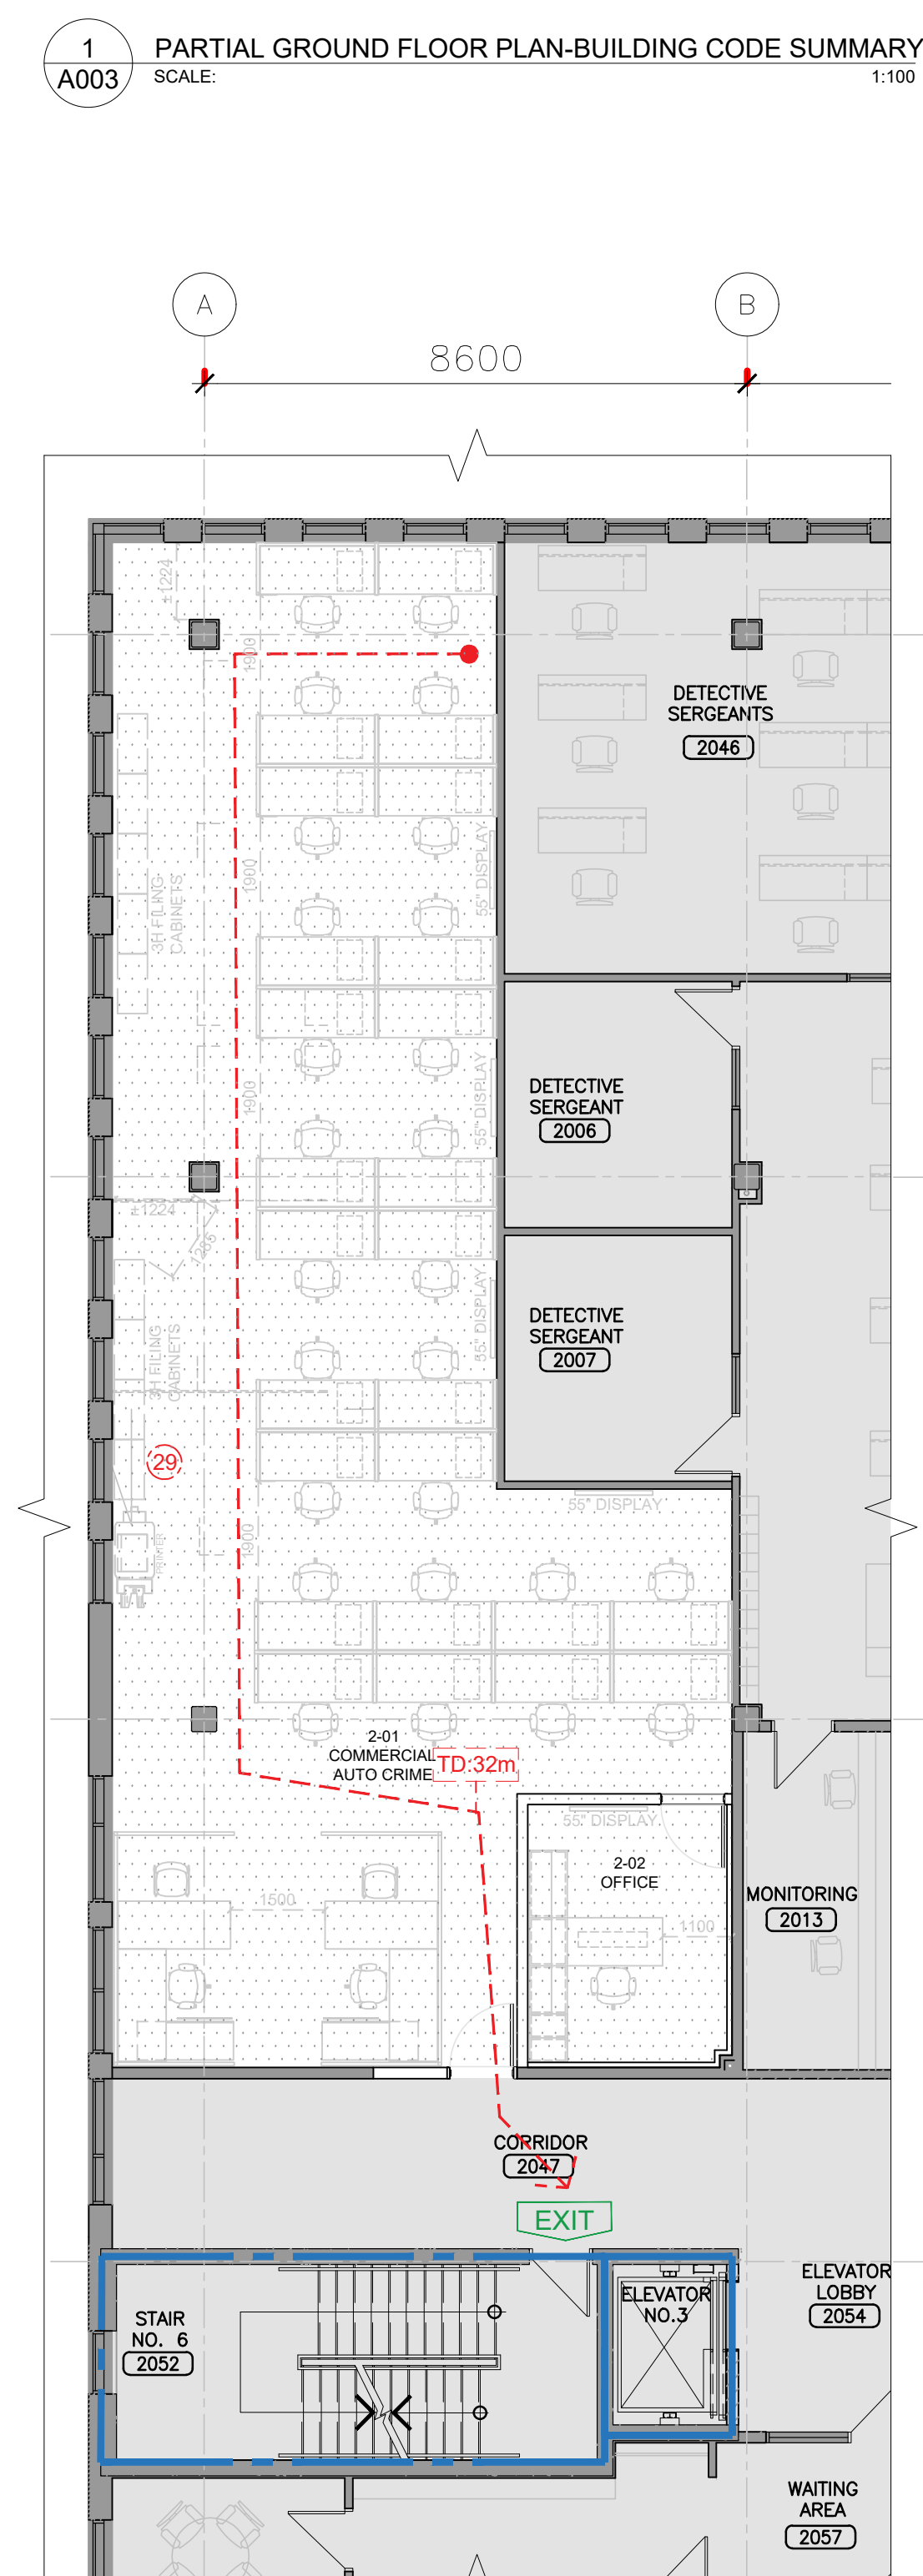


13.	ISSUED FOR TENDER	2026.05.01
12.	ISSUED FOR BUILDING PERMIT	2026.04.01
11.	ISSUED FOR 100% CLIENT REVIEW	2026.03.03
10.	ISSUED FOR 60% CLIENT REVIEW	2026.01.01
9.	ISSUED FOR DESIGN DEVELOPMENT CLIENT REVIEW	2025.10.20
8.	ISSUED FOR DESIGN DEVELOPMENT CLIENT REVIEW	2025.10.09
7.	ISSUED FOR PRELIMINARY DESIGN CLIENT REVIEW	2025.09.01
6.	ISSUED FOR PRELIMINARY DESIGN CLIENT REVIEW	2025.08.18
5.	ISSUED FOR PRELIMINARY DESIGN CLIENT REVIEW	2025.08.11
4.	ISSUED FOR PRELIMINARY DESIGN CLIENT REVIEW	2025.08.08
3.	ISSUED FOR PRELIMINARY DESIGN CLIENT REVIEW	2025.07.30
2.	ISSUED FOR PRELIMINARY DESIGN CLIENT REVIEW	2025.07.25
1.	ISSUED FOR PRELIMINARY DESIGN CLIENT REVIEW	2025.07.14
NO. DESCRIPTION DATE		
REVISIONS		




EMIL V. KOLB CENTRE
PEEL REGIONAL POLICE FACILITY
INTERIOR RENOVATION PROJECT
180 DERRY ROAD EAST, MISSISSAUGA, ONT L4T 1W6



	ISSUED FOR CONSTRUCTION	DA
	STRUCTURAL CONSULTANT	
	Stephenson Engineering	
	MECHANICAL CONSULTANT	
	EXP Services Inc.	
ELECTRICAL CONSULTANT		
EXP Services Inc.		

BUILDING CODE SUMMARY

SHEET NO. A003	DRAWN BY	CHECKED
	SZ	RI
	PROJECT NO.	
SCALE		AS NOTED

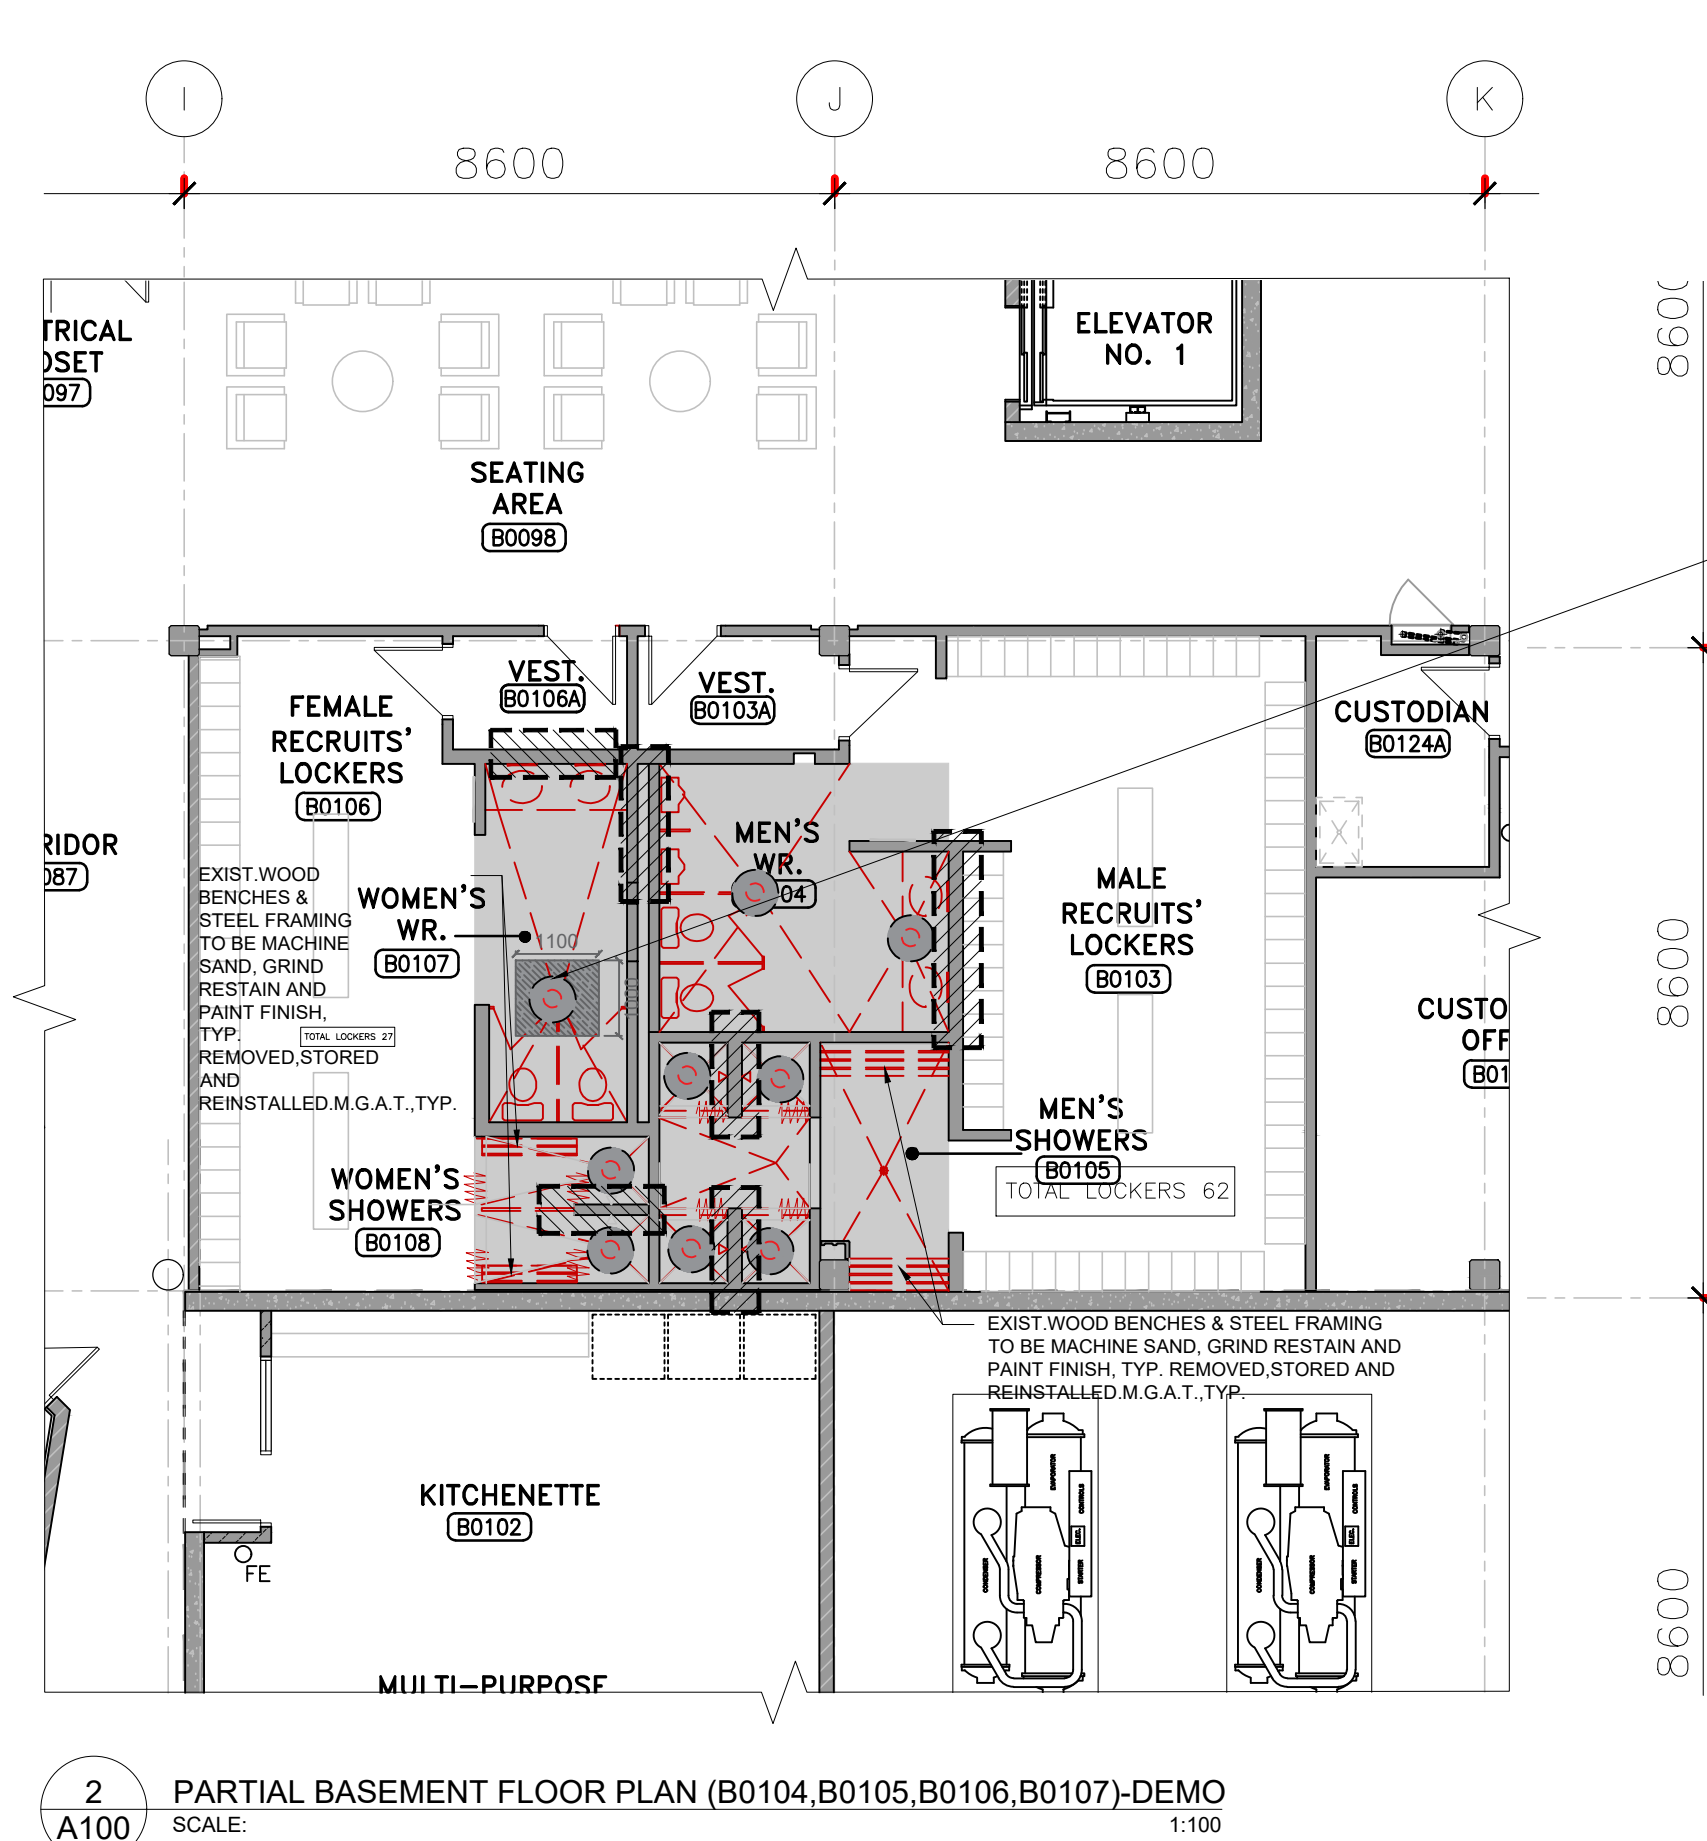

2 PARTIAL BASEMENT FLOOR PLAN (B0104,B0105,B0106,B0107)-DEM
A100 SCALE: 1:100

FLOOR REMEDIATION NOTES

ALL FLOOR AREAS WHERE EXISTING CARPET/ CARPET TILE FLOORING HAS BEEN REMOVED TO ACCOMMODATE NEW FINISHES, REMOVE ALL ADHESIVE, GRIND DOWN AND SMOOTH THE FLOOR TO ACHIEVE A SMOOTH AND EVEN SURFACE. REMOVE ANY EXISTING NEW FLOORING. REFER TO FLOOR FINISH PLAN AND SECTIONS FOR NEW FLOOR FINISH AND ELEVATION.


REPAIR, PATCH, MAKE GOOD AT WALLS AND FLOOR JOINTS AND PAINT FINISH TO ALL RELATED SURFACES TO ACHIEVE AN UNIFORM MECHANICAL & ELECTRICAL MODIFICATIONS, FIXTURES AND NEW CONNECTIONS.


CONTRACTOR IS RESPONSIBLE FOR X-RAY STUDY OF EXISTING CONCRETE FLOOR SLAB BEFORE CUTTING TO REVEAL STRUCTURAL INTEGRITY OF THE FLOOR SLAB AND NO EXISTING UNDERFLOOR SERVICES TO BE AFFECTED.

REFER TO FLOOR FINISH PLAN, ROOM FINISH SCHEDULE AND ELECTRICAL/MECHANICAL PLANS TO MAKE NECESSARY CHANGES OR DEMOLITION TO MATCH NEW LAYOUT AND FINISHES, NEW UNDERFLOOR SERVICES TO BE AFFECTED.

GENERAL DEMOLITION LEGEND	
	EXISTING WALL OR PARTITION TO REMAIN, TYP.
	EXISTING WALLS, PARTITIONS, WINDOWS, DOORS, FRAMES, FIXTURES, ACCESSORIES, SHOWER CURTAINS, AND MILLWORK TO BE DEMOLISHED.
	CUT & OFF ALL EXISTING PREWORK IF NECESSARY, SEE MECHANICAL.
	ALL EXISTING DAMAGED WALL, JOINTS/TOES TO BE CUT, FINISHED A SMOOTH, PAINT FINISH M.G.A.T., TYPICAL.
	EX-KITCHEN CLOSET, LINEN, WASHROOM PARTITION, BINK, SHOWER, FLOOR DRAIN, AND RELATED COMPONENTS TO BE DEMOLISHED AND REPLACED WITH NEW, TYP., REFER TO MECHANICAL.
	EX. DOOR AND FRAME TO REMAIN, TYP.
	EXTENT OF THE AREA TO BE DEMOLISHED TO BE BASE BUILDING WALLS AND DOOR STRUCTURE/ FLOOR. DEMOLISH ALL RELATED ARCHITECTURAL, STAIR BUT NOT LIMITED TO FLOOR FINISHES, CARPET, CARPET ADHESIVES, WALL BASE WALS.
	PARTITIONS BAY MILLWORK, FURNITURE, RAILINGS, WHITEBOARD, TACK BOARD, ETC. M.G.A.T., TYP. REMOVE WITH A CLEAN DEMOLISHED FLOOR & APPLY A LEVELING COMPOUND TO ACCOMMODATE NEW FINISH.
	FINISH PLAN AND SECTIONS FOR NEW FINISH FLOOR MATERIALS AND LEVELS, SEE MECHANICAL AND ELECTRICAL. M.G.A.T., TYP.
	PATCH REPAIR AND MODIFY EXISTING CEILING, FLOOR FINISH, ANY SURFACE DAMAGE TO BE DEMOLISHED TO ACCOMMODATE NEW CEILING, FLOOR FINISH, WALL DOORS AND FRAMES AND DOOR STRUCTURAL SUPPORT. M.G.A.T., TYP.
	GENERAL CONTRACTOR IS RESPONSIBLE TO CUT, REPAIR, PATCH, FIRESTOP AND REIN IN EXISTING WALL AND FLOOR TO ACCOMMODATE NEW MECHANICAL, ELECTRICAL, SECURITY OR OTHER MECHANICAL, ELECTRICAL AND SECURITY, TYP. GENERAL CONTRACTOR'S RESPONSIBILITY TO COORDINATE WITH MECHANICAL AND ELECTRICAL CONTRACTOR FOR SIZE AND LOCATION OF THE OPENING AND INSTALL NEW STEEL LINTEL FOR THE WALL OPENING, SEE MECHANICAL AND ELECTRICAL, TYP. EXACT LOCATION TO BE COORDINATED BY GC.
	EXISTING DOOR/SHOWER TRENCH TYP. EXISTING FLOOR SLAB TO BE CUT TO ACCOMMODATE NEW FLOOR AND NEW PARTITION. CUT, PATCH AND FIRE STOP AT EXIST. FLOOR SLAB CEILING TYP. FOR REQUIRED CLEARANCE. CONTRACTOR IS RESPONSIBLE FOR A RAY STUDY OF EXIST. CONCRETE FLOOR SLAB BEING CUTTING TO VERIFY STRUCTURAL INTEGRITY OF THE FLOOR SLAB AND NOT UNDERMINING SERVICES TO BE SPECIFIED. STRUCTURAL CONSULTANT SHALL BE RETAINED BY THE GENERAL CONTRACTOR TO BEAT AND SEAL EACH LOCATION ON SITE AND PROVIDE A WRITTEN REPORT WITH THEIR COMMENTS REGARDING THE ACCEPTABILITY OF PROPOSED LOCATIONS EXACT LOCATION TO BE COORDINATED BY GC.
	CUT EXIST. CONC. BLOCK WALL TO 40% AFF TO ACCOMMODATE ALL PLUMBING REPLACEMENT AND CONNECTION WORK. SEE MECHANICAL TYP. UIC TO COORDINATE THE EXACT LOCATIONS WITH MECHANICAL, SUBCONTRACTOR AS PER EXISTING CONDITIONS.
M.G.A.T.	MAKE GOOD ON ALL TRADES AT JUNCTION
EX	EXISTING
TYP.	TYPICAL

NO.	DESCRIPTION	DATE
REVISIONS		

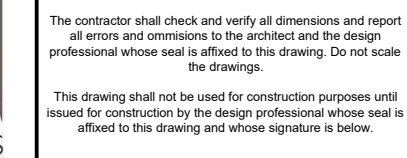

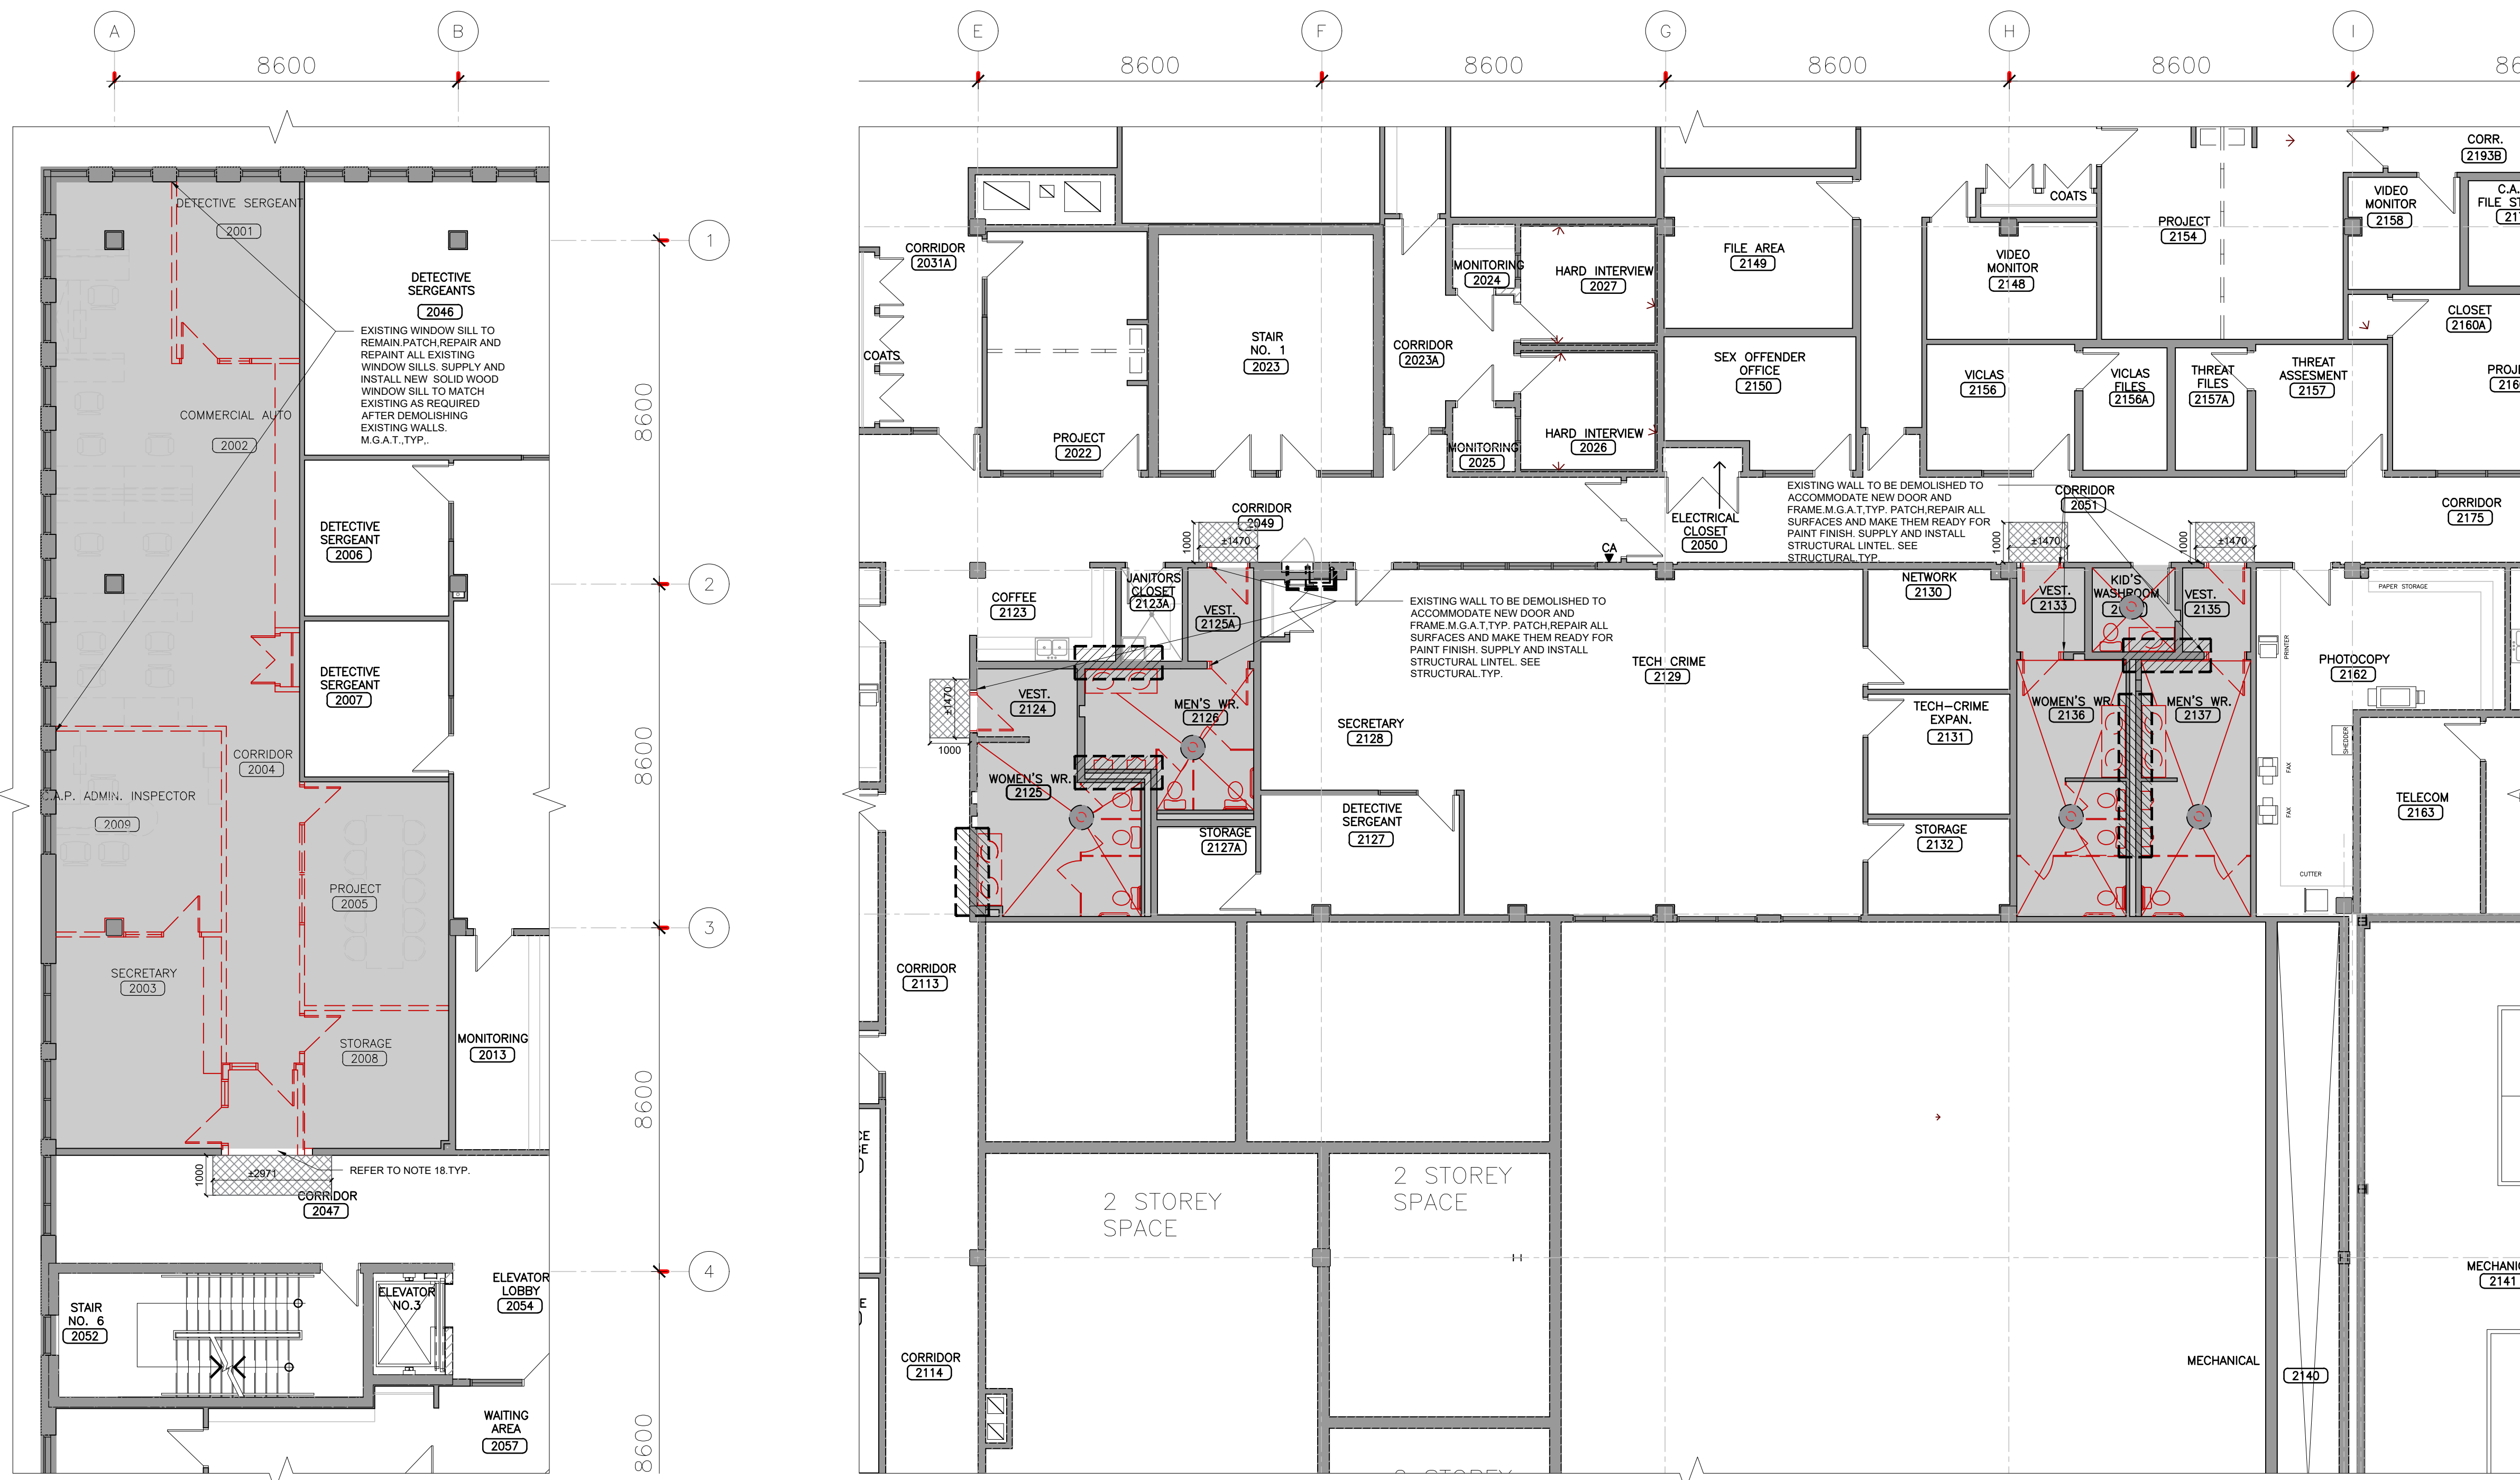


1 PARTIAL SECOND FLOOR PLAN-DEMO
SCALE: 1:100

2 PARTIAL SECOND FLOOR PLAN (WASHROOMS)-DEMO
SCALE: 1:100

- GENERAL DEMOLITION NOTES**
- ALL EXISTING WALL, DISTURBED AND DAMAGED DURING DEMOLITION TO BE REPAIRED/PATCHED AND FINISHED, READY FOR FINISH.
 - THIS DRAWING IS TO BE COORDINATED WITH MECHANICAL, ELECTRICAL DRAWINGS. ANY DISCREPANCIES IN THE DRAWINGS TO BE REPORTED TO ARCHITECT/ENGINEER.
 - CUT OUT SCRATCHES, CRACKS AND ABRASIONS IN WALL SURFACES AND ADJOINING TRIMS AS REQUIRED AND FILL WITH APPROVED NON-SHRINKING PATCHING COMPOUND FLUSH WITH ADJOINING SURFACE. SMOOTH DRY, SAND THE PATCH SMOOTH AND SEAL BEFORE THE APPLICATION OF THE PRIME COAT.
 - CONTRACTOR IS TO PROVIDE TEMPORARY PLYWOOD COVER FOR THE EXISTING EXPANSION JOINT TO PROTECT ELASTOMERIC BONDING, ALUM. ANGLES, CAULKING, FOAM ROPE AND WATER-STOP M.G.A.T. TYP. AGAINST DUST AND DIRT.
 - CONTRACTOR TO CHECK ALL MATERIALS USED IN CONSTRUCTION FOR DEFECTS. ONLY NEW, UNBLEMISHED MATERIALS ARE TO BE USED.
 - WHERE NEW WORK, INCLUDING ALL ELECTRICAL & MECHANICAL WORK, CONNECTS WITH EXISTING & WHERE EXISTING WORK IS ALTERED, ALL NECESSARY CUTTING & FITTING REQUIRED TO MAKE SATISFACTORY CONNECTIONS WITH THE EXISTING WORK SHALL BE PERFORMED UNDER THIS CONTRACT, SO AS TO LEAVE THE ENTIRE WORK IN FINISHED AND WORKMANLIKE CONDITION.
 - ALL DIMENSIONS SHOWN ARE APPROXIMATE. DIMENSIONS MUST BE SITE VERIFIED BY CONTRACTOR.
 - DUST CONTROL - THE GENERAL CONTRACTOR IS TO PROVIDE TEMPORARY PLASTIC COVER SHEETS TO EXISTING GRILLS, INDUATORS AND EQUIPMENTS PRIOR TO THE DEMOLITION WORK SO AS TO PROTECT ALL ADJACENT OFFICE AREAS AND EQUIPMENT FROM ANY DUST.
 - UPON COMPLETION, CLEAN THE ENTIRE AREA OF DEMOLITION TO A TIDY, UNIFORM CONDITION REMOVING ALL DUST, DIRT, PARTITIONS AND ASSOCIATED MATERIALS USED DURING THE DEMOLITION. CLEAN ALL AREAS IMPACTED BY THE DEMOLITION, INCLUDING BUT NOT LIMITED TO ADJACENT OCCUPIED AREAS AND AREAS NOT WITHIN THE SCOPE.
 - GENERAL CONTRACTOR IS RESPONSIBLE TO CUT, REPAIR, PATCH, FIRESTOP AND INFILL EXISTING WALL AND FLOOR TO ACCOMMODATE NEW ELECTRICAL CONDUIT AND MECHANICAL PIPE OPENING TYP.
 - GENERAL CONTRACTOR IS RESPONSIBLE TO COORDINATE WITH ELECTRICAL, SECURITY, MECHANICAL CONTRACTOR FOR LOCATION AND NUMBER OF THE OPENINGS FOR THE WALL AND FLOOR PENETRATION TYP.
 - ALL EXISTING TACK BOARDS, WHITEBOARDS, SIGNS INSTALLED ON THE WALLS TO BE DEMOLISHED. M.G.A.T. TYP.
 - ALL EXISTING PVC PAPER TOWEL DISPENSERS, TOILET PAPER HOLDERS SOAP DISPENSERS, STAINLESS STEEL SANITARY NAPKIN DISPENSER UNITS TO BE REMOVED, STORED AND REINSTALLED. EXACT LOCATION TO BE CONFIRMED BY CLIENT. TYPICAL TO WASHROOMS, KITCHEN, AND SHOWERS.
 - ALL EXISTING RECESSED STAINLESS STEEL PAPER TOWEL DISPENSER/DISPOSAL UNITS, TO BE DEMOLISHED. M.G.A.T. TYP.
 - ALL EXISTING OPENING ON THE WALL (AFTER REMOVING RECESSED ACCESSORIES) TO BE FILLED WITH WATER RESISTANT DRYWALL ON STUD FRAMING, PAINT FINISH TYP., TYPICAL TO ALL WASHROOMS, CHANGE ROOMS AND SHOWERS TYP.
 - ALL EXISTING WINDOW SILLS TO REMAIN PATCH, REPAIR AND REPAINT ALL EXISTING WINDOW SILLS. SUPPLY AND INSTALL NEW SOLID WOOD WINDOW SILL TO MATCH EXISTING AS REQUIRED AFTER DEMOLISHING EXISTING WALLS. M.G.A.T. TYP.
 - FOR ALL STC RATED DOORS THAT WILL BE INSTALLED ON EXISTING WALLS, GC IS TO CUT, REPAIR, PATCH EXISTING WALL CEILING FLOOR FINISH AS REQUIRED FOR THE INSTALLATION OF THE STRUCTURAL SUPPORT. GC TO SUPPLY AND INSTALL NEW WALL, FLOOR FINISH, CEILING FINISHES TO MATCH EXISTING. REFER TO STRUCTURAL TYP.
 - ALL EXISTING WALL MOUNTED ACCESS DOORS LOCATED IN WASHROOMS & SHOWERS TO BE REMOVED AND REPLACED WITH NEW TYP.
 - ALL EXISTING WINDOW BLINDS WITHIN THE SCOPE OF AREA TO BE DEMOLISHED. PATCH, REPAIR, PAINT FINISH ALL AFFECTED SURFACES DUE TO DEMOLITION. M.G.A.T. TYP.
 - GC TO PATCH/REPAIR/INFILL ALL EXISTING WALLS AFTER REMOVING ANY ELECTRICAL & MECHANICAL COMPONENTS INCLUDING BUT NOT LIMITED TO OUTLETS, SURFACE MOUNTED RECESSED COMPONENTS. M.G.A.T. TYP.
 - FOR ALL WALL/PARTITION DEMOLITION, GC IS TO INCLUDE MASONRY WALL WITH 2 LAYERS OF DRYWALL. M.G.A.T. TYP.
 - ALL EXIST FLOOR DRAINS LOCATED IN WASHROOMS & CHANGE ROOMS TO BE REMOVED AND REPLACED WITH NEW. REFER TO MECHANICAL. M.G.A.T. TYP. CUT, REPAIR, PATCH, AND FIRE STOP THE SLAB AS REQUIRED FOR THE INSTALLATION OF THE NEW FLOOR DRAINS M.G.A.T. TYP.
- FLOOR DEMOLITION NOTES**
- ALL FLOOR AREAS WHERE EXISTING CARPET/CARPET TILE FLOORING HAS BEEN REMOVED TO ACCOMMODATE NEW FINISHES. REMOVE ALL ADHESIVE, GRIND DOWN AND SMOOTH THE FLOOR TO BASE CONCRETE, SMOOTH AND CLEAN TO RECEIVE NEW FLOORING. REFER TO FLOOR FINISH PLAN AND SECTIONS FOR NEW FLOOR FINISH AND ELEVATION.
 - REPAIR, PATCH, MAKE GOOD AT WALL AND FLOOR JUNCTIONS AND PAINT FINISH TO ALL RELATED EXISTING AREAS TO ACCOMMODATE NEW MECHANICAL & ELECTRICAL MODIFICATIONS, FIXTURES AND NEW CONNECTIONS.
 - CONTRACTOR IS RESPONSIBLE FOR A RAY STUDY OF EXISTING CONCRETE FLOOR SLAB BEFORE CUTTING TO ENSURE STRUCTURAL INTEGRITY OF THE FLOOR SLAB AND NO EXISTING UNDERGROUND SERVICES TO BE AFFECTED.
 - REFER TO FLOOR FINISH PLAN, ROOM FINISH SCHEDULE AND ELECTRICAL, MECHANICAL PLANS TO MAKE NECESSARY CHANGES OR DEMOLITION TO MATCH NEW LAYOUT AND FINISHES. NEW MECHANICAL, ELECTRICAL MODIFICATION AND CONNECTIONS.

GENERAL DEMOLITION LEGEND	
	EXISTING WALL OR PARTITION TO REMAIN, TYP.
	EXISTING WALLS, PARTITIONS, WINDOWS, DOORS, FRAMES, ETC. TO REMAIN. ACCESSORIES, SHOWER CURTAINS, AND MILLWORK TO BE DEMOLISHED.
	CUT & CAP ALL EXISTING PREPWORK IF NECESSARY. SEE MECHANICAL.
	ALL EXISTING DAMAGED WALL JUNCTIONS TO BE CUT, PATCHED & SMOOTH PAINT FINISH M.G.A.T. TYPICAL.
	EX. WATER CLOSET, URINAL, WASHROOM PARTITION, SINK, SHOWER, FLOOR DRAIN AND ALL RELATED COMPONENTS TO BE DEMOLISHED AND REPLACED WITH NEW TYP. REFER TO MECHANICAL.
	EX. DOOR AND FRAME TO REMAIN, TYP.
	EXTENT OF THE AREA TO BE DEMOLISHED TO THE BASE BUILDING WALLS AND CONCRETE STRUCTURE/ FLOOR. DEMOLISH ALL RELATED ARCHITECTURAL ITEMS BUT NOT LIMITED TO FLOOR FINISHES, CARPET, CARPET ADHESIVES, WALL BASE, WALLS, PARTITIONS, RAMP, MILLWORK, FURNITURE, RAILINGS, WHITEBOARDS, TACK BOARDS, ETC. M.G.A.T. TYP. SAND, SMOOTH & CLEAN DEMOLISHED FLOOR & APPLY LEVELING COMPOUND TO ACCOMMODATE NEW FLOORING. REFER TO FLOOR FINISH PLAN AND SECTIONS FOR NEW FINISH FLOOR MATERIALS AND LEVELS. SEE MECHANICAL AND ELECTRICAL. M.G.A.T. TYP.
	PATCH, REPAIR AND MODIFY EXISTING CEILING, FLOOR FINISH, ANY SURFACE DAMAGED DURING DEMOLITION TO ACCOMMODATE NEW CEILING, FLOOR FINISH, WALL, DOOR AND FRAMES, AND DOOR STRUCTURAL SUPPORT. M.G.A.T. TYP.
	GENERAL CONTRACTOR IS RESPONSIBLE TO CUT, REPAIR, PATCH, FIRESTOP AND INFILL EXISTING WALL AND FLOOR TO ACCOMMODATE NEW MECHANICAL, ELECTRICAL, SECURITY OPENING. SEE MECHANICAL, ELECTRICAL AND SECURITY TYP. GENERAL CONTRACTOR RESPONSIBLE TO COORDINATE WITH MECHANICAL AND ELECTRICAL CONTRACTOR FOR SIZE AND LOCATION OF THE OPENINGS AND INSTALL NEW STEEL LINTELS FOR THE WALL OPENING. SEE MECHANICAL AND ELECTRICAL TYP. EXACT LOCATION TO BE COORDINATED BY GC.
	450mmx300mm TRENCH (TYP). EXIST. FLOOR SLAB TO BE CUT TO ACCOMMODATE INSTALLATION OF NEW JUNCTION BOXES, CUT, PATCH AND FIRE STOP AT EXIST. FLOOR SLAB. CEILING BELOW AS REQUIRED. GENERAL CONTRACTOR IS RESPONSIBLE FOR A RAY STUDY OF EXIST. CONCRETE FLOOR SLAB BEFORE CUTTING TO ENSURE STRUCTURAL INTEGRITY OF THE FLOOR SLAB AND NO EXIST. UNDERGROUND SERVICES TO BE AFFECTED. STRUCTURAL CONSULTANT SHALL BE RETAINED BY THE GENERAL CONTRACTOR TO REVIEW EACH SCAN LOCATION ON SITE AND PROVIDE A WRITTEN REPORT WITH THEIR COMMENTS REGARDING THE ACCEPTABILITY OF PROPOSED LOCATIONS EXACT LOCATION TO BE COORDINATED BY GC.
	CUT EXIST. CONC. BLOCK WALL TO 450mm AFF TO ACCOMMODATE ALL PLUMBING REPLACEMENT AND CONNECTION WORK. (SEE MECH. (M.G.A.T. TYP.)) GC TO COORDINATE THE EXACT LOCATIONS WITH MECHANICAL. SUBCONTRACTOR AS PER EXISTING CONDITIONS.
M.G.A.T.	MAKE GOOD ON ALL TRADES AT JUNCTION
EX.	EXISTING
TYP.	TYPICAL

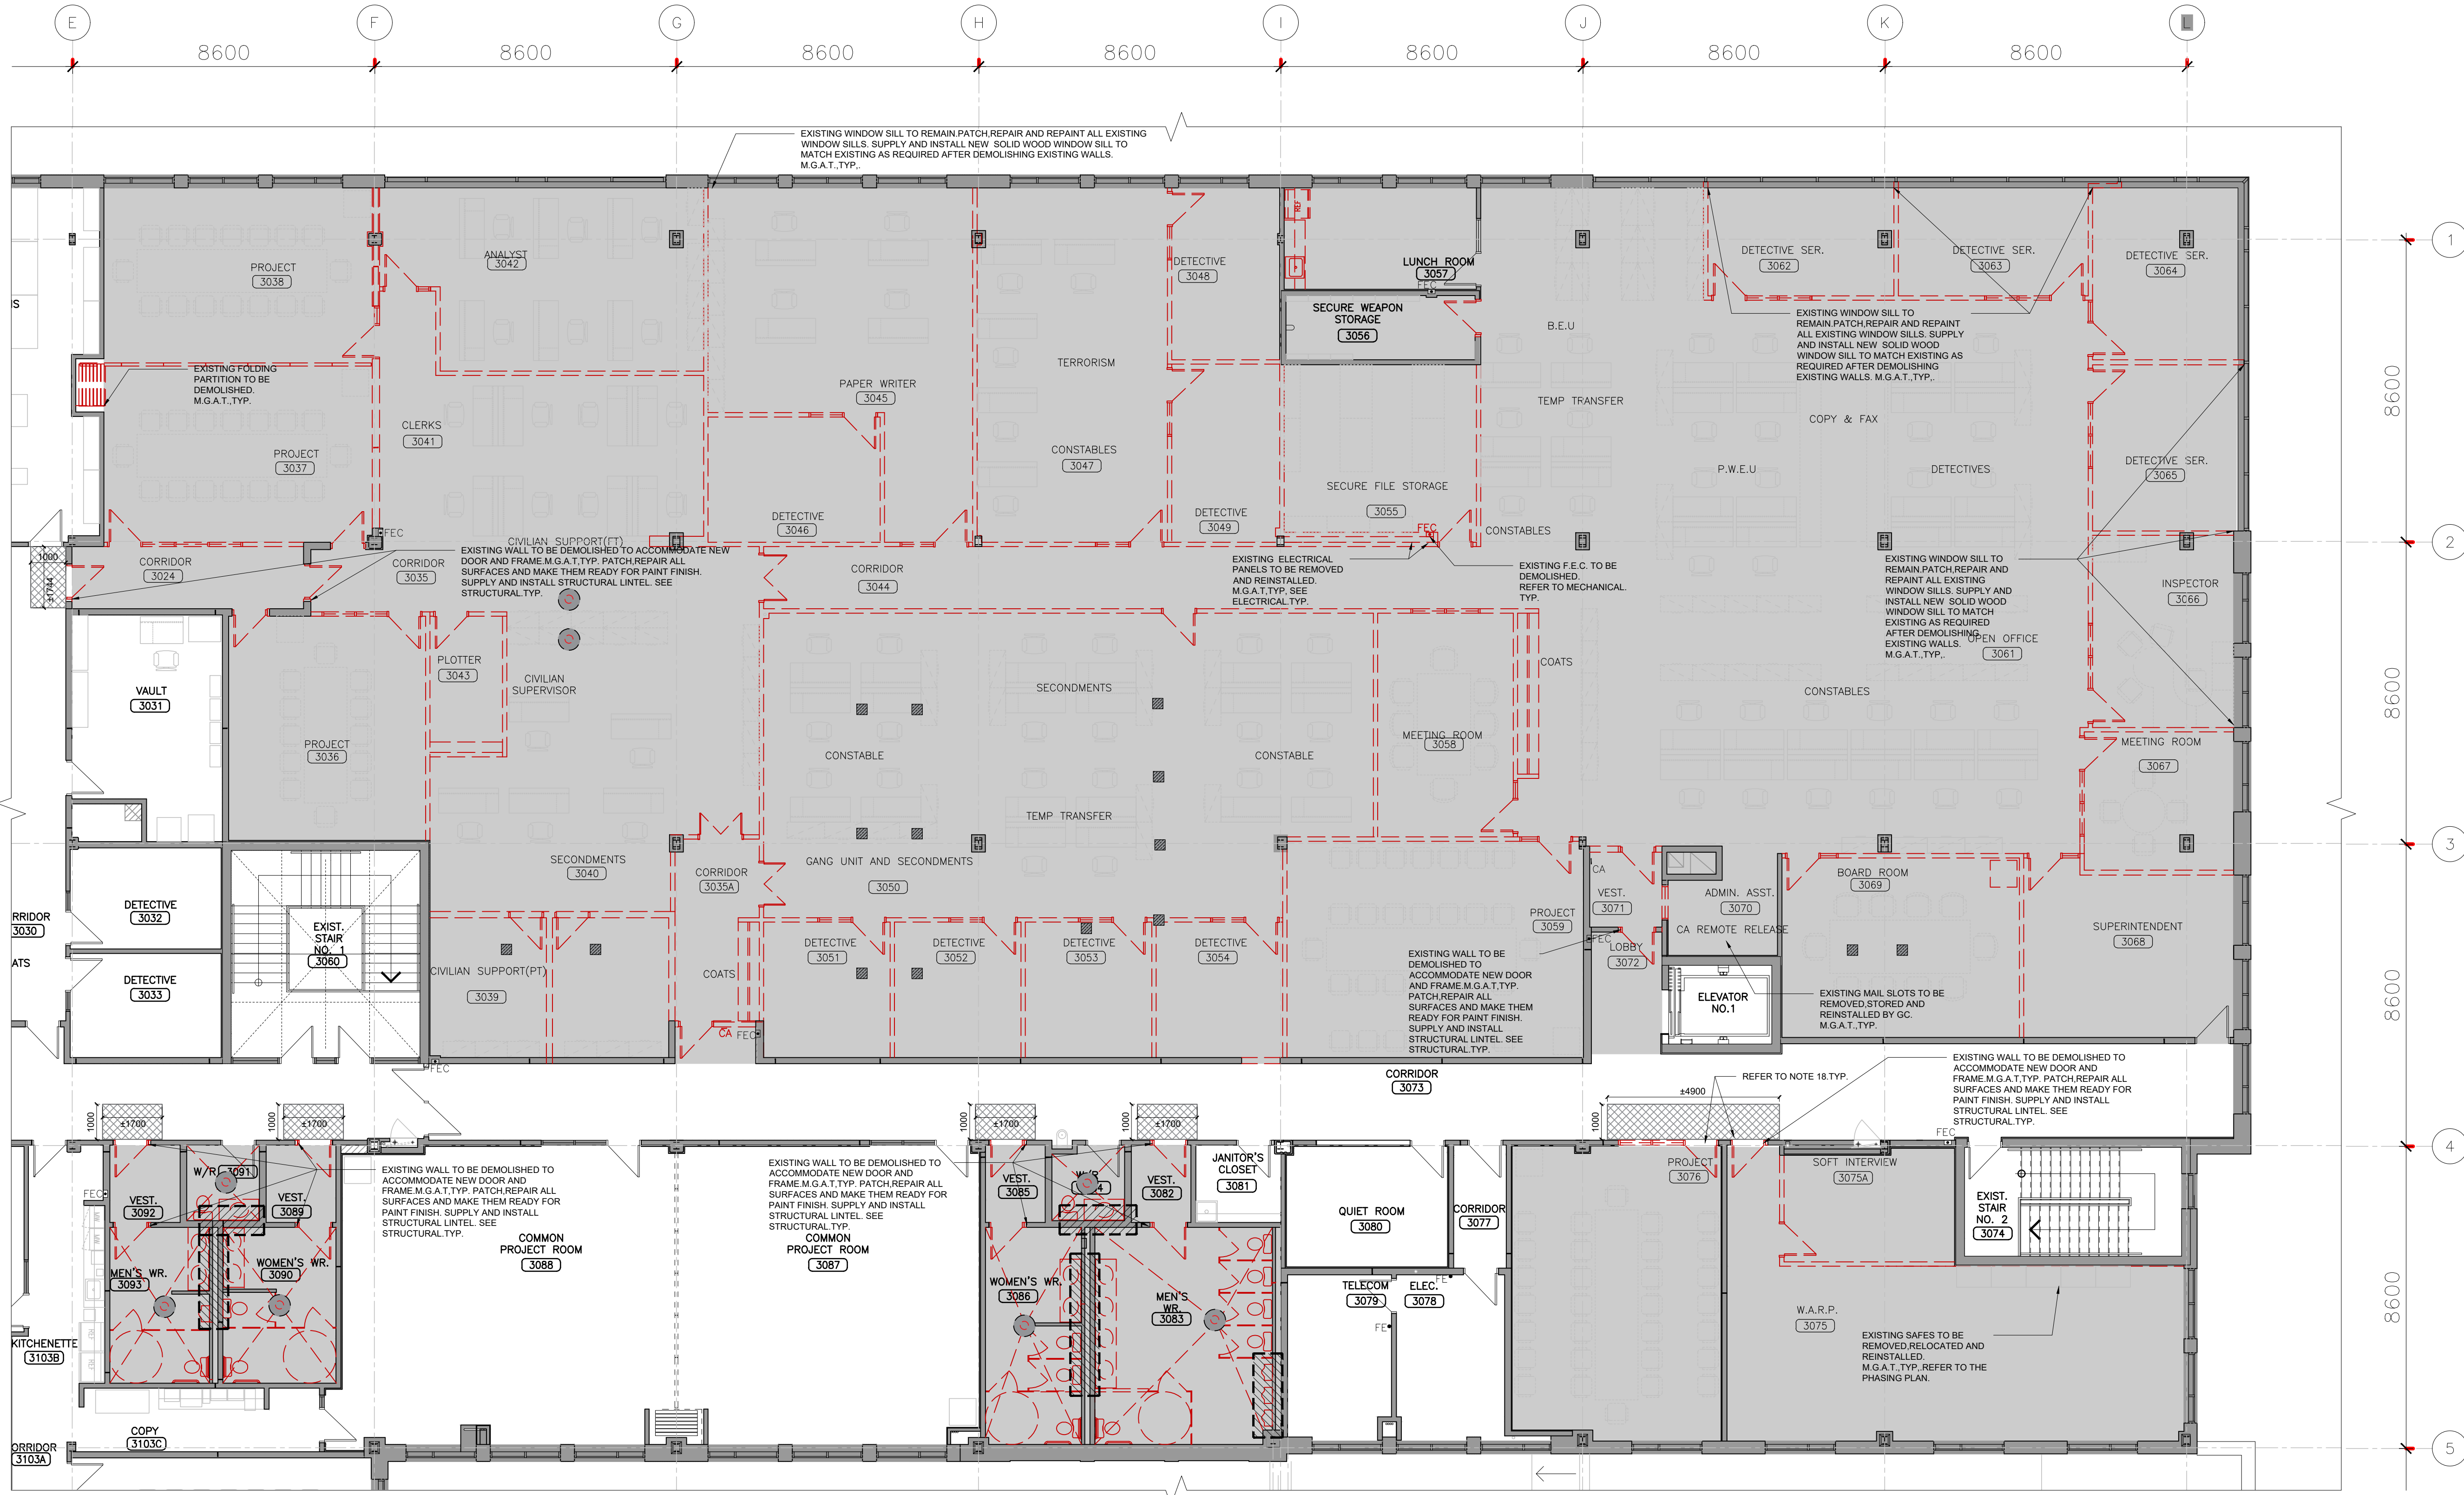

3 PARTIAL THIRD FLOOR PLAN-DEMO
SCALE: 1:100

13. ISSUED FOR TENDER	2026.05.01
12. ISSUED FOR BUILDING PERMIT	2026.08.04
11. ISSUED FOR 100% CLIENT REVIEW	2026.03.31
10. ISSUED FOR 90% CLIENT REVIEW	2026.01.26
9. ISSUED FOR DESIGN DEVELOPMENT CLIENT REVIEW	2025.10.24
8. ISSUED FOR PRELIMINARY DESIGN CLIENT REVIEW	2025.10.01
7. ISSUED FOR PRELIMINARY DESIGN CLIENT REVIEW	2025.09.03
6. ISSUED FOR PRELIMINARY DESIGN CLIENT REVIEW	2025.08.18
5. ISSUED FOR PRELIMINARY DESIGN CLIENT REVIEW	2025.08.12
4. ISSUED FOR PRELIMINARY DESIGN CLIENT REVIEW	2025.08.01
3. ISSUED FOR PRELIMINARY DESIGN CLIENT REVIEW	2025.07.30
2. ISSUED FOR PRELIMINARY DESIGN CLIENT REVIEW	2025.07.25
1. ISSUED FOR PRELIMINARY DESIGN CLIENT REVIEW	2025.07.14

NO. DESCRIPTION DATE

REVISIONS

PROJECT

REGION OF PEEL

EMIL V. KOLB CENTRE
PEEL REGIONAL POLICE FACILITY
INTERIOR RENOVATION PROJECT
181 DERRY ROAD EAST, MISSISSAUGA, ON L5T 2Y5

NGA ARCHITECTS

STRUCTURAL CONSULTANT
STEPHENSON ENGINEERING
WESTSCOTT CONSULTING
EXP SERVICES INC.
ELECTRICAL CONSULTANT
EXP SERVICES INC.

SHEET TITLE
PARTIAL SECOND & THIRD
FLOOR PLAN- DEMOLITION

SHEET NO.	DRAWN BY	CHECKED
A101	SZ	RN
SCALE	AS NOTED	



- [illegible]



13.	ISSUED FOR TENDER	2028.05.01
12.	ISSUED FOR BUILDING PERMIT	2028.04.06
11.	ISSUED FOR 100% CLIENT REVIEW	2028.03.31
10.	ISSUED FOR 60% CLIENT REVIEW	2028.01.01
9.	ISSUED FOR DESIGN DEVELOPMENT CLIENT REVIEW	2025.10.28
8.	ISSUED FOR DESIGN DEVELOPMENT CLIENT REVIEW	2025.10.01
7.	ISSUED FOR PRELIMINARY DESIGN CLIENT REVIEW	2025.08.01
6.	ISSUED FOR PRELIMINARY DESIGN CLIENT REVIEW	2025.08.01
5.	ISSUED FOR PRELIMINARY DESIGN CLIENT REVIEW	2025.08.11
4.	ISSUED FOR PRELIMINARY DESIGN CLIENT REVIEW	2025.08.01
3.	ISSUED FOR PRELIMINARY DESIGN CLIENT REVIEW	2025.07.31
2.	ISSUED FOR PRELIMINARY DESIGN CLIENT REVIEW	2025.07.25
1.	ISSUED FOR PRELIMINARY DESIGN CLIENT REVIEW	2025.07.14



REGION OF PEE

EMIL V. KOLB CENTRE
PEEL REGIONAL POLICE FACILITY
INTERIOR RENOVATION PROJECT
180 DERRY ROAD EAST, MISSISSAUGA, ON L5T 2Y5




The contractor shall check and verify all dimensions and report all errors and omissions to the architect and the design professional whose seal is affixed to this drawing. Do not scale the drawings.


This drawing shall not be used for construction purposes unless issued for construction by the design professional whose seal is affixed to this drawing and whose signature is below.

NORTH	ISSUED FOR CONSTRUCTION	04
	STRUCTURAL CONSULTANT	Stephenson Engineering
	MECHANICAL CONSULTANT	EXP Services Inc
	ELECTRICAL CONSULTANT	EXP Services Inc


SHEET TITLE	EXP Services Inc.
REFLECTED CEILING PLAN DEMOLITION- BASEMENT & GROUND FLOOR	

SHEET NO. A102	DRAWN BY MM	CHECKED RI
	PROJECT NO.	
	SCALE AS NOTED	

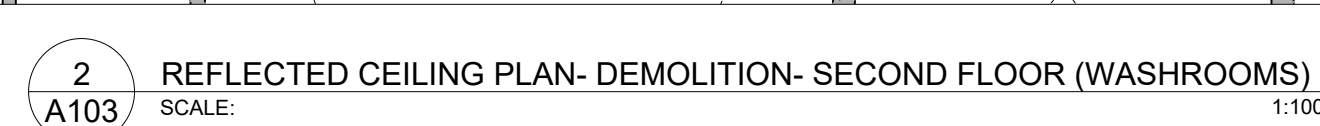
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1 PARTIAL BASEMENT FLOOR PLAN (B0131,B0132,B0138,B0139)-NEW
SCALE: 1:100

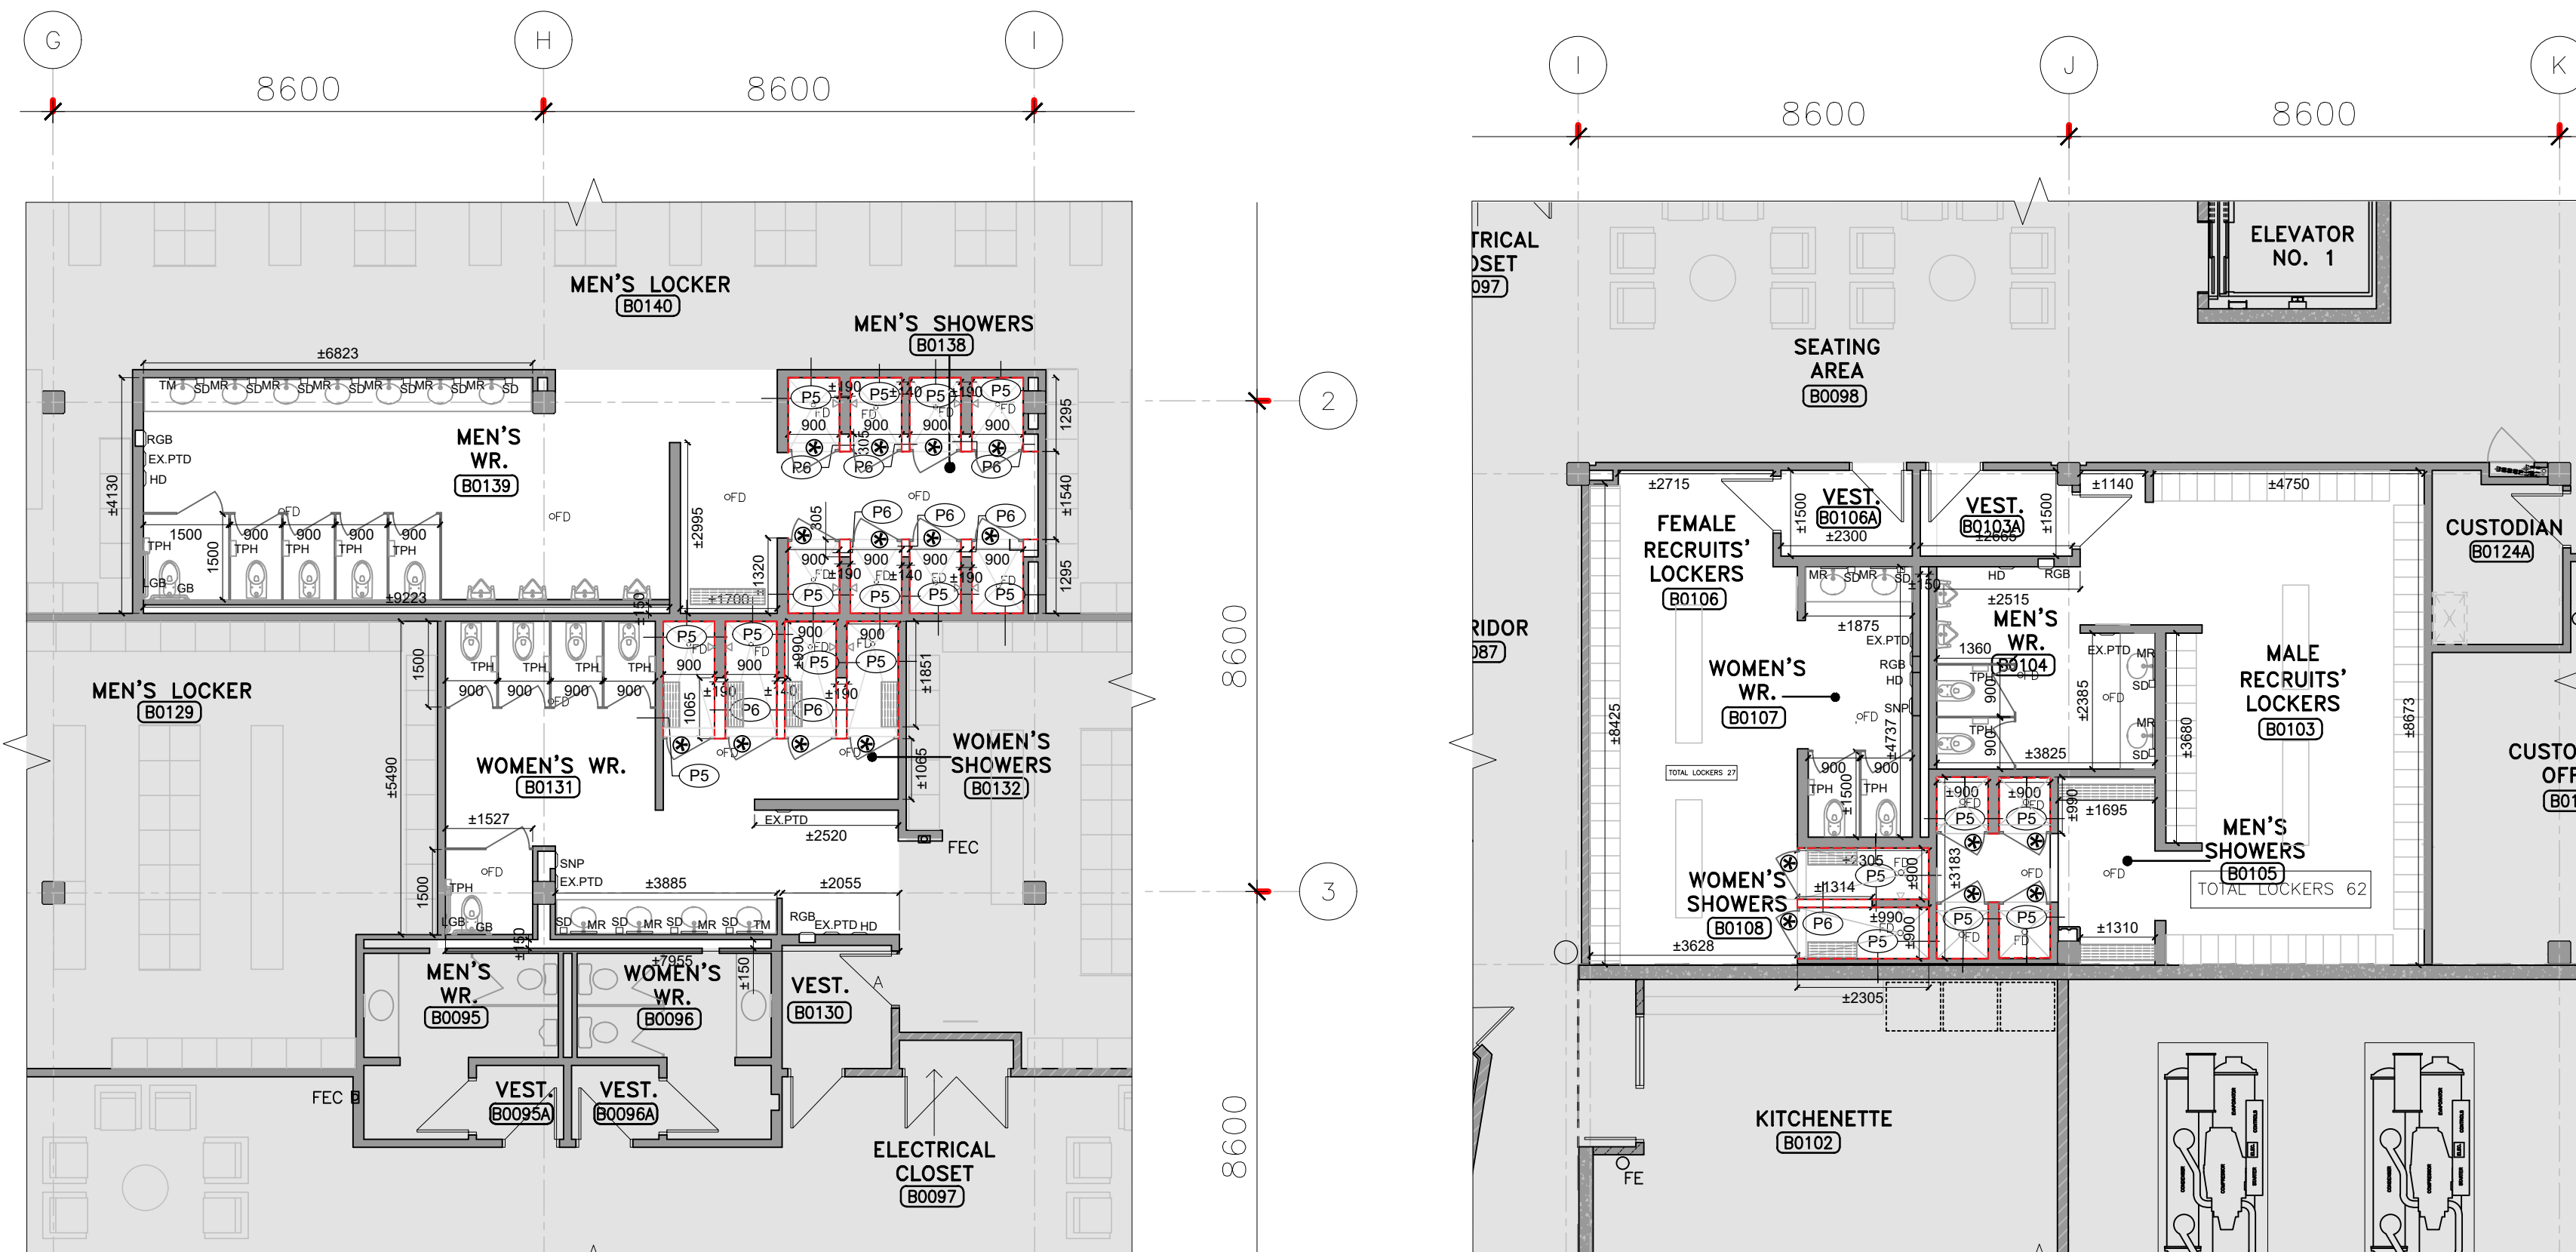


2 PARTIAL BASEMENT FLOOR PLAN (B0104,B0105,B0106,B0107)-NEW
SCALE: 1:100

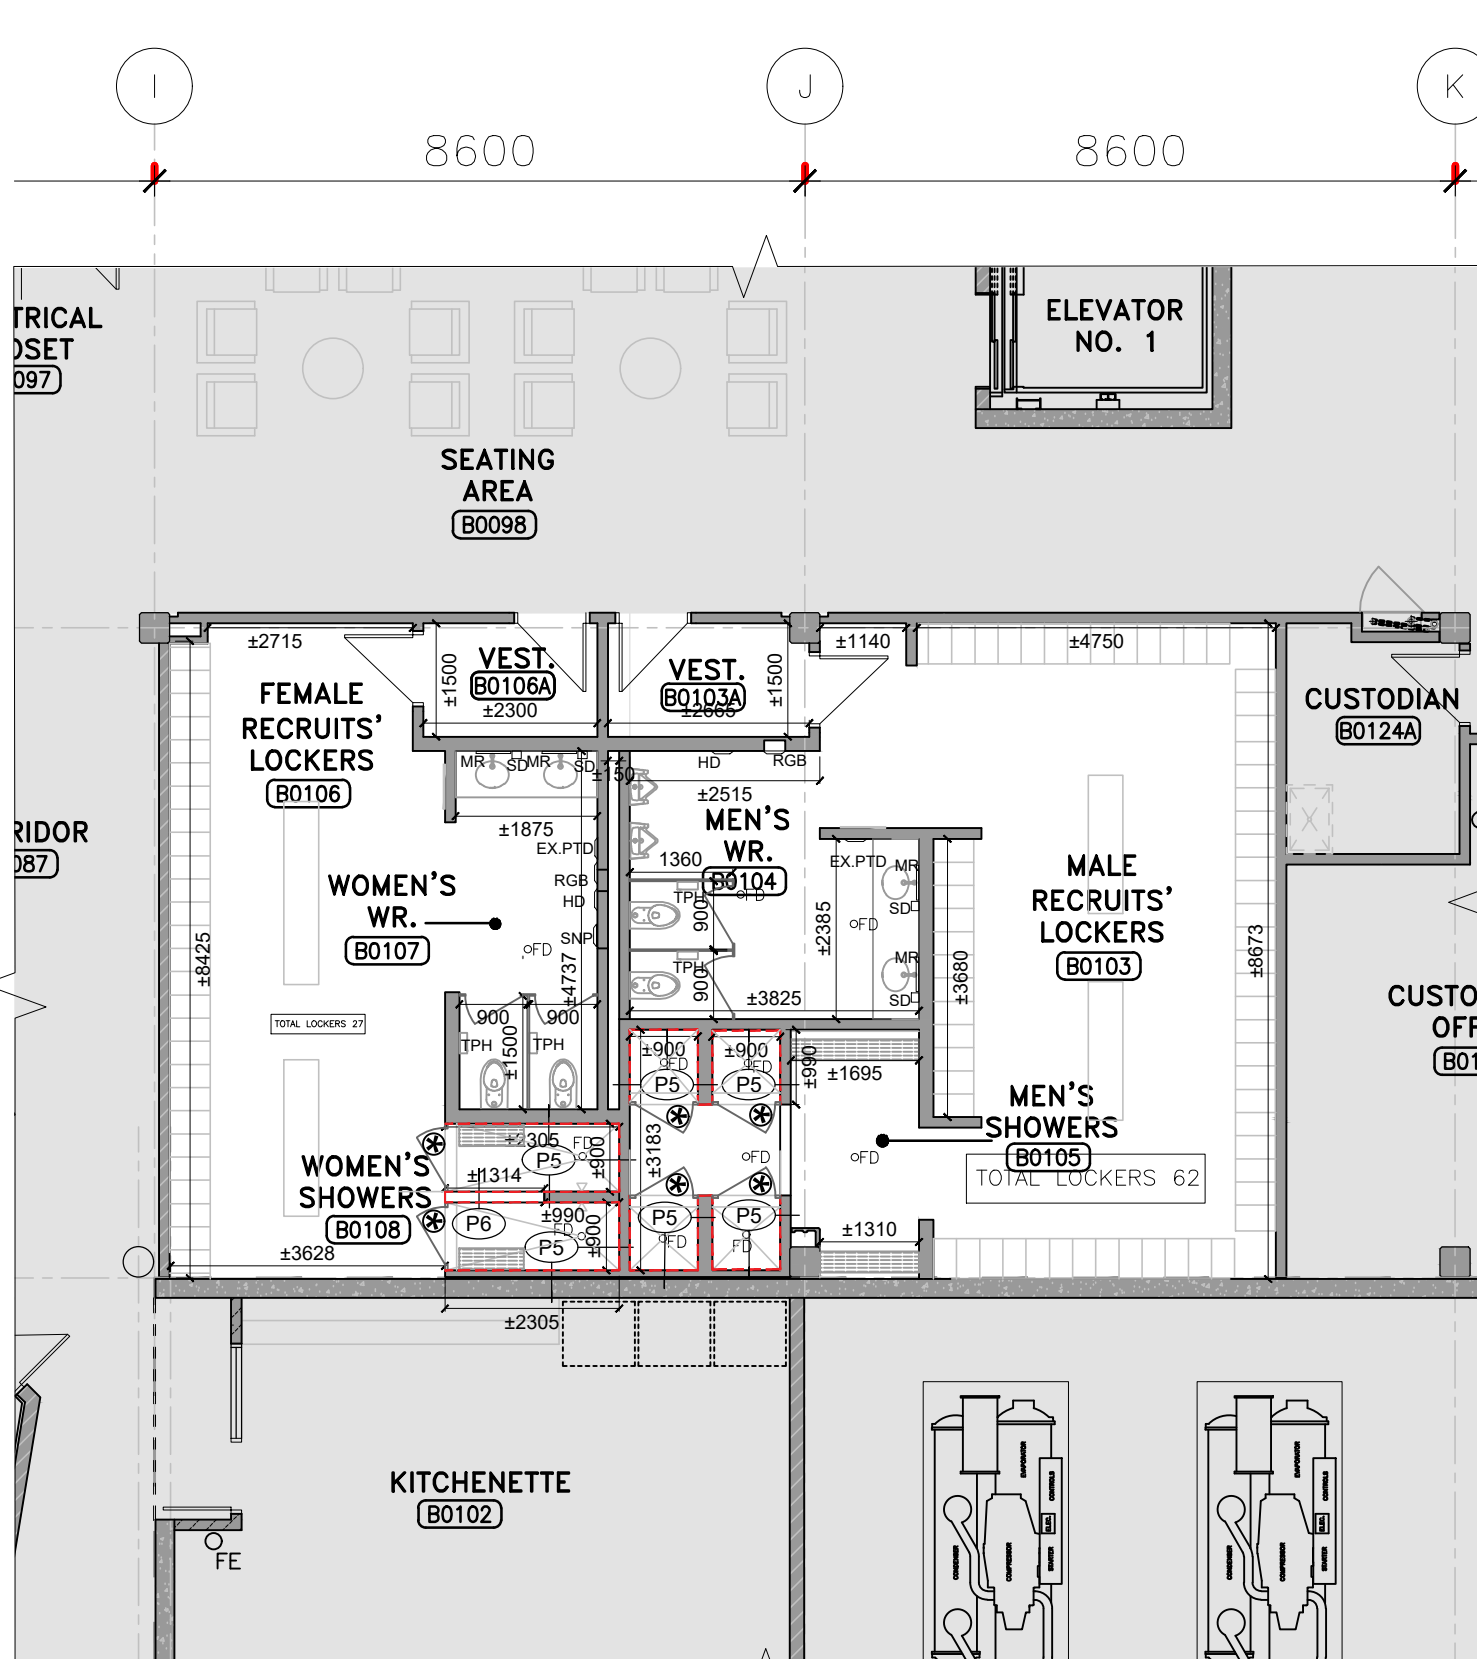

3 PARTIAL GROUND FLOOR PLAN-NEW
SCALE: 1:100

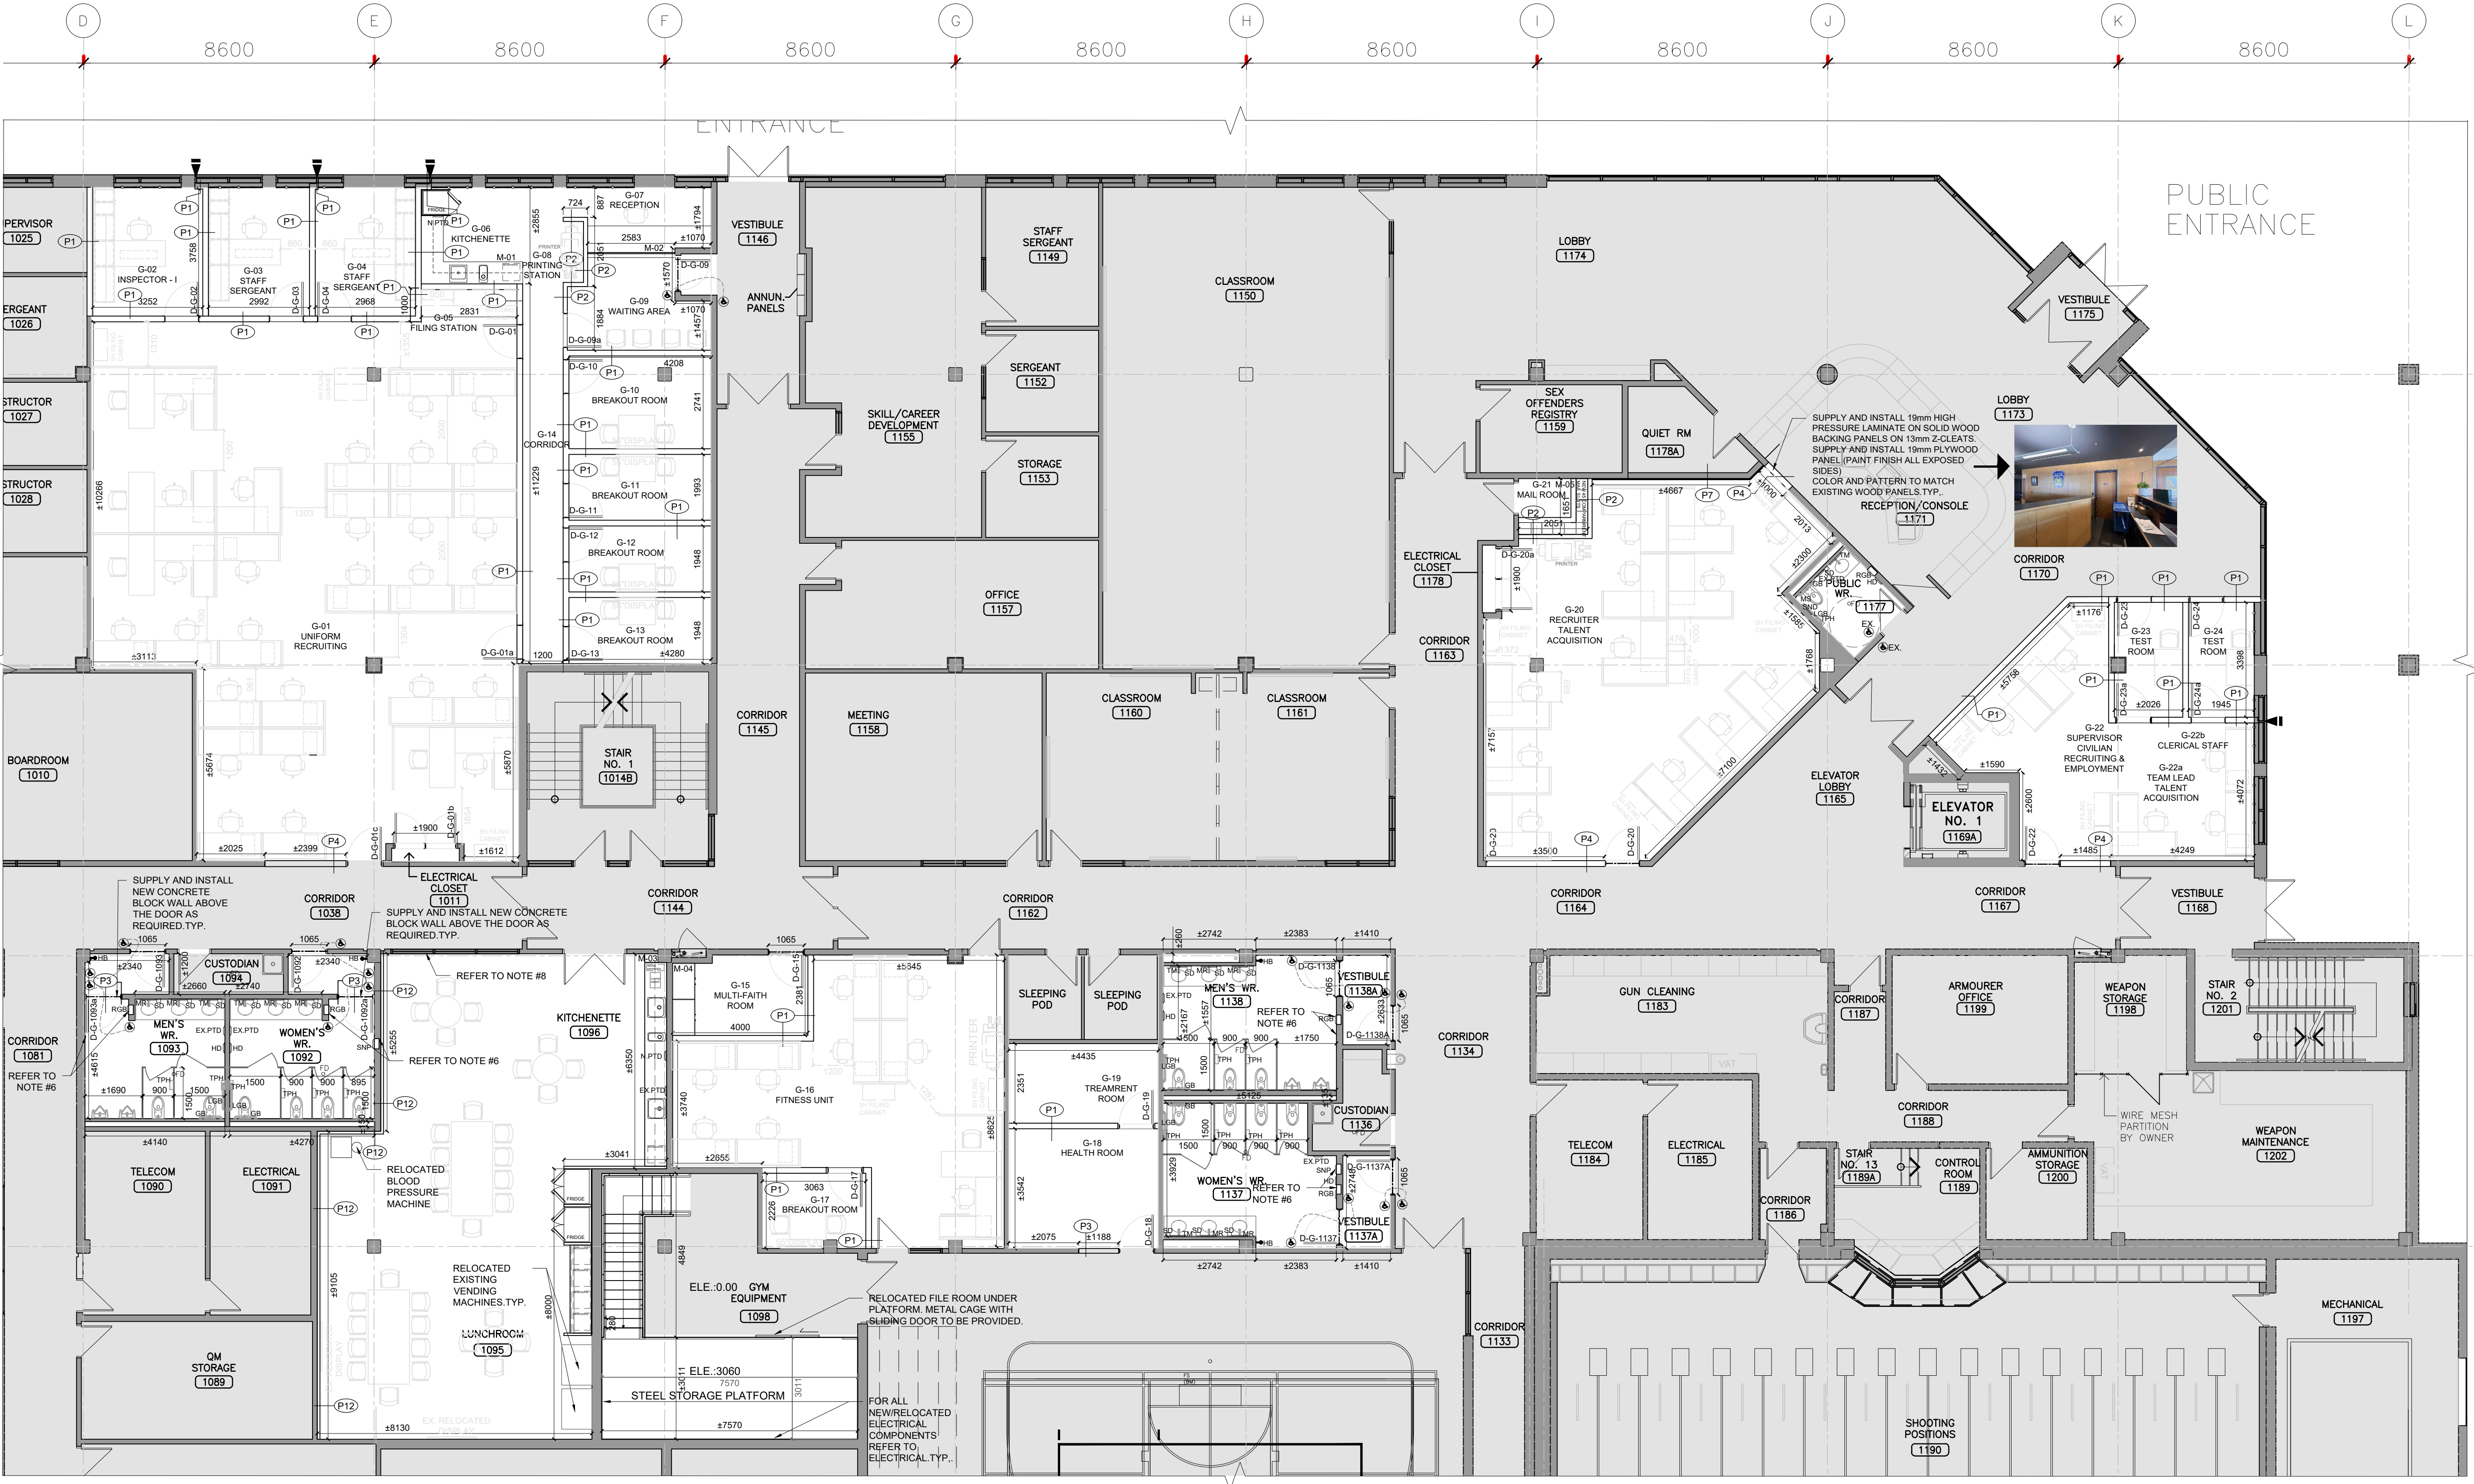- TYPICAL NOTES**
1. ALL PARTITIONS EXTEND TO UNDERSIDE OF STRUCTURAL SLAB OR ROOF DECKING UNLESS OTHERWISE NOTED EXISTING SLAB HEIGHT IS 4' 000mm TO VERIFY THE HEIGHT ON SITE.
 2. ALL PARTITIONS LISTED WITH AN STC RATING ARE TO BE SOUND SEALED AT ALL JUNCTIONS AND PENETRATIONS, TYPICAL.
 3. GENERAL CONTRACTOR IS RESPONSIBLE TO SUPPLY AND INSTALL ALL REQUIRED STEEL AND UNISTRUT FRAMING TO SUPPORT WALL OR CEILING HUNG DIGITAL SCREENS, TYPICAL.
 4. ALL STC RATED PARTITION ASSEMBLIES TO COMPLY WITH BELOW MENTIONED TESTING STANDARDS: ASTM C423 & ASTM E1414.
 5. GENERAL CONTRACTOR IS RESPONSIBLE TO SUPPLY AND INSTALL ALL REQUIRED BLOCKING, FRAMING, AND REINFORCEMENT TO SUPPORT WALL HUNG TOILETS, LAVATORIES, GRAB BARS, ETC.
 6. ALL EXISTING OPENING ON THE WALL (AFTER REMOVING RECESSED ACCESSORIES) TO BE FILLED WITH WATER RESISTANT DRYWALL ON STUD FRAMING, PAINT FINISH, TYP. TYPICAL TO ALL WASHROOMS, CHANGE ROOMS AND SHOWERS, TYP.
 7. ALL EXISTING PAPER TOWEL DISPENSERS INSTALLED IN WASHROOMS, CHANGE ROOMS, SHOWERS, AND KITCHENETTES TO BE REMOVED AND REINSTALLED.
 8. GC TO REMOVE ALL EXISTING WINDOW BLINDS INSTALLED TO EXISTING INTERIOR WINDOWS AND DOOR SIGHTGLASS, M.G.A.T. TYP. GC TO SUPPLY AND INSTALL NEW DECORATIVE WINDOW FILM TO ALL INTERIOR WINDOW AND SIGHTGLASS (GLAZING TYP. TYPICAL TO ALL WASHROOMS, CHANGE ROOMS AND SHOWERS, TYP.
 9. PATCH AND REPAIR ALL EXIST WALLS MAKE THEM READY FOR PAINT FINISH AFTER REMOVING WALL MOUNTED TV's, CLOCKS, ELECTRICAL OUTLETS, TYPICAL TO ALL RENOVATION SCOPE.
 10. GC TO REMOVE EXISTING TOILET PAPER HOLDERS, SANITARY NAPKIN DISPENSERS, SOAP DISPENSERS, PAPER TOWEL DISPENSERS, STORE THEM AND REINSTALL, M.G.A.T. TYP. FINAL LOCATIONS TO BE CONFIRMED BY ARCHITECT AND CLIENT. SEE ALSO TYPICAL DETAIL ON DRAWING A001.
 11. ALL CORNERS TO INTERIOR MASONRY WALLS TO BE ROUNDED BULLNOSE, TYP.
 12. GENERAL CONTRACTOR IS RESPONSIBLE TO SUPPLY AND INSTALL ALL REQUIRED UNISTRUT FRAMING, BLOCKING, AND REINFORCEMENT TO SUPPORT WALL HUNG TOILETS, LAVATORIES, GRAB BARS, CEILING HUNG TOILET PARTITIONS, WALL STOPS, ETC. GENERAL CONTRACTOR IS RESPONSIBLE TO COORDINATE LOCATIONS WITH SUBCONTRACTORS. SEE ALSO TYPICAL DETAIL ON DRAWING A001.
 13. GENERAL CONTRACTOR IS RESPONSIBLE TO SUPPLY AND INSTALL ALL REQUIRED STEEL AND UNISTRUT FRAMING TO SUPPORT WALL OR CEILING HUNG DIGITAL SCREENS, TYPICAL.
 14. CUT OUT SCRATCHES, CRACKS AND ABRASIONS IN WALL SURFACES AND ADJOINING TRIMS AS REQUIRED AND FILL WITH AN APPROVED NON-SHRINK PATCHING COMPOUND FLUSH WITH ADJOINING SURFACE. WHEN DRY, SAND THE PATCH SMOOTH AND SEAL BEFORE THE APPLICATION OF THE PRIME COAT.
 15. WHERE NEW WORK, INCLUDING ALL ELECTRICAL & MECHANICAL WORK CONNECTS WITH EXISTING & WHERE EXISTING WORK IS ALTERED, ALL NECESSARY CUTTING & FITTING REQUIRED TO MAKE SATISFACTORY CONNECTIONS WITH THE EXISTING WORK SHALL BE PERFORMED UNDER THIS CONTRACT, SO AS TO LEAVE THE ENTIRE WORK IN FINISHED AND WORKMANLIKE CONDITION.
 16. GENERAL CONTRACTOR IS RESPONSIBLE TO CO-ORDINATE WITH MECH & ELEC SUB-CONTRACTORS TO CONFIRM QUANTITY & LOCATION FOR THE DEMO OF ALL INCLUDING BUT NOT LIMITED TO EXISTING DUCTWORK, PIPING, CONDUIT, ETC.
 17. GENERAL CONTRACTOR TO REPAIR, PATCH, FIRESTOP & INFILL EXISTING WALLS & PARTITION OPENINGS FROM THE DEMO OF EXISTING MECH & ELEC SYSTEM (TYP. M.G.A.T.).
 18. ANY CONFLICTS, OMISSIONS, DISCREPANCIES AND DISAGREEMENT IN ARCHITECTURAL DRAWINGS AND SPECIFICATIONS SHALL BE REPORTED TO THE ARCHITECT PRIOR TO ANY PROCEEDING FOR ITS CLARIFICATIONS AND INSTRUCTIONS.
 19. AS STC RATED WALLS TO BE CONTINUED TO THE STRUCTURAL SLAB IF THERE IS ANY CONFLICT BETWEEN MECHANICAL/ELECTRICAL COMPONENTS AND NEW STC RATED WALL, GC IS RESPONSIBLE TO EITHER RELOCATE THE MECHANICAL/ELECTRICAL COMPONENT OR SUPPLY AND INSTALL THE REQUIRED BULKHEAD AROUND THE COMPONENT TO MAINTAIN THE INTEGRITY OF THE STC RATED WALL.
 20. GC TO SUPPLY AND INSTALL DRYWALL ENCLOSURE AROUND EXIST. DAMAGED/EXPOSED COLUMNS, TYP.
 21. GC TO COORDINATE THE DEMOLITION OF THE EXISTING CONCRETE BLOCK WALL DRYWALL AS REQUIRED, FOR INSTALLATION OF THE RECESSED EXISTING SANITARY NAPKIN DISPENSER UNITS AND NEW RECESSED PAPER TOWEL DISPOSAL UNITS, M.G.A.T. TYP.

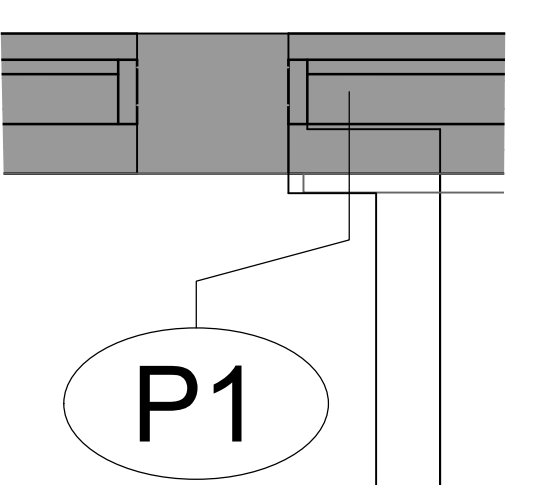

4 TYPICAL TO DRYWALL PARTITION AND GLASS JUNCTION
SCALE: N.T.S.

FLOOR PLAN LEGEND	
	EXISTING WALL OR PARTITION TO REMAIN, TYP.
	NEW STEEL STUD FRAMED WALL OR PARTITION, TYP.
	NEW DOOR, SEE DOOR SCHEDULE, TYP.
	EX. DOOR AND FRAME TO REMAIN, TYP.
	NEW PLUMBING FIXTURES, SEE MECHANICAL, TYP.
	NEW FLOOR DRAINS / HUB DRAINS, SLOPE FLOOR TOWARDS DRAIN IN ALL ROOMS THAT FLOOR DRAINS APPEAR IN, SEE MECHANICAL. ALL EXISTING FLOOR DRAINS TO BE REPLACED WITH NEW, TYP. SEE MECHANICAL.
	NEW WASHROOM PARTITIONS, TYP. REFER TO SPECIFICATIONS.
	EXTENT OF AREA NOT IN CONTRACT.
	EX. EXIT
	NEW RECESSED FIRE EXTINGUISHER CABINET, TYP. REFER TO MECHANICAL.
	NEW HOSE BIB, SEE MECHANICAL.
	MOTION SENSOR AUTOMATIC DOOR OPERATOR ACTUATOR BUTTON, TYP.
	NEW SHOWER PARTITION, HIGH DENSITY SOLID PLASTIC PARTITIONS (HDPE), REFER TO SPECIFICATIONS.
	NEW ELECTRICAL JUNCTION BOX TO BE RECESSED IN CONCRETE SLAB, TYP. SEE STRUCTURAL, SEE ELECTRICAL, REFER TO A101 SMCAT LOCATION TO BE COORDINATED BY GC.
	TYPICAL TO DRYWALL PARTITION AND GLASS JUNCTION, TERMINATE DRYWALL PARTITION TO EXISTING VERTICAL WINDOW SUPPLY AND INSTALL ACOUSTICAL QUIET JOINT BY EMBEAL OR EQUAL ON BOTH SIDES OF DRYWALL PARTITION AND GLASS, SIZE, THICKNESS AND STC RATING TO MATCH PARTITION TYPE.
	DISPLAYS, TYP. ARE NOT IN CONTRACT, TO BE SUPPLIED AND INSTALLED BY CLIENT, ROUGH IN IS UNDER GENERAL CONTRACTOR'S SCOPE OF WORK, REFER TO ELECTRICAL DRAWINGS FOR THE SCOPE OF WORK, TYP.
	NOT IN CONTRACT
	NEW STRUCTURAL LINTEL, TYP. SEE STRUCTURAL, GC TO PATCH, REPAIR & PAINT FINISH ALL THE DAMAGED SURFACES AFTER LINTEL INSTALLATION, REFER TO THE STRUCTURAL DRAWING FOR EXTENT OF WORK, ALLOW FOR SHORING EXISTING CONCRETE BLOCK WALL ABOVE THE BLOCKS AS REQUIRED FOR INSTALLATION OF THE NEW LINTEL.
	NEW WINDOW BLINDS, TYP. REFER TO SPECIFICATIONS.
	EXISTING RE-INSTALLED SOAP DISPENSER EXIST. RE-INSTALLED RECESSED SANITARY NAPKIN DISPENSER GC TO CUT EXISTING CONCRETE BLOCK WALL, DRY WALL TO ACCOMMODATE NEW SOAP DISPENSER, NEW METAL SHELF NEW SHOWER GRAB BAR NEW SHOWER GRAB BAR NEW TILTED MIRROR NEW MIRROR NEW RECESSED GARBAGE BIN, GC TO CUT EXISTING CONCRETE BLOCK WALL, DRY WALL TO ACCOMMODATE NEW GARBAGE BIN, M.G.A.T. TYP. EXISTING RE-INSTALLED PAPER TOWEL DISPENSER NEW PAPER TOWEL DISPENSER NEW HAND DRYER NEW SHOWER SHELF-REFER TO INTERIOR ELEVATIONS TYP. TYPICAL

PARTITION TYPES LEGEND	
TAG	DESCRIPTION
	GYPSUM BOARD PARTITION, STC 55, SMOKE SEAL AT JUNCTIONS AS REQUIRED, REFER TO A003.
	1-HOUR FIRE RATED VERSION TO BUILT TO UL 1418
	2 x 16 mm SHEETROCK ECONOMY GYPSUM PANEL (TYPE X F FIRE RATED), 13mm RESILIENT CHANNEL, 25ga 0.10mm O.C. STEEL STUDS AT 400mm O.C., 82 mm FIBER GLASS INSULATION IN CAVITY, 2 x 16 mm SHEETROCK ECONOMY GYPSUM PANEL (TYPE X F FIRE RATED).
	GYPSUM BOARD PARTITION, SMOKE SEAL AT JUNCTIONS AS REQUIRED, REFER TO A003.
	1-HOUR FIRE RATED VERSION TO BUILT TO UL 1418
	16mm GYPSUM WALLBOARD (TYPE X F FIRE RATED), 82mm STEEL STUDS AT 400mm O.C. BRACING IN WALL, 89mm MINERAL WOOL ACOUSTIC INSULATION IN CAVITY, 16mm GYPSUM WALLBOARD (TYPE X F FIRE RATED).
	CONCRETE BLOCK PARTITION (TO MATCH EXISTING)
	CONCRETE BLOCK PARTITION, DIMENSIONS & PATTERN TO MATCH EXISTING
	CONCRETE BLOCK PARTITION, DIMENSIONS & PATTERN TO MATCH EXISTING
	EXISTING PARTITION WITH CEMENT BOARD 16mm SCHLUTER WATERPROOFING MEMBRANE (WHERE INDICATED ON PLAN)
	CONCRETE BLOCK WALL EXTENDED 150mm ABOVE THE CEILING 16mm SCHLUTER WATERPROOFING MEMBRANE (WHERE INDICATED ON PLAN)
	EXISTING PARTITION WITH GYPSUM BOARD 13mm GYPSUM BOARD 22mm FURRING CHANNEL EXISTING CONCRETE BLOCK PARTITION
	DEMOUNTABLE PRE-MANUFACTURED GLAZED PARTITION SYSTEM - STC49 61mm FRAMING WITH CLEAR TEMPERED GLASS WITH CONTINUOUS STRIP 300mm HEIGHT FROSTED DECORATIVE FILM
	EXISTING PARTITION TO BE EXTENDED TO UNDERSIDE OF THE SLAB - SMOKE SEALED AT JUNCTIONS REFER TO A003 FOR LOCATION OF SMOKE SEALED PARTITION
	CONCRETE BLOCK PARTITION, EXTENDED 100mm ABOVE FLOOR FINISH, SUPPLY & INSTALL WOOD WALL CAP PAINT FINISH
	GYPSUM BOARD PARTITION, EXTENDED 100mm ABOVE FLOOR FINISH, SUPPLY & INSTALL WOOD WALL CAP PAINT FINISH
	GYPSUM WALLBOARD 13mm 22mm 82mm 89mm 16mm
	EXISTING PARTITION WITH GYPSUM BOARD 13mm 22mm 82mm 89mm 16mm

TYPICAL NOTES

15mm FIRE-RESISTANT PLYWOOD BACKING IF HIGH TO WALLS IN SECURITY ROOM SUPPLY & INSTALL TWO 100mmx100mmx10mm PLYWOOD BACKING.

FIRE RATING SUFFIX CODES LISTED BELOW ARE TO BE READ IN CONJUNCTION WITH WALL AND PARTITION TYPES. PROVIDE ALL FIRE-RATED WALLS WITH FIRESTOPPING AND SMOKE SEALS AT ALL JUNCTIONS AND PENETRATIONS, TYPICAL.

A 1 HOUR

13. ISSUED FOR TENDER 2026.05.01

12. ISSUED FOR BUILDING POINT 2026.04.08

11. ISSUED FOR 100% CLIENT REVIEW 2026.03.31

10. ISSUED FOR 100% CLIENT REVIEW 2026.10.09

9. ISSUED FOR DESIGN DEVELOPMENT CLIENT REVIEW 2025.10.24

8. ISSUED FOR PRELIMINARY DESIGN CLIENT REVIEW 2025.09.03

7. ISSUED FOR PRELIMINARY DESIGN CLIENT REVIEW 2025.08.18

6. ISSUED FOR PRELIMINARY DESIGN CLIENT REVIEW 2025.08.12

5. ISSUED FOR PRELIMINARY DESIGN CLIENT REVIEW 2025.08.01

4. ISSUED FOR PRELIMINARY DESIGN CLIENT REVIEW 2025.07.30

3. ISSUED FOR PRELIMINARY DESIGN CLIENT REVIEW 2025.07.25

2. ISSUED FOR PRELIMINARY DESIGN CLIENT REVIEW 2025.07.14

1. ISSUED FOR PRELIMINARY DESIGN CLIENT REVIEW 2025.07.14

NO. DESCRIPTION DATE

REVISIONS

PROJECT

PEEL REGIONAL POLICE

REGION OF PEEL

EMIL V. KOLB CENTRE
PEEL REGIONAL POLICE FACILITY
INTERIOR RENOVATION PROJECT
181 DERRY ROAD EAST, MISSISSAUGA, ON L5T 2Y5

STRUCTURAL CONSULTANT
Stephenson Engineering
MECHANICAL CONSULTANT
EXP Services Inc.
ELECTRICAL CONSULTANT
EXP Services Inc.


SHEET TITLE
PARTIAL BASEMENT &
GROUND FLOOR PLAN-NEW

SHEET NO.
A200

DRAWN BY
SZ


CHECKED BY
RN

PROJECT NO.
SCALE
AS NOTED

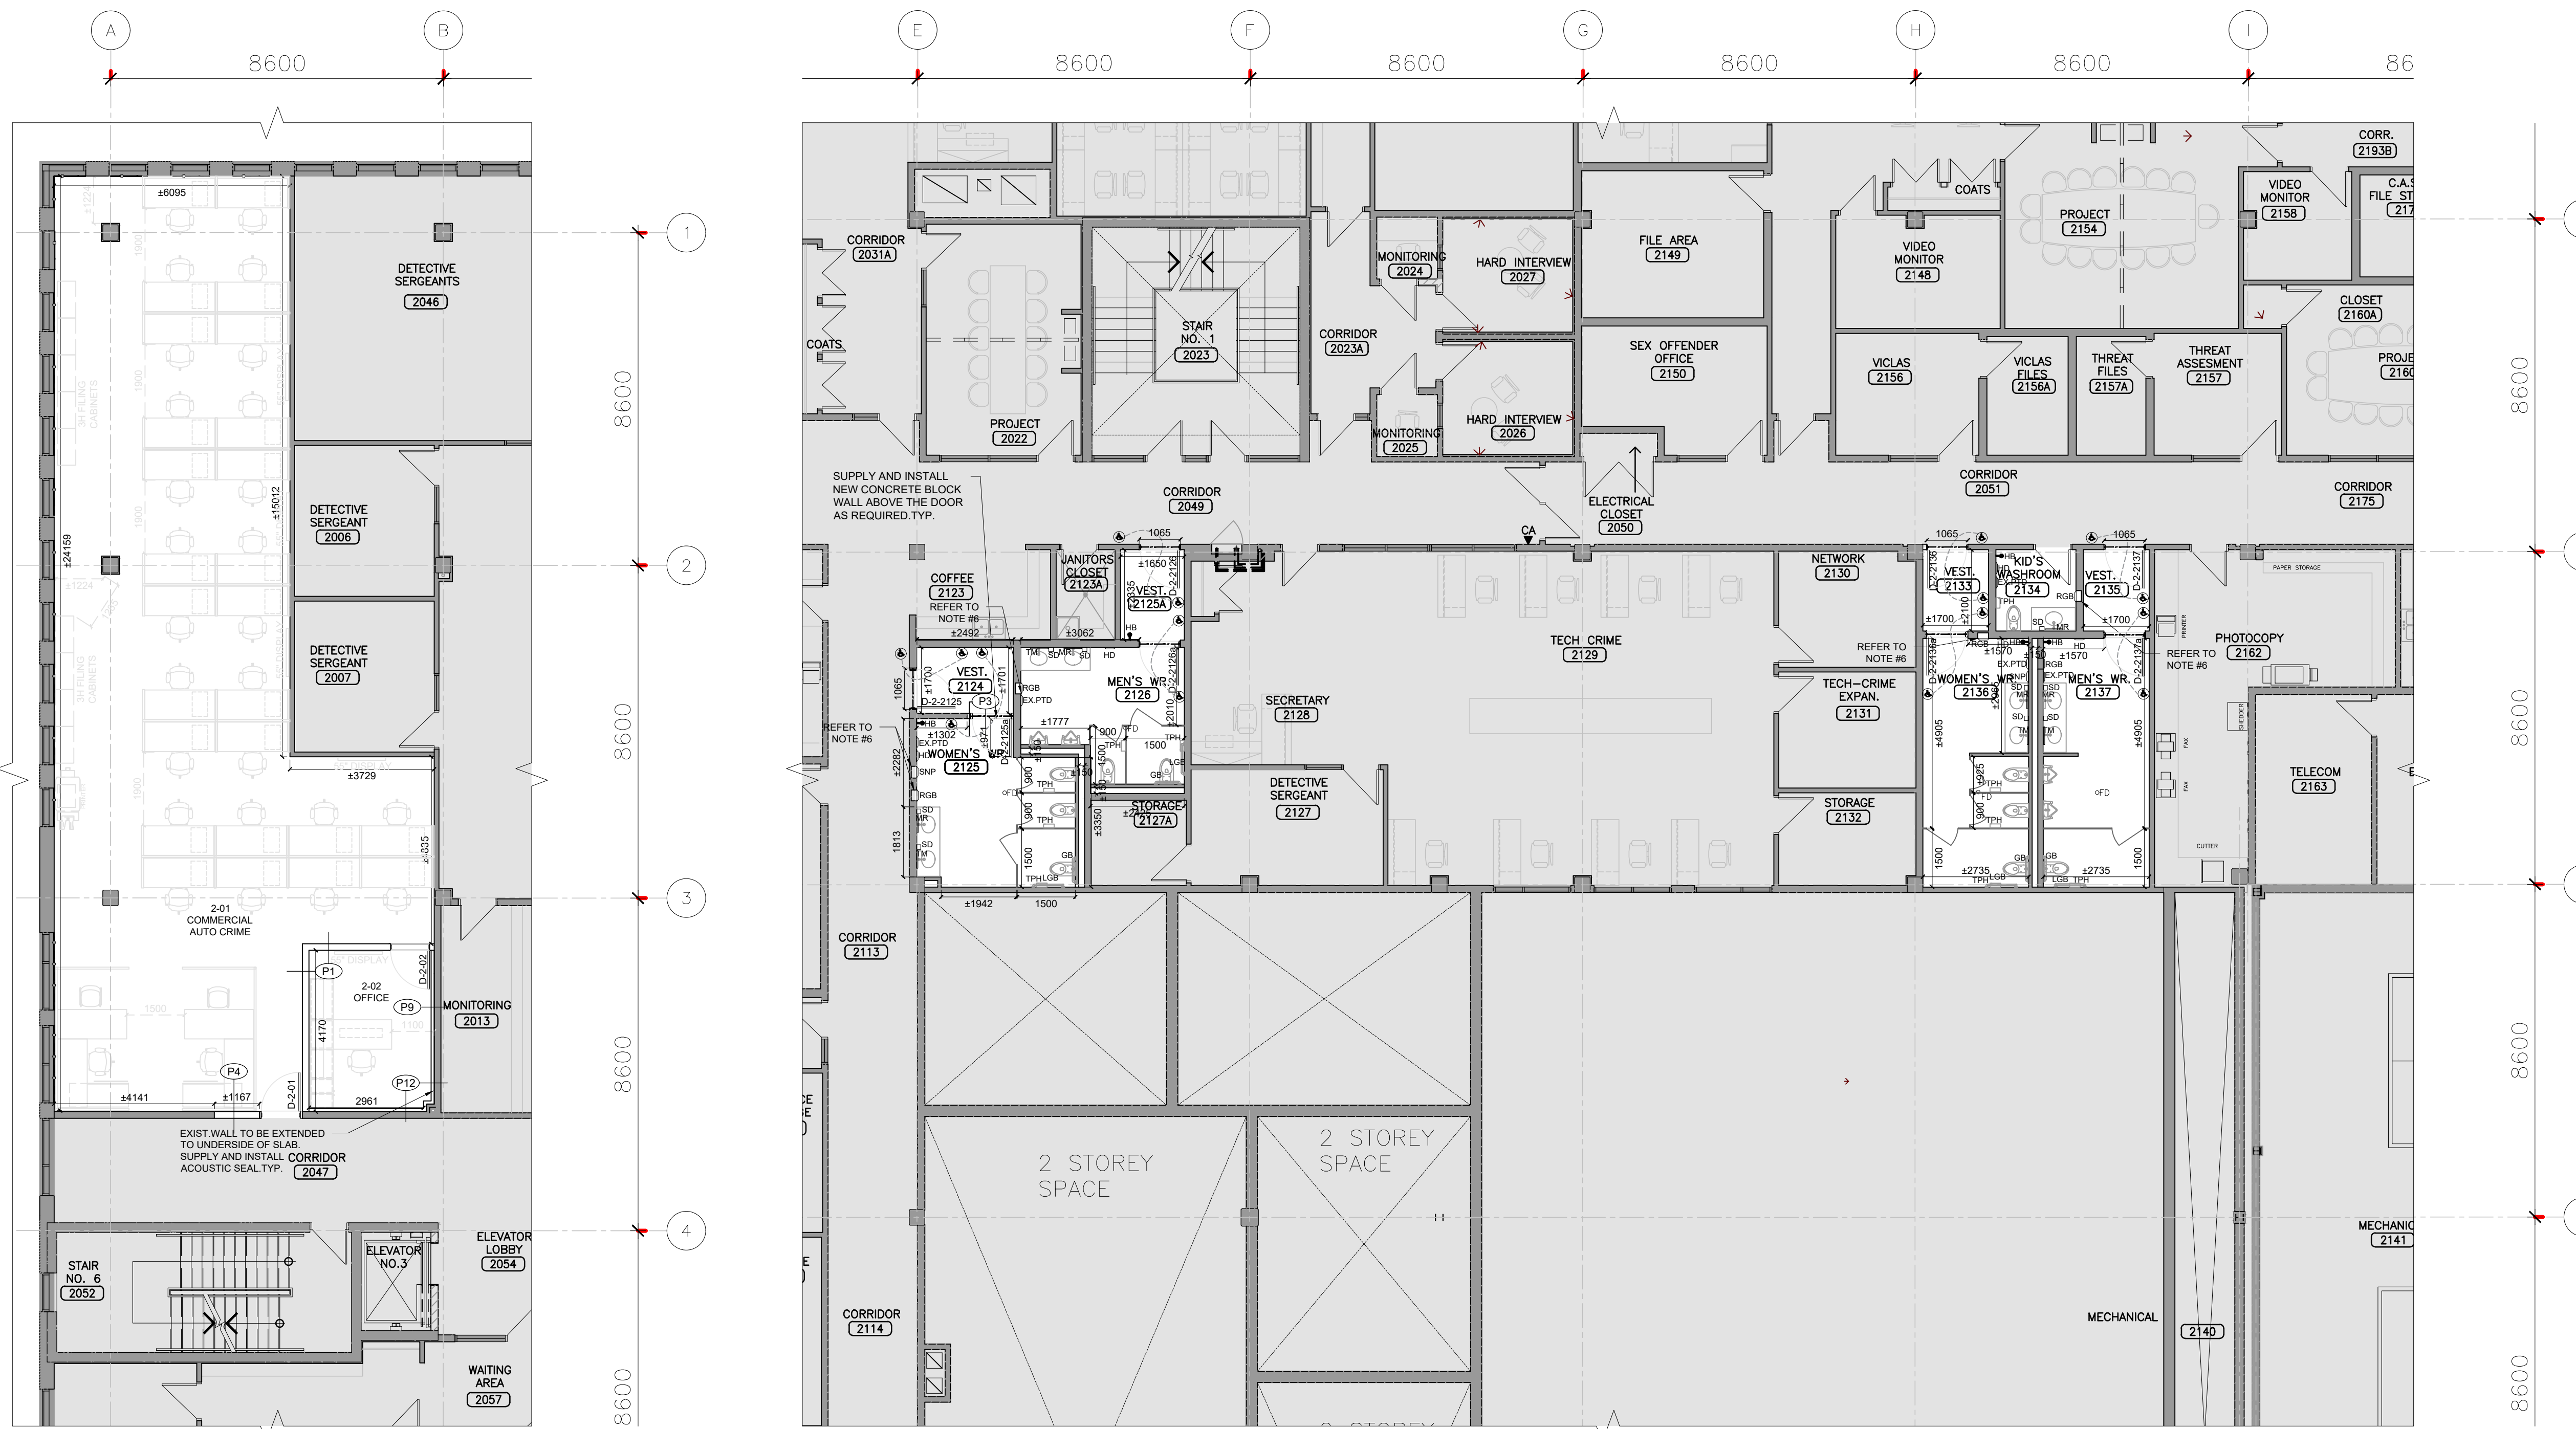

1 PARTIAL SECOND FLOOR PLAN-NEW
SCALE: 1:100

2 PARTIAL SECOND FLOOR PLAN (WASHROOMS)-NEW
SCALE: 1:100

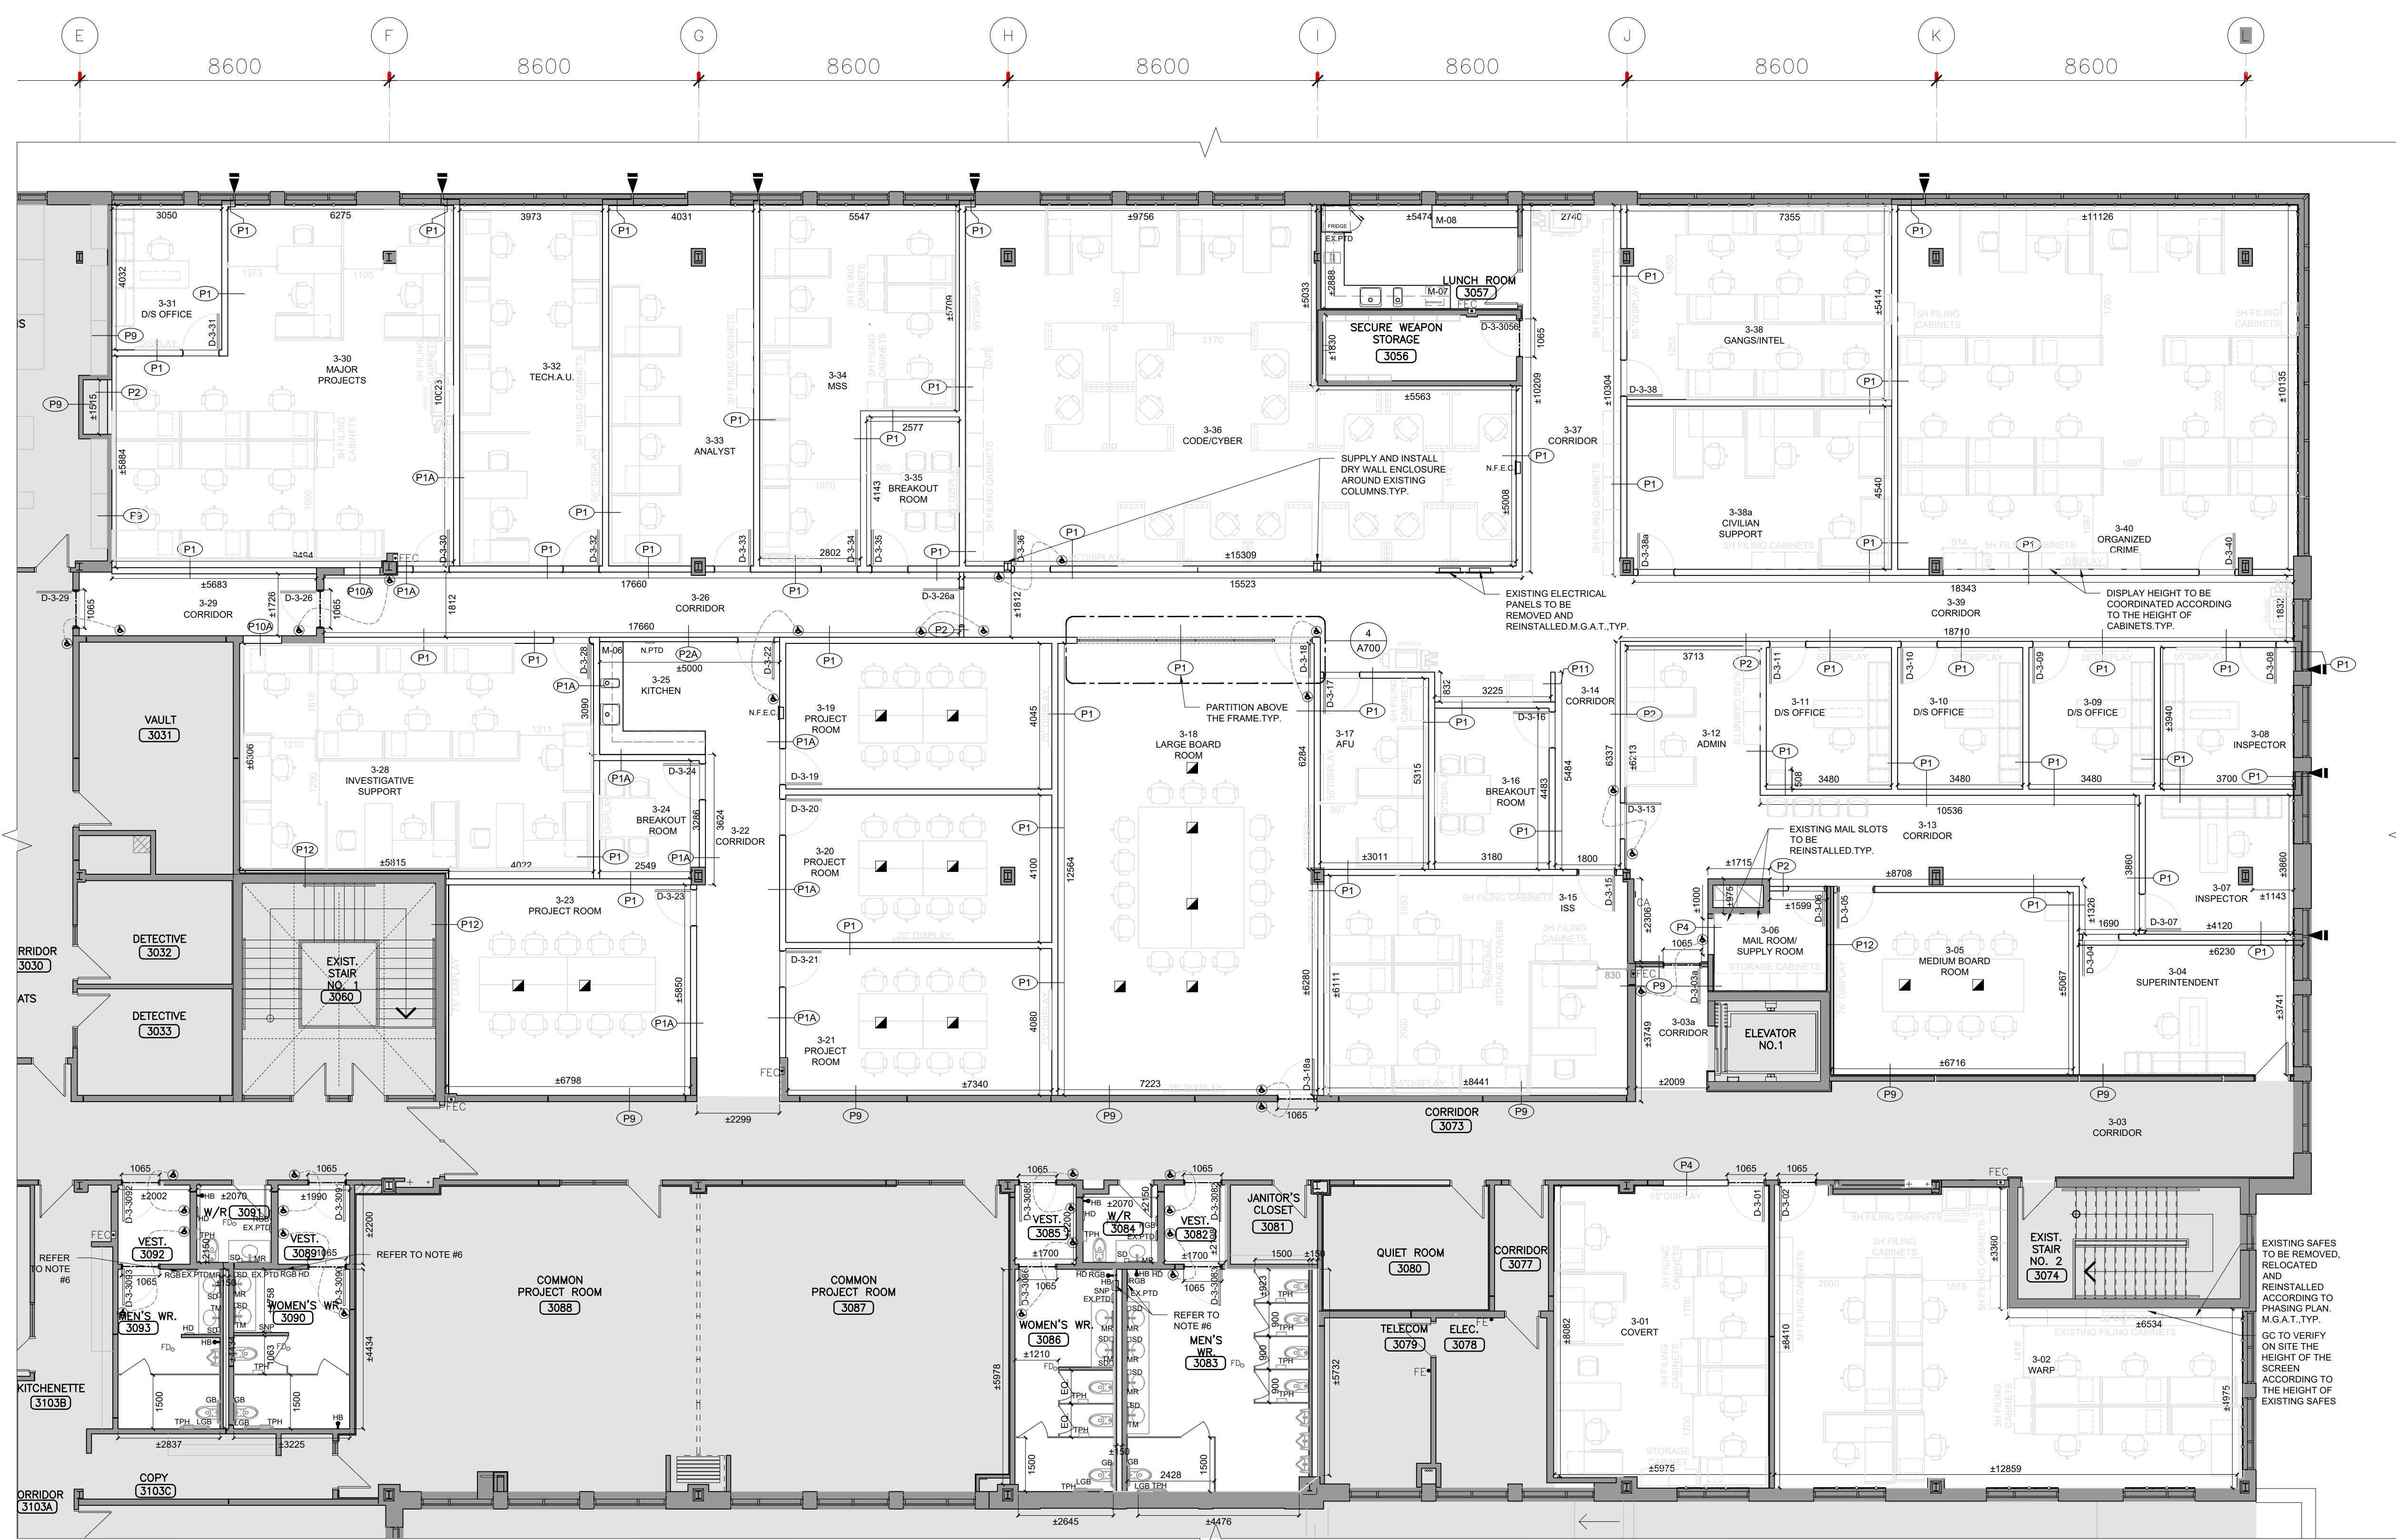

3 PARTIAL THIRD FLOOR PLAN-DEMO
SCALE: 1:100

- TYPICAL NOTES**
1. ALL PARTITIONS EXTEND TO UNDERSIDE OF STRUCTURAL SLAB OR ROOF DECKING UNLESS OTHERWISE NOTED. EXISTING SLAB HEIGHT IS 4.400m. GC TO VERIFY THE HEIGHT ON SITE.
2. ALL PARTITIONS LISTED WITH AN STC RATING ARE TO BE SOUND SEALED AT ALL JOINTS AND PENETRATIONS, TYPICAL.
3. GENERAL CONTRACTOR IS RESPONSIBLE TO SUPPLY AND INSTALL ALL REQUIRED STEEL AND UNISTRUT FRAMING TO SUPPORT WALL OR CEILING HUNG DIGITAL SCREENS, TYPICAL.
4. ALL STC RATED PARTITION ASSEMBLIES TO COMPLY WITH BELOW MENTIONED TESTING STANDARDS: ASTM C423 & ASTM E1414.
5. GENERAL CONTRACTOR IS RESPONSIBLE TO SUPPLY AND INSTALL ALL REQUIRED BLOCKING, FRAMING, AND REINFORCEMENT TO SUPPORT WALL HUNG TOILETS, LAVATORIES, GRAB BARS, ETC.
6. ALL EXISTING OPENING ON THE WALL (AFTER REMOVING RECESSED ACCESSORIES) TO BE FILLED WITH WATER RESISTANT DRYWALL ON STUD FRAMING, PAINT FINISH, TYP. TYPICAL TO ALL WASHROOMS, CHANGE ROOMS AND SHOWERS, TYP.
7. ALL EXISTING PAPER TOWEL DISPENSERS INSTALLED IN WASHROOMS, CHANGE ROOMS, SHOWERS, AND KITCHENETTES TO BE REMOVED AND REINSTALLED.
8. GC TO REMOVE ALL EXISTING WINDOW BLINDS INSTALLED TO EXISTING INTERIOR WINDOWS AND DOOR SIGHTGLASS, M.G.A.T. TYP. GC TO SUPPLY AND INSTALL NEW DECORATIVE WINDOW FILM TO ALL INTERIOR WINDOW AND SIGHTGLASS TYP.
9. PATCH AND REPAIR ALL EXIST WALLS MAKE THEM READY FOR PAINT FINISH AFTER REMOVING WALL MOUNTED TVs, CLOCKS, ELECTRICAL OUTLETS, TYPICAL TO ALL RENOVATION SCOPE.
10. GC TO REMOVE EXISTING TOILET PAPER HOLDERS, SANITARY NAPKIN DISPENSERS, SOAP DISPENSERS, PAPER TOWEL DISPENSERS, STORE THEM AND REINSTALL, M.G.A.T. TYP. FINAL LOCATIONS TO BE CONFIRMED BY ARCHITECT AND CLIENT.
11. ALL CORNERS TO INTERIOR MASONRY WALLS TO BE ROUNDED BULDOSE, TYP.
12. GENERAL CONTRACTOR IS RESPONSIBLE TO SUPPLY AND INSTALL ALL REQUIRED UNISTRUT FRAMING, BLOCKING, AND REINFORCEMENT TO SUPPORT WALL HUNG TOILETS, LAVATORIES, GRAB BARS, CEILING HUNG TOILET PARTITIONS, WALL STOPS, ETC. GENERAL CONTRACTOR IS RESPONSIBLE TO COORDINATE LOCATIONS WITH SUBCONTRACTORS. SEE ALSO TYPICAL DETAIL ON DRAWING A001.
13. GENERAL CONTRACTOR IS RESPONSIBLE TO SUPPLY AND INSTALL ALL REQUIRED STEEL AND UNISTRUT FRAMING TO SUPPORT WALL OR CEILING HUNG DIGITAL SCREENS, TYPICAL.
14. CUT OUT SCRATCHES, CRACKS AND ABRASIONS IN WALL SURFACES AND ADJOINING TRIMS AS REQUIRED AND FILL WITH AN APPROVED NON-SHRINK PATCHING COMPOUND FLUSH WITH ADJOINING SURFACE. WHEN DRY, SAND THE PATCH SMOOTH AND SEAL, BEFORE THE APPLICATION OF THE PRIME COAT.
15. WHERE NEW WORK, INCLUDING ALL ELECTRICAL & MECHANICAL WORK CONNECTS WITH EXISTING & WHERE EXISTING WORK IS ALTERED, ALL NECESSARY CUTTING & FITTING REQUIRED TO MAKE SATISFACTORY CONNECTIONS WITH THE EXISTING WORK SHALL BE PERFORMED UNDER THIS CONTRACT, SO AS TO LEAVE THE ENTIRE WORK IN FINISHED AND WORKMANLIKE CONDITION.
16. GENERAL CONTRACTOR IS RESPONSIBLE TO COORDINATE WITH MECH & ELEC SUB-CONTRACTORS TO CONFIRM QUANTITY & LOCATION FOR THE DEMO OF ALL INCLUDING BUT NOT LIMITED TO EXISTING DUCTWORK, PIPING, CONDUIT, ETC.
17. GENERAL CONTRACTOR TO REPAIR, PATCH, FIRESTOP & INFILL EXISTING WALLS & PARTITION OPENINGS FROM THE DEMO OF EXISTING MECH & ELEC SYSTEM (TYP. M.G.A.T.).
18. ANY CONFLICTS, OMISSIONS, DISCREPANCIES AND DISAGREEMENT IN ARCHITECTURAL DRAWINGS AND SPECIFICATIONS SHALL BE REPORTED TO THE ARCHITECT PRIOR TO ANY PROCEEDING FOR ITS CLARIFICATIONS AND INSTRUCTIONS.
19. ALL STC RATED WALLS TO BE CONTINUED TO THE STRUCTURAL SLAB. IF THERE IS ANY CONFLICT BETWEEN MECHANICAL/ELECTRICAL COMPONENTS AND NEW STC RATED WALL, GC IS RESPONSIBLE TO EITHER RELOCATE THE MECHANICAL/ELECTRICAL COMPONENT OR SUPPLY AND INSTALL THE REQUIRED BULKHEAD AROUND THE COMPONENT TO MAINTAIN THE INTEGRITY OF THE STC RATED WALL.
20. GC TO SUPPLY AND INSTALL DRYWALL ENCLOSURE AROUND EXIST. DAMAGED/EXPOSED AREAS, TYP.
21. GC TO COORDINATE THE DEMOLITION OF THE EXISTING CONCRETE BLOCK WALL/DRYWALL AS REQUIRED, FOR INSTALLATION OF THE RECESSED EXISTING SANITARY NAPKIN DISPENSER UNITS AND NEW RECESSED PAPER TOWEL DISPOSAL UNITS, M.G.A.T. TYP.

FLOOR PLAN LEGEND	
	EXISTING WALL OR PARTITION TO REMAIN, TYP.
	NEW STEEL STUD FRAMED WALL OR PARTITION, TYP.
	NEW DOOR, SEE DOOR SCHEDULE, TYP.
	EX. DOOR AND FRAME TO REMAIN, TYP.
	NEW PLUMBING FIXTURES, SEE MECHANICAL, TYP.
	NEW FLOOR DRAINS / HUB DRAINS, SLOPE FLOOR TOWARDS DRAIN IN ALL ROOMS THAT FLOOR DRAINS APPEAR IN, SEE MECHANICAL. ALL EXISTING FLOOR DRAINS TO BE REPLACED WITH NEW, TYP. SEE MECHANICAL.
	NEW WASHROOM PARTITIONS, TYP. REFER TO SPECIFICATIONS.
	EXTENT OF AREA NOT IN CONTRACT.
	EX. EXIT
	EXISTING RECESSED FIRE EXTINGUISHER CABINET TO REMAIN.
	NEW RECESSED FIRE EXTINGUISHER CABINET, TYP. REFER TO MECHANICAL.
	NEW HOSE BIB, SEE MECHANICAL.
	MOTION CENSORED AUTOMATIC DOOR OPERATOR ACTUATOR BUTTON, TYP.
	NEW SHOWER PARTITION, HIGH DENSITY SOLID PLASTIC PARTITIONS (HDP), REFER TO SPECIFICATIONS.
	NEW ELECTRICAL/AVT JUNCTION BOX TO BE RECESSED IN CONCRETE SLAB, TYP. SEE STRUCTURAL. SEE ELECTRICAL, REFER TO A101.5M4T. LOCATION TO BE COORDINATED BY GC.
	TYPICAL TO DRYWALL, PARTITION AND GLASS JUNCTION TERMINATE DRYWALL PARTITION TO EXISTING VERTICAL WINDOW SUPPLY AND INSTALL ACOUSTICAL, QUIET JOINT BY EMBEAL OR EQUALANT BETWEEN DRYWALL PARTITION AND GLASS. SIZE, THICKNESS AND STC RATING TO MATCH PARTITION TYPE.
	DISPLAYS, TYP. ARE NOT IN CONTRACT. TO BE SUPPLIED AND INSTALLED BY CLIENT. ROUGH IN IS UNDER GENERAL CONTRACTOR'S SCOPE OF WORK. REFER TO ELECTRICAL DRAWINGS FOR THE SCOPE OF WORK, TYP.
	NOT IN CONTRACT
	NEW STRUCTURAL UNIT, TYP. SEE STRUCTURAL. GC TO PATCH, REPAIR & PAINT FINISH ALL THE DAMAGED SURFACES AFTER UNIT INSTALLATION. REFER TO THE STRUCTURAL DRAWING FOR EXTENT OF WORK. ALLOW FOR SHORING EXISTING CONCRETE BLOCK WALL ABOVE THE BLOCKS AS REQUIRED FOR INSTALLATION OF THE NEW UNIT.
	NEW WINDOW BLINDS, TYP. REFER TO SPECIFICATIONS.
	EXISTING RE-INSTALLED SOAP DISPENSER
	EXISTING RE-INSTALLED RECESSED SANITARY NAPKIN DISPENSER GC TO CUT EXISTING CONCRETE BLOCK WALL, DRY WALL, TO ACCOMMODATE NEW SOAP, M.G.A.T. TYP.
	EXISTING RE-INSTALLED TOILET PAPER HOLDER
	NEW WHITE GRAB BAR
	NEW WHITE MIRROR
	NEW RECESSED GARBAGE BIN, GC TO CUT EXISTING CONCRETE BLOCK WALL, DRY WALL, TO ACCOMMODATE NEW GARBAGE BIN, M.G.A.T. TYP.
	EXISTING RE-INSTALLED PAPER TOWEL DISPENSER
	NEW HAND DRYER
	NEW SHOWER SHELF-REFER TO INTERIOR ELEVATIONS
	EXISTING
	TYPICAL

PARTITION TYPES LEGEND	
TAG	DESCRIPTION
	GYPSUM BOARD PARTITION, STC 55, SMOKE SEAL AT JUNCTIONS AS REQUIRED, REFER TO A203.
	1-HOUR FIRE RATED VERSION TO BUILT TO UL1419
	2 x 16 mm SHEETROCK ECONOMY GYPSUM PANEL (TYPE X F FIRE RATED)
	13mm RESILIENT CHANNEL, 25ga, 610mm O.C.
	82 mm STEEL STUDS AT 400mm O.C.
	88 mm FIBER GLASS INSULATION IN CAVITY
	2 x 16 mm SHEETROCK ECONOMY GYPSUM PANEL (TYPE X F FIRE RATED)
	16mm GYPSUM WALLBOARD (TYPE X F FIRE RATED)
	82 mm STEEL STUDS AT 400 mm O.C. Bracing in wdg.
	88 mm MINERAL WOOL ACOUSTIC INSULATION IN CAVITY
	16 mm GYPSUM WALLBOARD (TYPE X F FIRE RATED)
	CONCRETE BLOCK PARTITION (TO MATCH EXISTING)
	CONCRETE BLOCK PARTITION (TO MATCH EXISTING)
	CONCRETE BLOCK PARTITION, DIMENSIONS & PATTERN TO MATCH EXISTING
	EXISTING PARTITION WITH CEMENT BOARD
	EXISTING PARTITION WITH CEMENT BOARD
	CONCRETE BLOCK WALL EXTENDED 150mm ABOVE THE CEILING
	CONCRETE BLOCK WALL EXTENDED 150mm ABOVE THE CEILING
	EXISTING PARTITION WITH GYPSUM BOARD
	EXISTING PARTITION WITH GYPSUM BOARD
	DEMOUNTABLE PRE-MANUFACTURED GLAZED PARTITION SYSTEM - STC49
	FRAMING WITH CLEAR TEMPERED GLASS WITH CONTINUOUS STRIP 300mm HEIGHT FROSTED DECORATIVE FILM
	EXISTING PARTITION TO BE EXTENDED TO UNDERSIDE OF THE SLAB - SMOKE SEALED AT JUNCTIONS
	EXISTING PARTITION TO BE EXTENDED TO UNDERSIDE OF THE EXISTING STRUCTURAL SLAB, SMOKE SEAL AT JUNCTIONS
	SUPPLY AND INSTALL 16mm GYPSUM WALLBOARD ON BOTH SIDES OF STUDS, TAPE ALL DRYWALL JOINTS, SMOKE SEALED AT JUNCTIONS, REFER TO A203 FOR LOCATION OF SMOKE SEALED PARTITION
	CONCRETE BLOCK PARTITION (TO MATCH EXISTING 1-HOUR FIRE RATED VERSION TO BUILT TO UL1419)
	13 mm GYPSUM BOARD (TYPE X F FIRE RATED)
	22 mm RESILIENT CHANNEL
	CONCRETE BLOCK PARTITION, DIMENSIONS & PATTERN TO MATCH EXISTING
	13mm GYPSUM BOARD (TYPE X F FIRE RATED)
	GYPSUM BOARD PARTITION, EXTENDED 100mm ABOVE FLOOR FINISH, SUPPLY AND INSTALL WOOD WALL CAP PAINT FINISH
	16mm GYPSUM WALLBOARD
	82 mm STEEL STUDS AT 400 mm O.C. Bracing in wdg.
	88 mm MINERAL WOOL ACOUSTIC INSULATION IN CAVITY
	16 mm GYPSUM WALLBOARD
	EXISTING CONCRETE BLOCK PARTITION
	82 mm STEEL STUDS AT 400 mm O.C. Bracing in wdg.
	16 mm GYPSUM WALLBOARD

- TYPICAL NOTES**
- 16mm FIRE-RESISTANT PLYWOOD BACKING 8' HIGH TO WALLS IN SECURITY ROOM SUPPLY & INSTALL TWO 100mmx100mmx10mm PLYWOOD BACKING.
- FIRE RATING SUFFIX CODES LISTED BELOW ARE TO BE READ IN CONJUNCTION WITH WALL AND PARTITION TYPES. PROVIDE ALL FIRE-RATED WALLS WITH FIRESTOPPING AND SMOKE SEALS AT ALL JUNCTIONS AND PENETRATIONS, TYPICAL.
- A 1 HOUR

PEEL REGIONAL POLICE

REGION OF PEEL

EMIL V. KOLB CENTRE
PEEL REGIONAL POLICE FACILITY
INTERIOR RENOVATION PROJECT
181 DERRY ROAD EAST, MISSISSAUGA, ON L5T 2Y5

STRUCTURAL CONSULTANT
Stephenson Engineering
WESTON/COLETT/DOY

ELECTRICAL CONSULTANT
EXP Services Inc.



SHEET TITLE
PARTIAL SECOND & THIRD
FLOOR PLAN-NEW

SHEET NO.
A201


DRAWN BY
SZ

CHECKED
RN

SCALE
AS NOTED

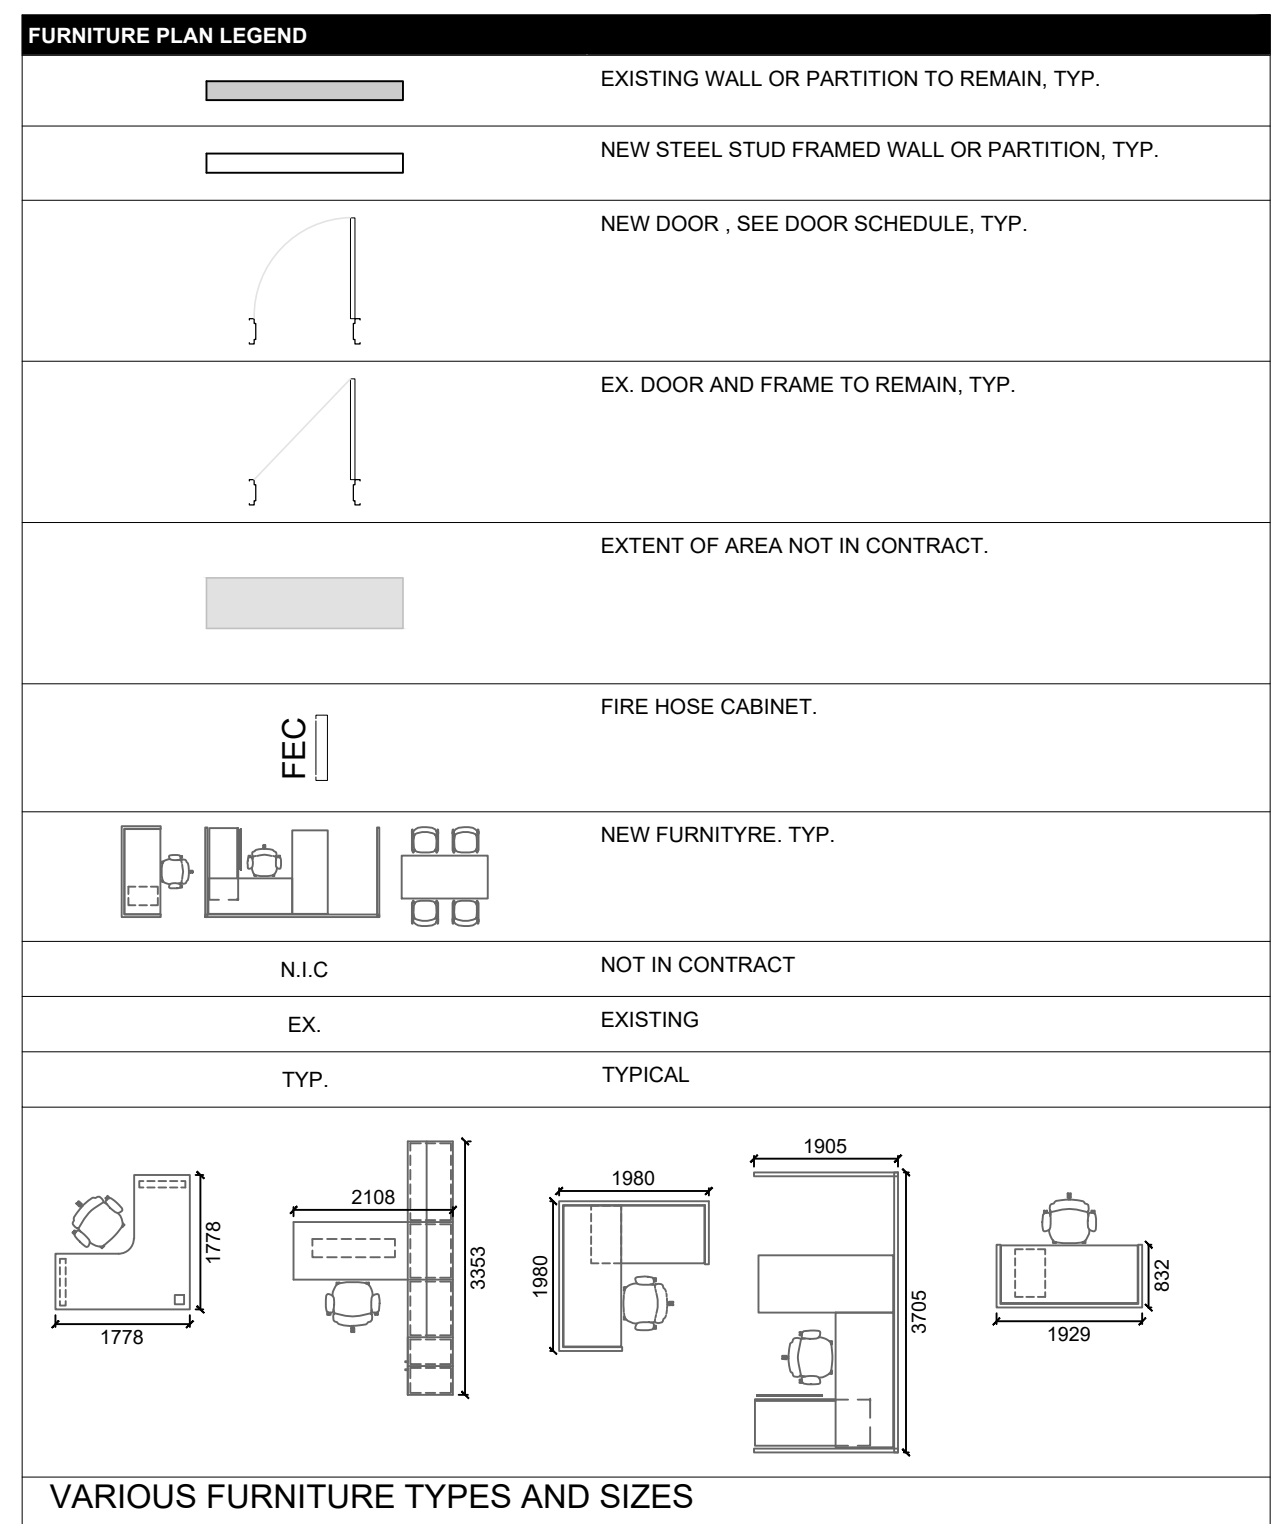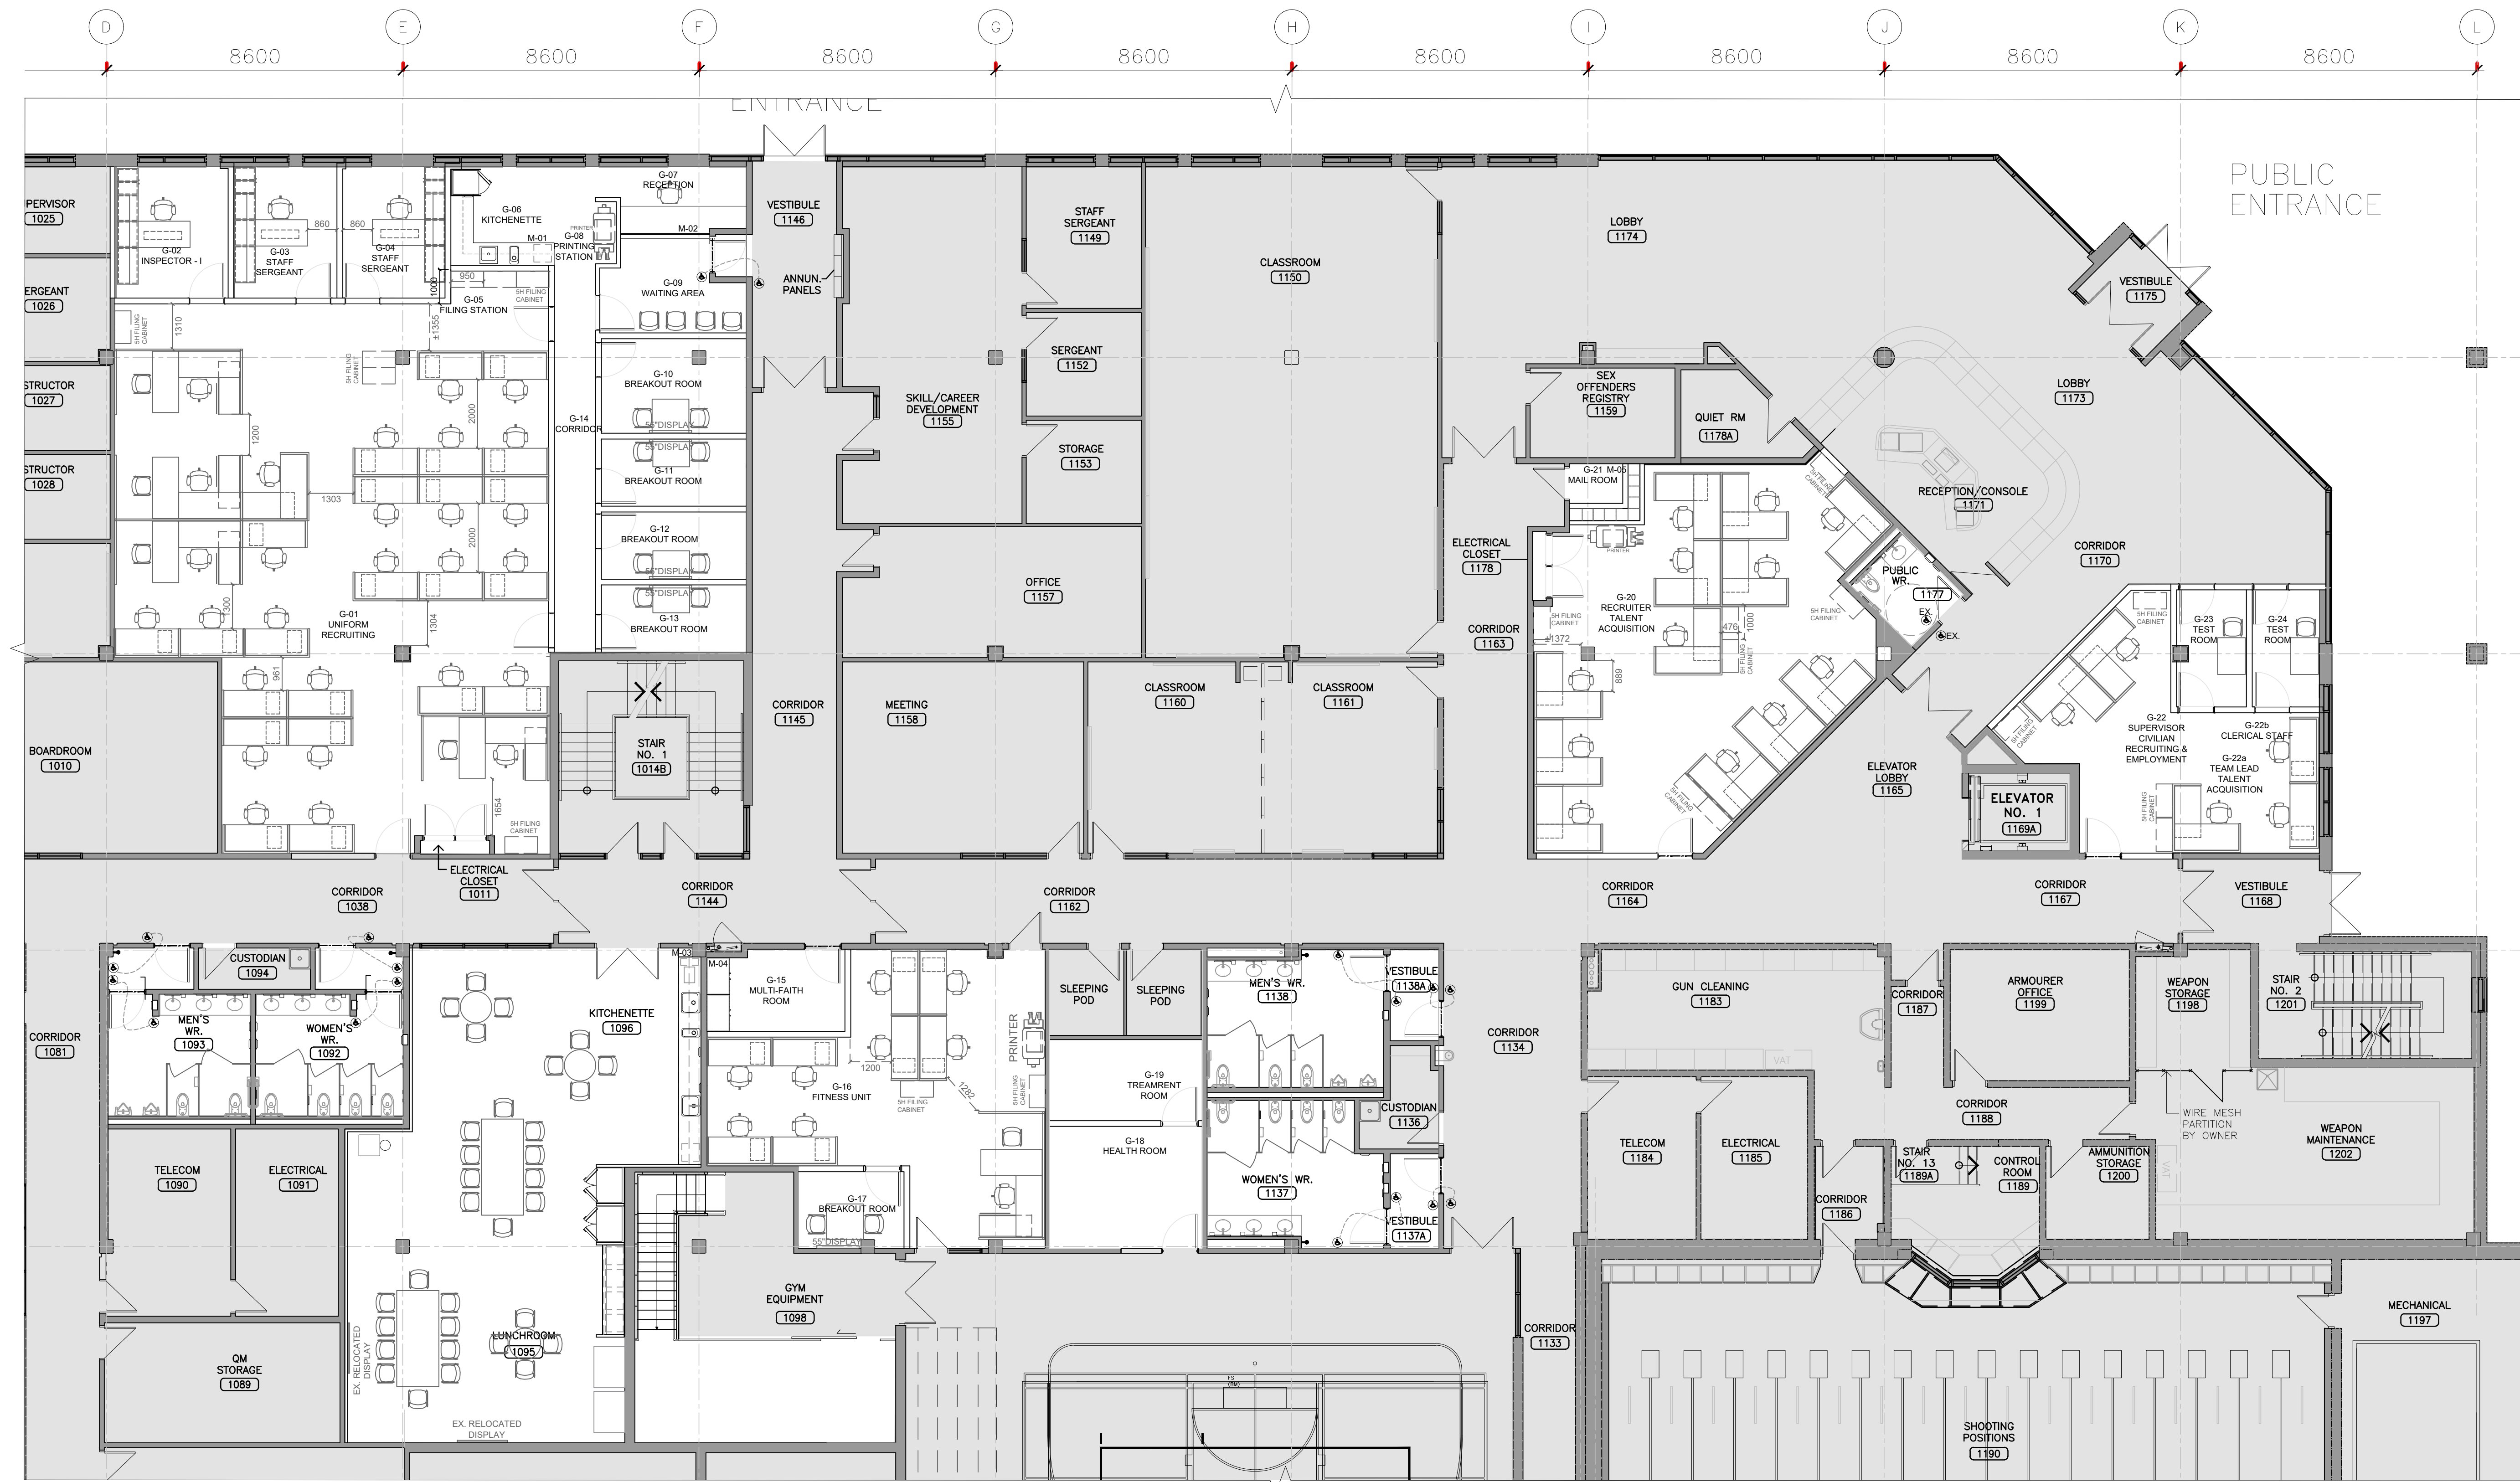

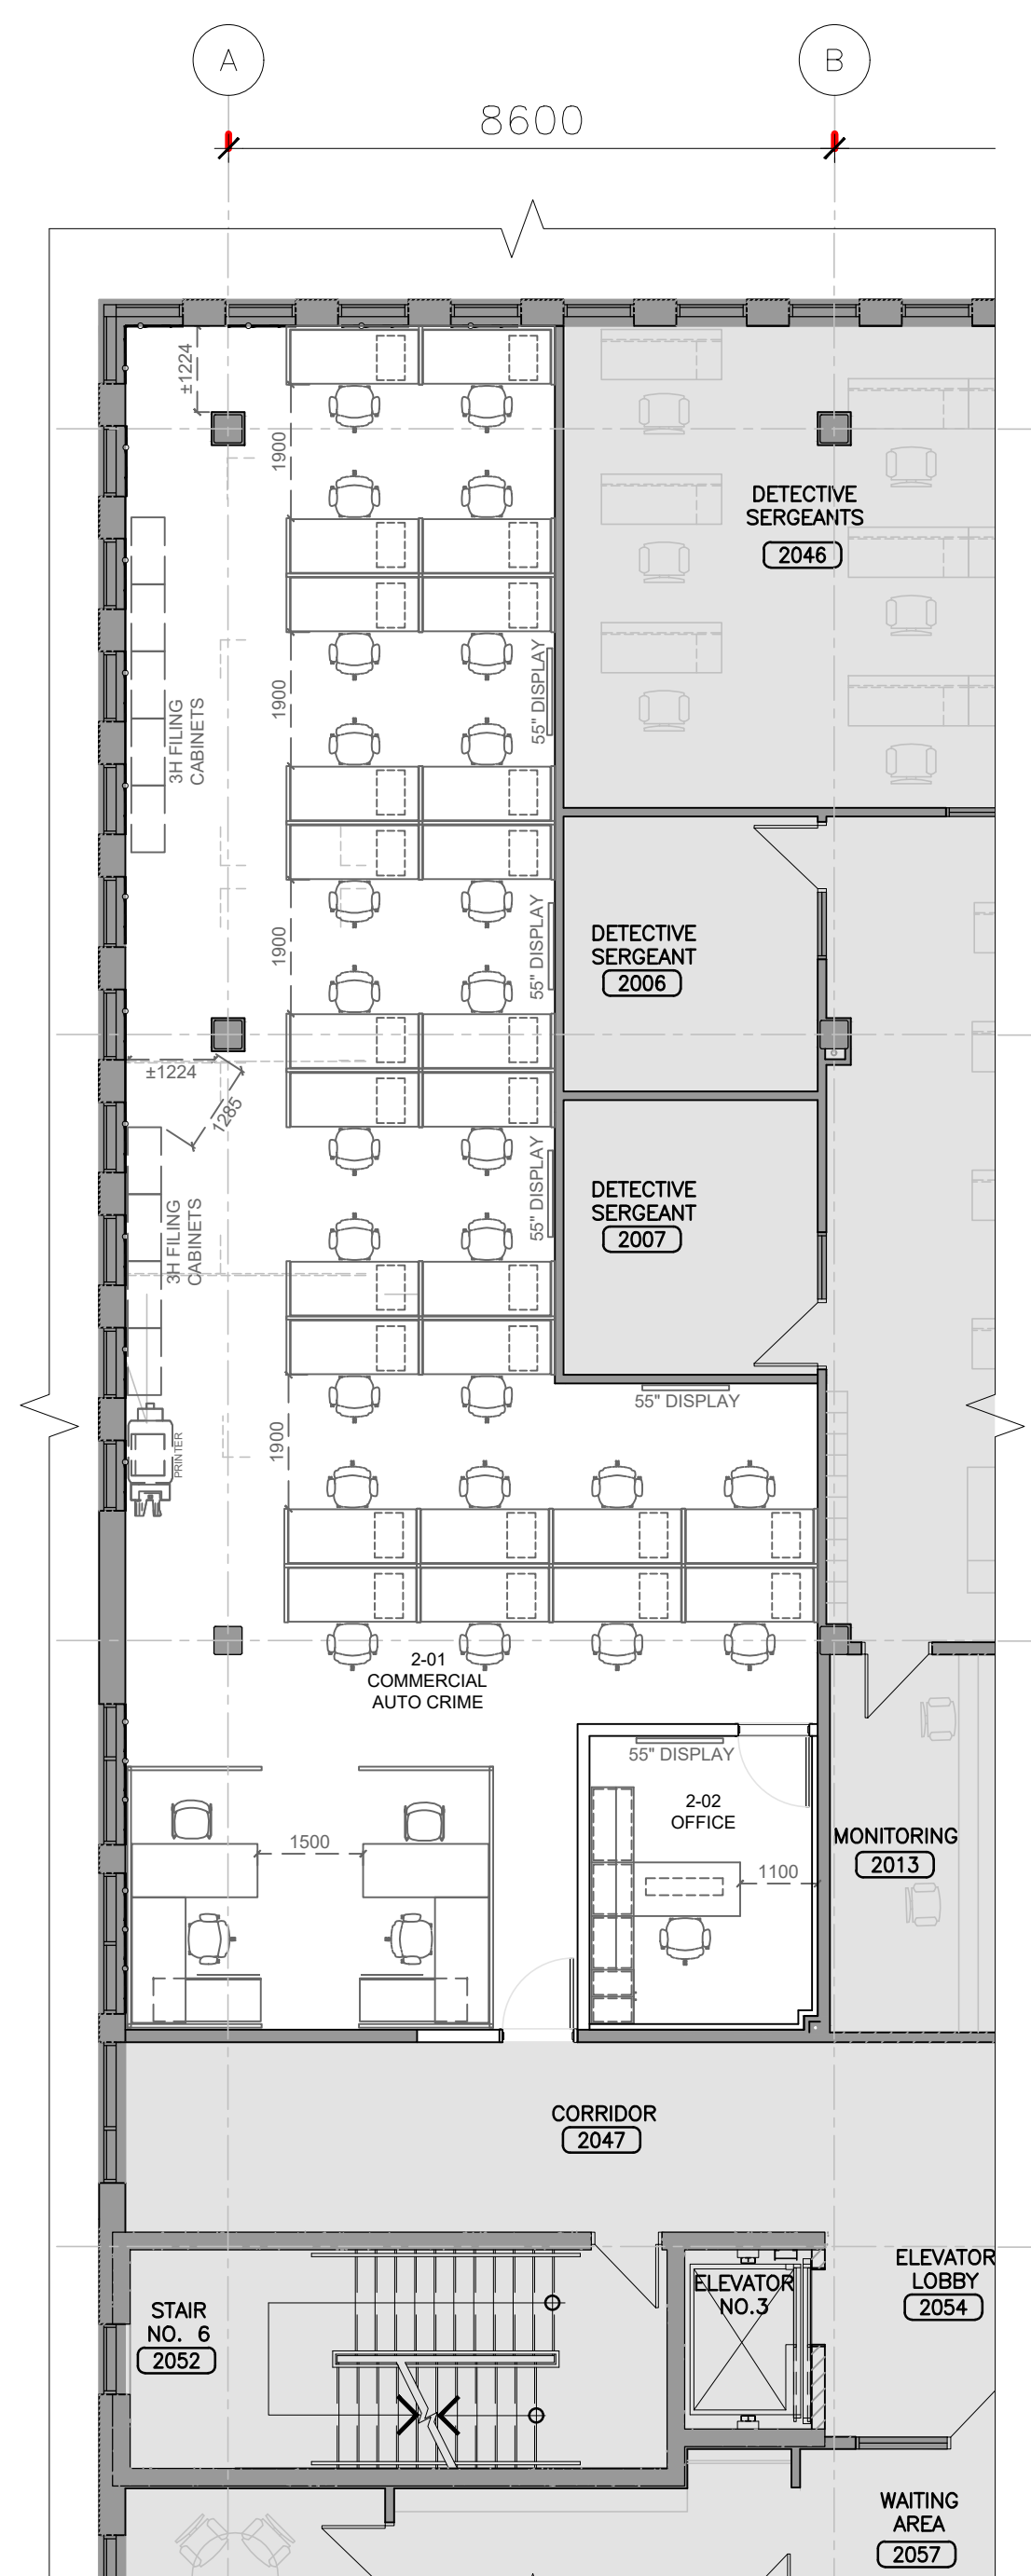

1 PARTIAL GROUND FLOOR PLAN-FURNITURE NEW
SCALE: 1/100





2 PARTIAL SECOND FLOOR PLAN-FURNITURE NEW
SCALE: 1/100



3 PARTIAL THIRD FLOOR PLAN-FURNITURE NEW
SCALE: 1/100

13. ISSUED FOR TENDER	2026.05.01
12. ISSUED FOR BUILDING POINT	2026.04.08
11. ISSUED FOR 100% CLIENT REVIEW	2026.03.31
10. ISSUED FOR 90% CLIENT REVIEW	2026.01.08
9. ISSUED FOR DESIGN DEVELOPMENT CLIENT REVIEW	2025.10.24
8. ISSUED FOR DESIGN DEVELOPMENT CLIENT REVIEW	2025.10.01
7. ISSUED FOR PRELIMINARY DESIGN CLIENT REVIEW	2025.09.03
6. ISSUED FOR PRELIMINARY DESIGN CLIENT REVIEW	2025.08.18
5. ISSUED FOR PRELIMINARY DESIGN CLIENT REVIEW	2025.08.12
4. ISSUED FOR PRELIMINARY DESIGN CLIENT REVIEW	2025.08.01
3. ISSUED FOR PRELIMINARY DESIGN CLIENT REVIEW	2025.07.30
2. ISSUED FOR PRELIMINARY DESIGN CLIENT REVIEW	2025.07.25
1. ISSUED FOR PRELIMINARY DESIGN CLIENT REVIEW	2025.07.14
NO. DESCRIPTION	DATE
REVISIONS	
PROJECT	
 REGION OF PEEL	
EMIL V. KOLB CENTRE PEEL REGIONAL POLICE FACILITY 180 DERRY ROAD EAST, MISSISSAUGA, ON L5T 2Y5	
 ARCHITECTS	
The copyright shall remain with the architect and shall not be transferred or assigned to the client without the written consent of the architect. No part of this drawing shall be reproduced or transmitted in any form or by any means electronic or mechanical, including photocopying, recording, or by any information storage and retrieval system, without the prior written permission of the architect.	
SHEET TITLE FURNITURE PLANS - NEW	
SHEET NO. A202	DRAWN BY SZ
PROJECT NO. SCALE	CHECKED RN AS NOTED

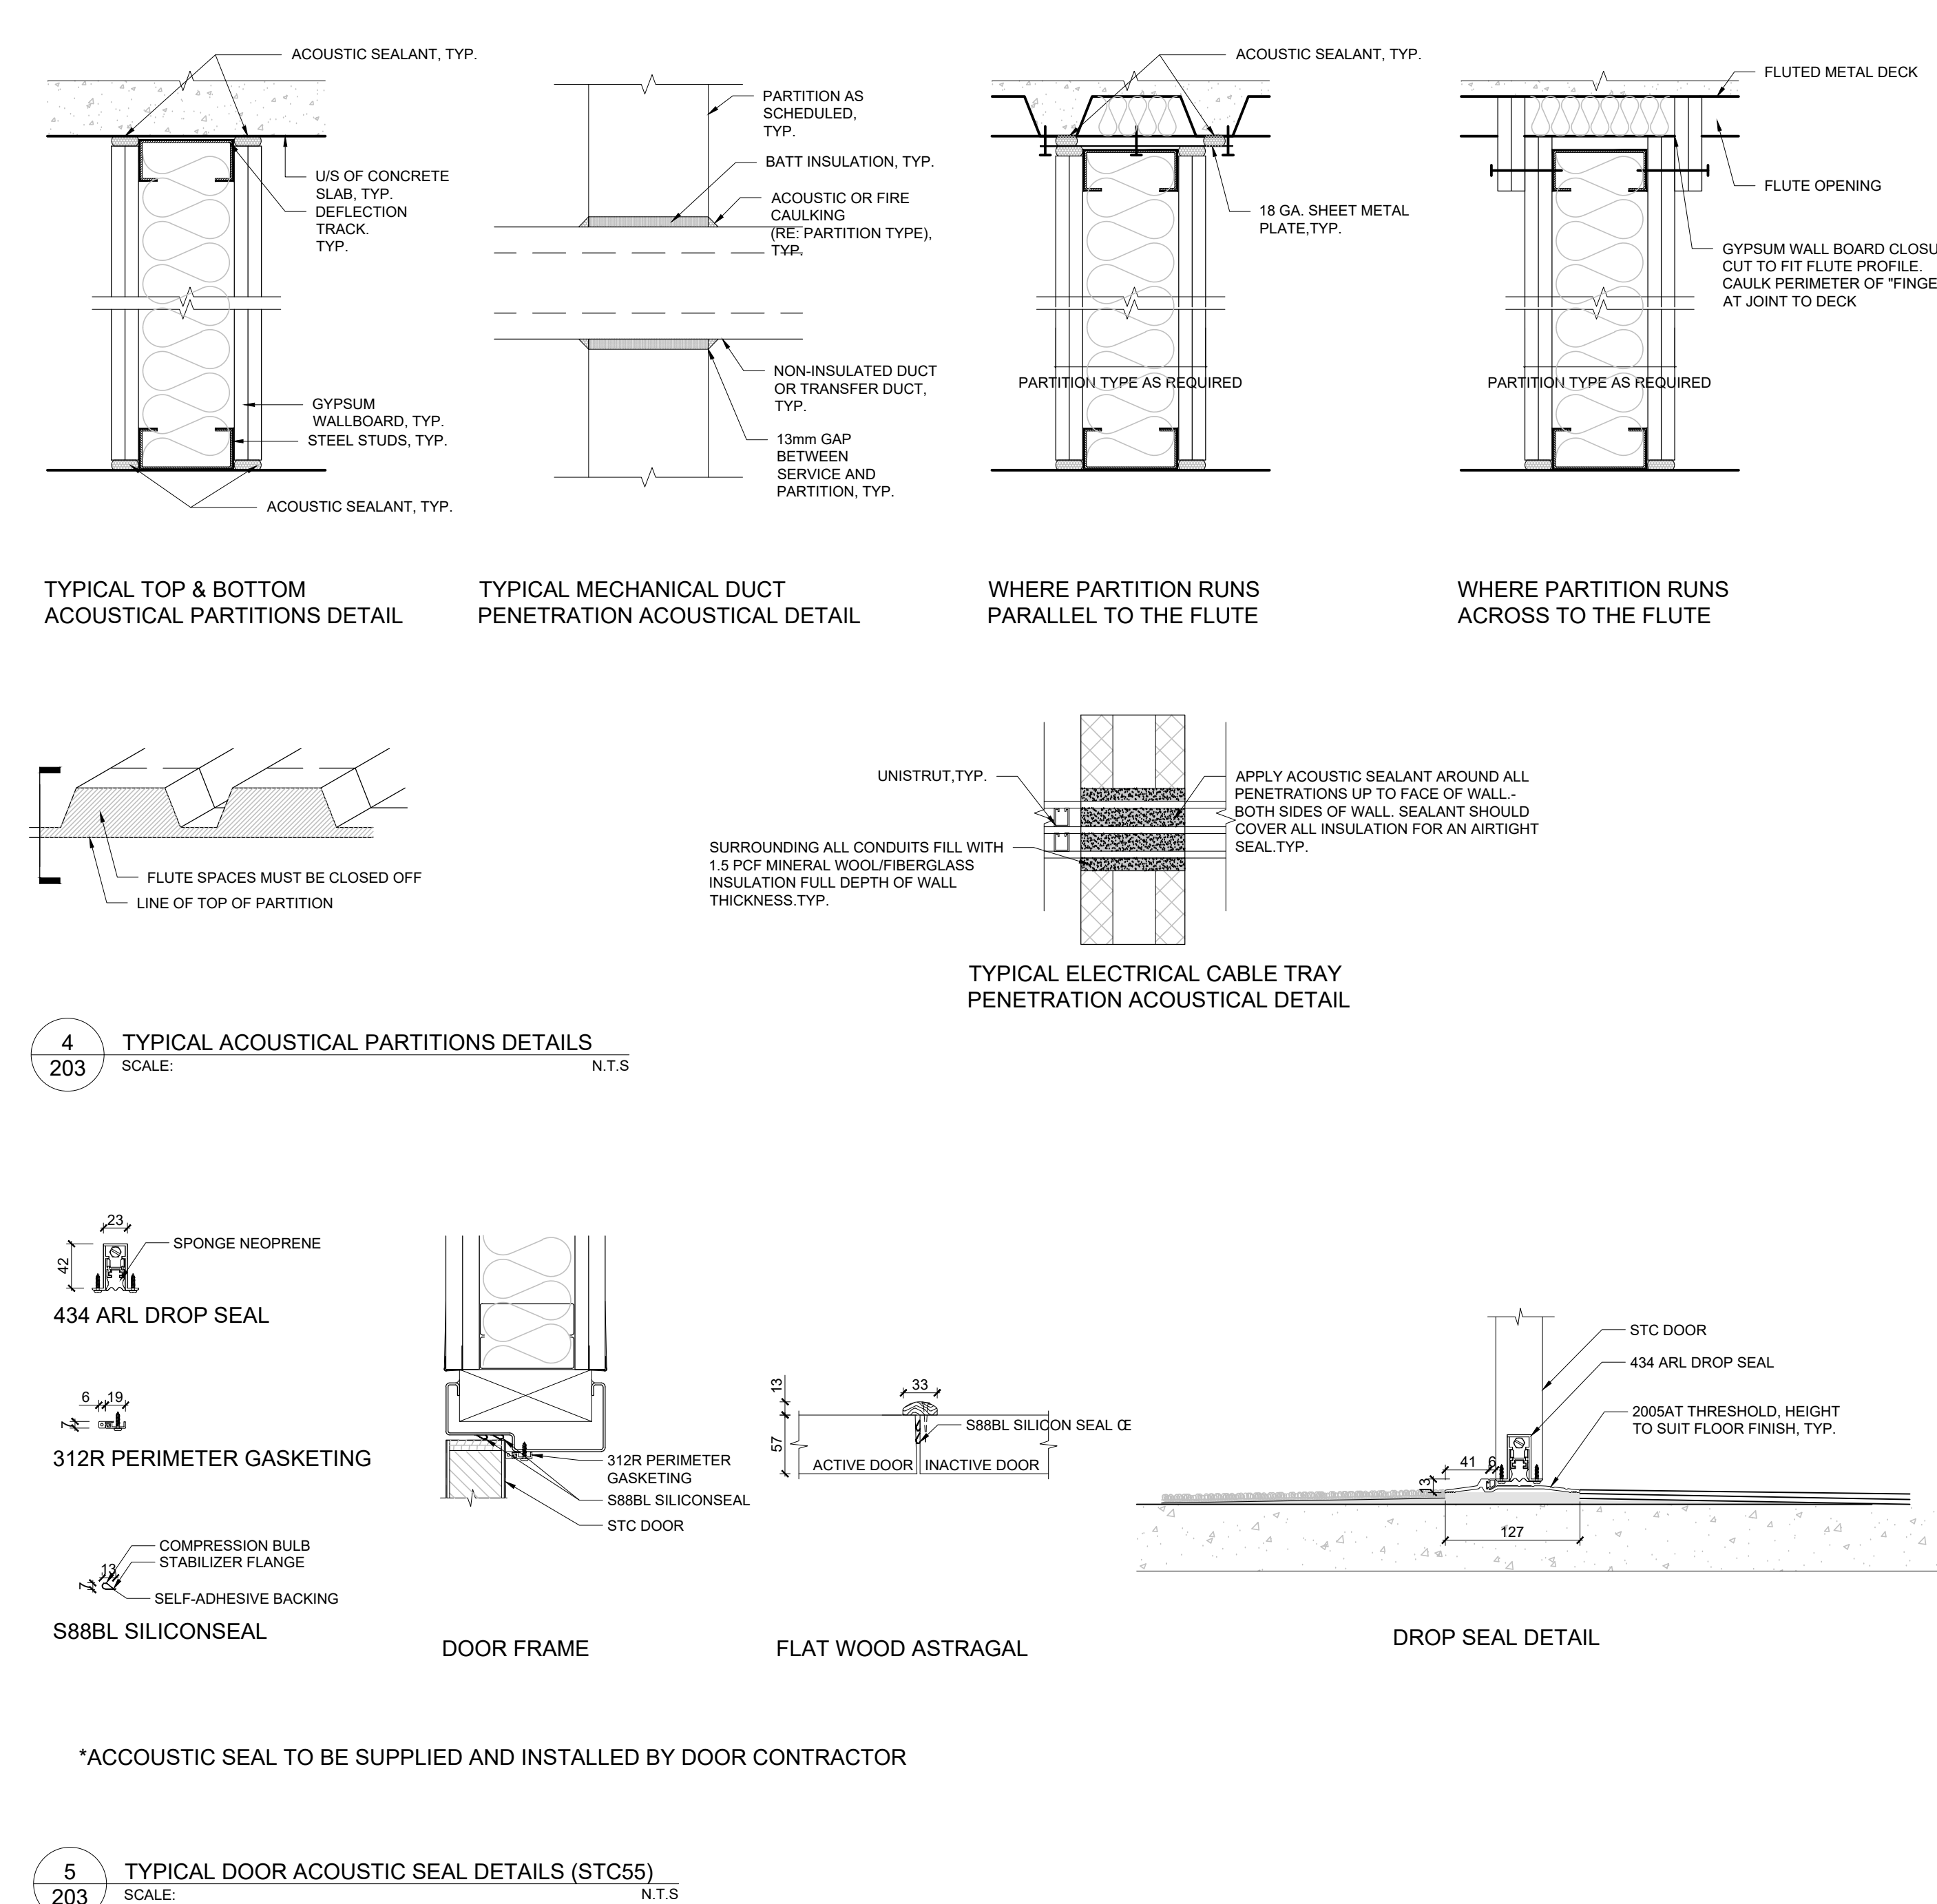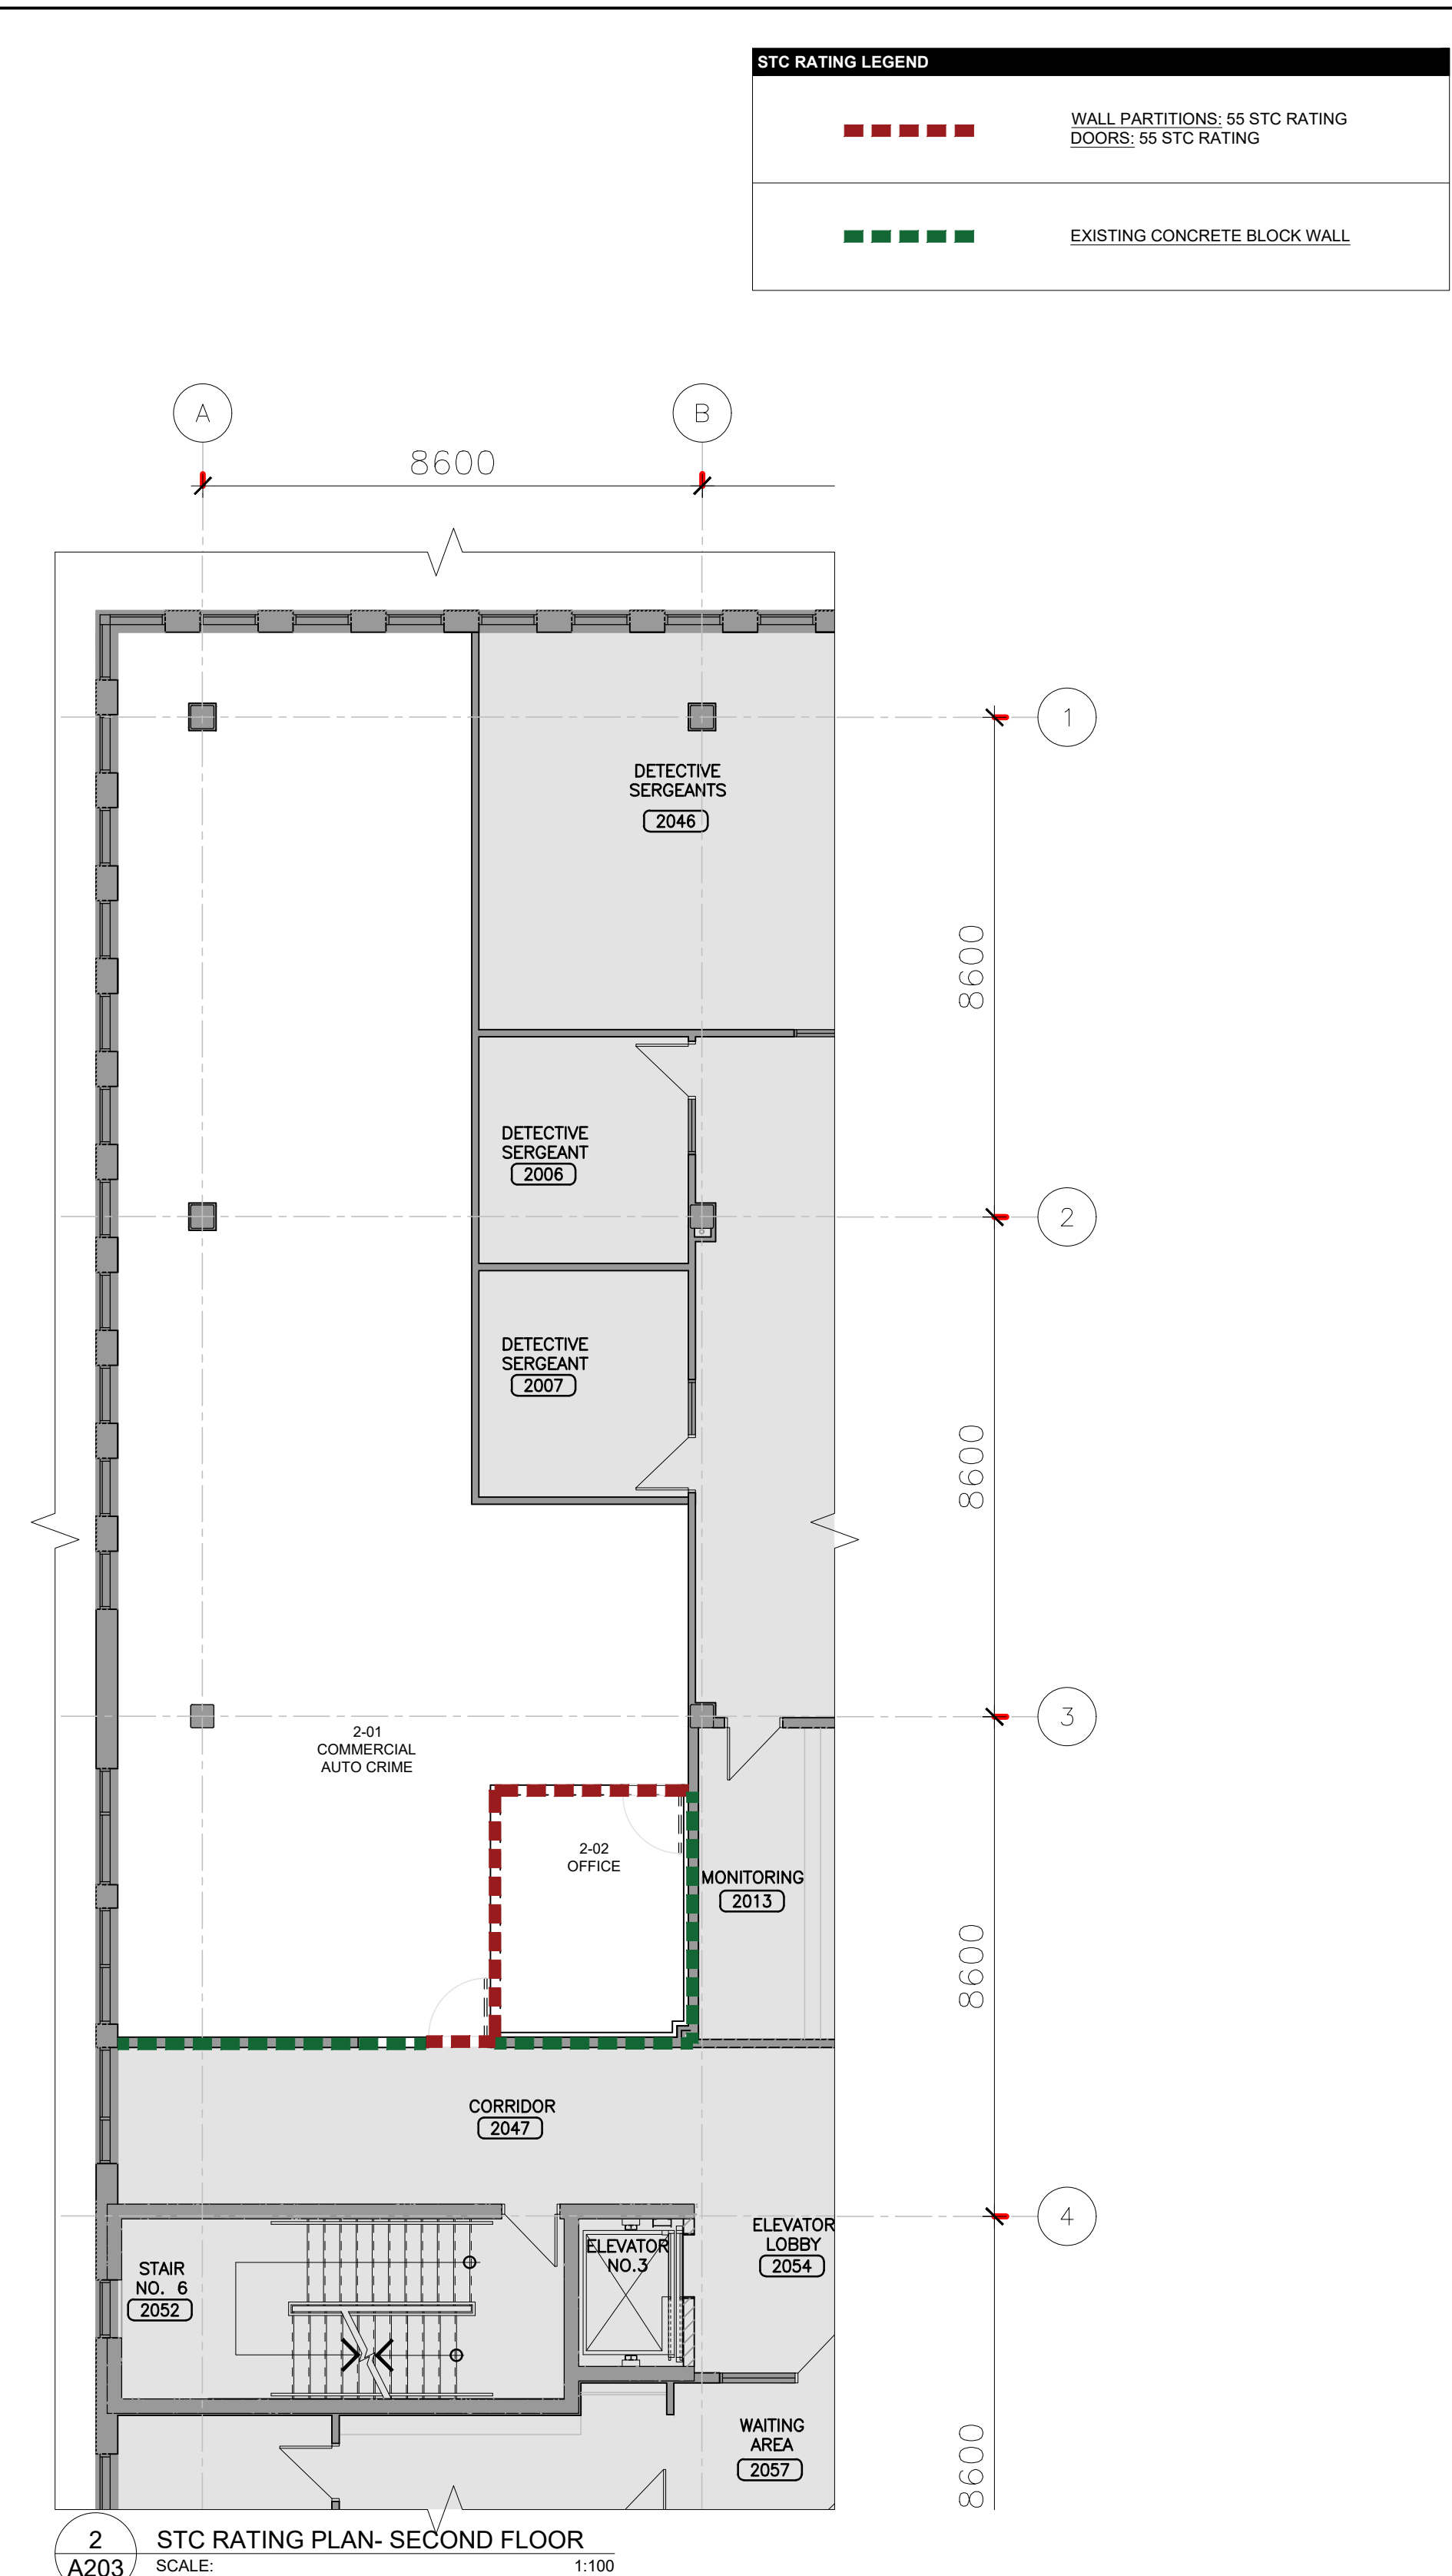

11	ISSUED FOR TENDER	2006.05.01
12	ISSUED FOR BUILDING PERMIT	2006.04.08
13	ISSUED FOR 10% CLIENT REVIEW	2006.03.31
14	ISSUED FOR 30% CLIENT REVIEW	2006.01.09
15	ISSUED FOR PRELIMINARY DESIGN CLIENT REVIEW	2005.10.01
17	ISSUED FOR PRELIMINARY DESIGN CLIENT REVIEW	2005.09.03
18	ISSUED FOR PRELIMINARY DESIGN CLIENT REVIEW	2005.08.18
19	ISSUED FOR PRELIMINARY DESIGN CLIENT REVIEW	2005.08.12
20	ISSUED FOR PRELIMINARY DESIGN CLIENT REVIEW	2005.08.07
21	ISSUED FOR PRELIMINARY DESIGN CLIENT REVIEW	2005.07.30
22	ISSUED FOR PRELIMINARY DESIGN CLIENT REVIEW	2005.07.07
23	ISSUED FOR PRELIMINARY DESIGN CLIENT REVIEW	2005.07.14
NO	DESCRIPTION	DATE
REVISIONS		
PROJECT		



REGION OF PEEL


**EMIL V. KOLB CENTRE
PEEL REGIONAL POLICE FACILITY
INTERIOR RENOVATION PROJECT**

180 DERRY ROAD EAST, MISSISSAUGA, ON L1T 2Y5



The undersigned shall assist and co-operate in obtaining and defend professional liability and errors and omissions insurance and shall not be responsible for any loss or damage to the project or the client's property.

The drawing shall be used for the construction of the project and shall not be used for any other purpose without the written consent of the undersigned.

OWNER'S REPRESENTATION		DATE
NORTH		
		
SHEET TITLE		
STC STAIRING PLAN-GROUND FLOOR- TYPICAL		
ACOUSTICAL DETAILS		
SHEET NO.	DRAWN BY	CHECKED
A203	MM	RN
PROJECT NO.		
SCALE		AS NOTED





1. ALL DIMENSIONS TO BE SITE MEASURED AND VERIFIED.
2. THIS DRAWING IS FOR THE LOCATION DMS OF A PORTION OF TOWERS, STAIRS, ETC. ONLY. DISCREPANCIES OR VARIATIONS IN THIS DRAWING ARE NOT INTENDED TO INDICATE THE COMPLETE SCOPE OF MECHANICAL AND ELECTRICAL WORK. THE CONTRACTOR SHALL CONSULT THE DRAWING AND THE ENGINEERS DRAWINGS TO THE DESIGNER IMMEDIATELY.
3. THIS DRAWING IS TO BE READ IN CONJUNCTION WITH MECHANICAL AND ELECTRICAL SPECIFICATIONS, GENERAL NOTES, AND SPECIAL FINISH SCHEDULE. DRAWINGS REPORT ANY DISCREPANCIES OR CONFLICTS BETWEEN CONTRACT DOCUMENTS TO THE ARCHITECT.
4. IN ALL AREAS OF WORK, SMOKE AND FIRE SEAL ALL CONNECTIONS AND WALL PENETRATIONS.
5. REPAIR, PATCH, PAINT AND MAKE GOOD AT JUNCTIONS ALL RELATED EXISTING DAMAGE TO ACCURATELY MATCH ADJACENT WALLS, CEILING, AND ELECTRONIC, AND ELECTRICAL MODIFICATIONS AND NEW CONNECTIONS.
6. RECESSED LIGHT FIXTURES TO BE INSTALLED SO THAT NO LIGHT LEAKS ARE VISIBLE.
7. ALL HVAC DUCTS, T-BAR & GYPSUM BOARD CEILING TO BE SUSPENDED FROM BUILDING STRUCTURE. SUSPENSION FROM METAL DECK WILL NOT BE ALLOWED.
8. RESEAL ALL PENETRATIONS TO LANDLORD BASE BUILDING CAUSING BY HANDLING OF EQUIPMENT, CEILING, LIGHT, ETC.
9. RECESS IN TO APPROVE LOCATIONS OF ALL SPECIAL LIGHTING. CONSULT IN CASE INQUIRY PRIOR TO INSTALLATION.
10. ALL MECHANICAL AND ELECTRICAL DEVICES ON ACOUSTIC CEILING SHALL BE CENTERED ON EACH TILE, TYP.
11. ENSURE FIRE ALARM AND SMOKE DETECTORS TO BE BYPASSED, COVERED AND PROTECTED PRIOR TO SANDING GYM CEILINGS.
12. PROVIDE NECESSARY BLOCKING AND REINFORCING WITHIN CEILING STRUCTURE AND INTERIOR.
13. CONFIRM LOCATION OF ACCESS PANELS WITH THE CONSULTANT BEFORE ANY WORK. ANY REQUIREMENTS TO LOCATION WITHIN SYSTEM MAY BE REQUIRED. PLEASE PANEL INTERFERES WITH ARCHITECTURAL APPEARANCE.
14. COORDINATE WITH MECHANICAL & ELECTRICAL CONTRACTORS FOR ALL CUTTING & PATCHING.
15. EXPOSED SURFACES OF PAINTABLE CEILING FIXTURES, INCLUDING ACCESS PANELS AND MECHANICAL ELECTRICAL, SHALL BE PAINTED TO MATCH EXISTING CEILING. DO NOT PAINT EXPOSED DATA OR VOICE CABLES, OR HVAC CONDUITS.
16. LOCATE AIR DIFFUSERS AND RETURN AIR GRILLS TO SUIT NEW LAYOUT. MECHANICAL HEADS LOCATED AS INDICATED ON ARCHITECTURAL DRAWINGS AND COORDINATED WITH MECHANICAL ENGINEERING DRAWINGS.
17. SPRINKLER HEADS IN GYM TO BE CONCEALED WITH FLUSH MOUNTED GYM, COLOUR WHITE.
18. LOCATE LIGHT FIXTURES IN ACCORDANCE WITH ARCHITECTURAL DRAWINGS. OTHER ELECTRICAL ITEMS ARE SHOWN FOR COORDINATION.
19. GENERAL CONTRACTOR TO CONFIRM WITH ARCHITECT THE NUMBER AND LOCATION OF MECHANICAL ELECTRICAL, AND SPECIAL LIGHTING.

13	ISSUED FOR TENDER	2008.05.01
12	ISSUED FOR BUILDING PERMIT	2008.04.08
11	ISSUED FOR 100% CLIENT REVIEW	2008.03.31
10	ISSUED FOR 60% CLIENT REVIEW	2008.01.09
9	ISSUED FOR DESIGN DEVELOPMENT CLIENT REVIEW	2008.10.24
8	ISSUED FOR DESIGN DEVELOPMENT CLIENT REVIEW	2008.10.01
7	ISSUED FOR PRELIMINARY DESIGN CLIENT REVIEW	2008.09.03
6	ISSUED FOR PRELIMINARY DESIGN CLIENT REVIEW	2008.08.18
5	ISSUED FOR PRELIMINARY DESIGN CLIENT REVIEW	2008.08.12
4	ISSUED FOR PRELIMINARY DESIGN CLIENT REVIEW	2008.08.01
3	ISSUED FOR PRELIMINARY DESIGN CLIENT REVIEW	2008.07.30
2	ISSUED FOR PRELIMINARY DESIGN CLIENT REVIEW	2008.07.25
1	ISSUED FOR PRELIMINARY DESIGN CLIENT REVIEW	2005.07.14
NO. DESCRIPTION		DATE
NOTES:		




**EMIL V. KOLB CENTRE
PEEL REGIONAL POLICE FACILITY
INTERIOR RENOVATION PROJECT**
180 DERRY ROAD EAST, MISSISSAUGA, ON L5T 2Y5

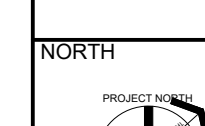

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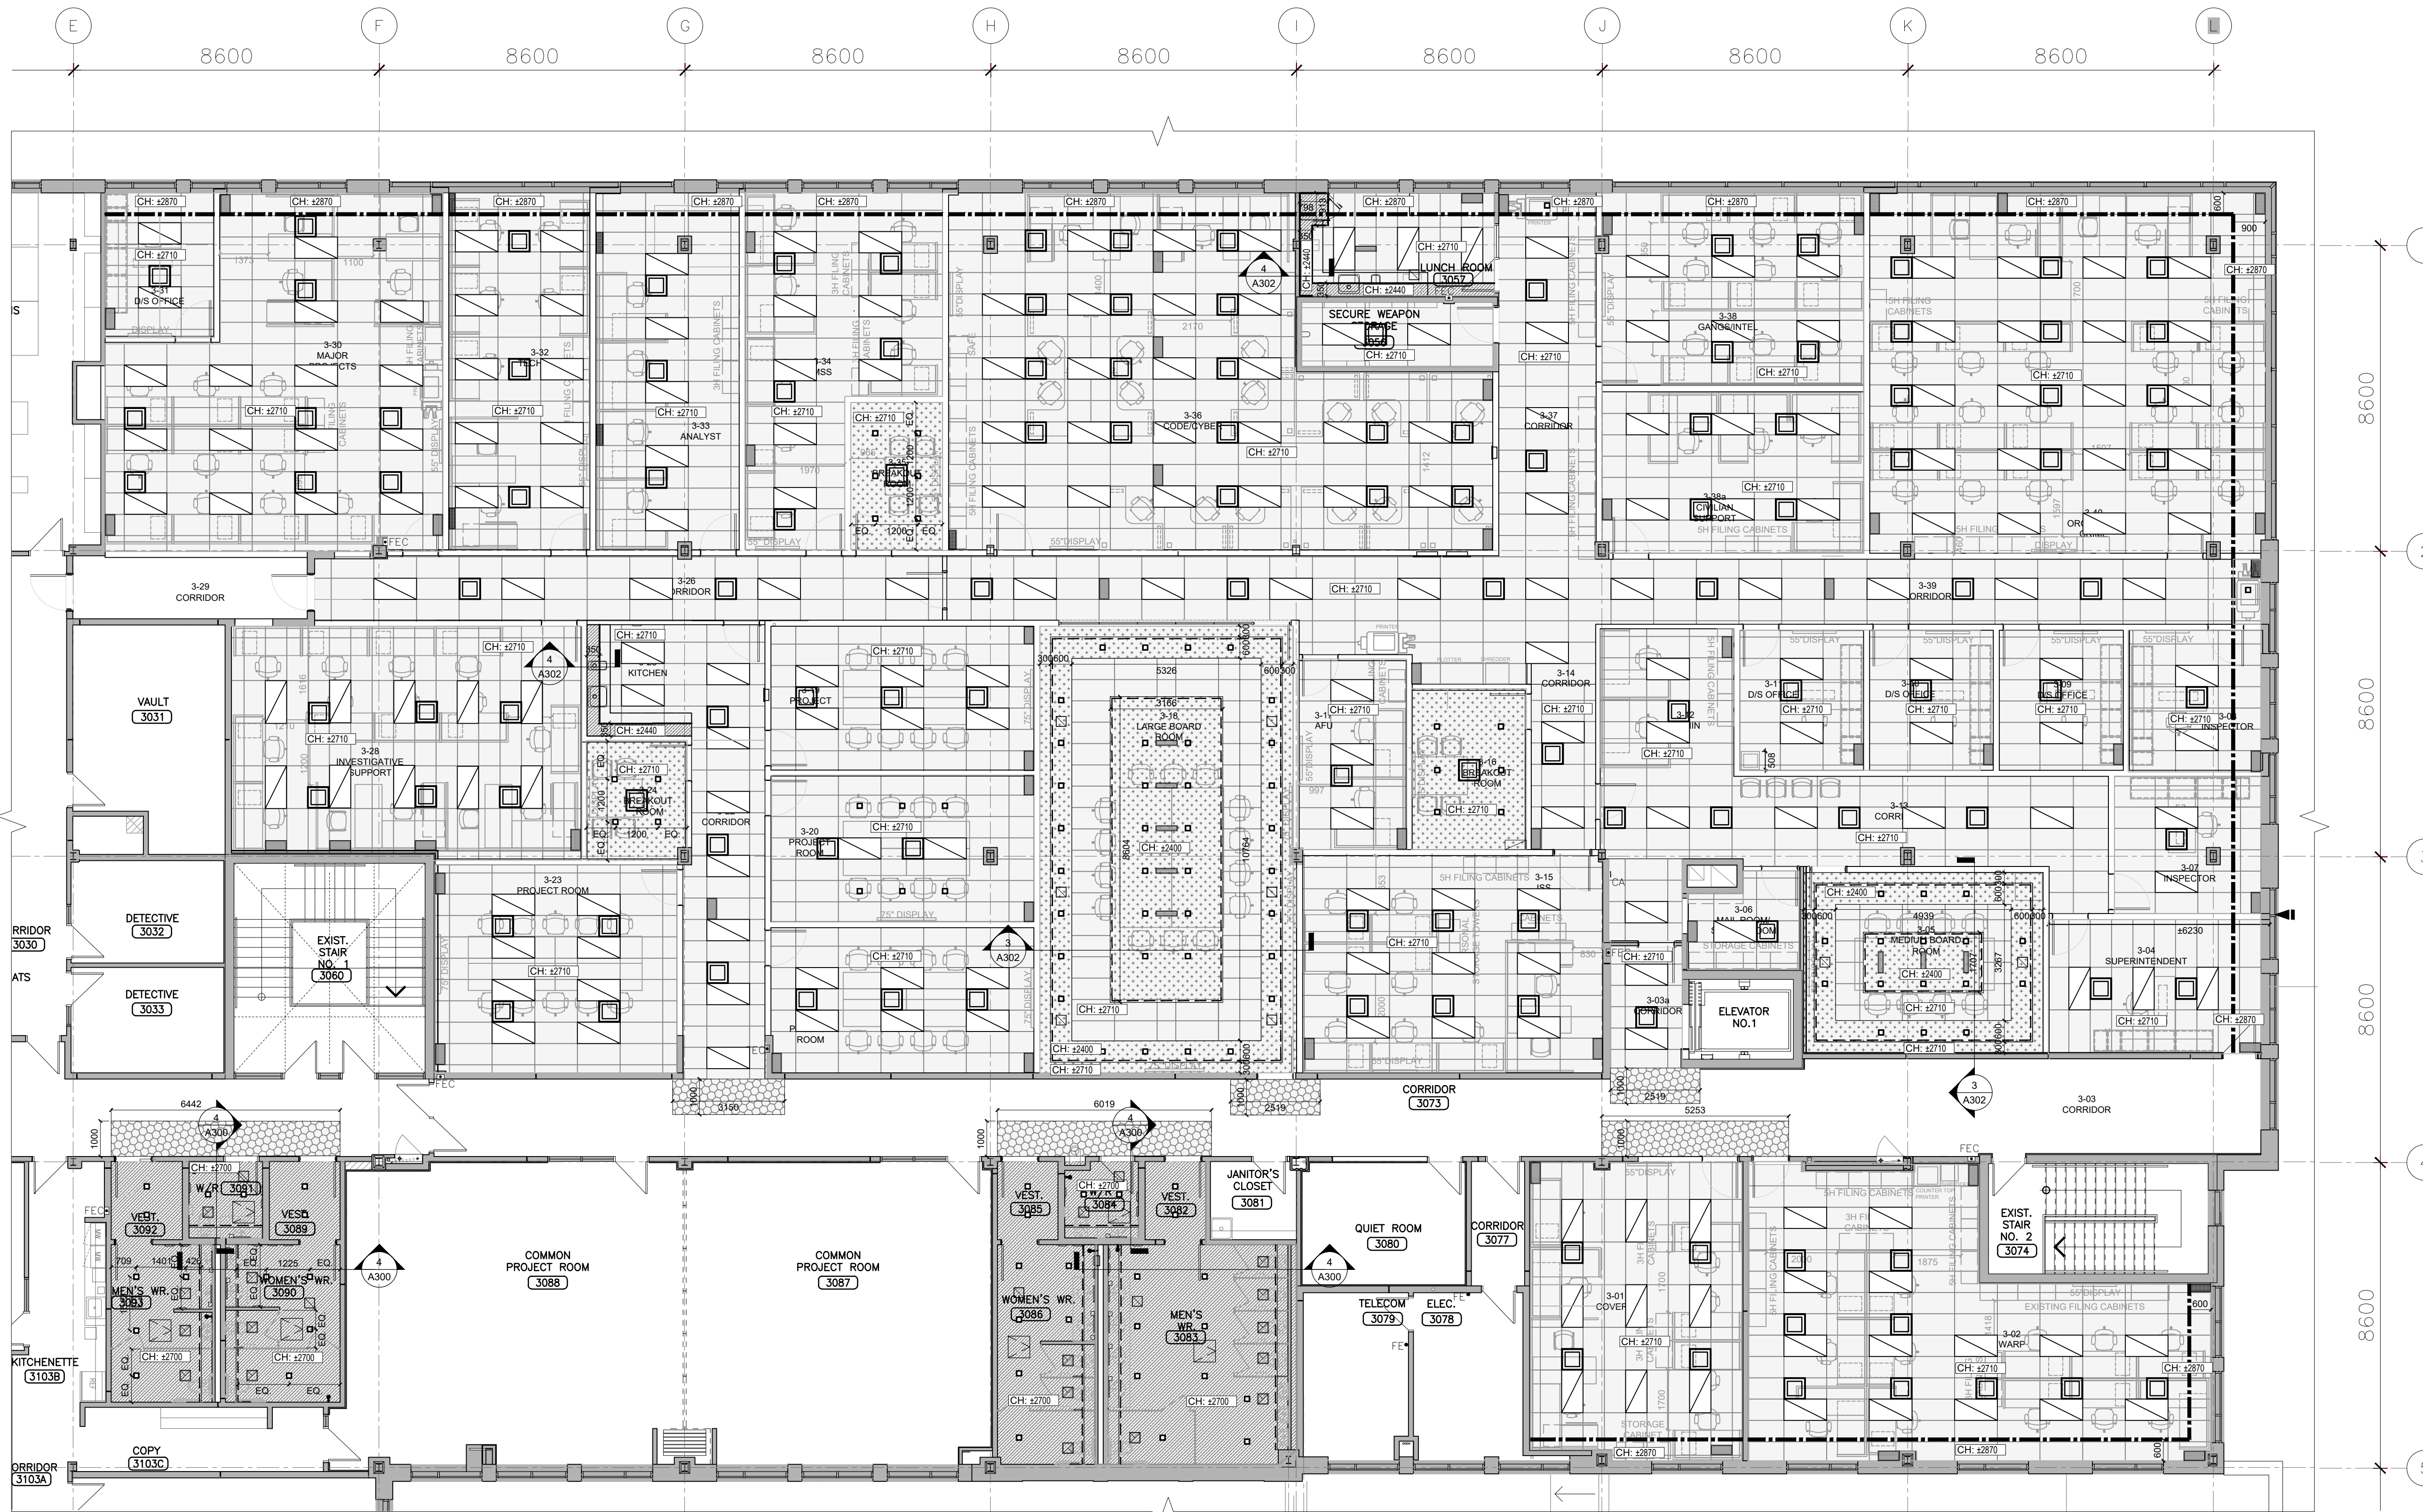
REFLECTED CEILING PLAN
NEW- BASEMENT &
GROUND FLOOR

SHEET NO. A300	DRAWN BY MM	CHECKED RN
	PROJECT NO.	
	SCALE AS NOTED	

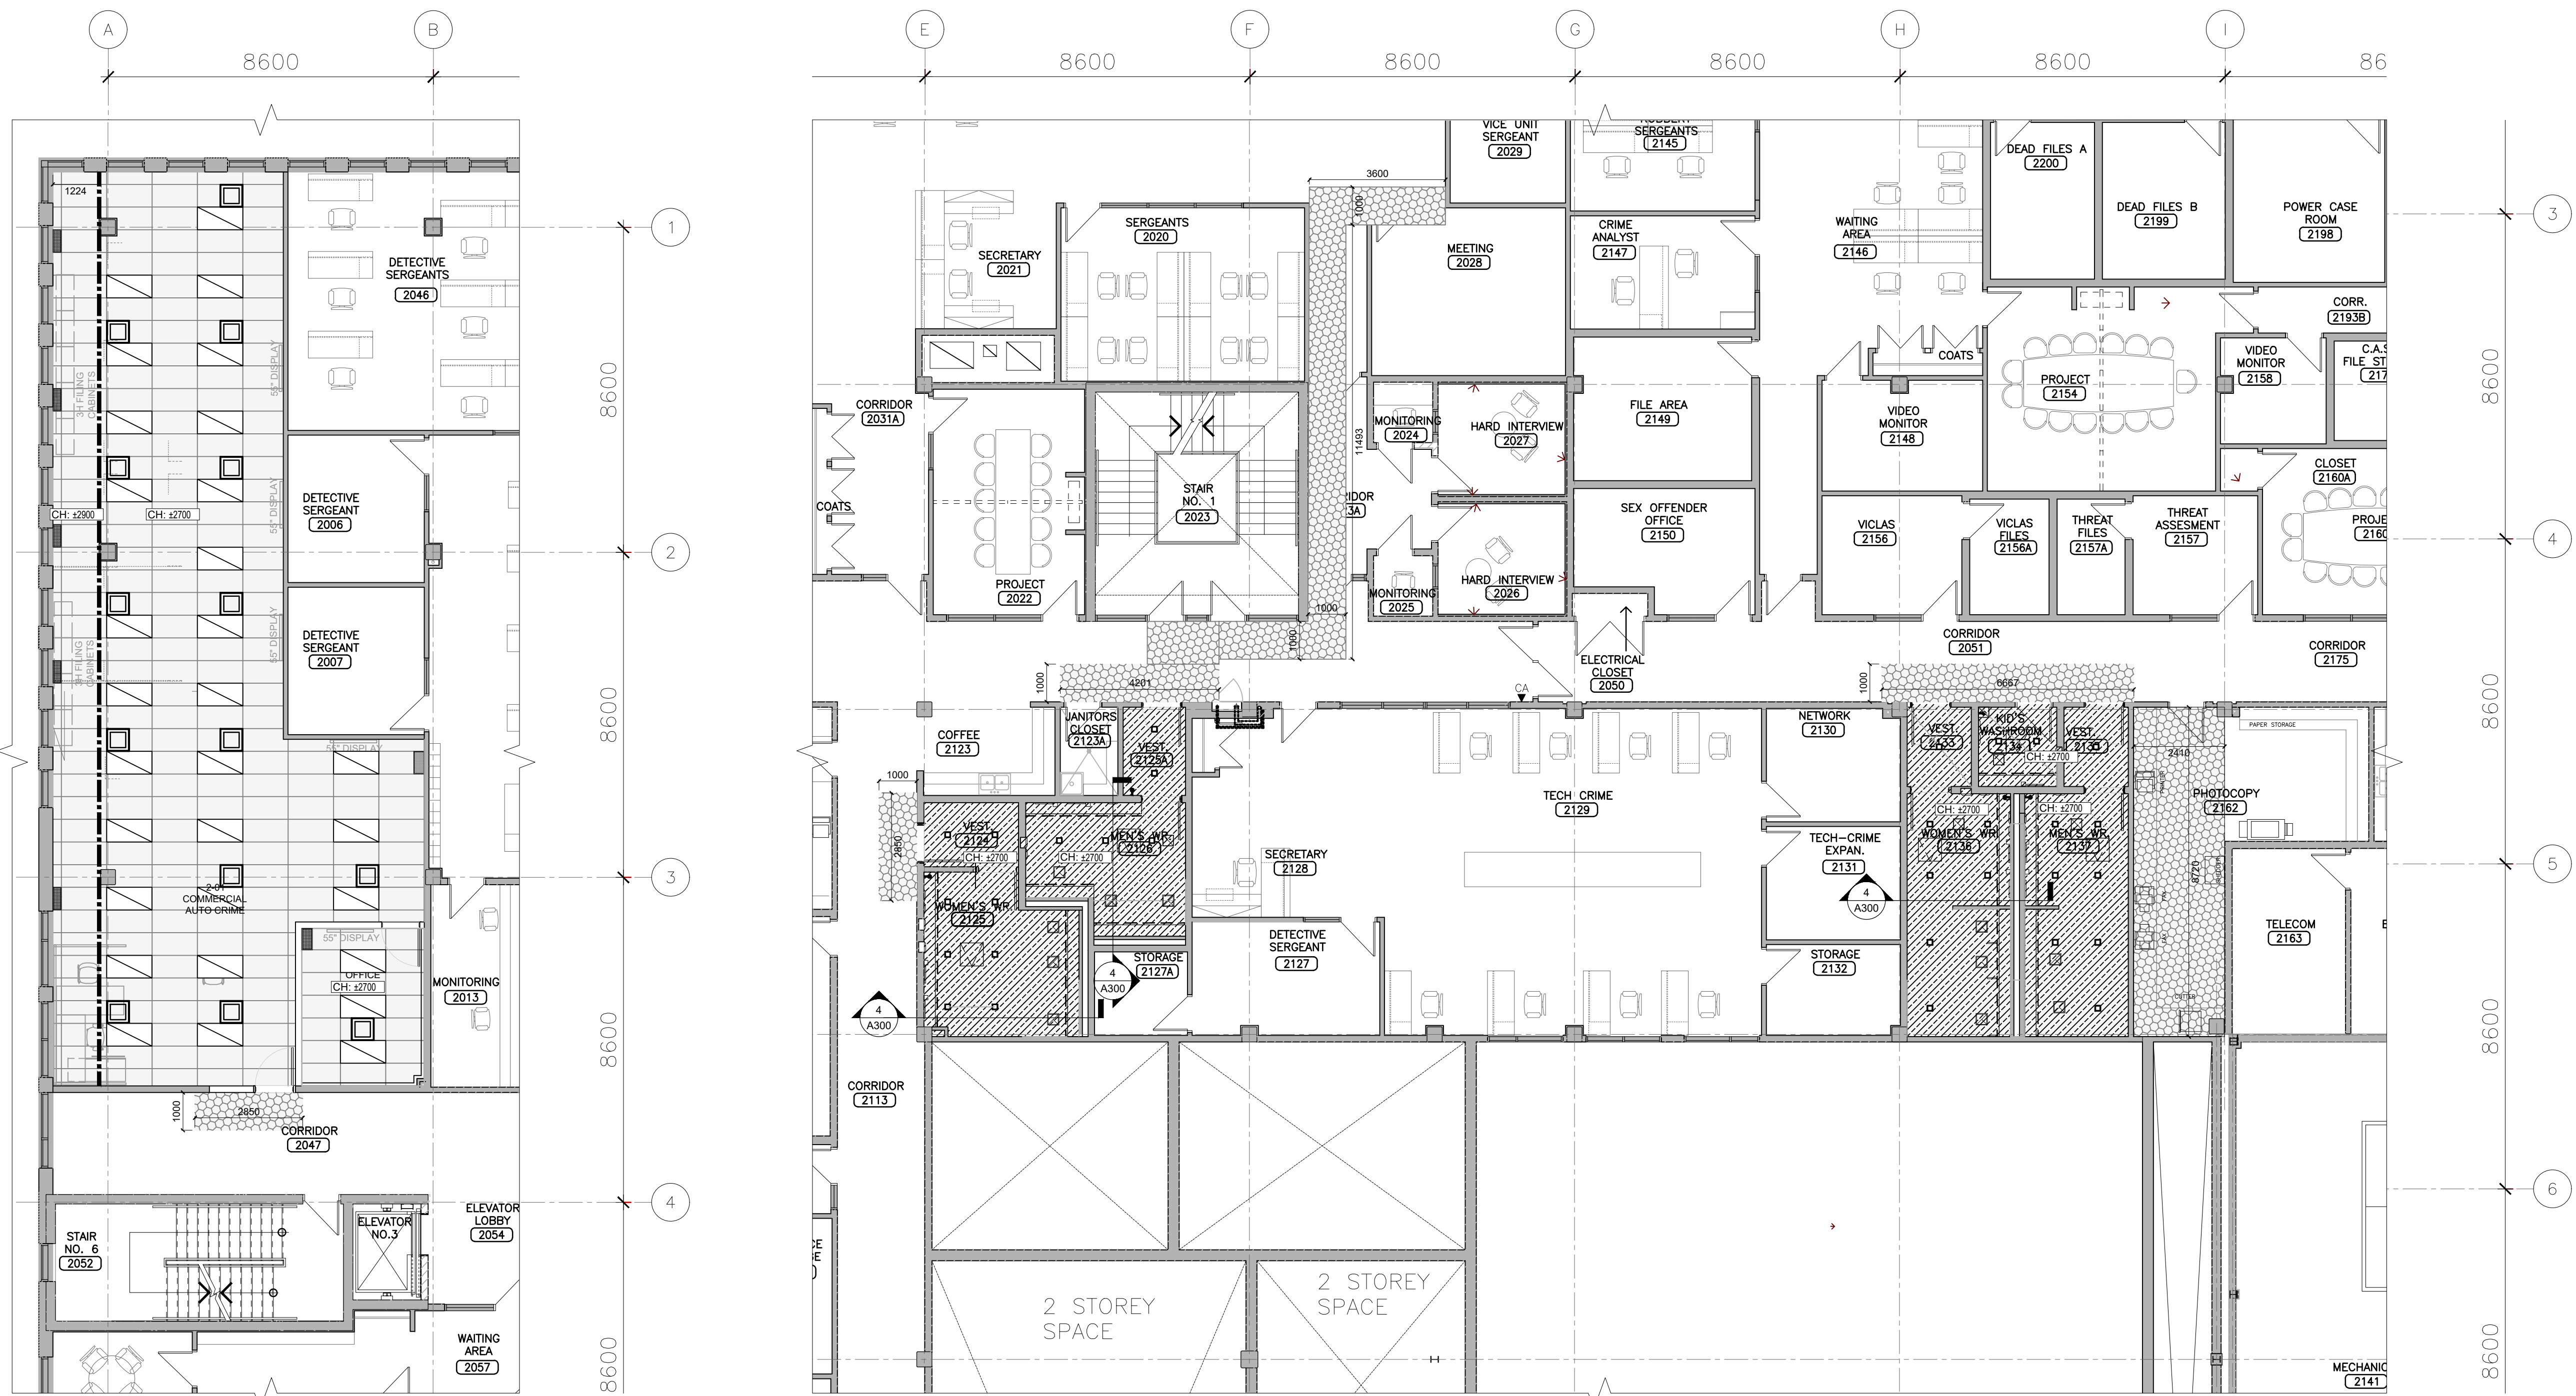

1 REFLECTED CEILING PLAN- NEW- SECOND FLOOR
SCALE: 1:100

2 REFLECTED CEILING PLAN- NEW- SECOND FLOOR (WASHROOMS)
SCALE: 1:100



3 REFLECTED CEILING PLAN- NEW- THIRD FLOOR
SCALE: 1:100

REFLECTED CEILING PLAN NEW LEGEND	
	NEW SUSPENDED ACOUSTIC TILE CEILING, 600mm x 1200mm TYPICAL PANELS
	NEW GYPSUM BOARD CEILING, TYP. HANGER SPACING 1200mm O.C. MAX. WIRE TIED OR CLIPPED TO 38mm METAL CARRYING CHANNELS @ 1200mm O.C. MAX. USING METAL FURRING CHANNEL CLIPS TO ATTACH TO METAL FURRING CHANNELS SPACED AT 600mm O.C. MAX.
	NEW WATER-RESISTANT GYPSUM BOARD CEILING, TYP. HANGER SPACING 1200mm O.C. MAX. WIRE TIED OR CLIPPED TO 38mm METAL CARRYING CHANNELS @ 1200mm O.C. MAX. USING METAL FURRING CHANNEL CLIPS TO ATTACH TO METAL FURRING CHANNELS SPACED AT 600mm O.C. MAX.
	REMOVE, REPLACE, CUT AND PATCH EX. DRYWALL CEILING & CEILING TILE TO ACCOMMODATE THE NEW MECHANICAL WORK IN THE CEILING SPACE. SEE MECHANICAL, TYP.
	ANY DAMAGED TILES DURING THE PROCESS ARE TO BE REPLACED WITH NEW TILES. CEILING GRID IS TO REMAIN.
	REPLACE ANY DAMAGED CEILING SYSTEM COMPONENTS INCLUDE BUT NOT LIMITED TO HANGING, EXPOSED MAIN TIE, EXPOSED CHONG TEE, WALL MOLDING LAY IN PANELS AND HOLD DOWN CLIPS WHERE REQUIRED. M.G.A.T., TYP.
	PATCH, REPAIR AND PAINT FINISH ALL AFFECTED GYPSUMBOARD CEILING TO MATCH EXISTING. M.G.A.T., TYP.
	REMOVE AND REINSTALL ALL EXISTING MECHANICAL AND ELECTRICAL FIXTURES. DEVICES, COMPONENTS INCLUDE BUT NOT LIMITED TO LIGHTING FIXTURES, EXHAUSTS/SUPPLY GRILLE, OCCUPANCY SENSORS, ETC. IF REQUIRED, ALL DAMAGED EXISTING ELECTRICAL AND MECHANICAL COMPONENTS TO BE REPLACED WITH NEW TO MATCH EXISTING. M.G.A.T., TYP. GENERAL CONTRACTOR TO VERIFY QUANTITIES, TYPE AND EXACT LOCATION OF ALL ELECTRICAL & MECHANICAL COMPONENTS ON SITE.
	NEW DRYWALL BULKHEAD, REFER TO MECHANICAL DRAWING FOR DIFFUSER. SEE MECH. TYP.
	HEIGHT TO UNDERSIDE OF CEILING FROM FINISH FLOOR
	EX. WALL OR PARTITION TO REMAIN, TYP.
	NEW WALL OR PARTITION, TYP.
LIGHTING	
	NEW ARCHITECTURAL RECESSED 600mm x 1200mm LED LUMINAIRE, SEE ELECTRICAL, TYP.
	NEW ARCHITECTURAL RECESSED 600mm x 600mm LED LUMINAIRE, SEE ELECTRICAL, TYP.
	NEW LINEAR RECESSED LED LUMINAIRE, SEE ELEC., TYP.
	NEW RECESSED SQUARE LED DOWNLIGHT SEE ELECTRICAL, TYP.
	NEW LINEAR COVE LED LUMINAIRE, SEE ELECTRICAL, TYP.
HVAC	
	NEW LINEAR SUPPLY AIR DIFFUSER, SEE MECHANICAL, TYP.
	NEW RECTANGULAR SUPPLY AIR DIFFUSER, SEE MECHANICAL, TYP.
	NEW RETURN/ EXHAUST INTAKE AIR GRILLE, SEE MECHANICAL, TYP.
	NEW RADIANT PANEL, SEE MECHANICAL, TYP.
	NEW DRYWALL CONCEALED TYPE ACCESS PANEL, TYP.
TYPICAL	
EX	EXISTING
M.G.A.T.	MAKE GOOD ON ALL TRADES AT JUNCTION
TYP.	TYPICAL

- REFLECTED CEILING PLAN NEW NOTES
1. ALL DIMENSIONS TO BE SITE MEASURED AND VERIFIED.
 2. THIS DRAWING IS FOR THE LOCATION OF THE CEILING OF A PORTION OF THE BUILDING. IT IS NOT INTENDED TO INDICATE THE COMPLETE SCOPE OF MECHANICAL AND ELECTRICAL WORK. REPORT ANY DISCREPANCIES BETWEEN THIS DRAWING AND THE ENGINEER'S DRAWINGS TO THE DESIGNER IMMEDIATELY.
 3. THIS DRAWING TO BE READ IN CONJUNCTION WITH MECHANICAL AND ELECTRICAL REFLECTED CEILING PLAN AND DEMOLITION & ROOM FINISH SCHEDULE DRAWINGS. REPORT ANY DISCREPANCIES OR CONFLICTS BETWEEN CONSULTANT DRAWINGS TO THE ARCHITECT.
 4. IN ALL AREAS OF WORK, SMOKE AND FIRE SEAL ALL CONNECTIONS AND WALL PENETRATIONS.
 5. REPAIR, PATCH, AND MAKE GOOD AT JUNCTIONS ALL RELATED EXISTING AREAS TO ACCOMMODATE NEW MECHANICAL AND ELECTRICAL MODIFICATIONS AND NEW CONNECTIONS.
 6. RECESSED LIGHT FIXTURES TO BE INSTALLED SO THAT NO LIGHT LEAKS ARE VISIBLE.
 7. ALL HVAC DUCTS, T-BAR & GYPSUM BOARD CEILINGS TO BE SUSPENDED FROM BASE BUILDING STRUCTURE. SUSPENSION FROM METAL DECK WILL NOT BE ACCEPTED.
 8. RESEAL ALL PENETRATIONS TO LANDFORD BASE BUILDING CAUSED BY HANDLING OF EQUIPMENT, CEILING, LIGHT, ETC.
 9. CONSULTANT TO APPROVE LOCATIONS OF ALL SPECIALTY LIGHTING RECESSED IN CEILINGS PRIOR TO INSTALLATION.
 10. ALL MECHANICAL AND ELECTRICAL DEVICES ON ACOUSTIC CEILING TILES TO BE CENTERED ON EACH TILE, TYP.
 11. ENSURE FIRE ALARM AND SMOKE DETECTORS TO BE BYPASSED, COVERED AND PROTECTED PRIOR TO SANDING GIBS CEILINGS.
 12. PROVIDE NECESSARY BLOCKING AND REINFORCING WITHIN CEILING WHERE LOADING IS ANTICIPATED.
 13. CONFIRM LOCATION OF ACCESS PANELS WITH THE CONSULTANT BEFORE INSTALLATION. MINOR ADJUSTMENTS TO LOCATION WITHIN WALL SYSTEM MAY BE REQUIRED WHERE PANEL INTERFERES WITH ARCHITECTURAL APPEARANCE.
 14. COORDINATE WITH MECHANICAL AND ELECTRICAL CONTRACTOR FOR ALL CUTTING & PATCHING.
 15. EXPOSED SURFACES OF PAINTABLE CEILING FIXTURES, INCLUDING ACCESS PANELS, GRILLES, AND DIFFUSERS ARE TO BE PAINTED TO MATCH ADJACENT CEILING. DO NOT PAINT EXPOSED DATA OR VOICE CABLEING, OR HVAC CONTROLS.
 16. LOCATE AIR DIFFUSERS AND RETURN AIR GRILLES TO SUIT NEW LAYOUT. MECHANICAL FIXTURES LOCATED AS INDICATED ON ARCHITECTURAL DRAWINGS AND COORDINATED WITH MECHANICAL ENGINEERING DRAWINGS.
 17. SPRINKLER HEADS IN GIBS TO BE CONCEALED WITH FLUSH MOUNTED CAP, COLOUR WHITE.
 18. LOCATE LIGHT FIXTURES IN ACCORDANCE WITH ARCHITECTURAL DRAWINGS. OTHER ELECTRICAL ITEMS ARE SHOWN FOR COORDINATION.
 19. GENERAL CONTRACTOR TO CONFIRM WITH ARCHITECT THE NUMBER AND LOCATION OF ALL MECHANICAL, ELECTRICAL, AND AV DEVICES.

13. ISSUED FOR TENDER	2026.05.01
12. ISSUED FOR BUILDING PERMIT	2026.04.08
11. ISSUED FOR 10% CLIENT REVIEW	2026.03.31
10. ISSUED FOR 30% CLIENT REVIEW	2026.01.09
9. ISSUED FOR DESIGN DEVELOPMENT CLIENT REVIEW	2025.10.24
8. ISSUED FOR PRELIMINARY DESIGN CLIENT REVIEW	2025.10.01
7. ISSUED FOR PRELIMINARY DESIGN CLIENT REVIEW	2025.09.03
6. ISSUED FOR PRELIMINARY DESIGN CLIENT REVIEW	2025.08.18
5. ISSUED FOR PRELIMINARY DESIGN CLIENT REVIEW	2025.08.12
4. ISSUED FOR PRELIMINARY DESIGN CLIENT REVIEW	2025.08.01
3. ISSUED FOR PRELIMINARY DESIGN CLIENT REVIEW	2025.07.30
2. ISSUED FOR PRELIMINARY DESIGN CLIENT REVIEW	2025.07.22
1. ISSUED FOR PRELIMINARY DESIGN CLIENT REVIEW	2025.07.14

NO. DESCRIPTION DATE

REVISIONS

PROJECT

REGION OF PEEI

EMIL V. KOLB CENTRE
REGIONAL POLICE FACILITY
INTERIOR RENOVATION PROJECT
181 DERRY ROAD EAST, MISSISSAUGA, ON L5T 2Y5

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STRUCTURAL CONSULTANT
Stephenson Engineering
WESTON/CORSEY/COY
EXP Services Inc.
ELECTRICAL CONSULTANT
EXP Services Inc.


SHEET TITLE
REFLECTED CEILING PLAN
NEW- SECOND & THIRD
FLOOR

SHEET NO.
A301


DRAWN BY
MM

CHECKED
RN


PROJECT NO.
SCALE
AS NOTED

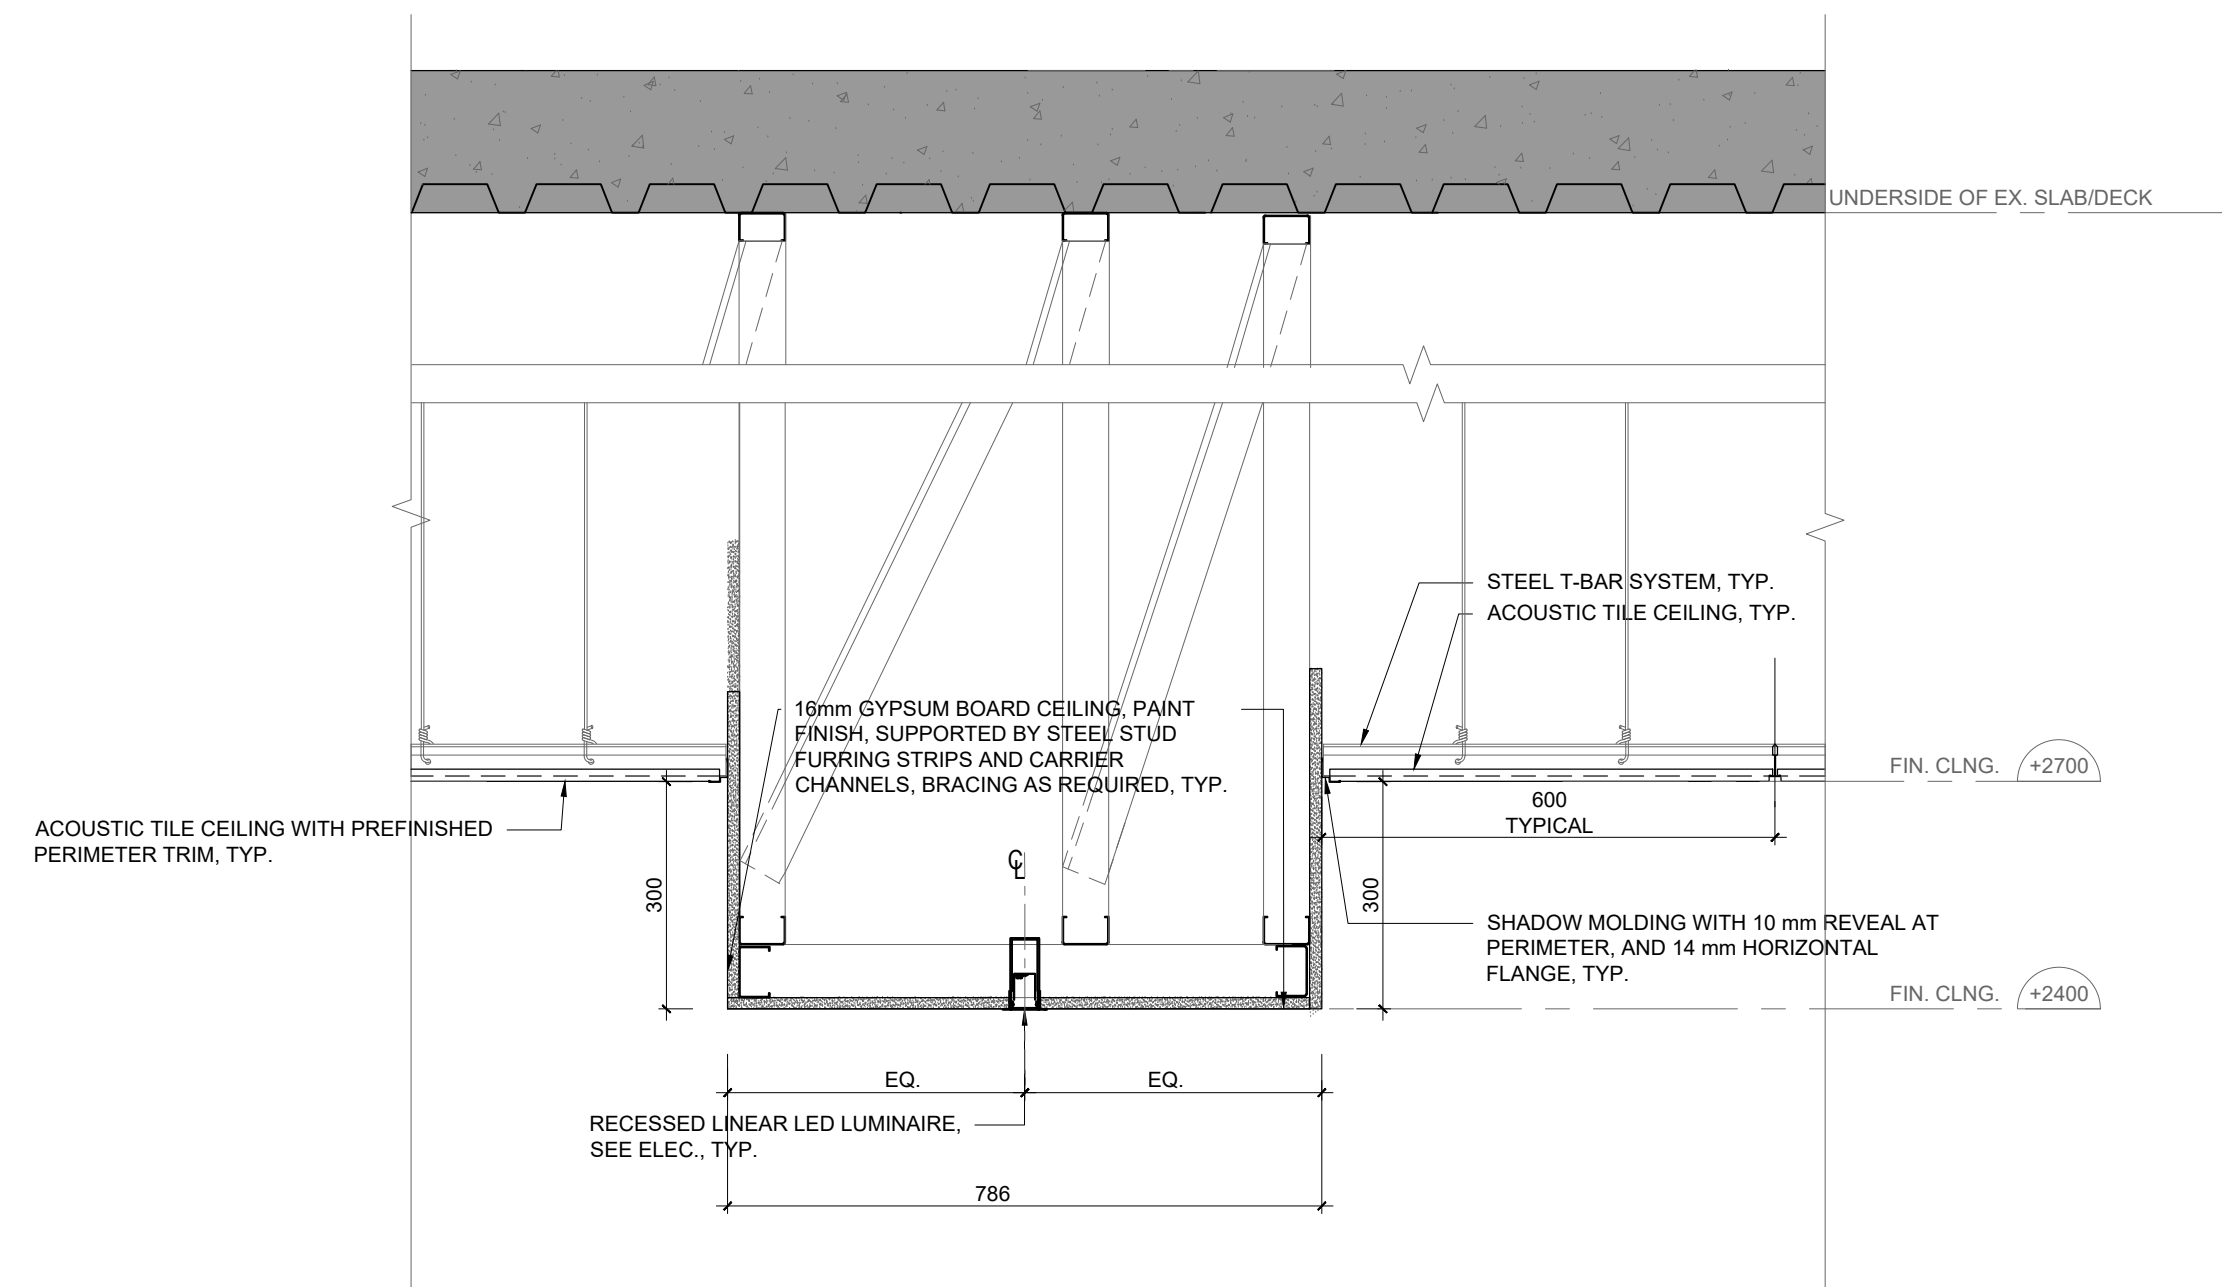


1
A302
CEILING DETAIL SECTION- GROUND FLOOR- RECEPTION
SCALE: 1:10

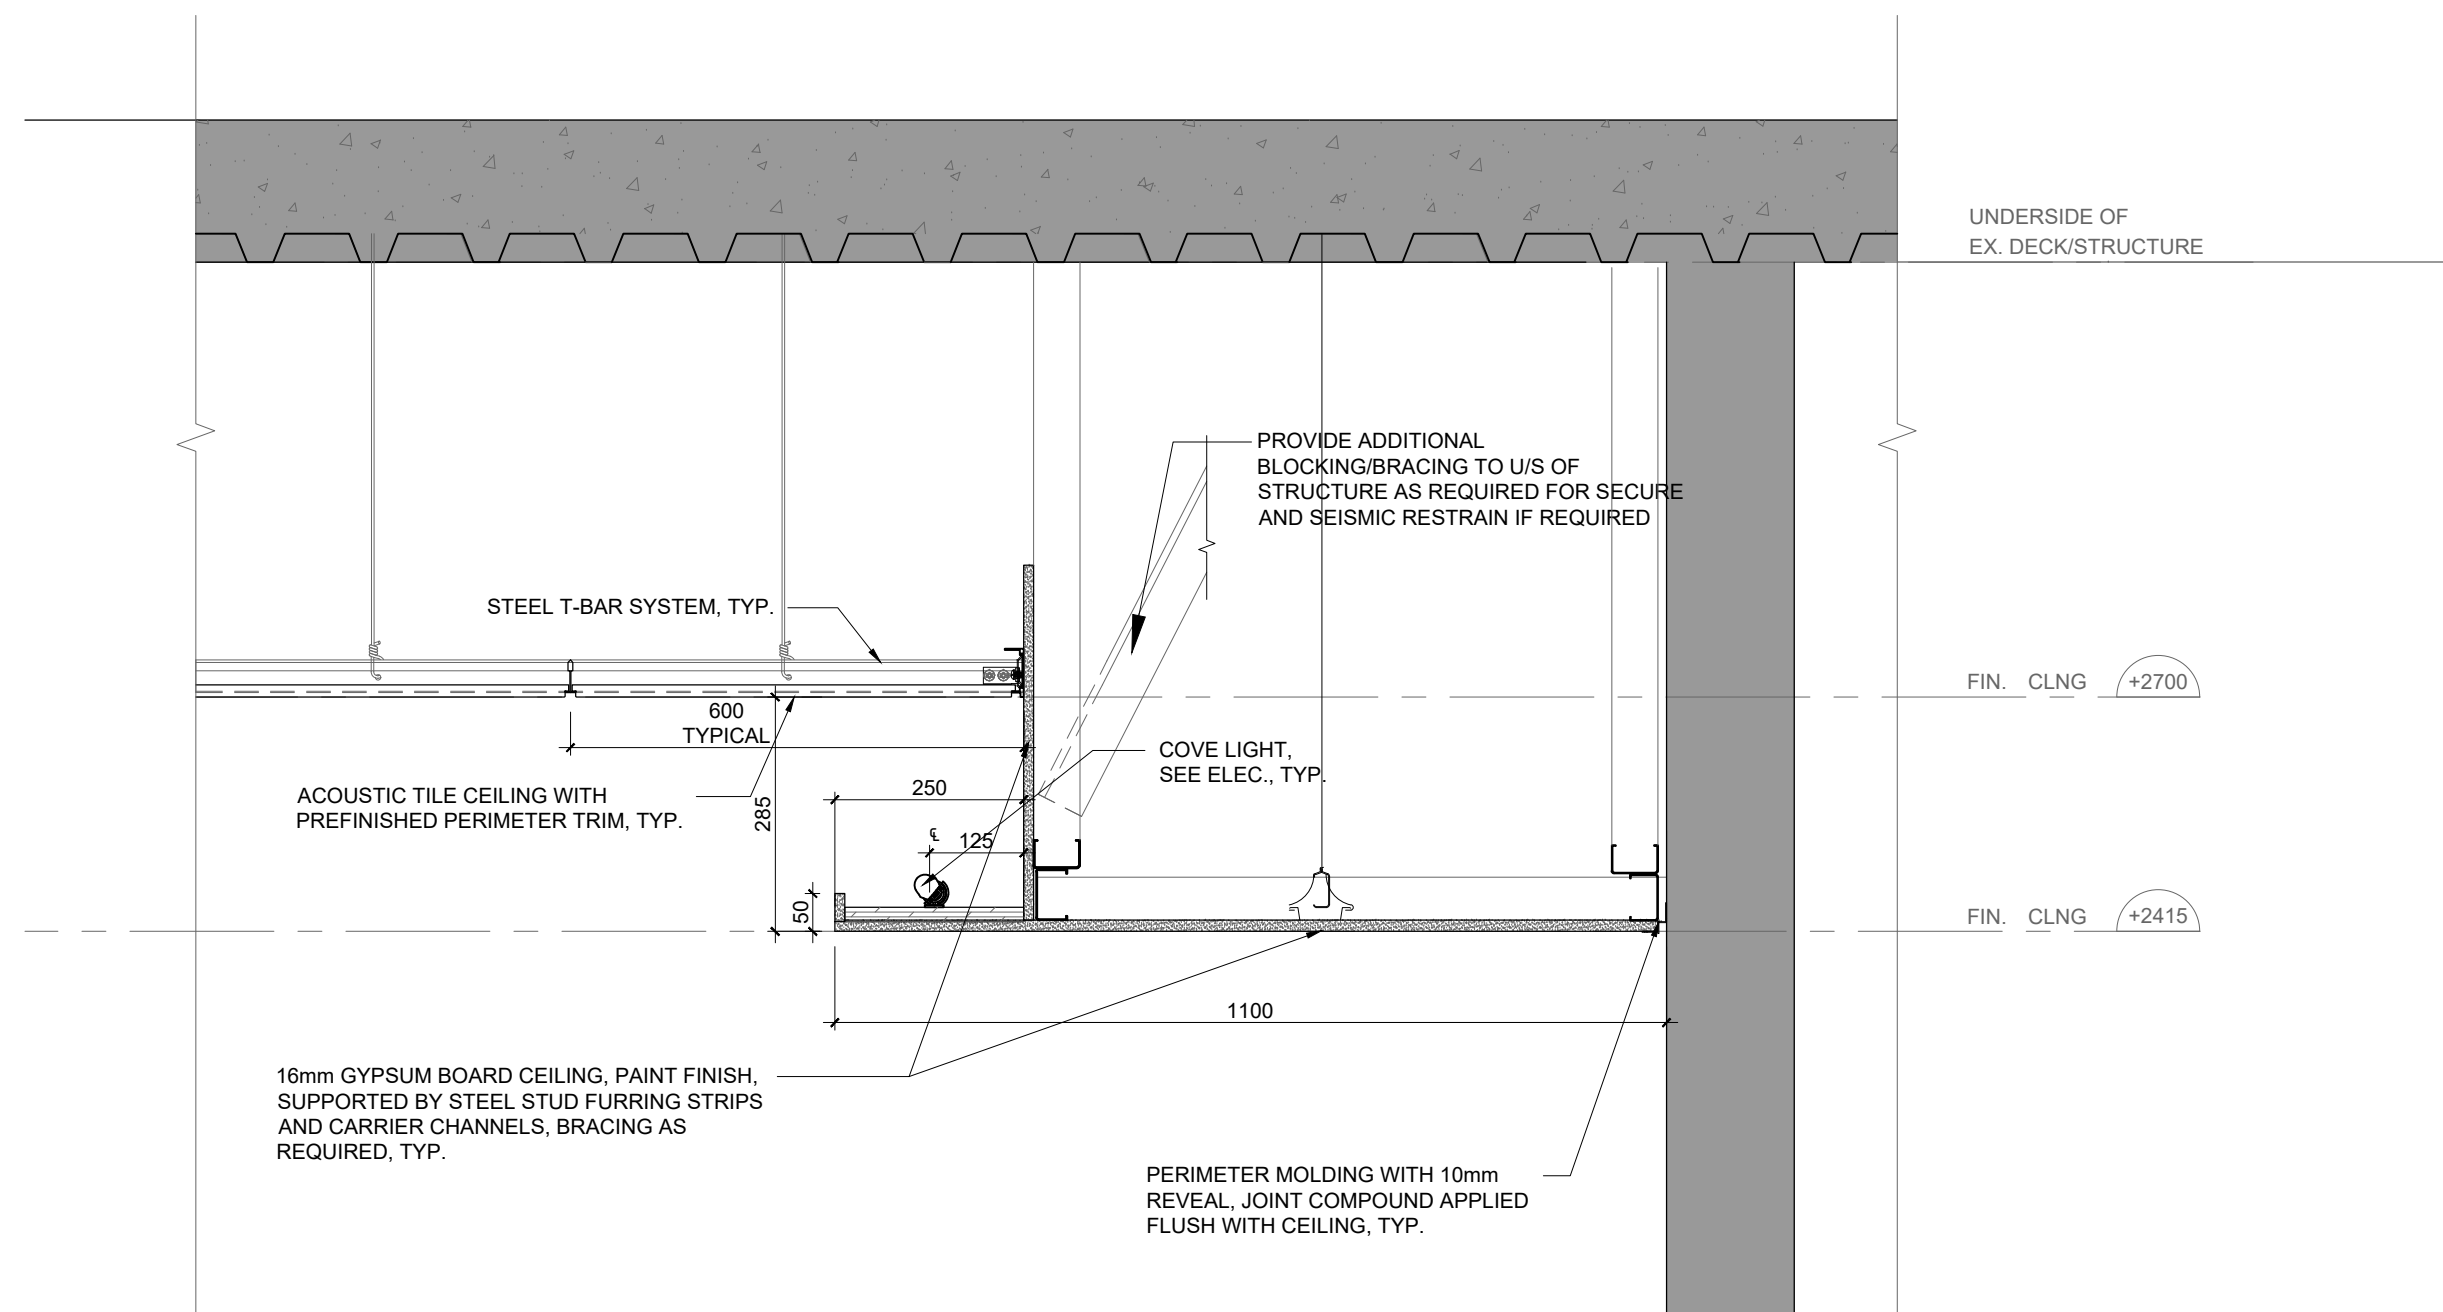

2
A302
CEILING DETAIL SECTION- GROUND FLOOR- KITCHENETTE 1096
SCALE: 1:10

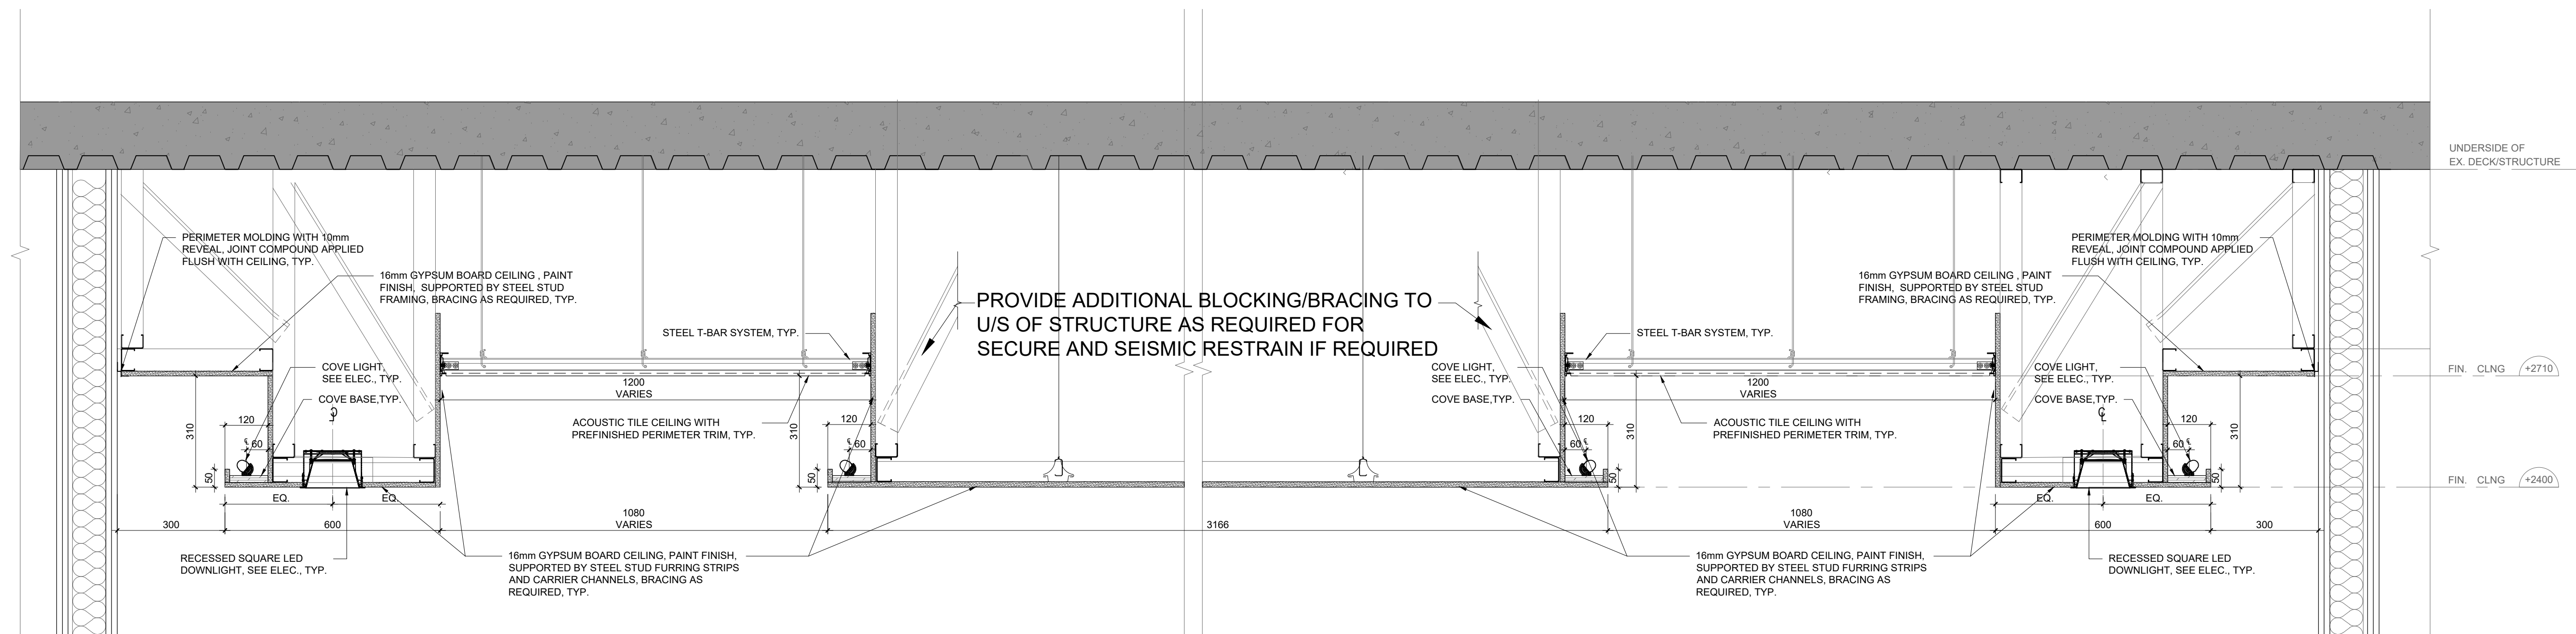

3
A302
CEILING DETAIL SECTION- THIRD FLOOR- LARGE & MEDIUM BOARD ROOM
SCALE: 1:10

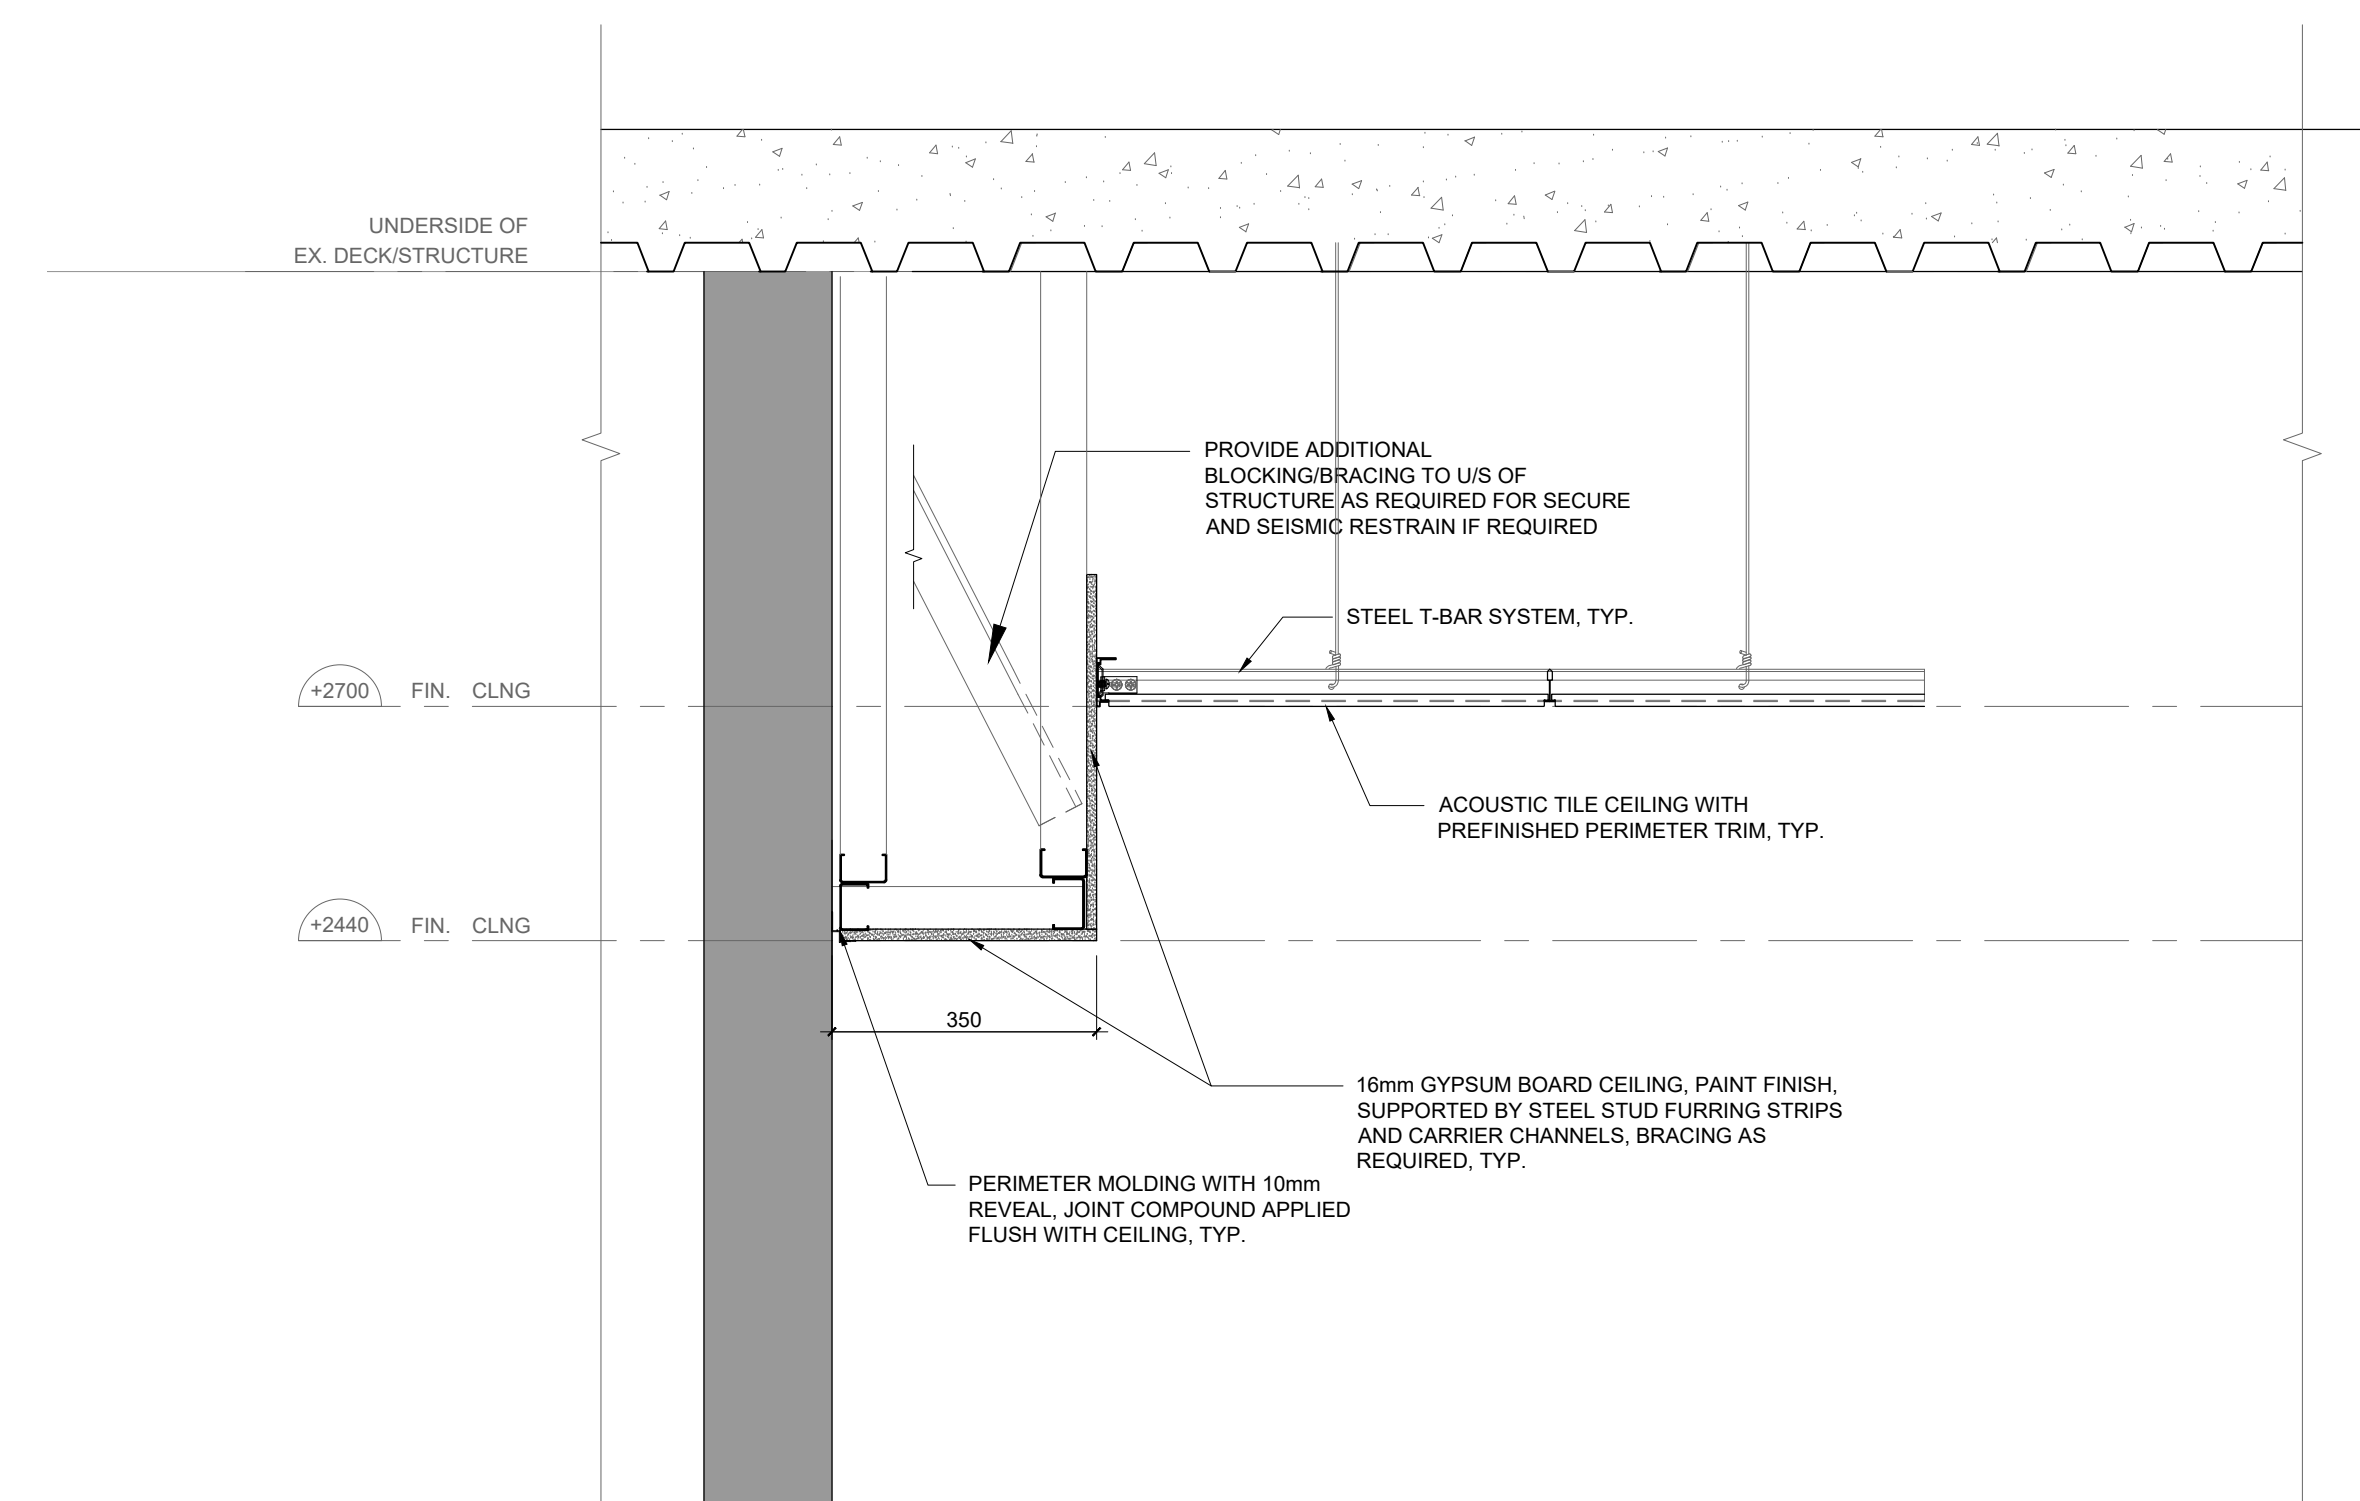

4
A302
CEILING DETAIL SECTION- GROUND AND THIRD FLOOR- KITCHEN AND LUNCH ROOM
SCALE: 1:10

13.	ISSUED FOR TENDER	2026.05.01
12.	ISSUED FOR BUILDING PERMIT	2026.04.08
11.	ISSUED FOR 10% CLIENT REVIEW	2026.03.31
10.	ISSUED FOR 5% CLIENT REVIEW	2026.01.08
9.	ISSUED FOR DESIGN DEVELOPMENT CLIENT REVIEW	2025.10.24
8.	ISSUED FOR DESIGN DEVELOPMENT CLIENT REVIEW	2025.10.01
7.	ISSUED FOR PRELIMINARY DESIGN CLIENT REVIEW	2025.09.03
6.	ISSUED FOR PRELIMINARY DESIGN CLIENT REVIEW	2025.08.18
5.	ISSUED FOR PRELIMINARY DESIGN CLIENT REVIEW	2025.08.12
4.	ISSUED FOR PRELIMINARY DESIGN CLIENT REVIEW	2025.08.01
3.	ISSUED FOR PRELIMINARY DESIGN CLIENT REVIEW	2025.07.30
2.	ISSUED FOR PRELIMINARY DESIGN CLIENT REVIEW	2025.07.25
1.	ISSUED FOR PRELIMINARY DESIGN CLIENT REVIEW	2025.07.14

NO.	DESCRIPTION	DATE
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REVISIONS	
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PROJECT	
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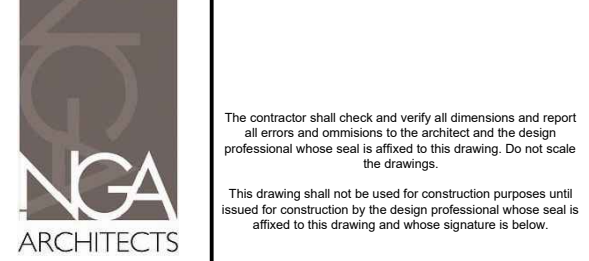


EMIL V. KOLB CENTRE

PEEL REGIONAL POLICE FACILITY

INTERIOR RENOVATION PROJECT

180 DERRY ROAD EAST, MISSISSAUGA, ON L5T 2Y5



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PROJECT CONSULTANT	DATE
STRUCTURAL CONSULTANT	
STEPHENSON ENGINEERING	
WESTON/STEPHENSON	
EXP SERVICES INC.	
ELECTRICAL CONSULTANT	
EXP SERVICES INC.	

SHEET TITLE

CEILING DETAIL SECTIONS

SHEET NO.	DRAWN BY	CHECKED
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A302

PROJECT NO.

SCALE

AS NOTED



FLOOR FINISH LEGEND	
	NEW SHEET VINYL FLOORING TYP.
	NEW CARPET TILE ON EXISTING SLAB TYP.
	NEW SLIP RESISTANT PORCELAIN TILE TYP.
	NEW SLIP RESISTANT PORCELAIN TILE TYP.
	NEW LUXURY VINYL TILE TYPE 1 TYP.
	NEW LUXURY VINYL TILE TYPE 2 TYP.
	PATCH AND REPAIR FLOOR FINISH TO MATCH EXISTING M.G.A.T. TYP.
	NEW FLOORING TRANSITION STRIP AS APPROPRIATE TO FLOORING

GENERAL DEMOLITION NOTES

1. ALL DIMENSIONS SHOWN ARE APPROXIMATE. DIMENSIONS MUST BE SITE VERIFIED BY CONTRACTOR.
2. THIS DRAWING TO BE READ IN CONJUNCTION W/ FLOOR FINISH NEW - ROOM FINISH SCHEDULE DRAWINGS. REPORT ANY DISAGREEMENTS OR CONFLICTS BETWEEN CONSULTANT'S DRAWINGS TO ARCHITECT.
3. CONTRACTOR TO SUPPLY AND INSTALL TEMPORARY PLYWOOD SHEETING TO PROTECT NEW FLOORING BEING INSTALLED IN ALL AREAS WHERE PUBLIC ACCESS MUST BE MAINTAINED DURING CONSTRUCTION.
4. GENERAL CONTRACTOR IS RESPONSIBLE FOR A-RAY STUDY OF EXIST. CONCRETE FLOOR SLAB BEFORE CUTTING TO ENSURE STRUCTURAL INTEGRITY OF THE FLOOR SLAB AND NO EXIST UNDERGROUND SERVICES TO BE AFFECTED.
5. ALL FLOOR AREAS WHERE EXISTING FLOOR FINISH HAS BEEN REMOVED TO ACCOMMODATE NEW FINISHES TO BE PROPERLY FINISHED WITH LEVELING COMPOUND UP TO 1/2" THICK. SMOOTH & CLEAN TO RECEIVE NEW FLOORING.
6. REPAIR, PATCH, MAKE GOOD AT WALL AND FLOOR JOINTS AND PAINT FINISH TO ALL RELATED SURFACES TO MATCH EXISTING NEW MECHANICAL & ELECTRICAL, DISPOSITIONS, FIXTURES AND NEW CONNECTIONS.



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10	ISSUED FOR 60% CLIENT REVIEW	2026.01.09
9	ISSUED FOR PRELIMINARY DESIGN CLIENT REVIEW	2025.10.24
8	ISSUED FOR PRELIMINARY DESIGN CLIENT REVIEW	2025.10.10
7	ISSUED FOR PRELIMINARY DESIGN CLIENT REVIEW	2025.09.23
6	ISSUED FOR PRELIMINARY DESIGN CLIENT REVIEW	2025.08.18
5	ISSUED FOR PRELIMINARY DESIGN CLIENT REVIEW	2025.08.12
4	ISSUED FOR PRELIMINARY DESIGN CLIENT REVIEW	2025.08.01
3	ISSUED FOR PRELIMINARY DESIGN CLIENT REVIEW	2025.07.30
2	ISSUED FOR PRELIMINARY DESIGN CLIENT REVIEW	2025.07.25
1	ISSUED FOR PRELIMINARY DESIGN CLIENT REVIEW	2025.07.14
NO. DESCRIPTION		DATE
REVISIONS		
6/20/2025		




REGION OF PEEB

EMIL V. KOLB CENTRE
PEEL REGIONAL POLICE FACILITY
INTERIOR RENOVATION PROJECT
180 DERRY ROAD EAST, MISSISSAUGA, ON L5T 2Y5




The contractor shall check and verify all dimensions and report all errors and omissions to the architect and the design professional whose seal is affixed to this drawing. Do not scale the drawings.

This drawing shall not be used for construction purposes until issued for construction by the design professional whose seal is affixed to this drawing and whose signature is below.

NORTH PROJECT NO. 	ISSUED FOR CONSTRUCTION _____ DATE _____
	STRUCTURAL CONSULTANT Stephenson Engineering MECHANICAL CONSULTANT EXP Services Inc. ELECTRICAL CONSULTANT EXP Services Inc.
SHEET NO. _____	

FLOOR FINISH PLAN
NEW- BASEMENT & GROUND
FLOOR

SHEET NO. A400	DRAWN BY	CHECKED
	MM	RN
	PROJECT NO.	
	SCALE AS NOTED	

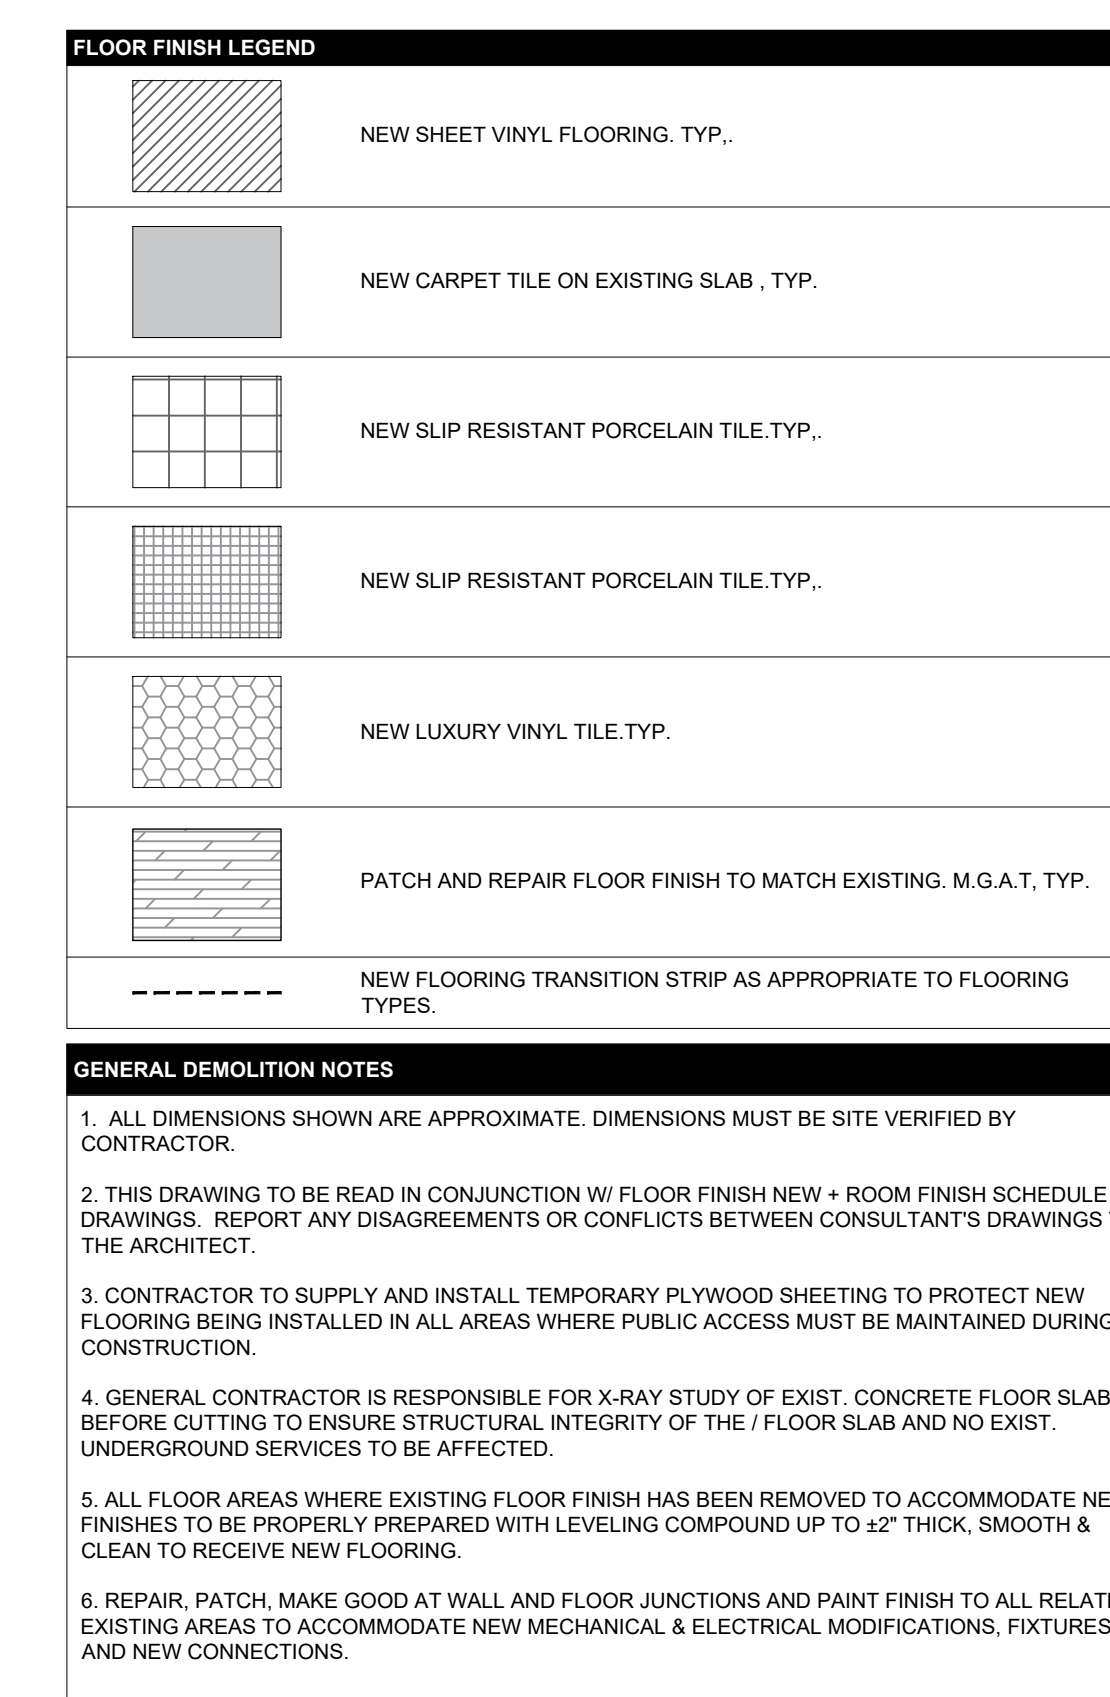

2 FLOOR FINISH PLAN- NEW- SECOND FLOOR (WASHROOMS)
A401 SCALE: 1:100




3 FLOOR FINISH PLAN- NEW- THIRD FLOOR
A401 SCALE: 1:100




3 WALL FINISH PLAN- GROUND FLOOR
A402 SCALE: 1:100

SHEET NO. A402	DRAWN BY	CHECKED
	MM	RN
	PROJECT NO.	
SCALE		AS NOTED

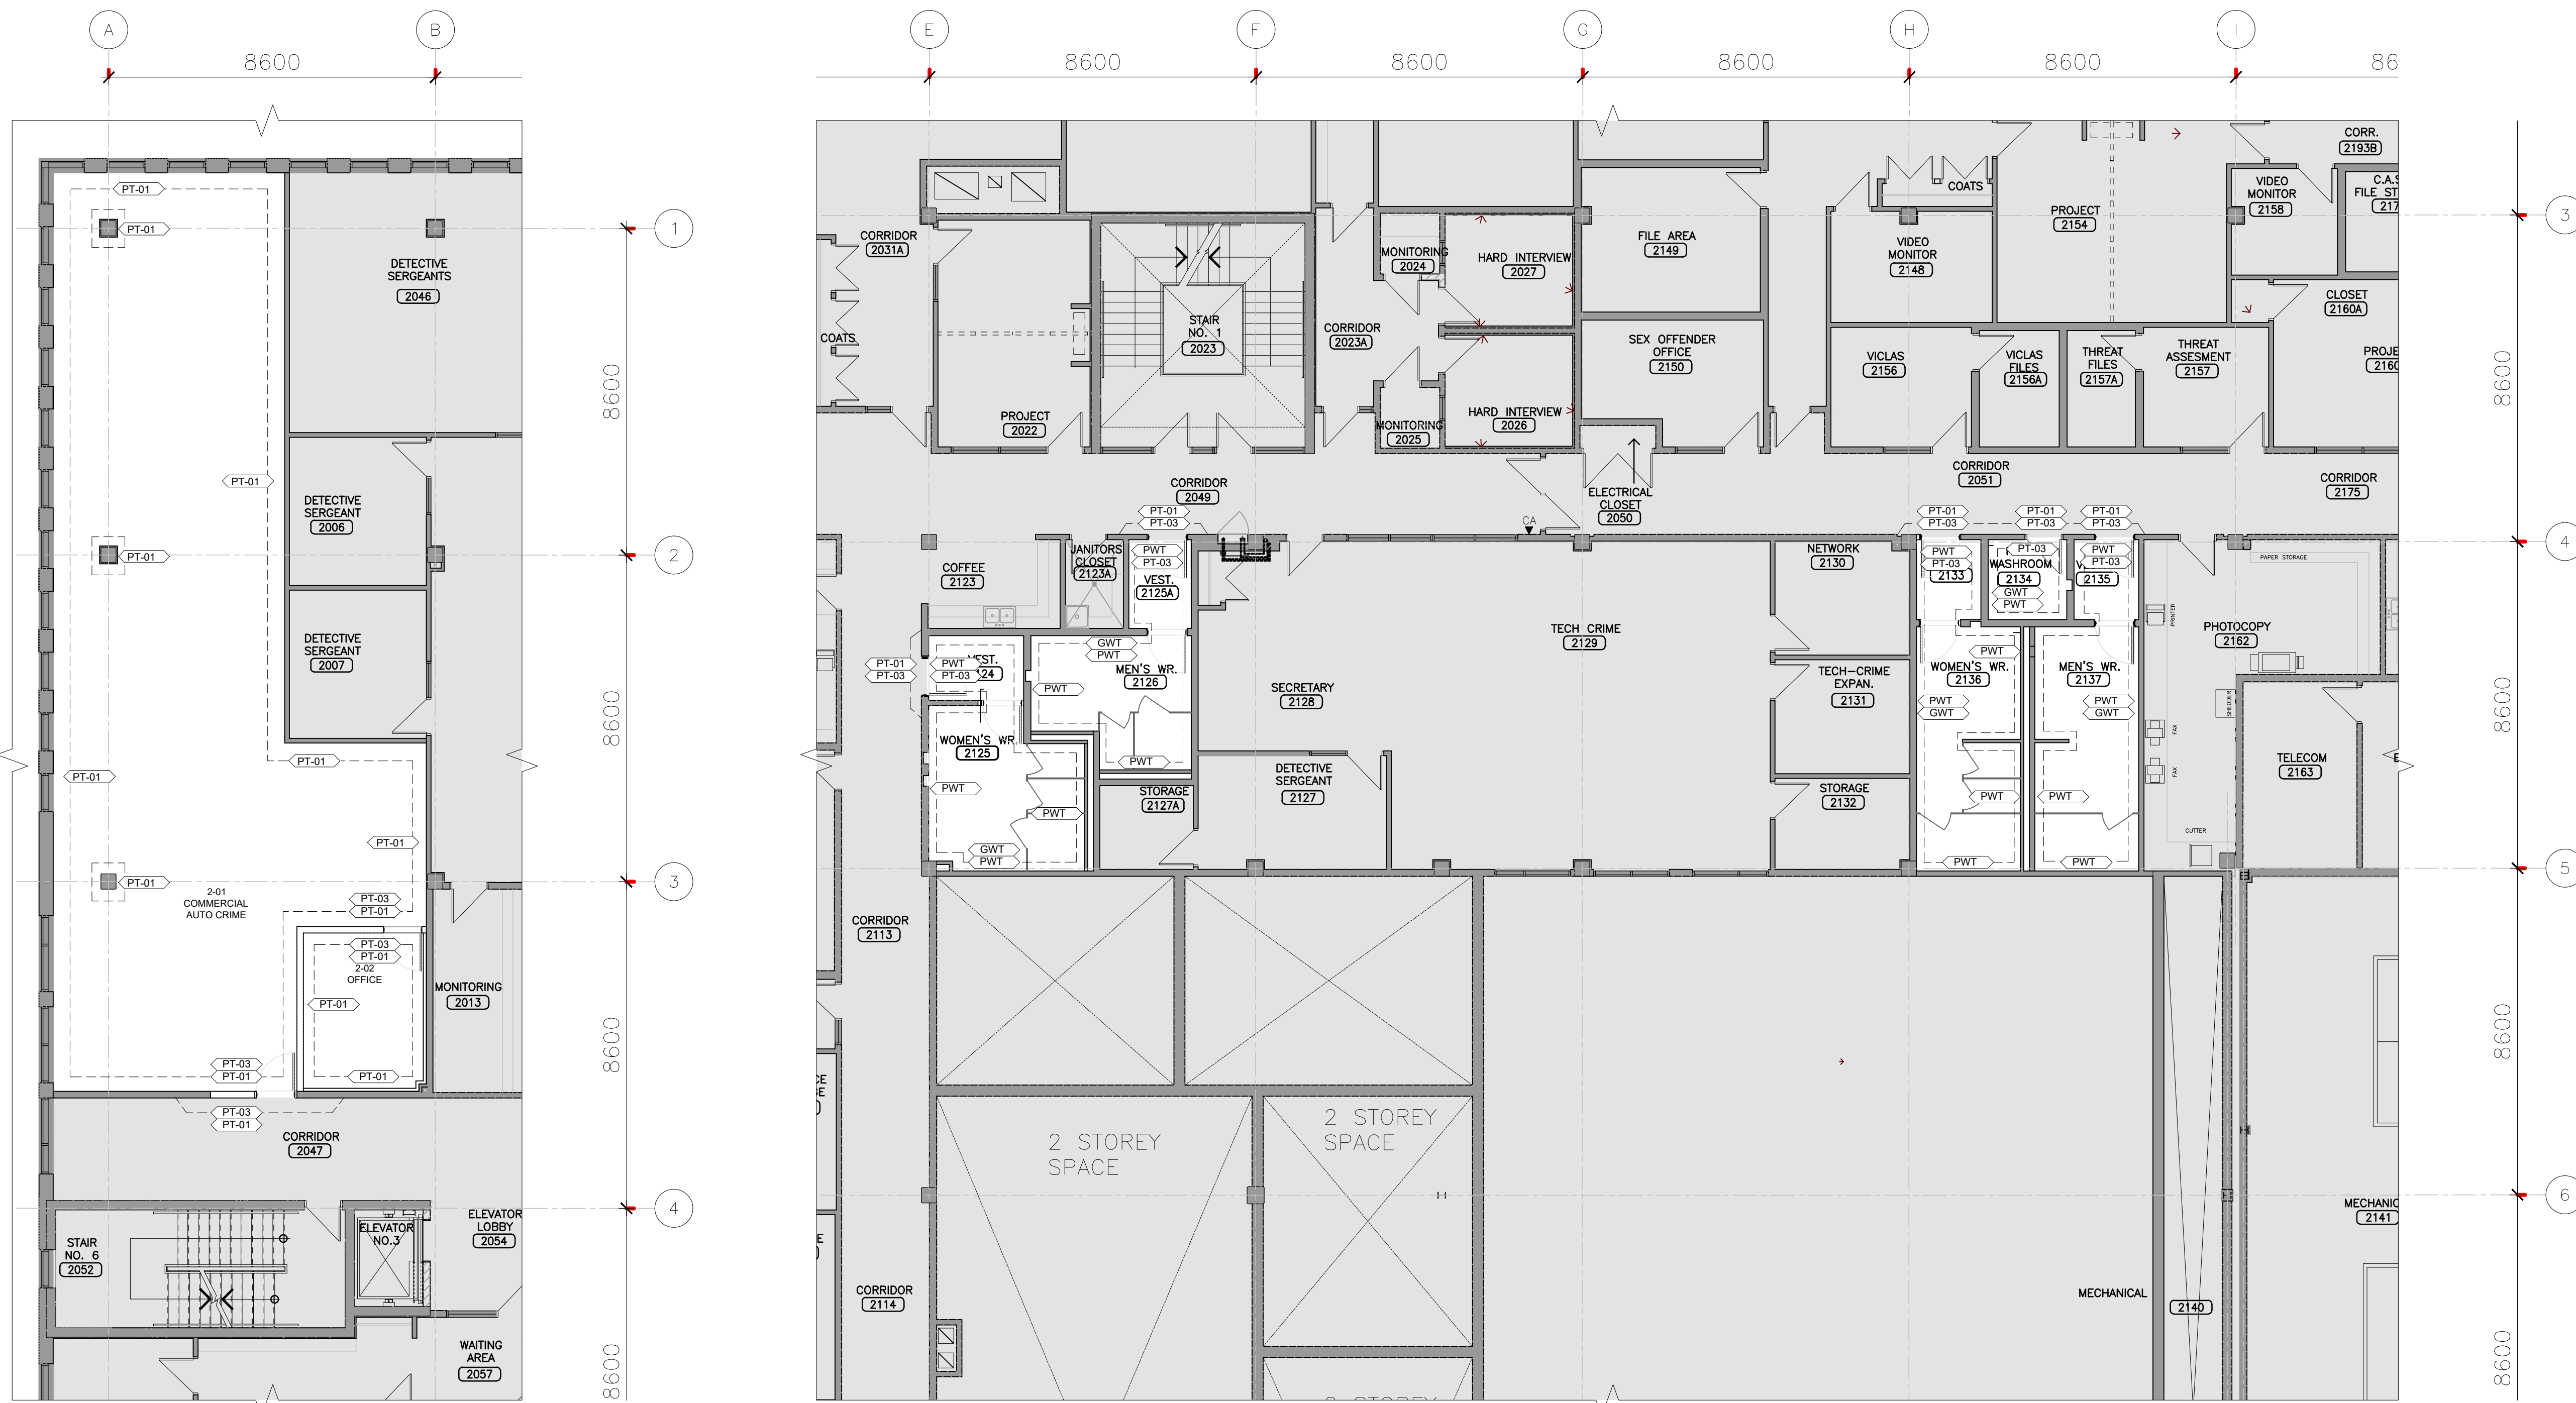

1 WALL FINISH PLAN- SECOND FLOOR
A403 SCALE: 1:100

2 WALL FINISH PLAN- NEW- SECOND FLOOR (WASHROOMS)
A403 SCALE: 1:100

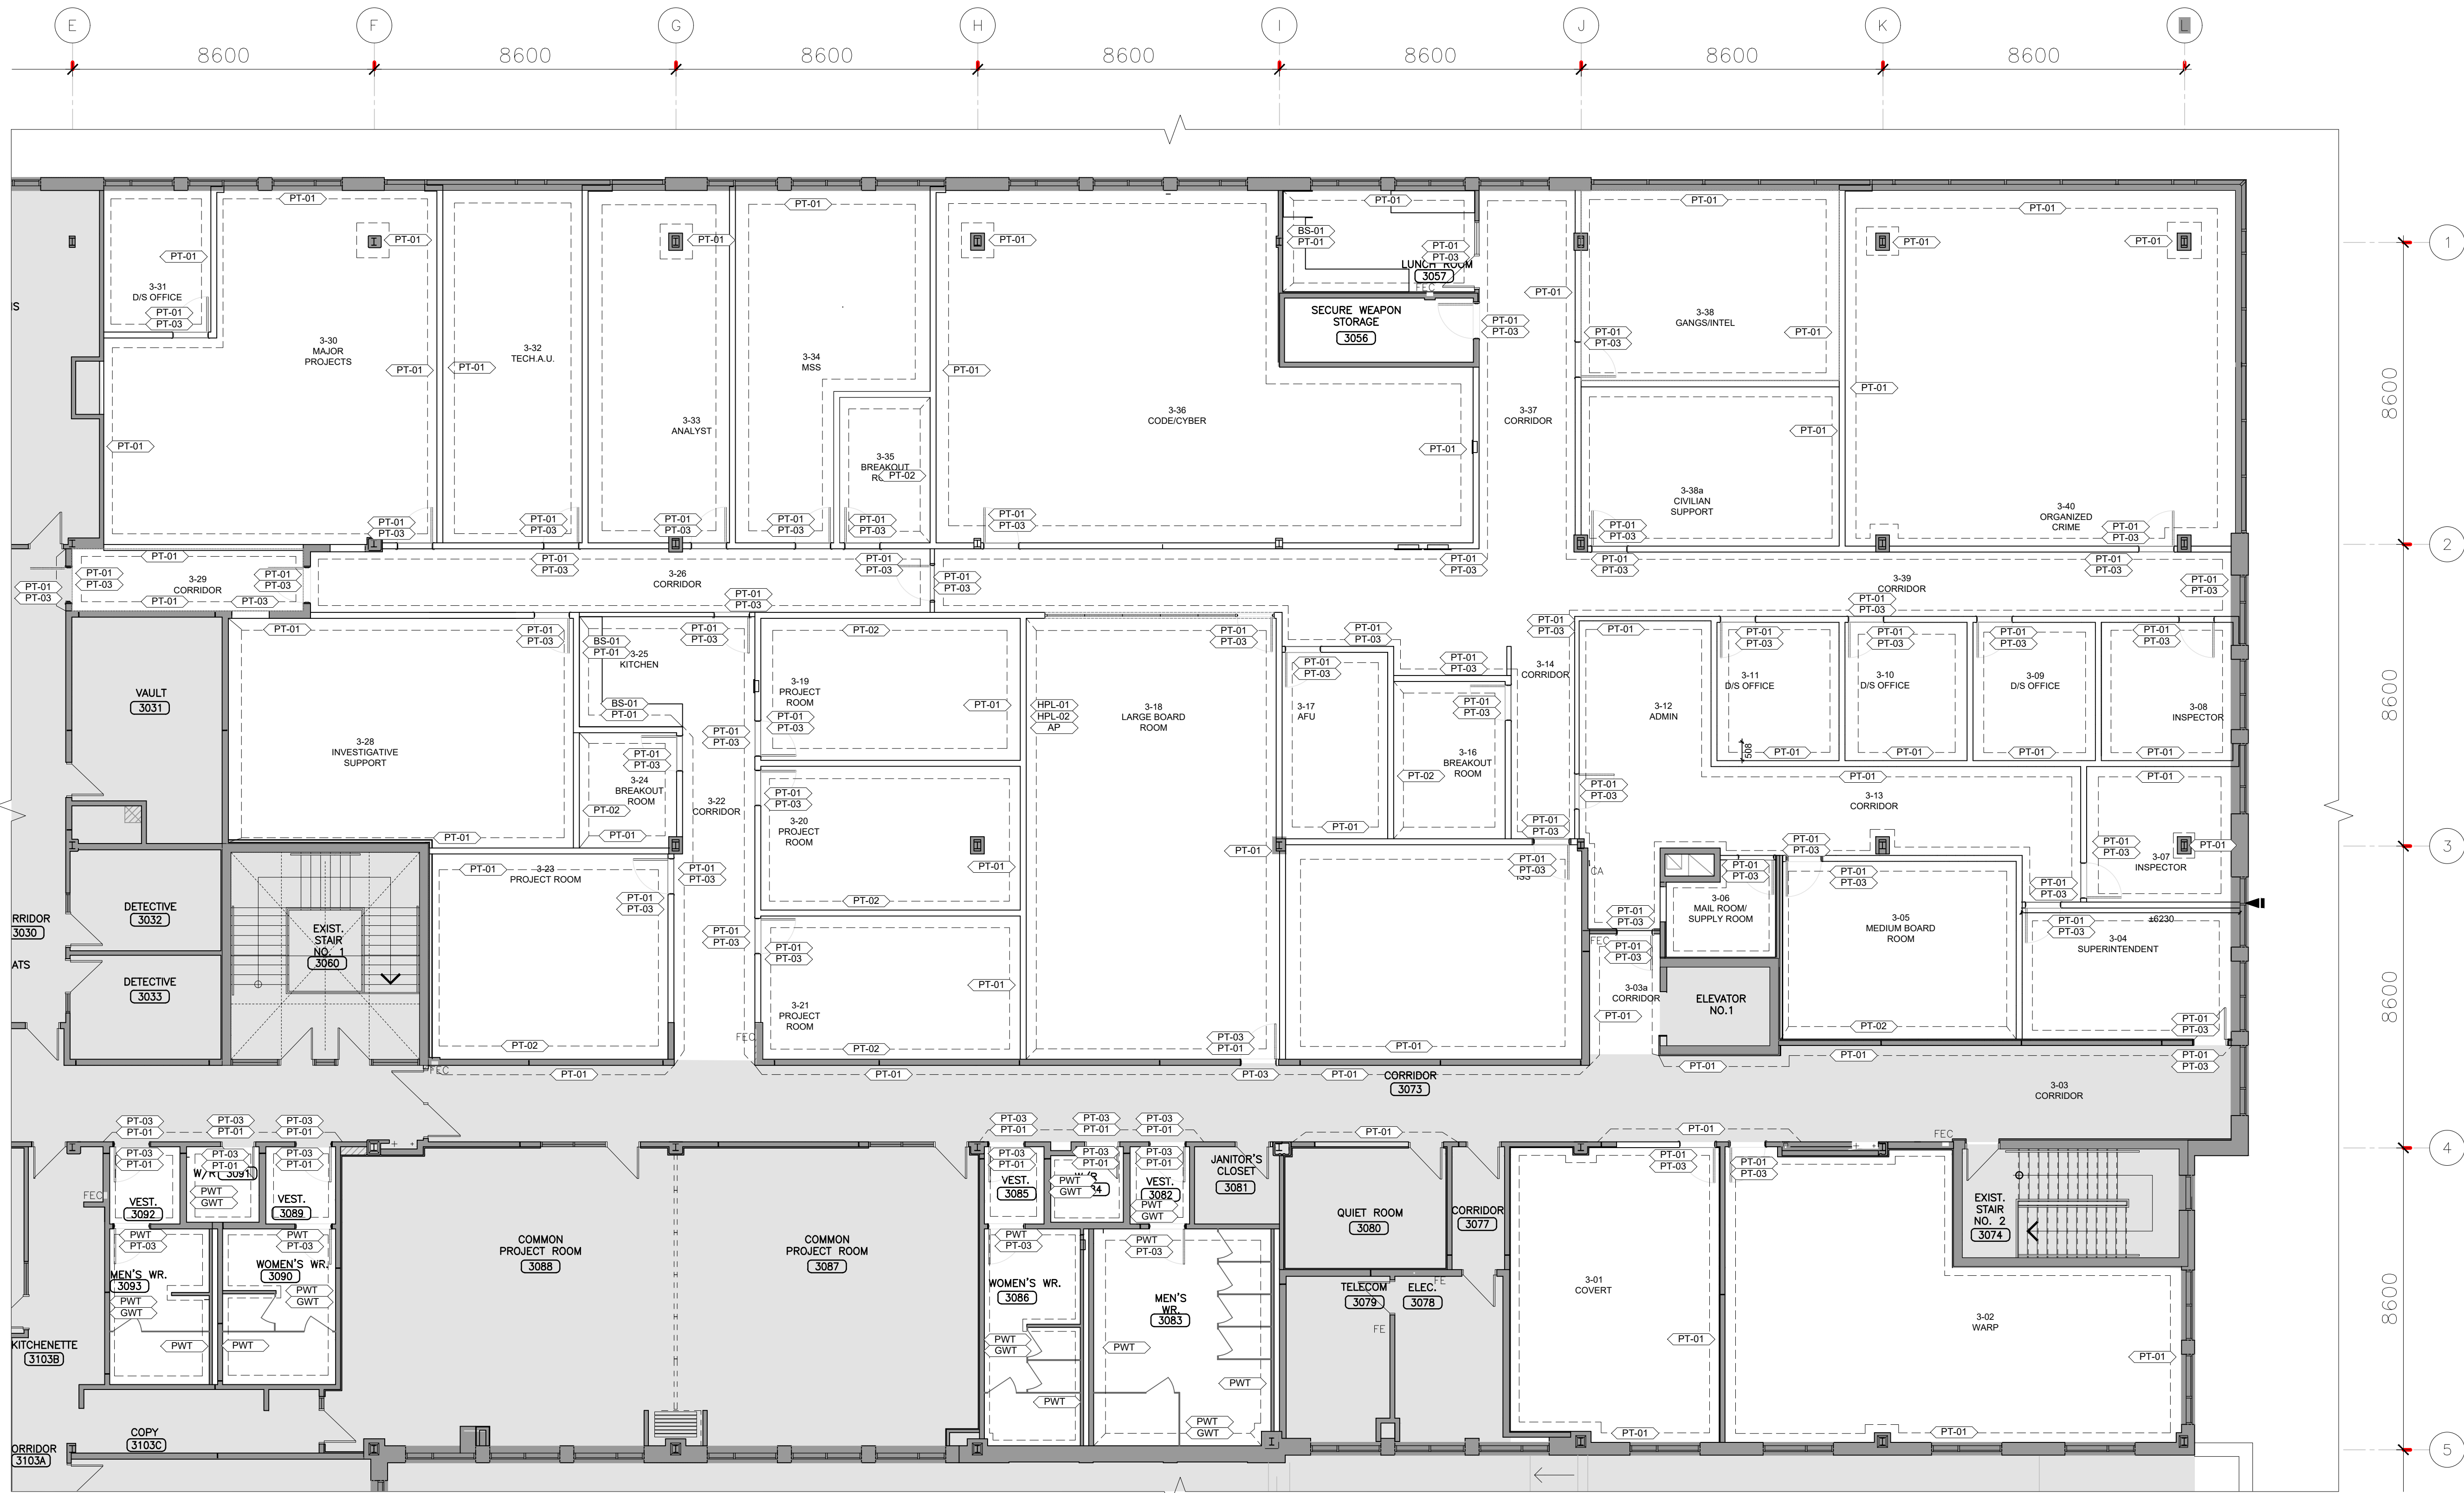

3 FLOOR FINISH PLAN- NEW- THIRD FLOOR
A403 SCALE: 1:100

FLOOR FINISH LEGEND	
PT-01	PAINT FINISH - GENERAL. COLOR TO BE CONFIRMED BY ARCHITECT & CLIENT
PT-02	PAINT FINISH - ACCENT WALL. COLOR TO BE CONFIRMED BY ARCHITECT & CLIENT
PT-03	PAINT FINISH - EXTINGNEW DOOR & FRAMES. COLOR TO BE CONFIRMED BY ARCHITECT & CLIENT BOTH SIDES OF DOORS TO BE PAINTED TYP. SAND PRIME AND STAIN FINISH ALL EXISTING WOOD DOORS. COLOR TO MATCH EXISTING. TYP.
BS-01	BACK SPLASH - CENTURA MKII GLASS SERIES- SEA HAZE MTG102 FINISH- GLOSSY 50mm X200mm GROUT: 909 - STERLING
PWT	PORCELAIN WALL TILE - CENTURA GLOCAL SERIES- CLEAR GC01. FINISH: NATURAL. 300mmX300mm GROUT: 909 - STERLING
GWT	FEATURE WALL GLASS WALL TILE - CENTURA MKII GLASS SERIES- SEA HAZE MTG102 FINISH- GLOSSY 50mm X 300mm. GROUT: 909 STERLING
GWT-1	FEATURE WALL GLASS WALL TILE - CENTURA MKII GLASS SERIES- ATMOSPHERE OPUS60212 FINISH- GLOSSY 50mm X 300mm. GROUT: 909 STERLING
WPA	WOOD PANEL TO MATCH EXISTING
HPL-01	HIGH PRESSURE LAMINATE PANEL - TAFSA MATERIA- MOONLIGHT T761 (M)
HPL-02	HIGH PRESSURE LAMINATE PANEL - TAFSA LMMMA- MIDNIGHT SUNTROMA
AP	ACOUSTIC PANEL - GULFORD OF MAINE HERITAGE - ANCHORAGE 2335- WHITE 2664

13. ISSUED FOR TENDER	2026.05.01
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8. ISSUED FOR DESIGN DEVELOPMENT CLIENT REVIEW	2025.10.01
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3. ISSUED FOR PRELIMINARY DESIGN CLIENT REVIEW	2025.07.30
2. ISSUED FOR PRELIMINARY DESIGN CLIENT REVIEW	2025.07.22
1. ISSUED FOR PRELIMINARY DESIGN CLIENT REVIEW	2025.07.14

NO.	DESCRIPTION	DATE
REVISIONS		
PROJECT		

REGION OF PEEL

EMIL V. KOLB CENTRE
PEEL REGIONAL POLICE FACILITY
181 DERRY ROAD EAST, MISSISSAUGA, ON L5T 2Y5

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STRUCTURAL CONSULTANT	STEPHENSON ENGINEERING
MECHANICAL CONSULTANT	EXP SERVICES INC.
ELECTRICAL CONSULTANT	EXP SERVICES INC.


SHEET TITLE	
FLOOR FINISH PLAN NEW- SECOND & THIRD FLOOR	
SHEET NO.	A403
DRAWN BY	MM
CHECKED BY	RN
PROJECT NO.	
SCALE	AS NOTED

NOTES


ALL EXISTING PAPER TOWEL DISPENSER, TOILET PAPER HOLDER, AND SOAP DISPENSER TO BE REMOVED AND REINSTALLED, TYP, TO ALL WASHROOMS, SHOWER ROOMS AND KITCHEN. FINAL LOCATION TO BE CONFIRMED BY THE CLIENT.

GENERAL CONTRACTOR IS RESPONSIBLE, AT THEIR OWN EXPENSE, TO SUPPLY & INSTALL NEW DISPENSER AND HOLDER TO REPLACE ANY DAMAGED DISPENSER AND HOLDER DURING REMOVAL TYP.


GC IS TO RETURN ALL EXISTING STAINLESS STEEL DISPENSER AND DISPOSAL UNIT TO THE CLIENT AFTER REMOVAL, TYP.

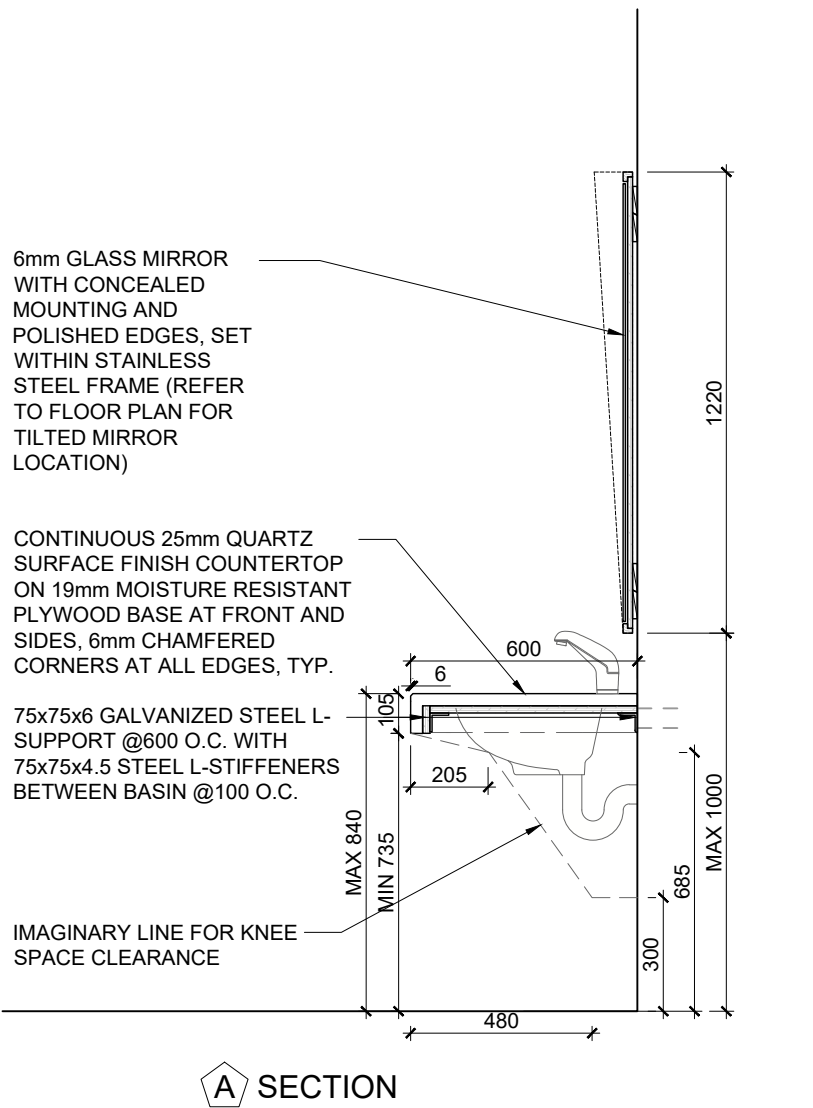


5 TYPICAL WASHROOM COUNTERTOP DETAILS
SCALE: 1:20

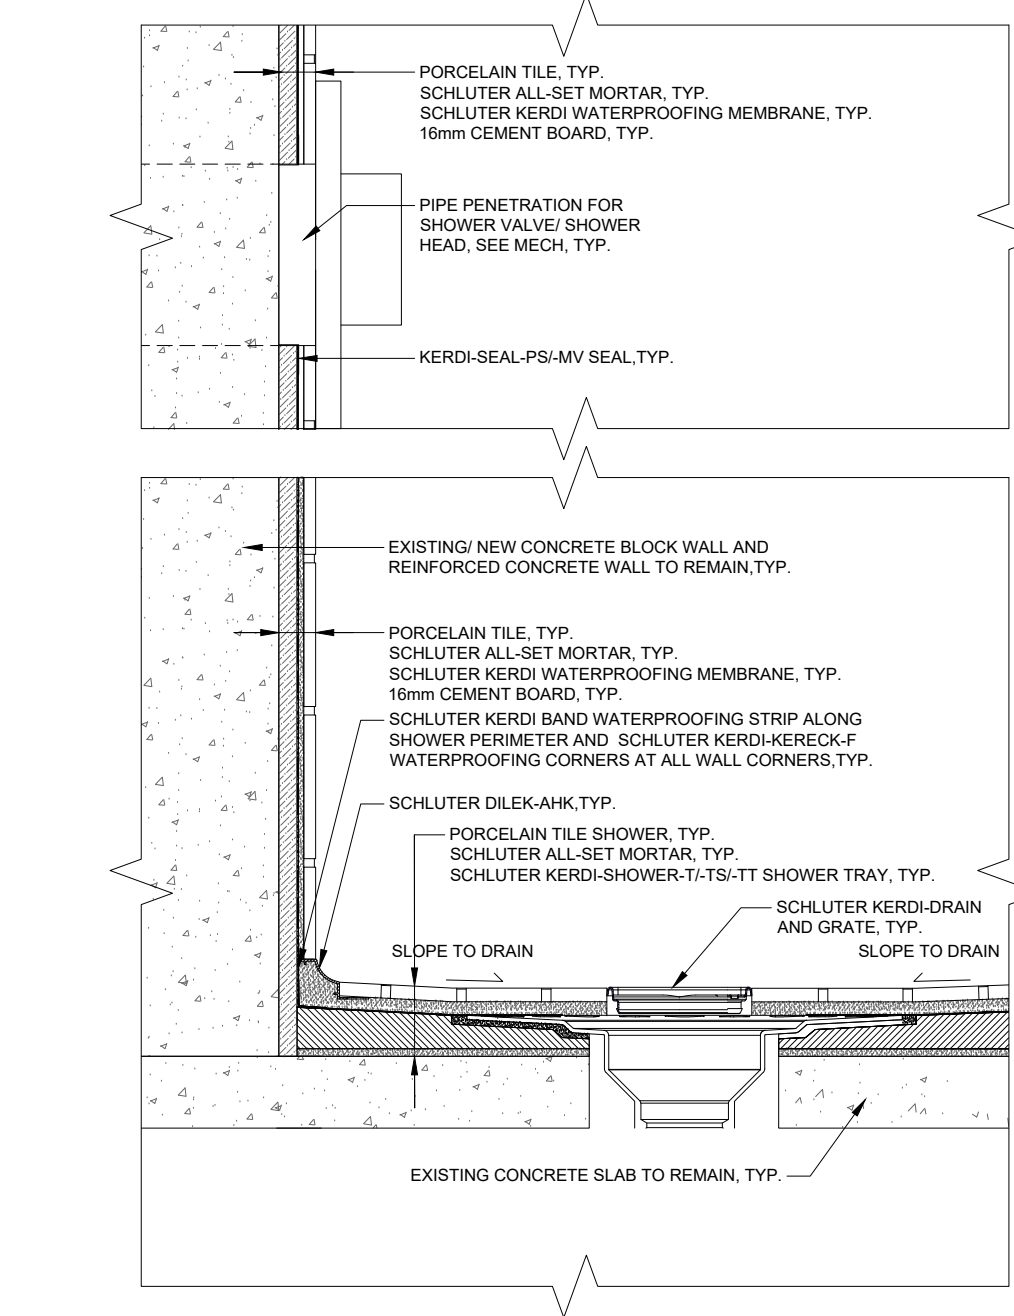

6 CONCRETE WALL DETAILS (POINT DRAIN)
SCALE: 1:5

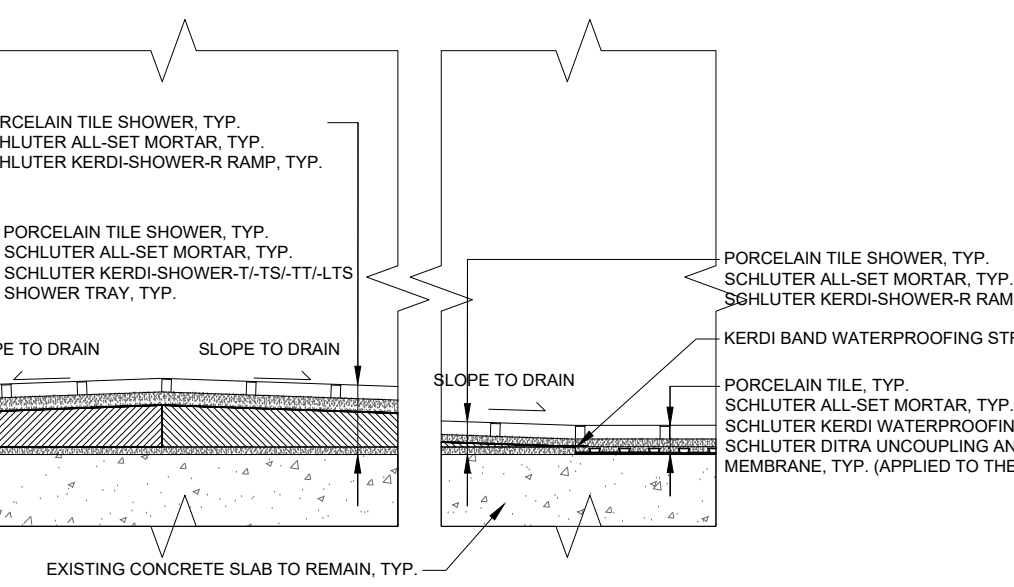


7 TYPICAL CURBLESS SHOWER DETAILS
SCALE: 1:5

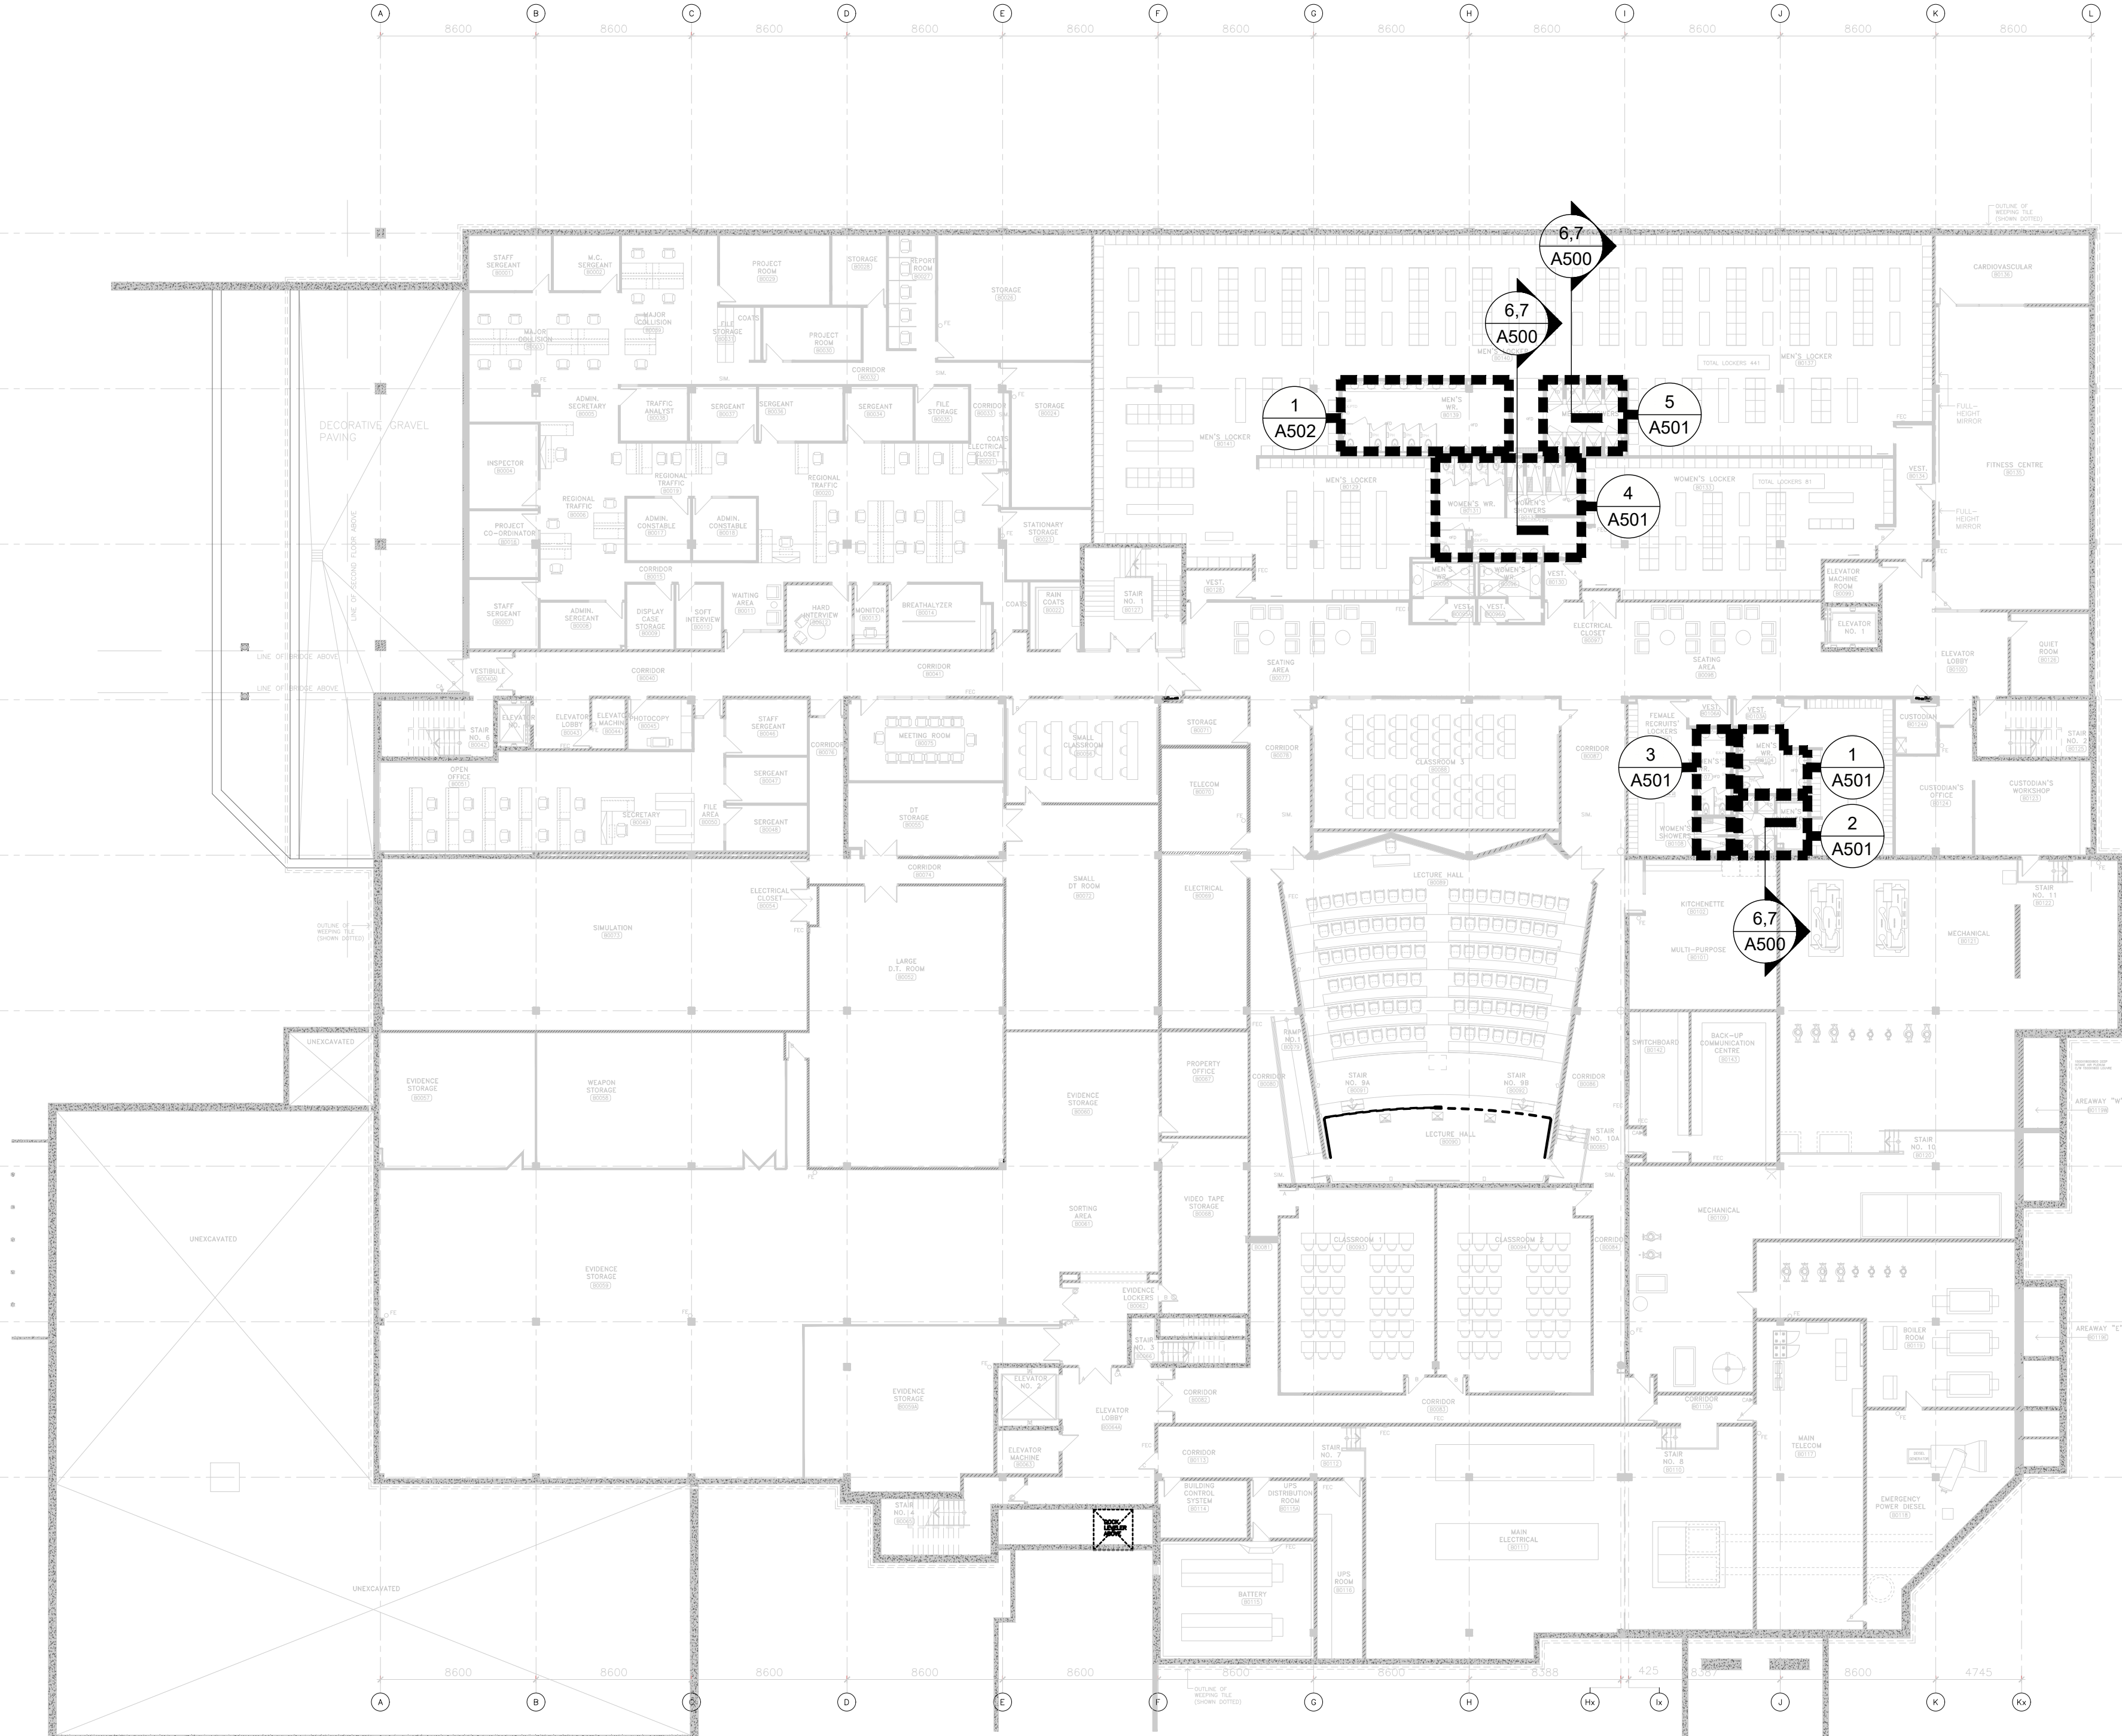


1 INTERIOR ELEVATION KEY PLAN - BASEMENT FLOOR SHOWER/WASHROOM
SCALE: 1:50



2 INTERIOR ELEVATION KEY PLAN - GROUND FLOOR WASHROOM
SCALE: 1:50

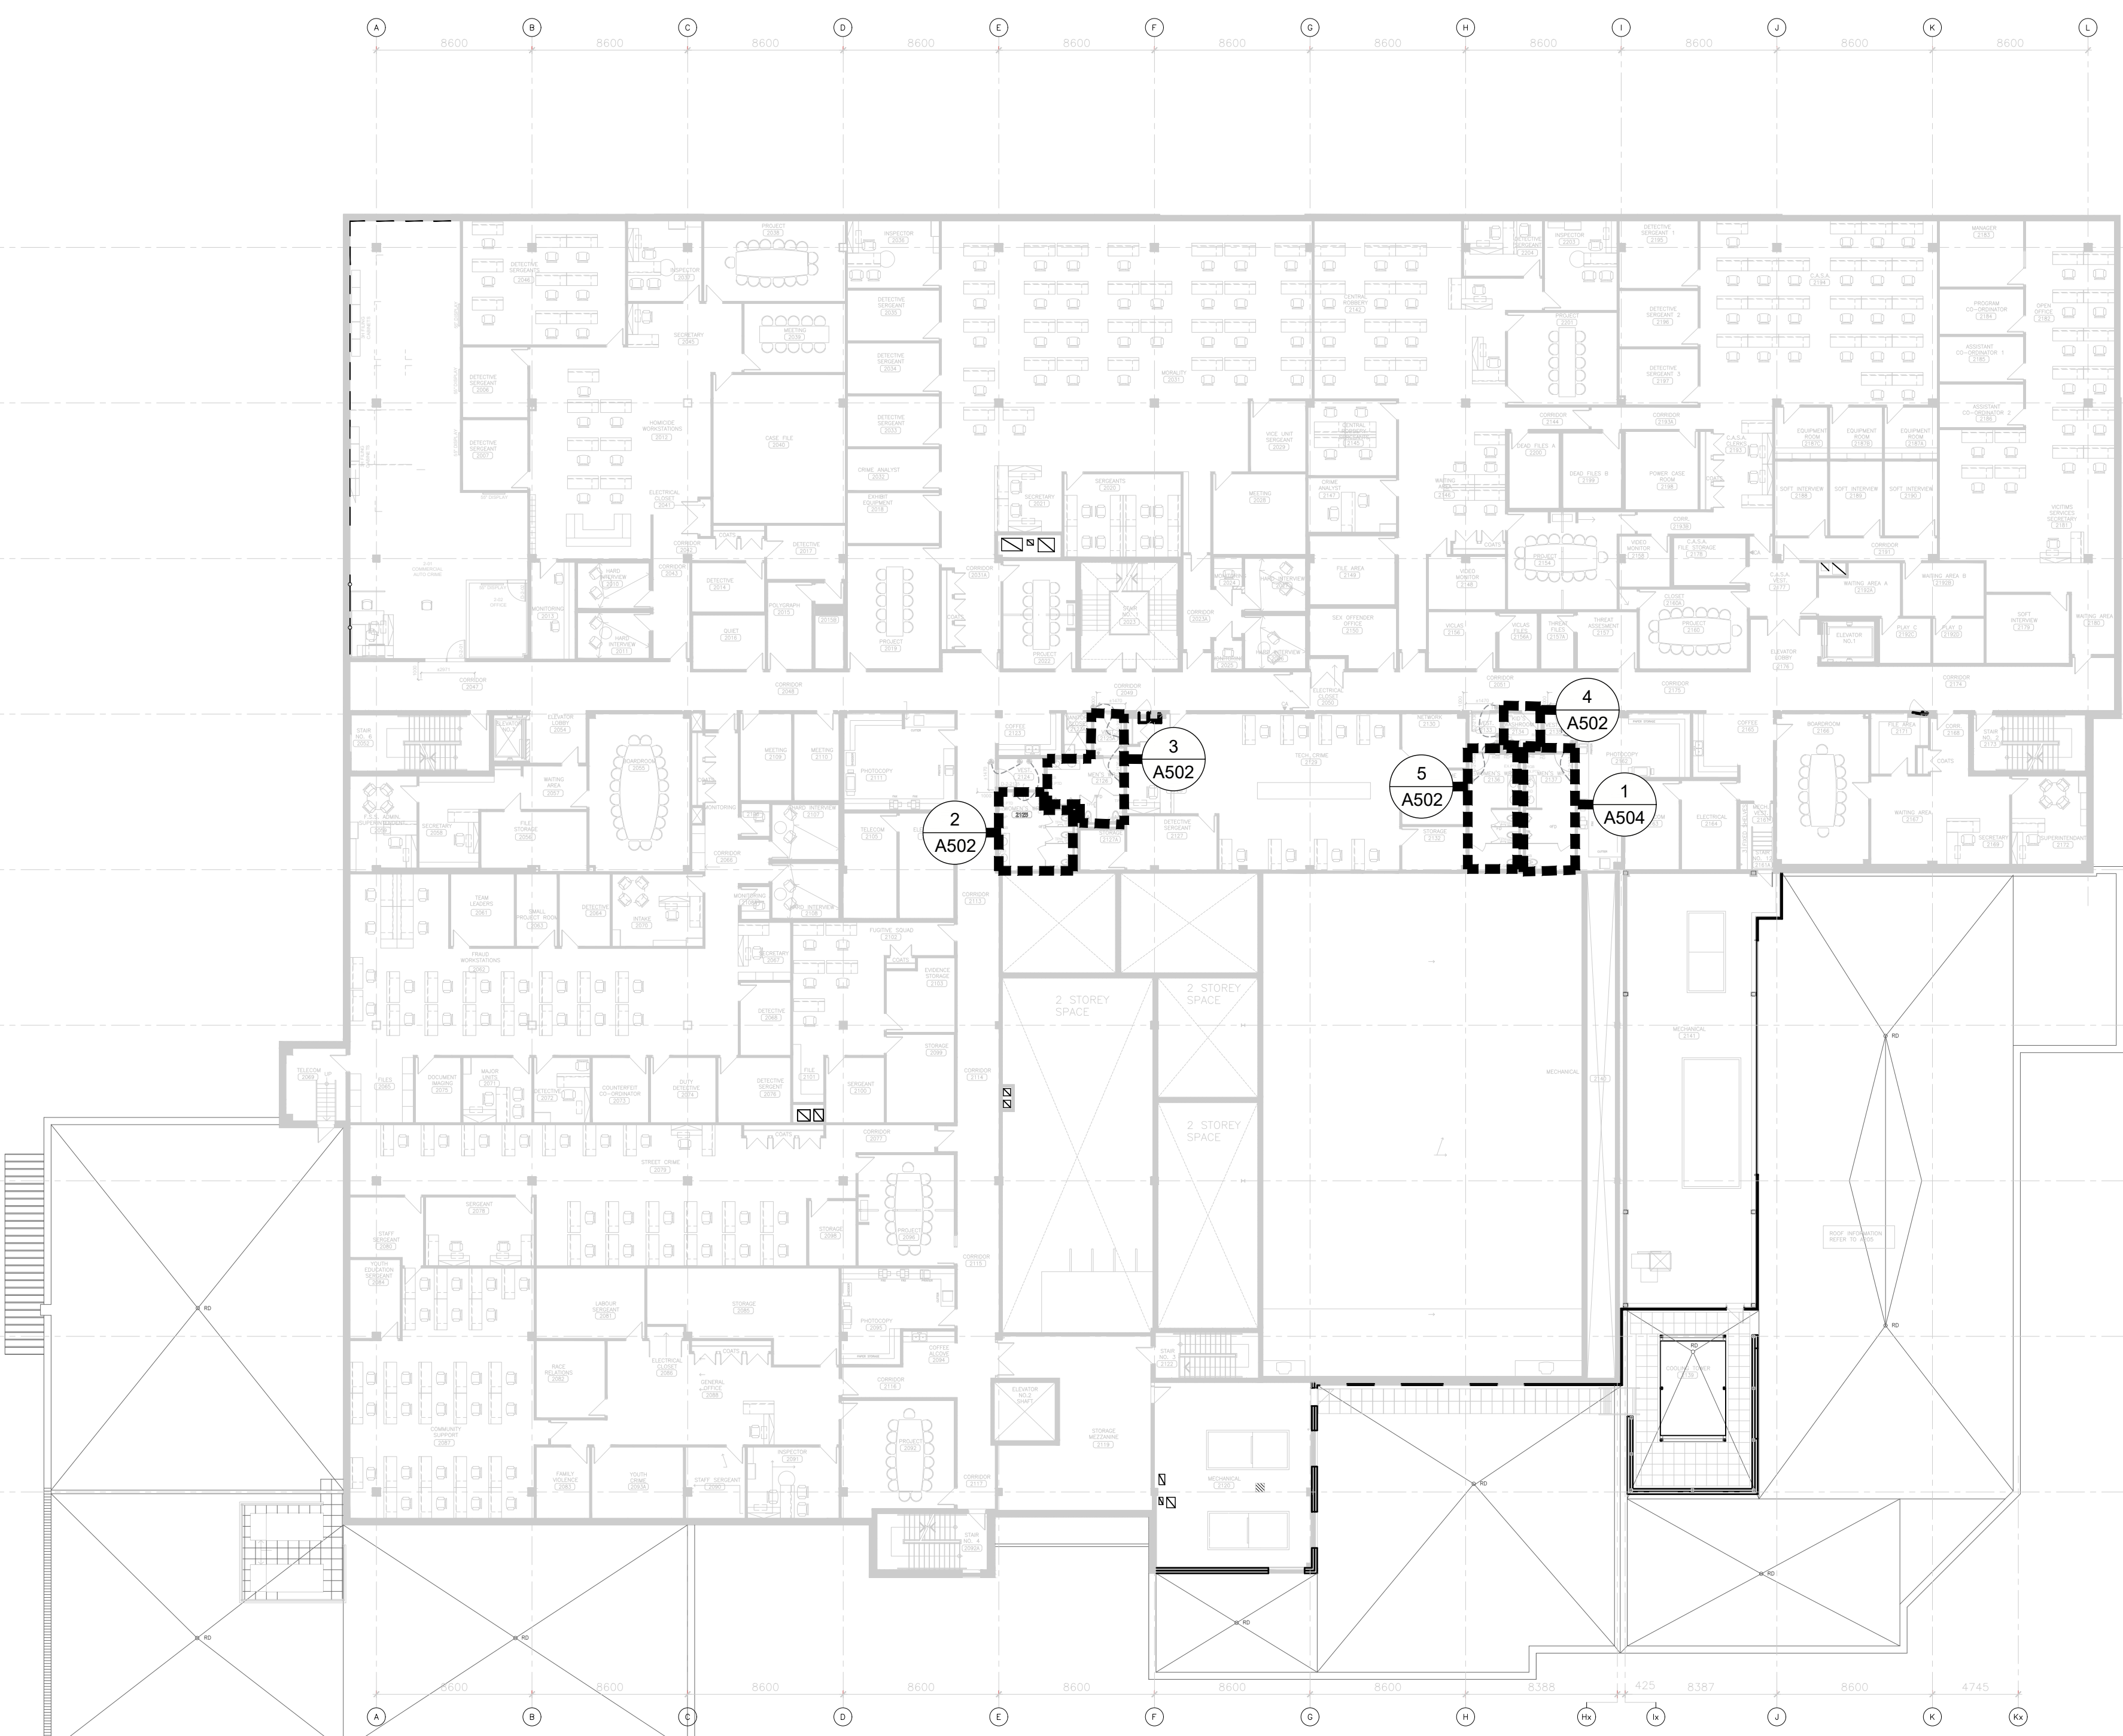


3 INTERIOR ELEVATION KEY PLAN - SECOND FLOOR WASHROOM
SCALE: 1:50


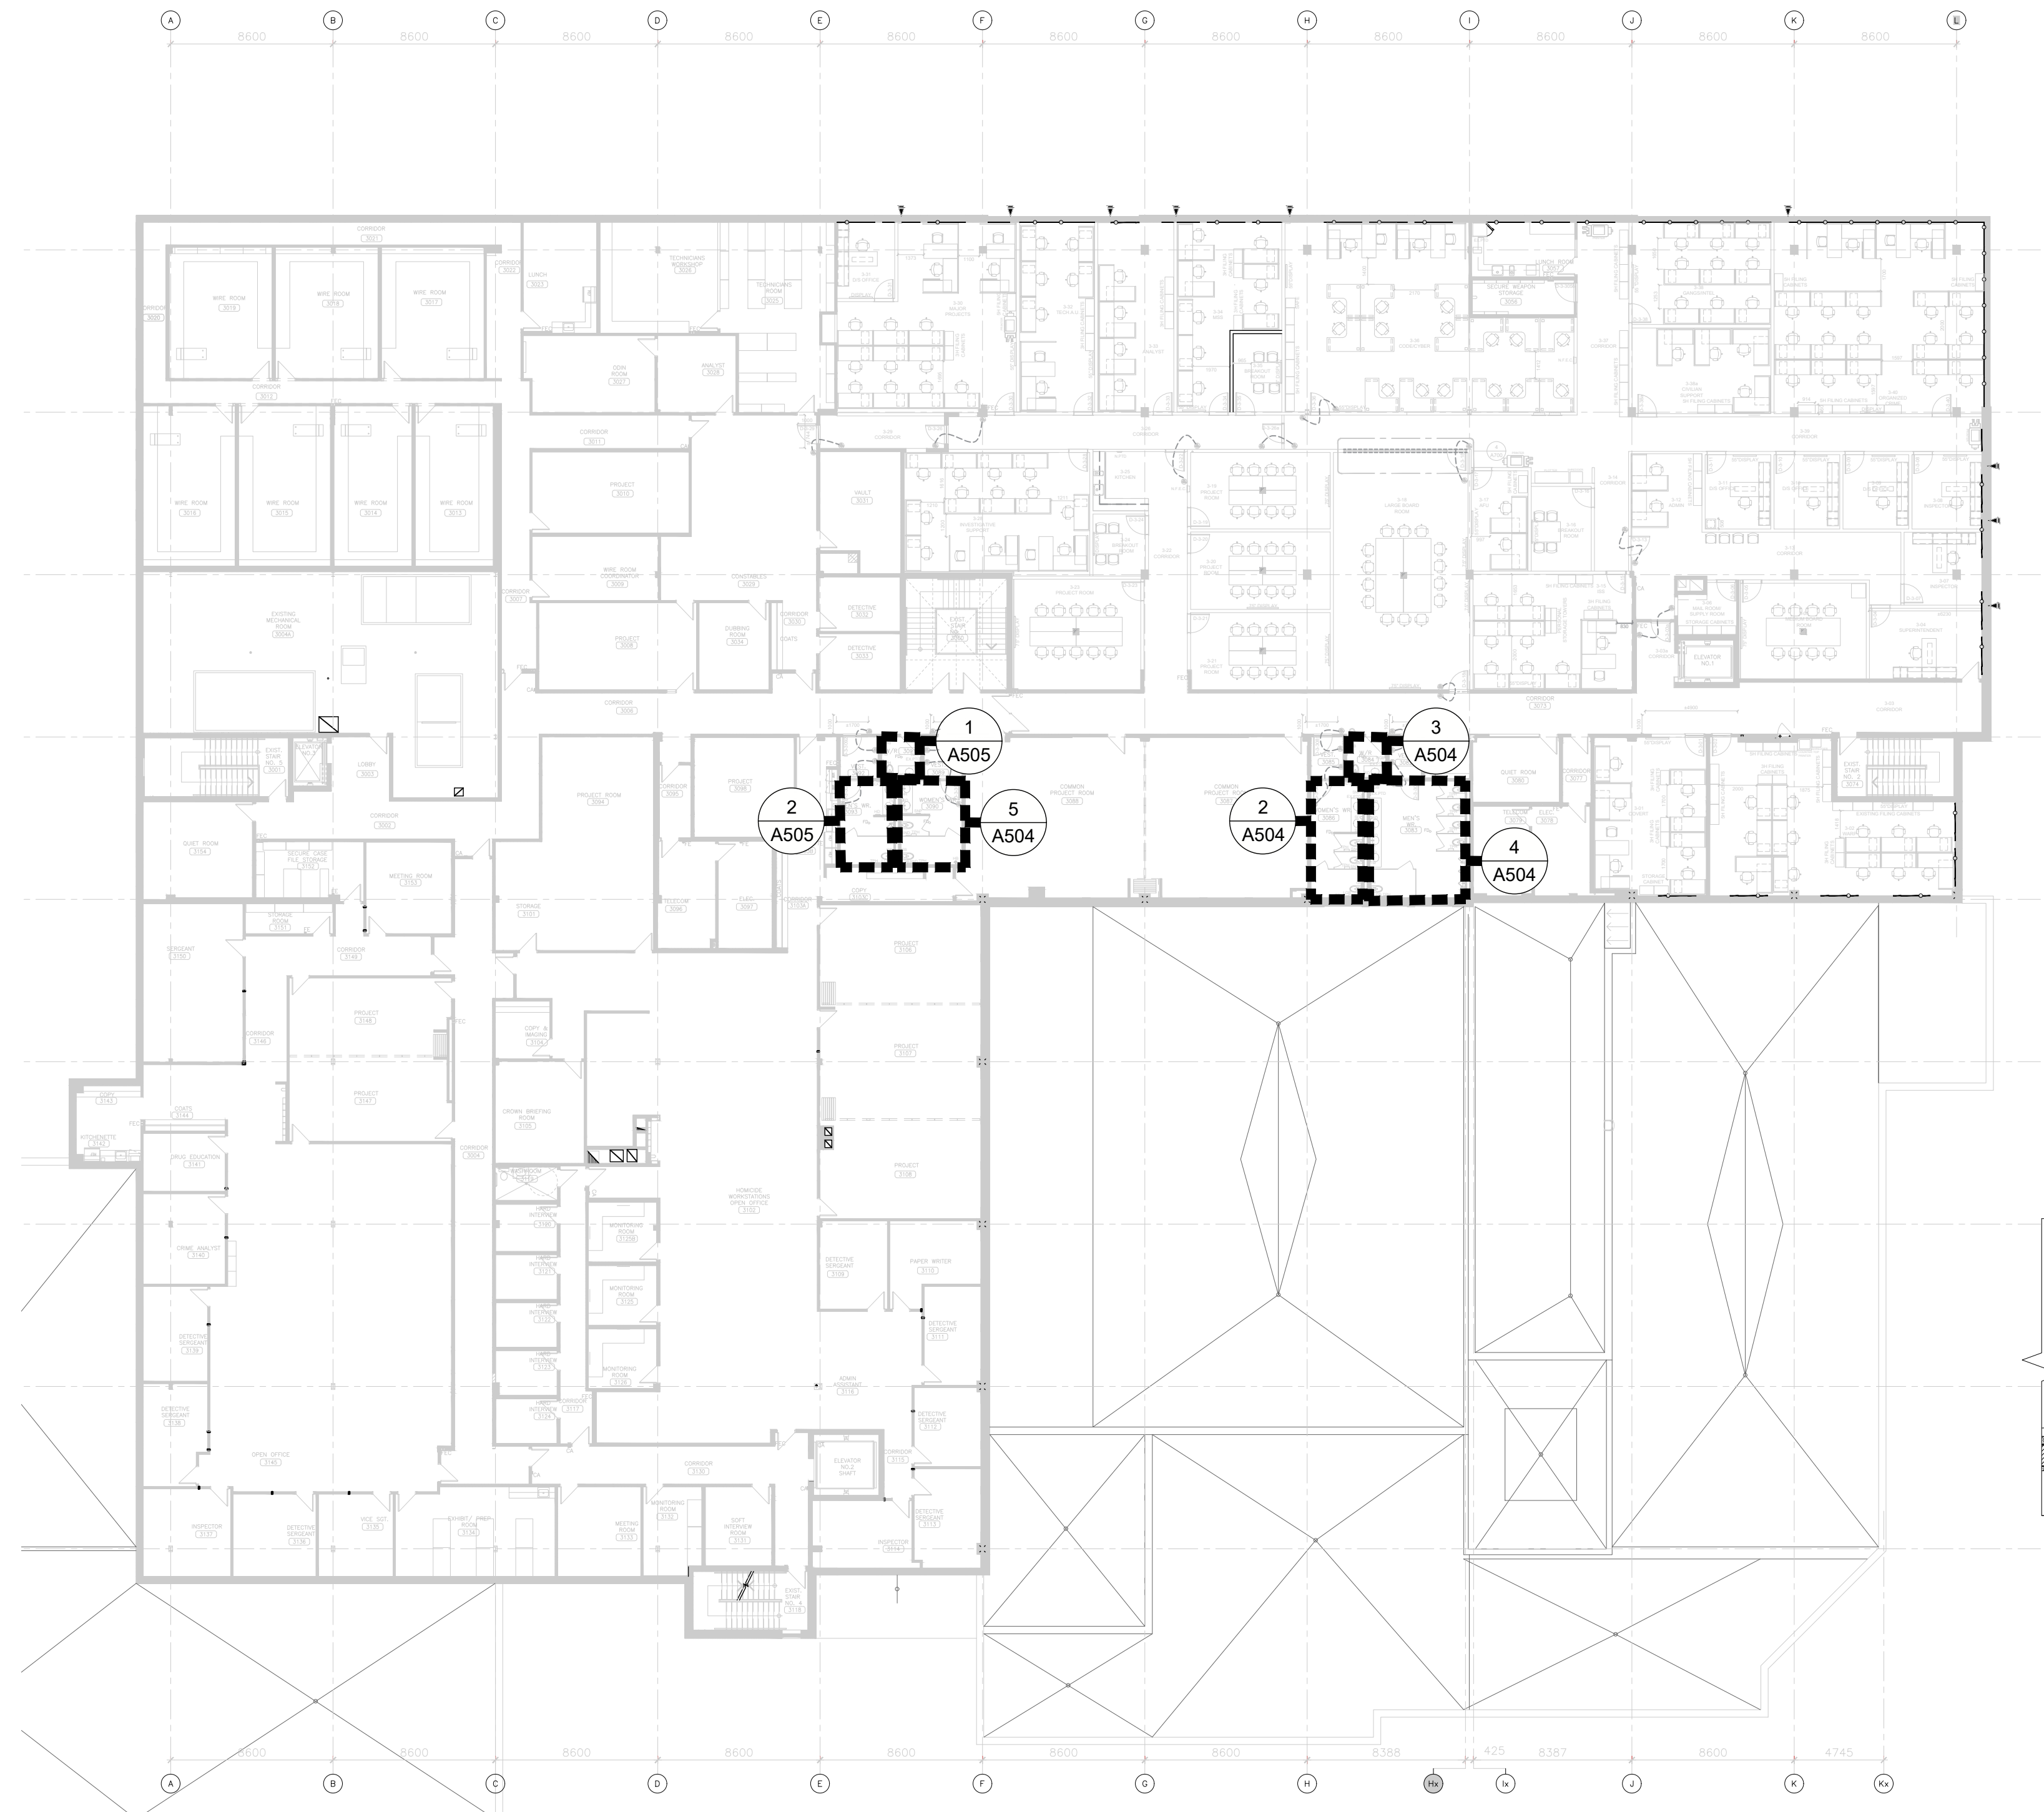


4 INTERIOR ELEVATION KEY PLAN - THIRD FLOOR WASHROOM
SCALE: 1:50



12. ISSUED FOR TENDER	2026.05.01
11. ISSUED FOR BUILDING PERMIT	2026.04.08
10. ISSUED FOR NON-CLIENT REVIEW	2026.03.31
9. ISSUED FOR DESIGN DEVELOPMENT CLIENT REVIEW	2025.10.28
8. ISSUED FOR DESIGN DEVELOPMENT CLIENT REVIEW	2025.10.01
7. ISSUED FOR PRELIMINARY DESIGN CLIENT REVIEW	2025.09.03
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3. ISSUED FOR PRELIMINARY DESIGN CLIENT REVIEW	2025.07.30
2. ISSUED FOR PRELIMINARY DESIGN CLIENT REVIEW	2025.07.25
1. ISSUED FOR PRELIMINARY DESIGN CLIENT REVIEW	2025.07.14
NO. DESCRIPTION	DATE
PROJECT	
PEEL REGIONAL POLICE	
EMIL V. KOLB CENTRE PEEL REGIONAL POLICE FACILITY 181 DERRY ROAD EAST, MISSISSAUGA, ON L5T 2Y5	
NGA ARCHITECTS	
STRUCTURAL CONSULTANT STEPHENSON ENGINEERING WESTON/CORRECTIONAL EXP SERVICES INC. ELECTRICAL CONSULTANT EXP SERVICES INC.	
SHEET TITLE INTERIOR ELEVATIONS - SHOWER/WASHROOM KEY PLANS	
SHEET NO.	DRAWN BY
A500	CC
PROJECT NO.	CHECKED
2520797	RN
SCALE	AS NOTED

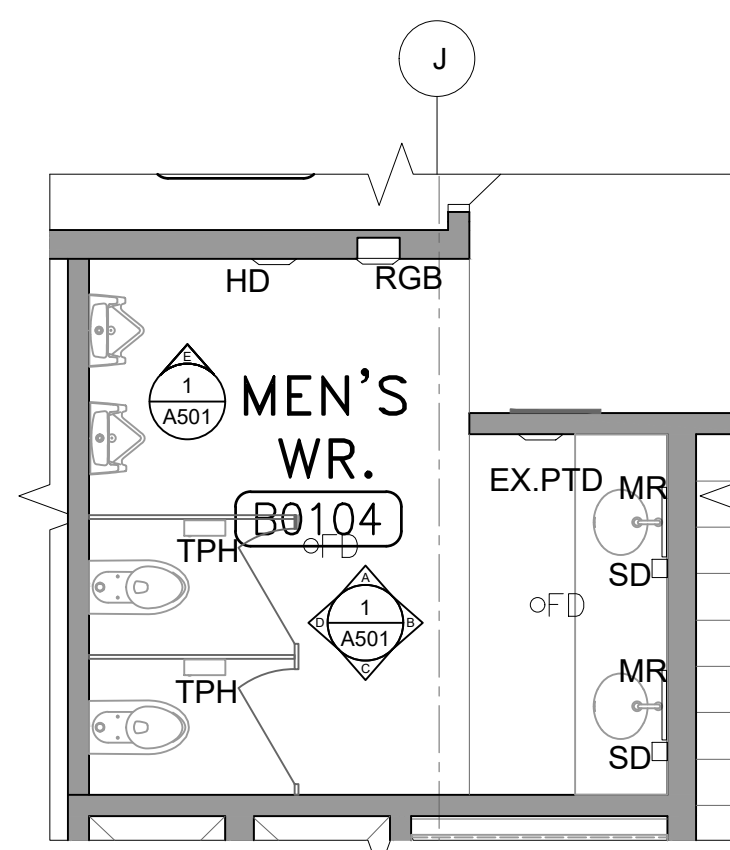



1 INTERIOR ELEVATIONS- BASEMENT FLOOR MEN'S WR. (B0104)
SCALE: 1/50

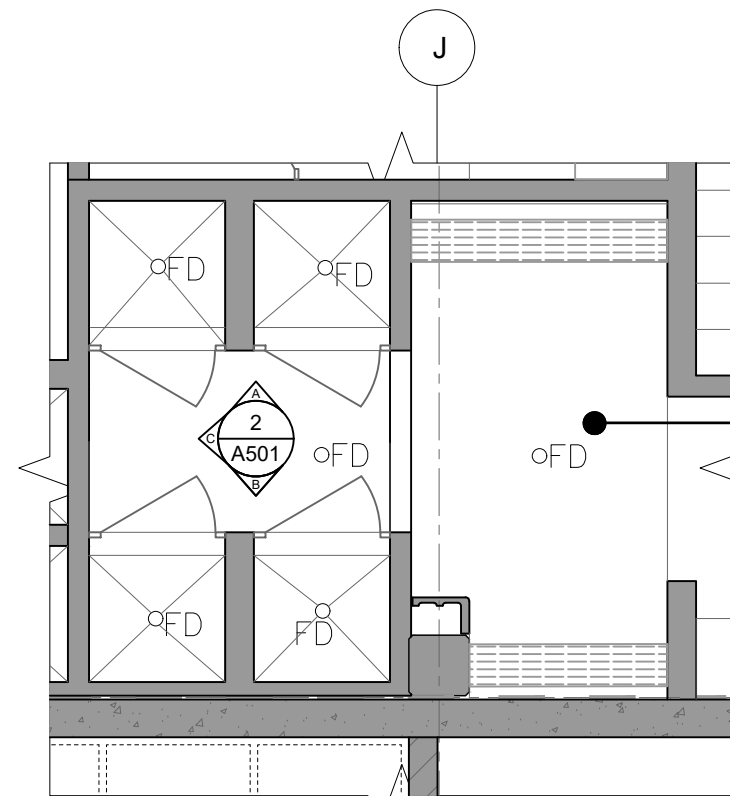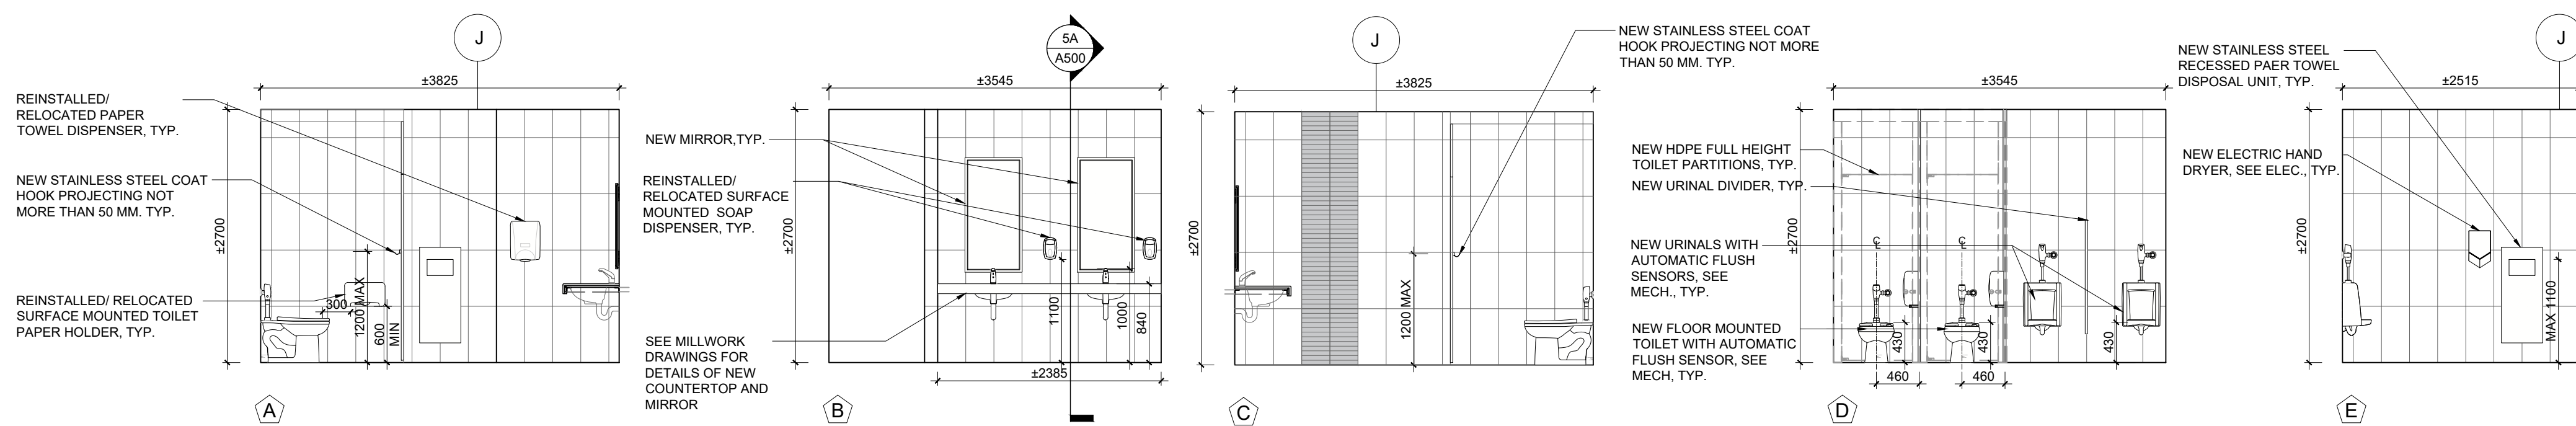



2 INTERIOR ELEVATIONS- BASEMENT FLOOR MEN'S SHOWERS (B0105)
SCALE: 1/50

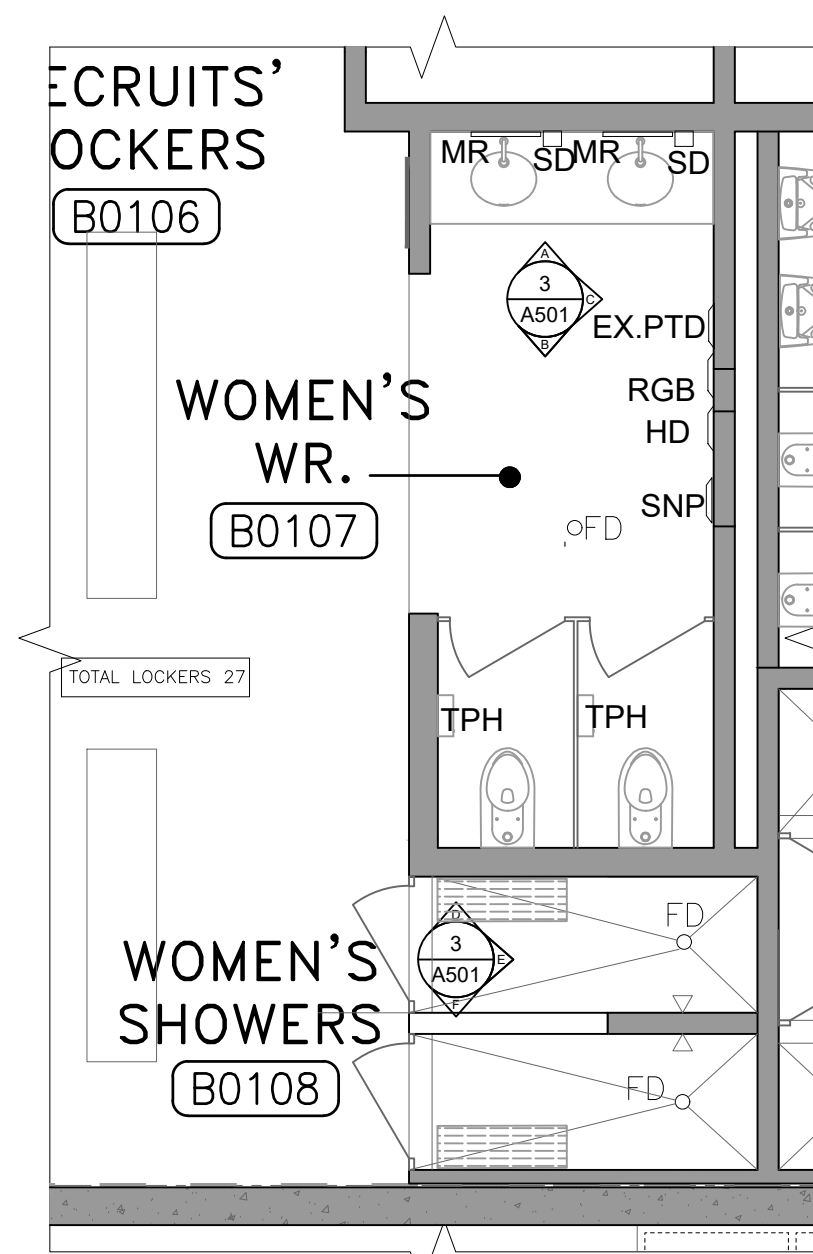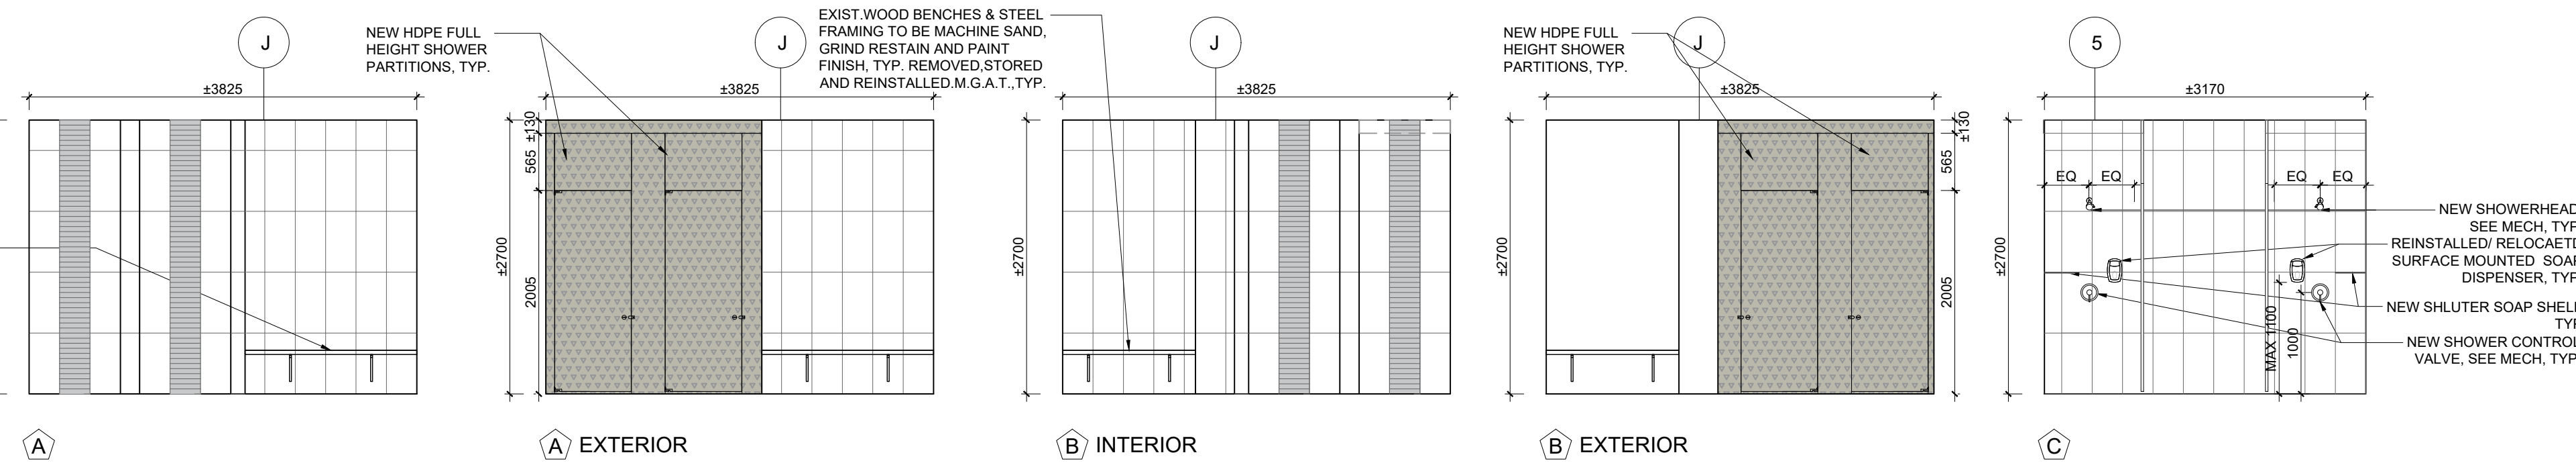


3 INTERIOR ELEVATIONS- BASEMENT FLOOR WOMEN'S WR. (B0107), WOMEN'S SHOWERS (B0108)
SCALE: 1/50

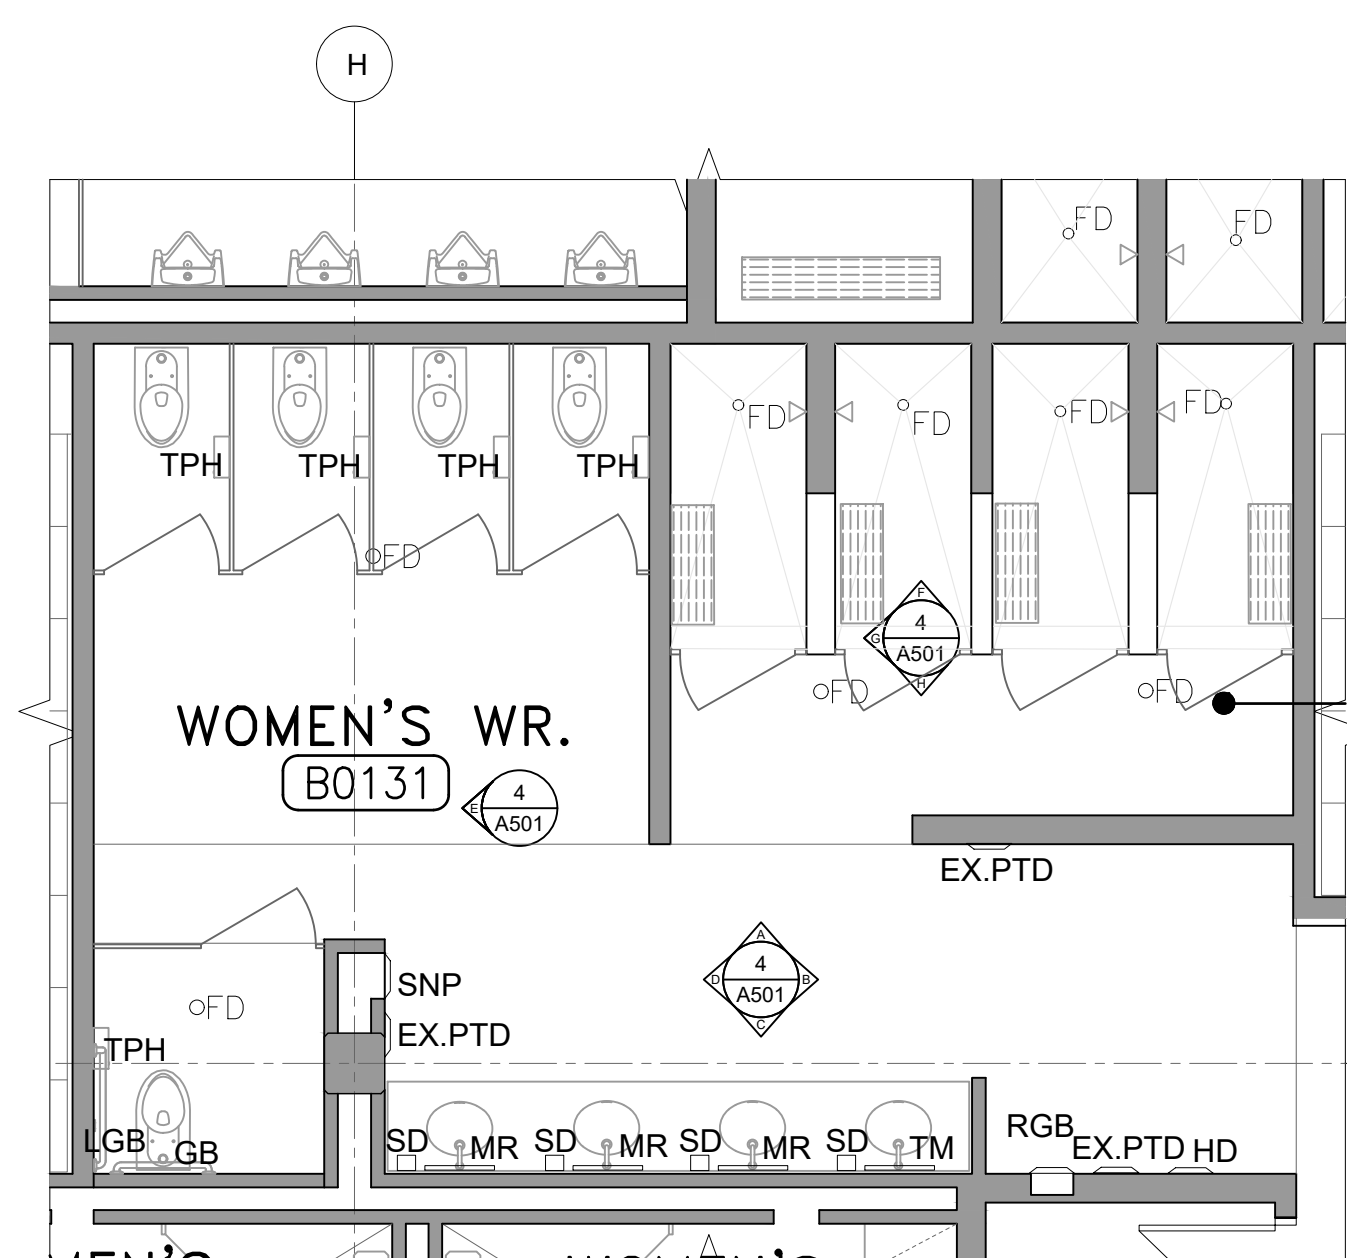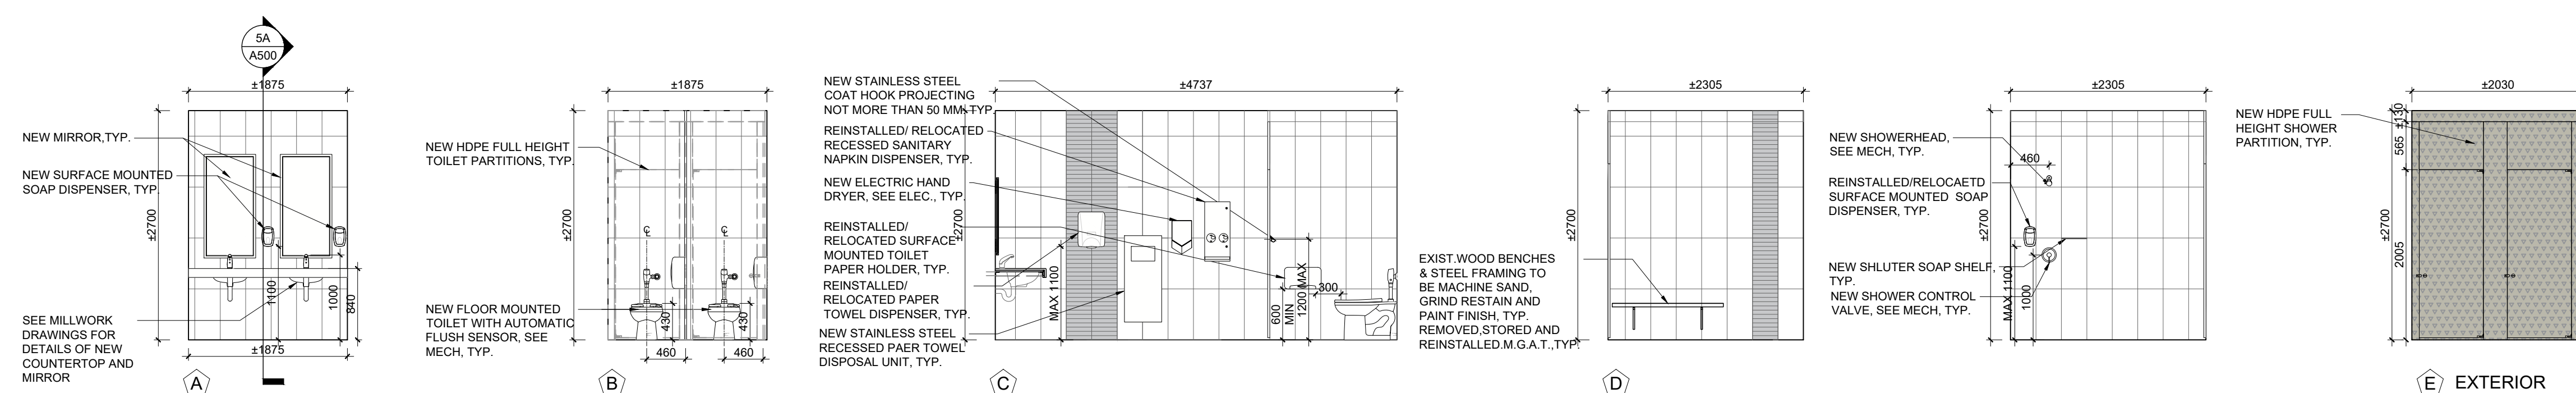

4 INTERIOR ELEVATIONS- BASEMENT FLOOR WOMEN'S WR. (B0131), WOMEN'S SHOWERS (B0132)
SCALE: 1/50

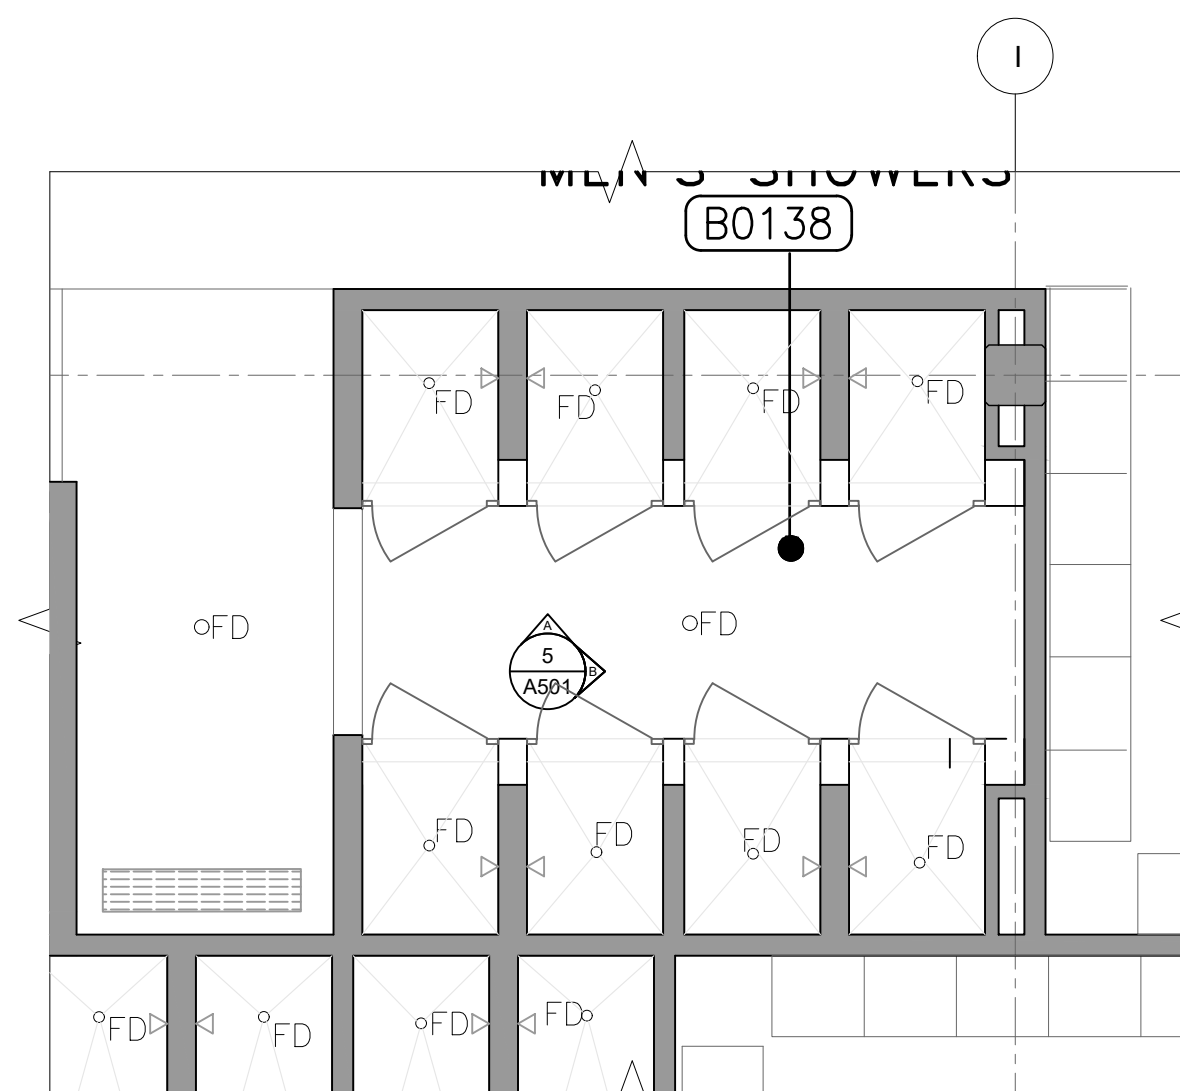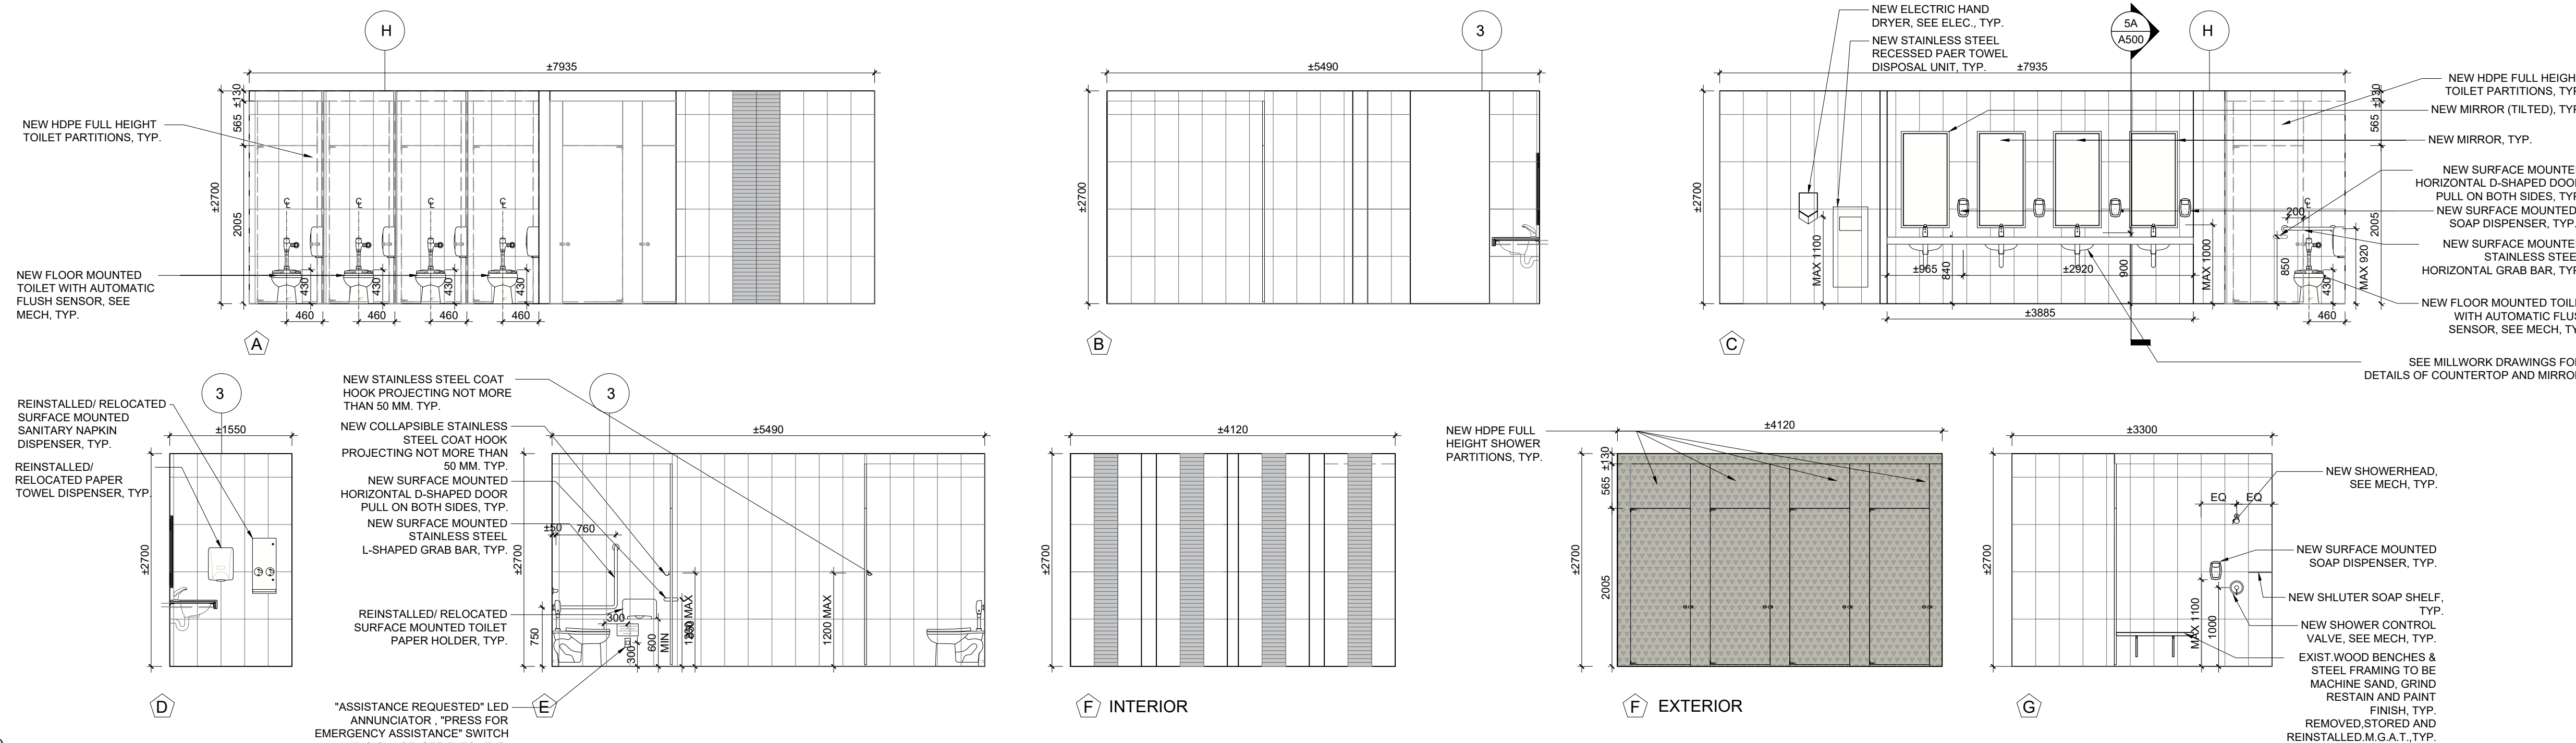


5 INTERIOR ELEVATIONS- BASEMENT FLOOR MEN'S SHOWERS (B0138)
SCALE: 1/50

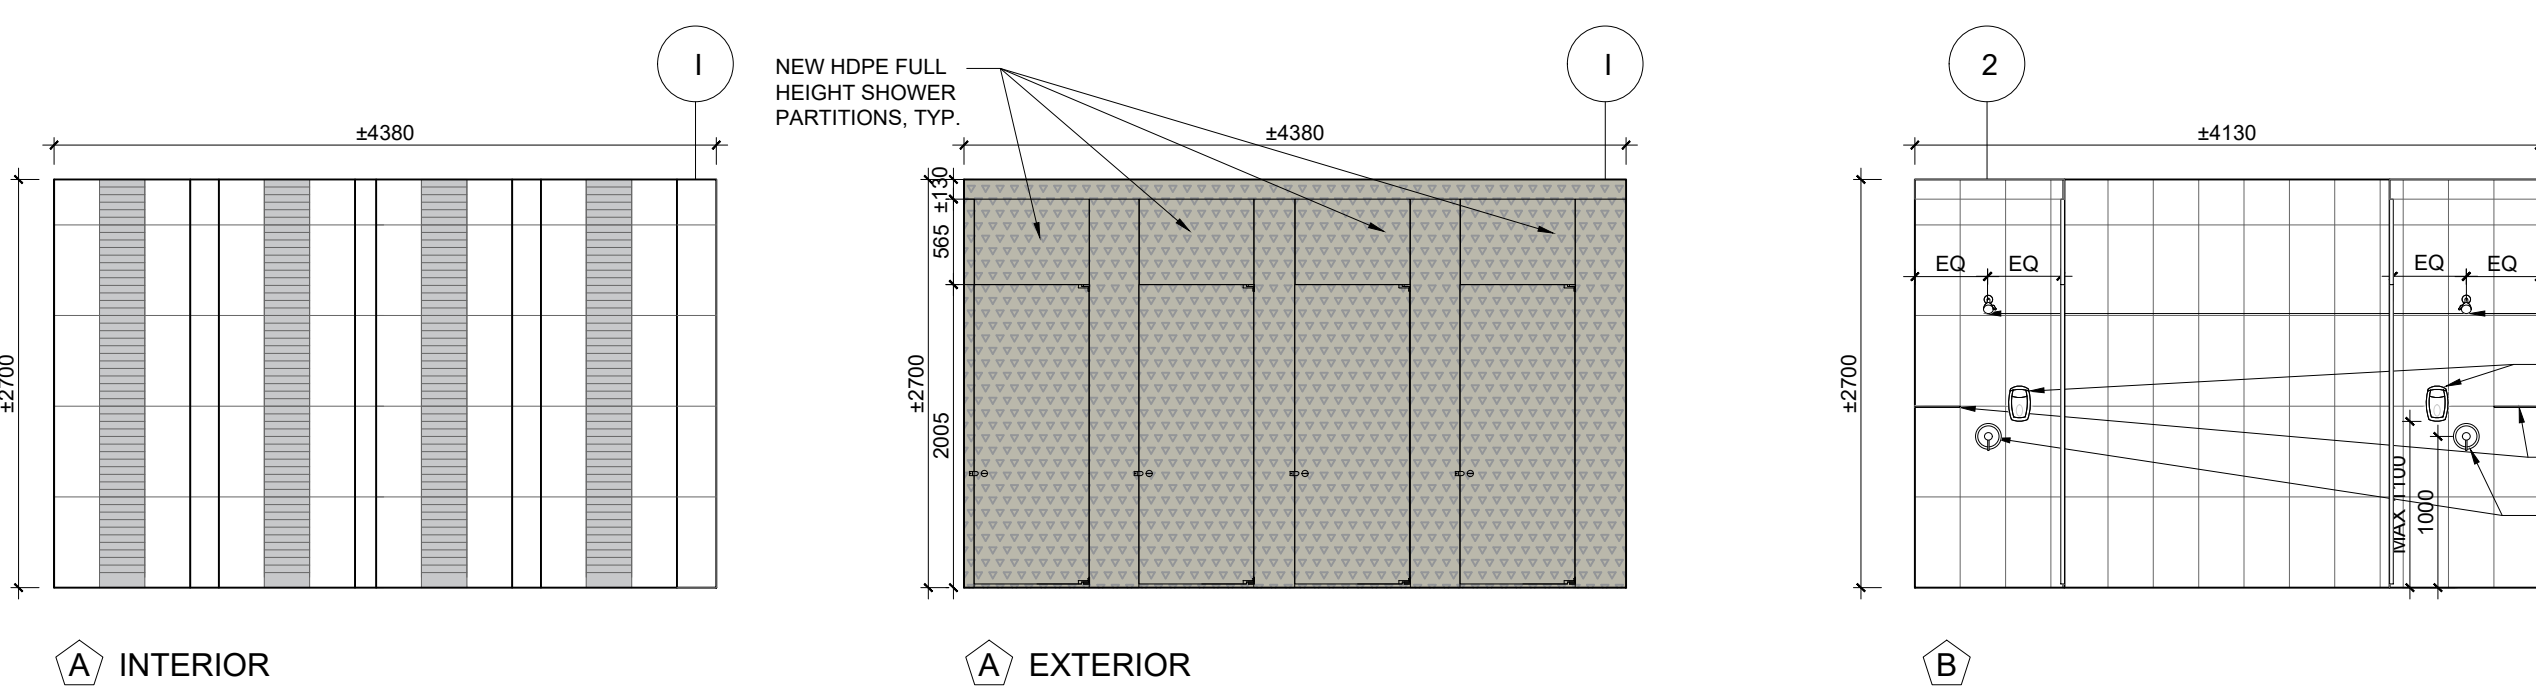


INTERIOR ELEVATIONS LEGEND	
	POR1: 305mm x 610mm PORCELAIN WALL TILE
	GLA1: 300mm x 50mm GLASS TILE, STACK-BOND
	GLA2: 300mm x 50mm GLASS TILE, STACK-BOND
	NEW HOPE FULL HEIGHT SHOWER PARTITIONS, TYP.
EX.	EXISTING
N.I.C.	NOT IN CONTRACT
TYP.	TYPICAL
INTERIOR ELEVATIONS NOTES	
1. MECHANICAL ACCESS HATCH FOR WASHROOMS AND SHOWER ROOMS NOT TO BE INSTALLED ON THE FEATURE WALL. GC TO COORDINATE WITH MECHANICAL SUBCONTRACTOR AND INFORM THE ARCHITECT. GC TO RECEIVE THE APPROVAL FROM THE ARCHITECT REGARDING THE LOCATION OF THE ACCESS HATCH BEFORE STARTING ANY MECHANICAL WORK.	
2. GC IS RESPONSIBLE TO SUPPLY & INSTALL ±18 SOAP/SHAMPOO SHELVES BY SCHLUTER SYSTEMS TO ALL SHOWERS, TYP.	


12. ISSUED FOR TENDER	2026.05.01
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3. ISSUED FOR PRELIMINARY DESIGN CLIENT REVIEW	2025.07.30
2. ISSUED FOR PRELIMINARY DESIGN CLIENT REVIEW	2025.07.25
1. ISSUED FOR PRELIMINARY DESIGN CLIENT REVIEW	2025.07.14
NO. DESCRIPTION	DATE
REVISIONS	
PROJECT	
REGION OF PEEL	
EMIL V. KOLB CENTRE PEEL REGIONAL POLICE FACILITY INTERIOR RENOVATION PROJECT 181 DERRY ROAD EAST, MISSISSAUGA, ON L5T 2Y5	
The contractor shall check and verify all dimensions and report to the architect any discrepancies. The architect shall be responsible for providing accurate and complete information to the contractor. The contractor shall be responsible for providing accurate and complete information to the building official.	
This drawing shall not be used for construction purposes until it has been approved by the architect. The architect shall be responsible for providing accurate and complete information to the contractor. The contractor shall be responsible for providing accurate and complete information to the building official.	
SHEET TITLE INTERIOR ELEVATIONS- BASEMENT FLOOR WASHROOM / SHOWER	
SHEET NO. A501	
DRAWN BY CC	
CHECKED BY RN	
PROJECT NO. 2520797	
SCALE AS NOTED	

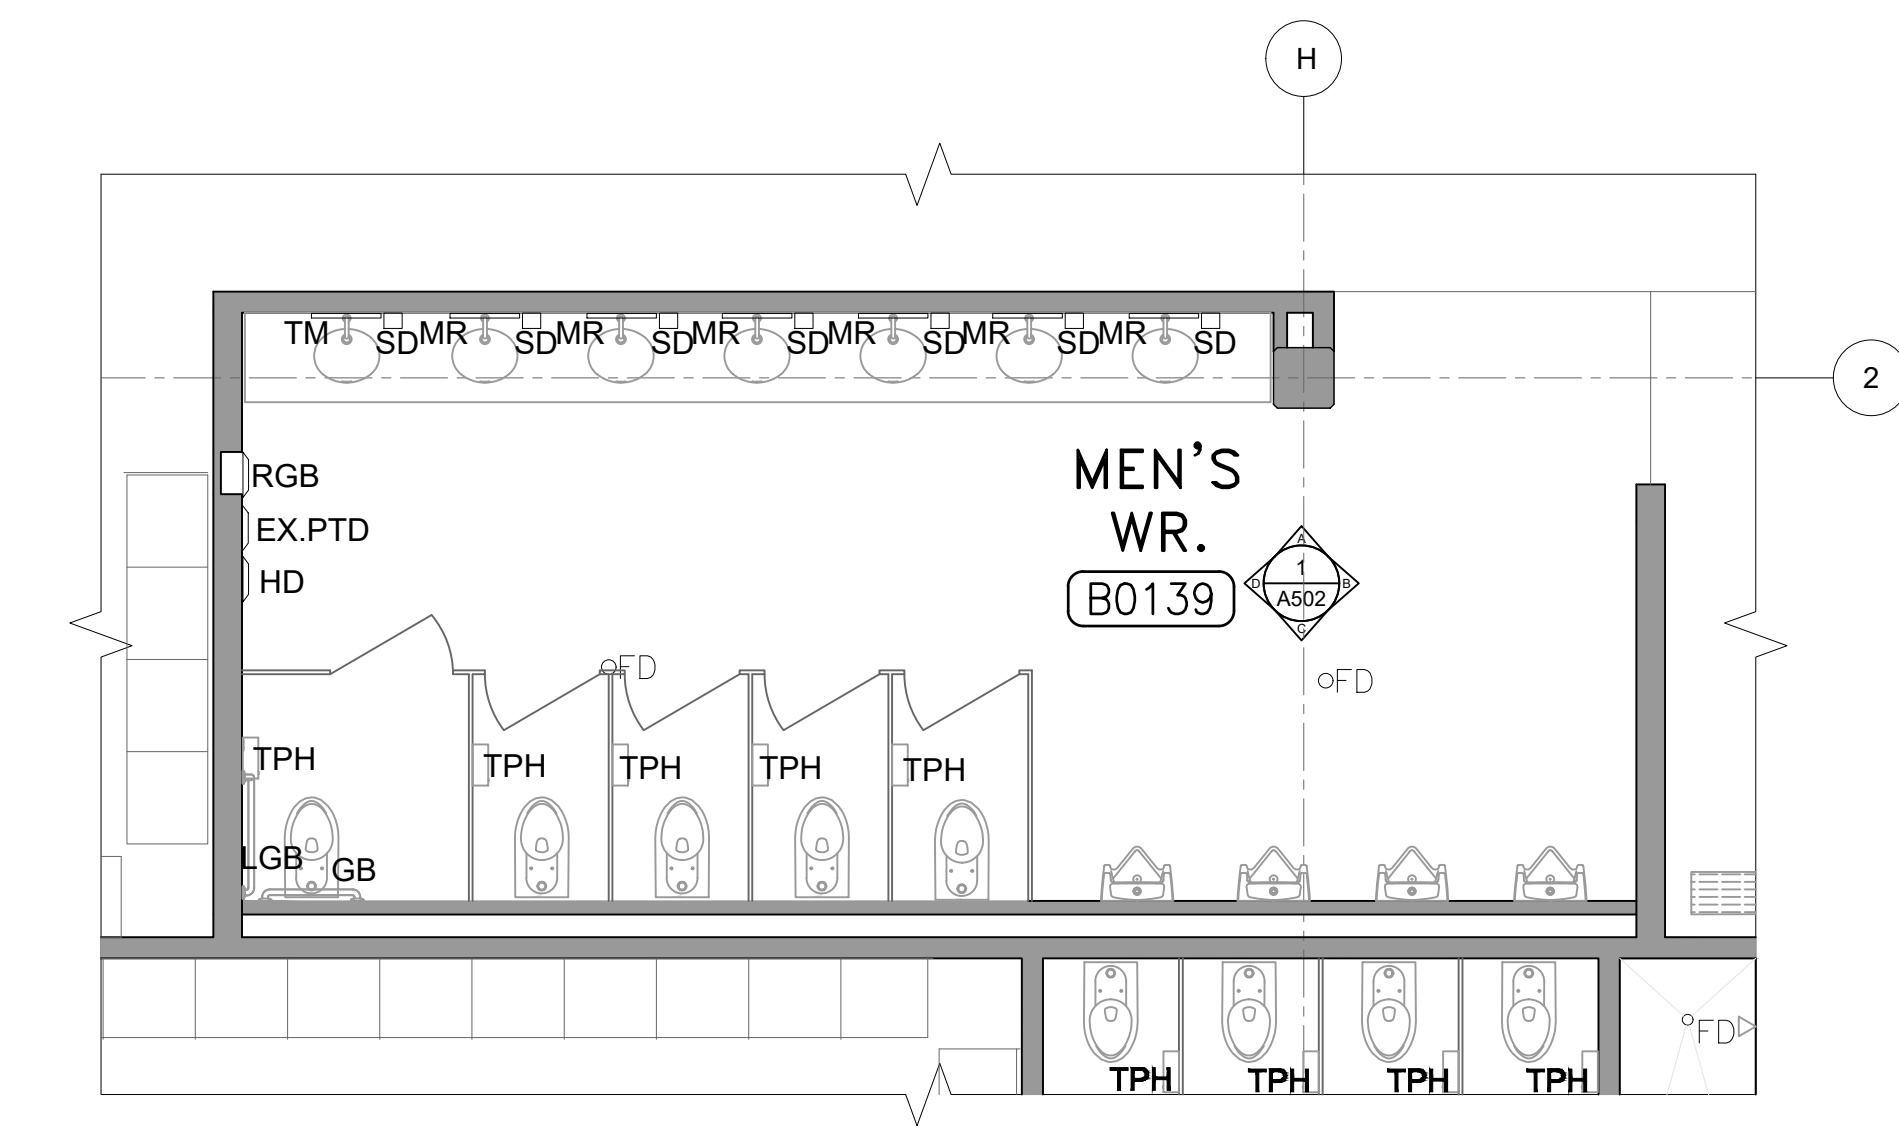


1
A502 INTERIOR ELEVATIONS- BASEMENT FLOOR MEN'S WR. (B0139)
SCALE: 1/32

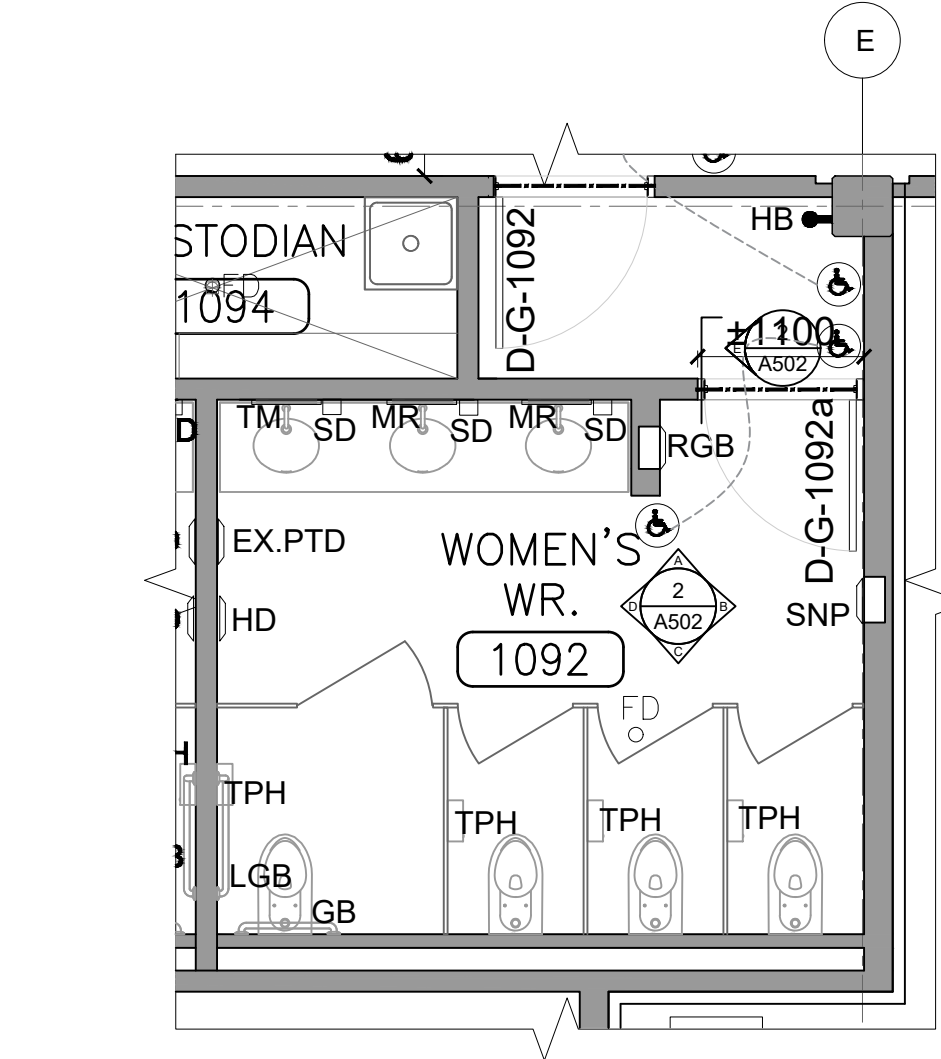


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A502 INTERIOR ELEVATIONS- GROUND FLOOR WOMEN'S WR. (1092)
SCALE: 1/32

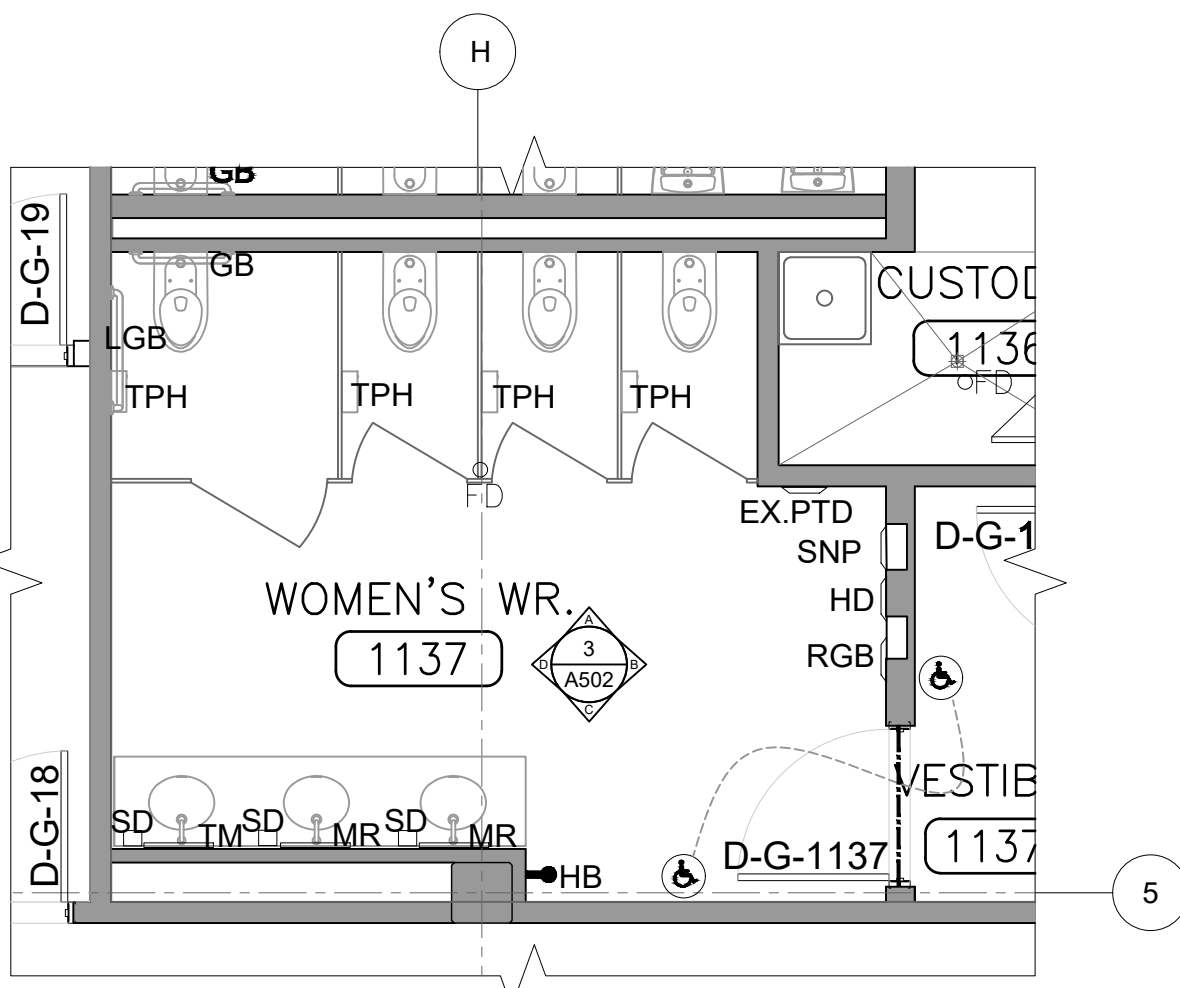
















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A502 INTERIOR ELEVATIONS- GROUND FLOOR WOMEN'S WR. (1137)
SCALE: 1/32

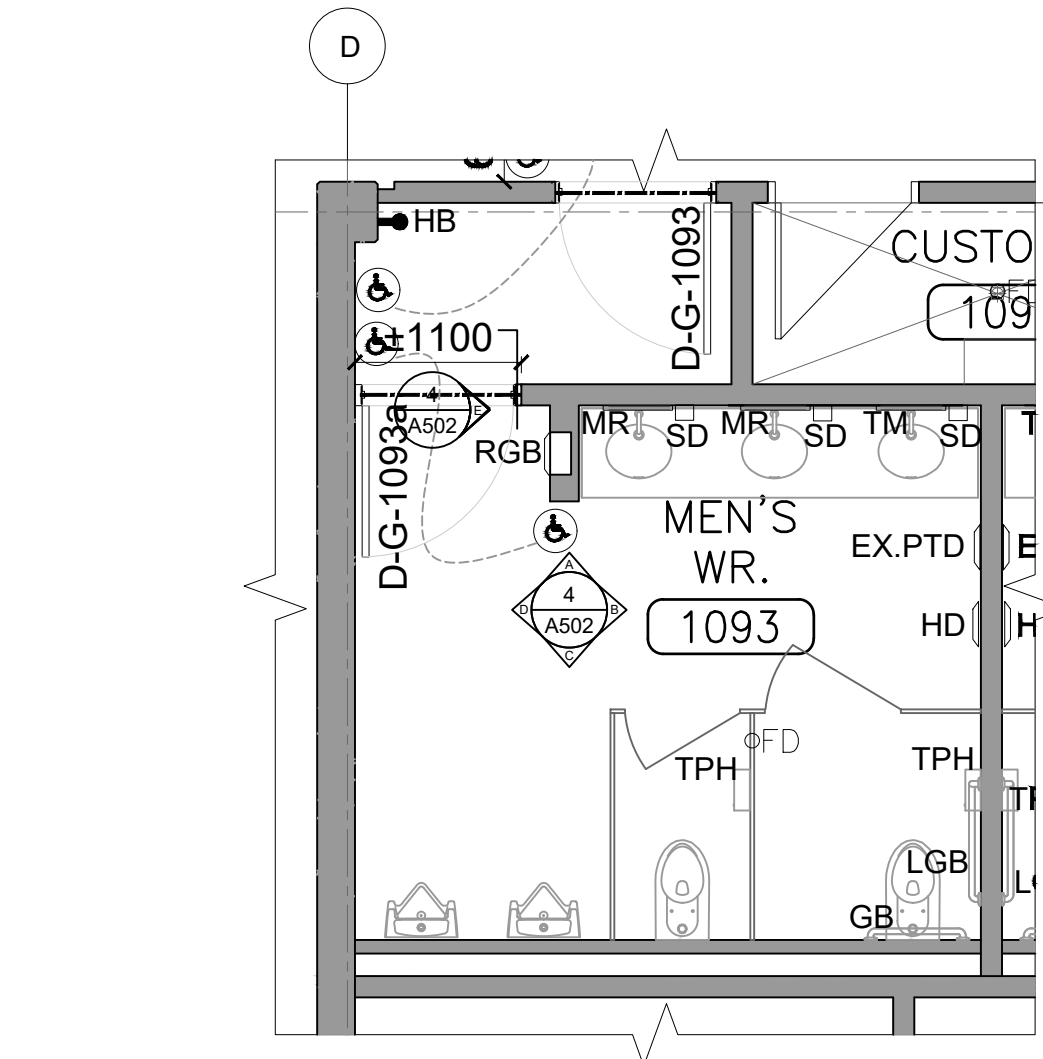

4
A502 INTERIOR ELEVATIONS- GROUND FLOOR MEN'S WR. (1093)
SCALE: 1/32

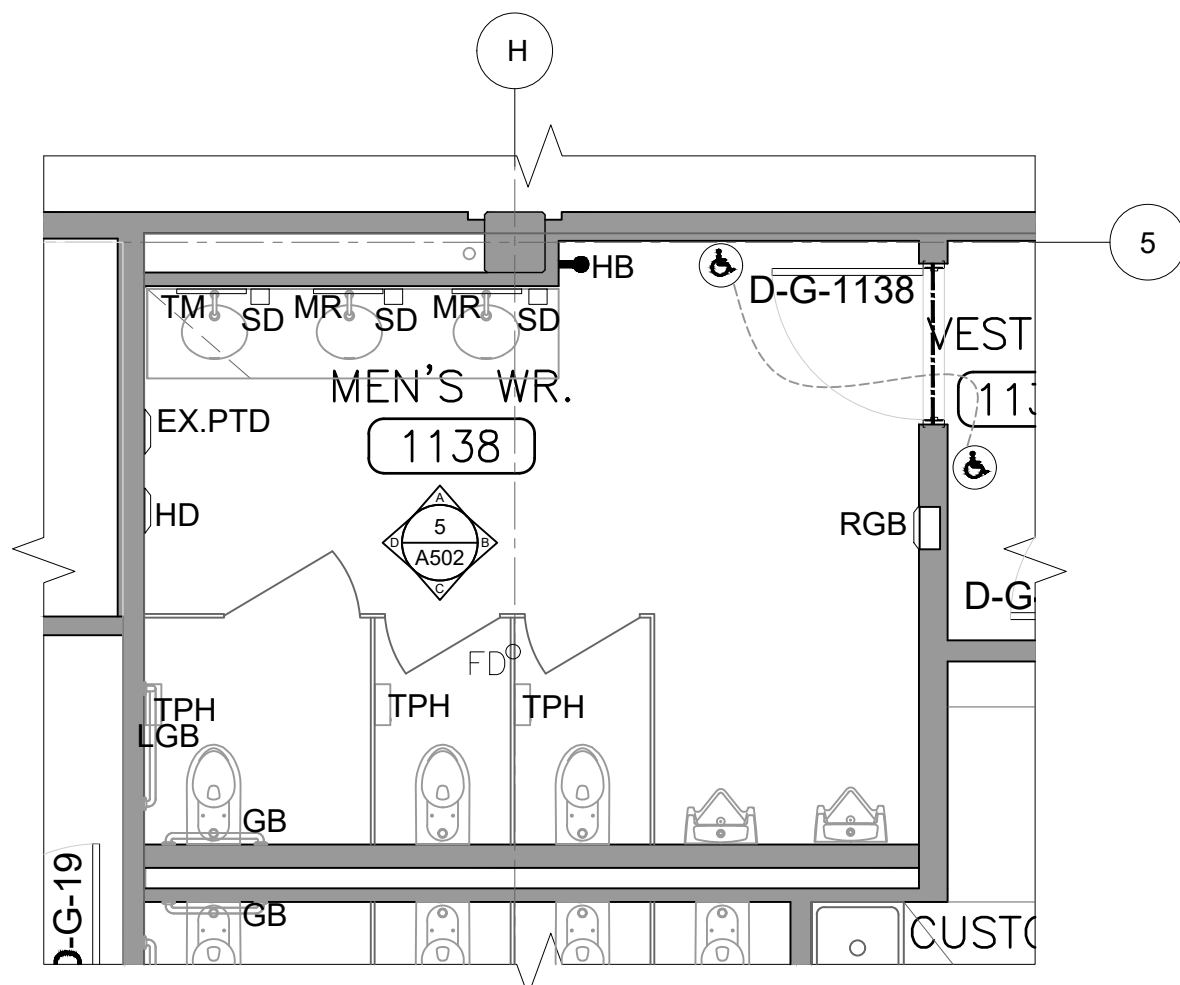


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A502 INTERIOR ELEVATIONS- GROUND FLOOR MEN'S WR. (1138)
SCALE: 1/32

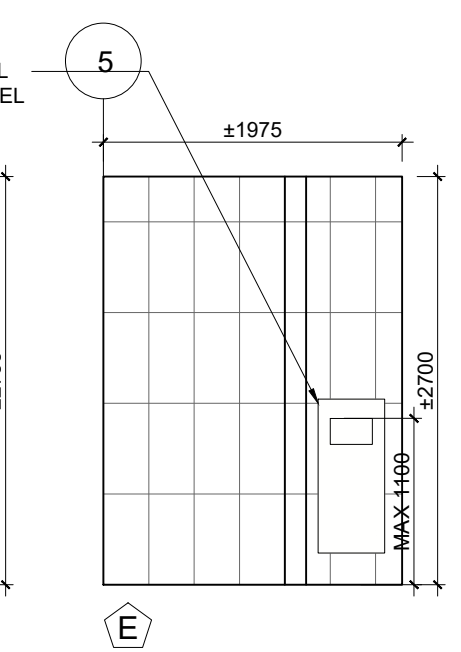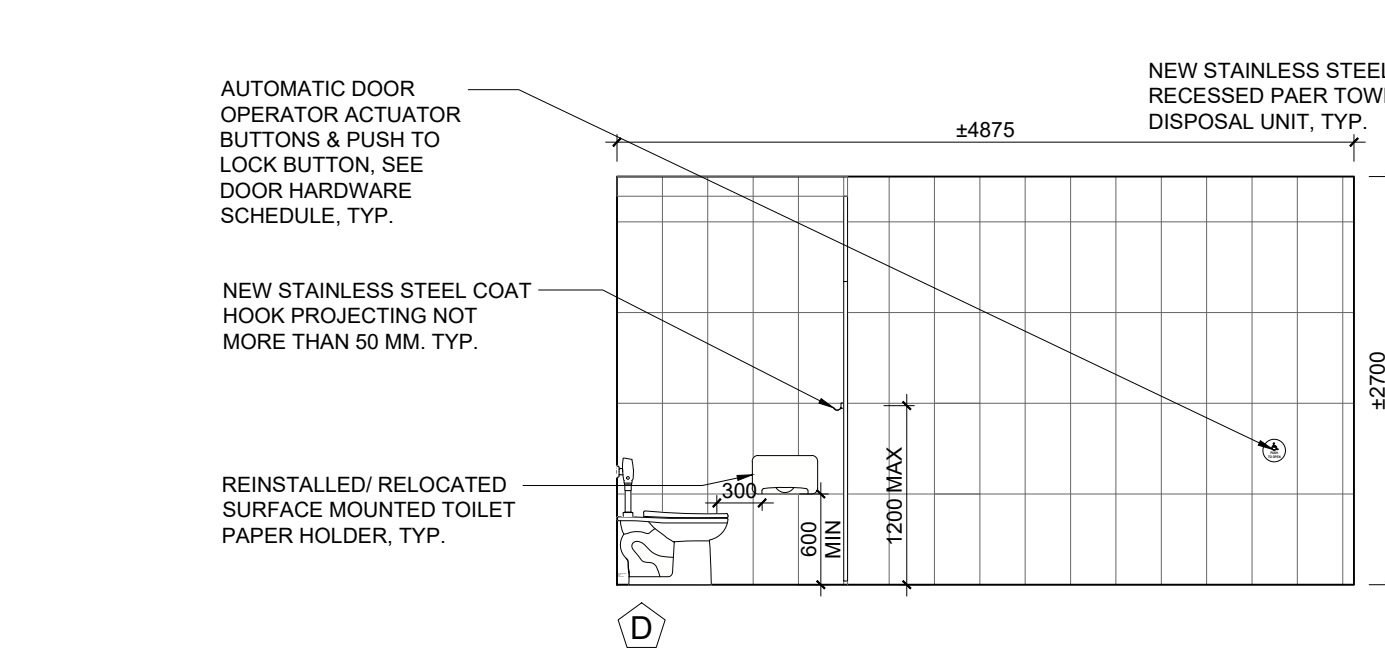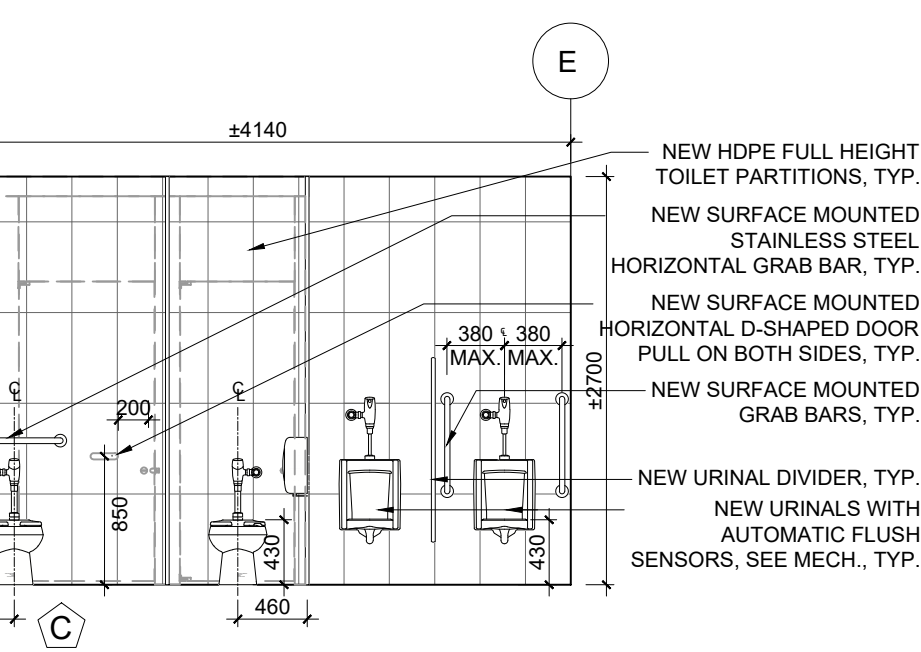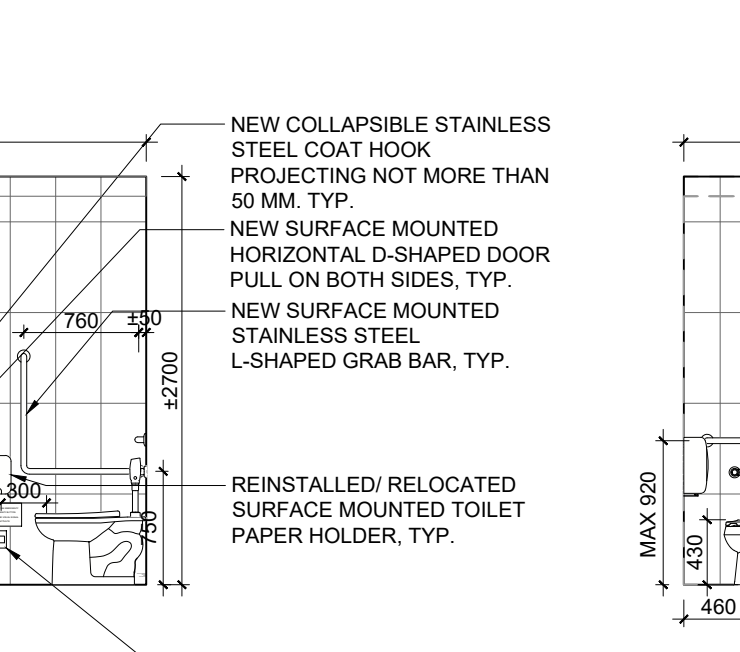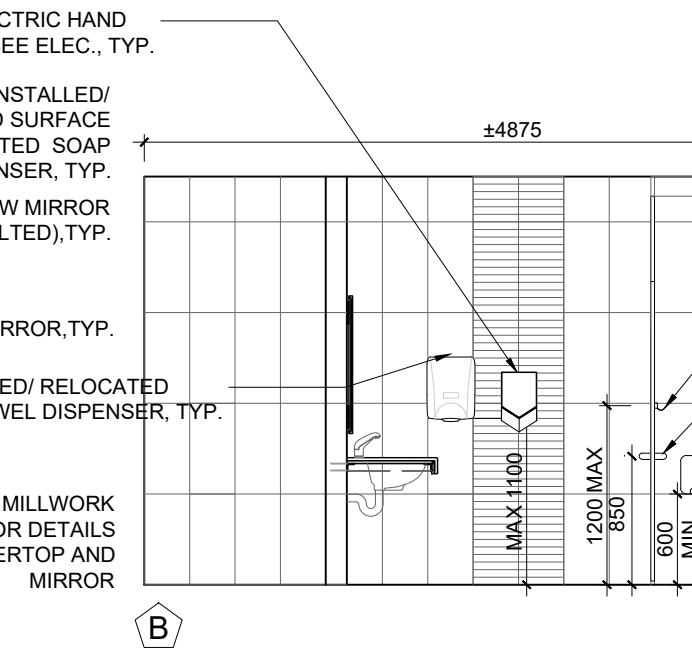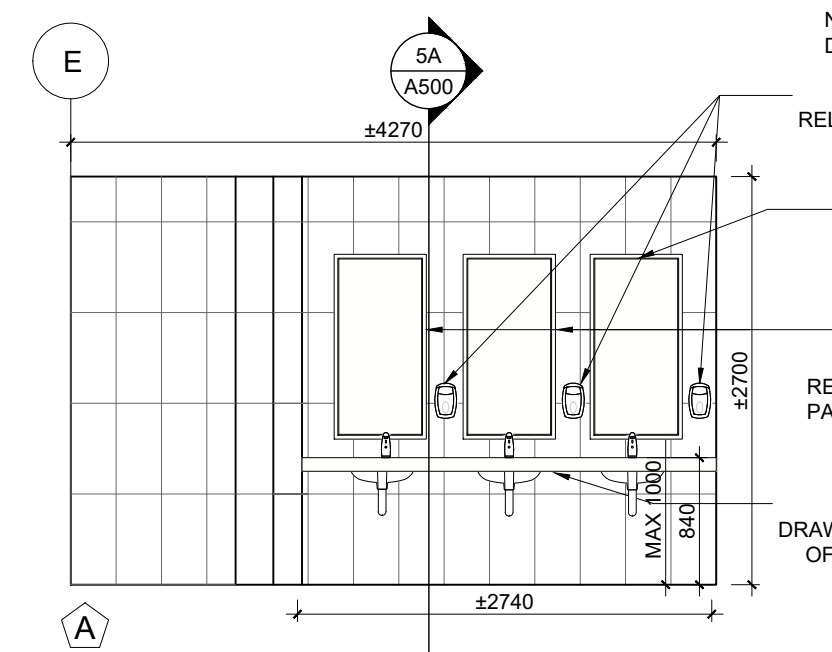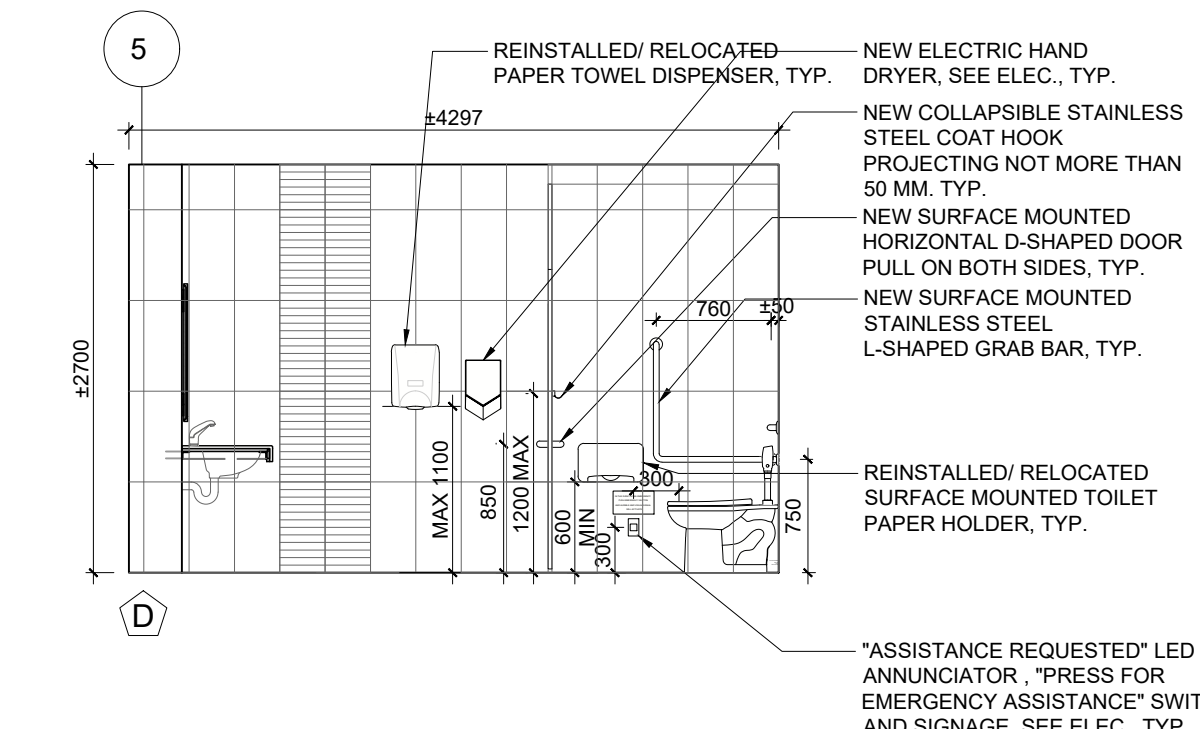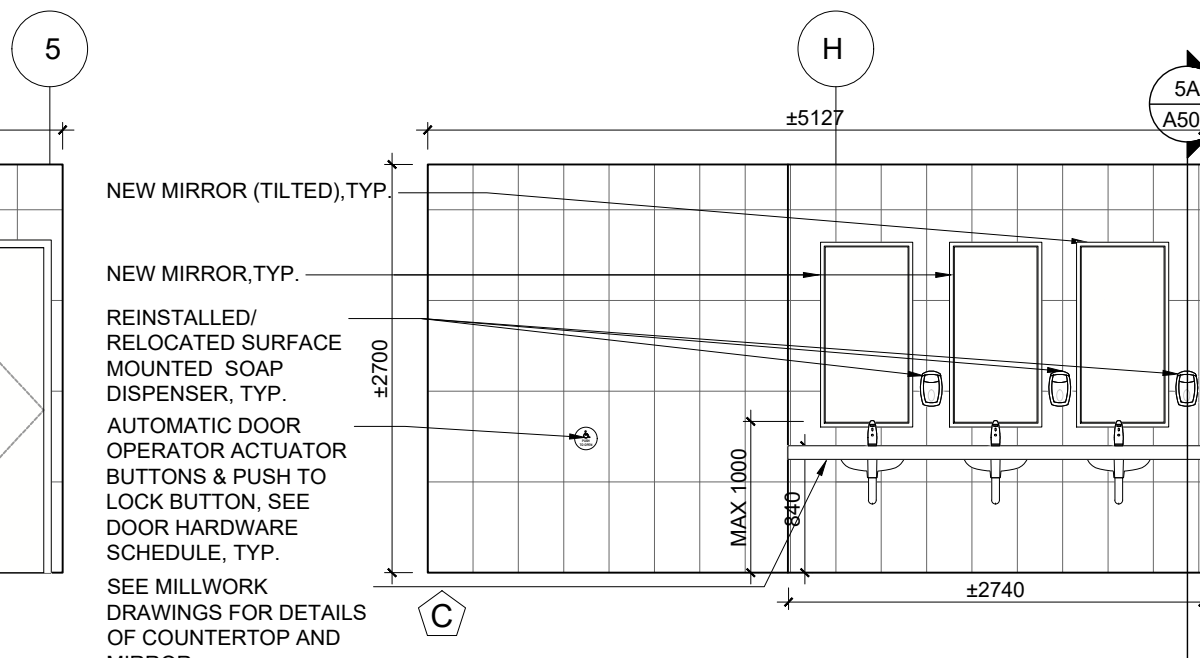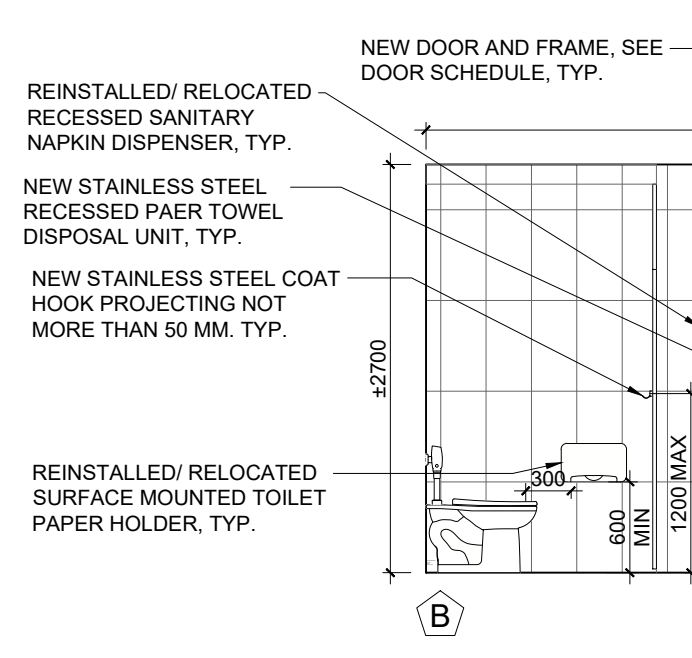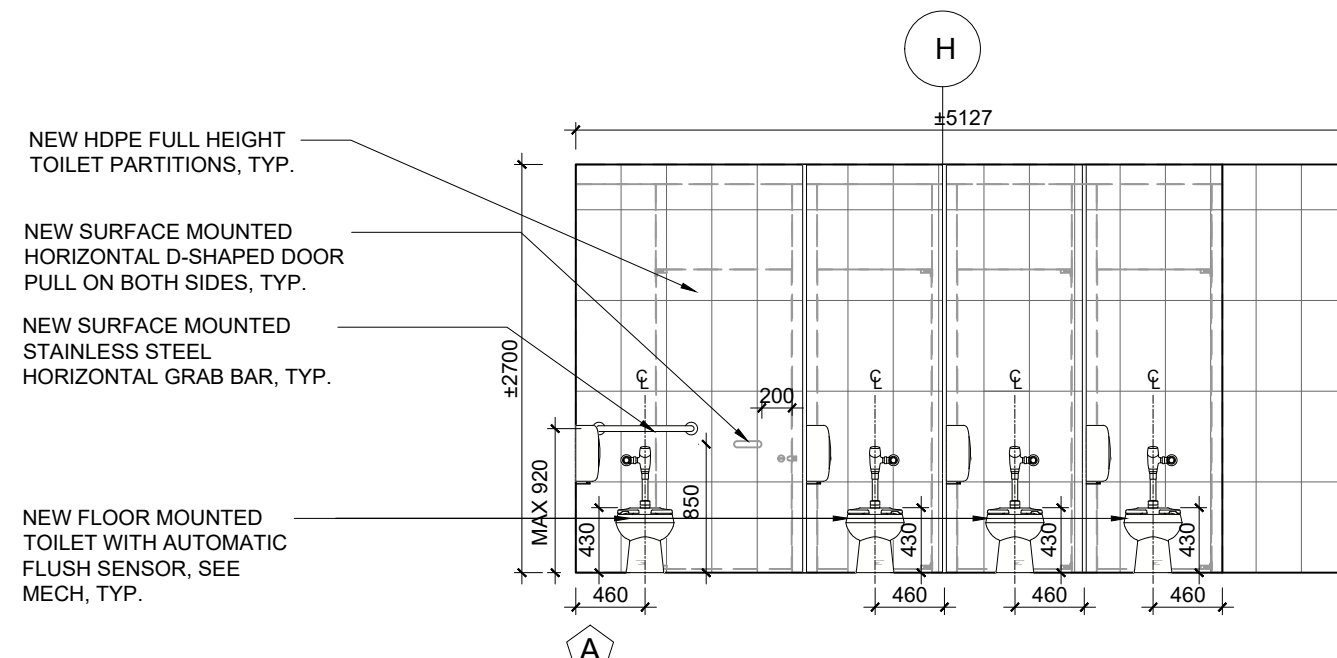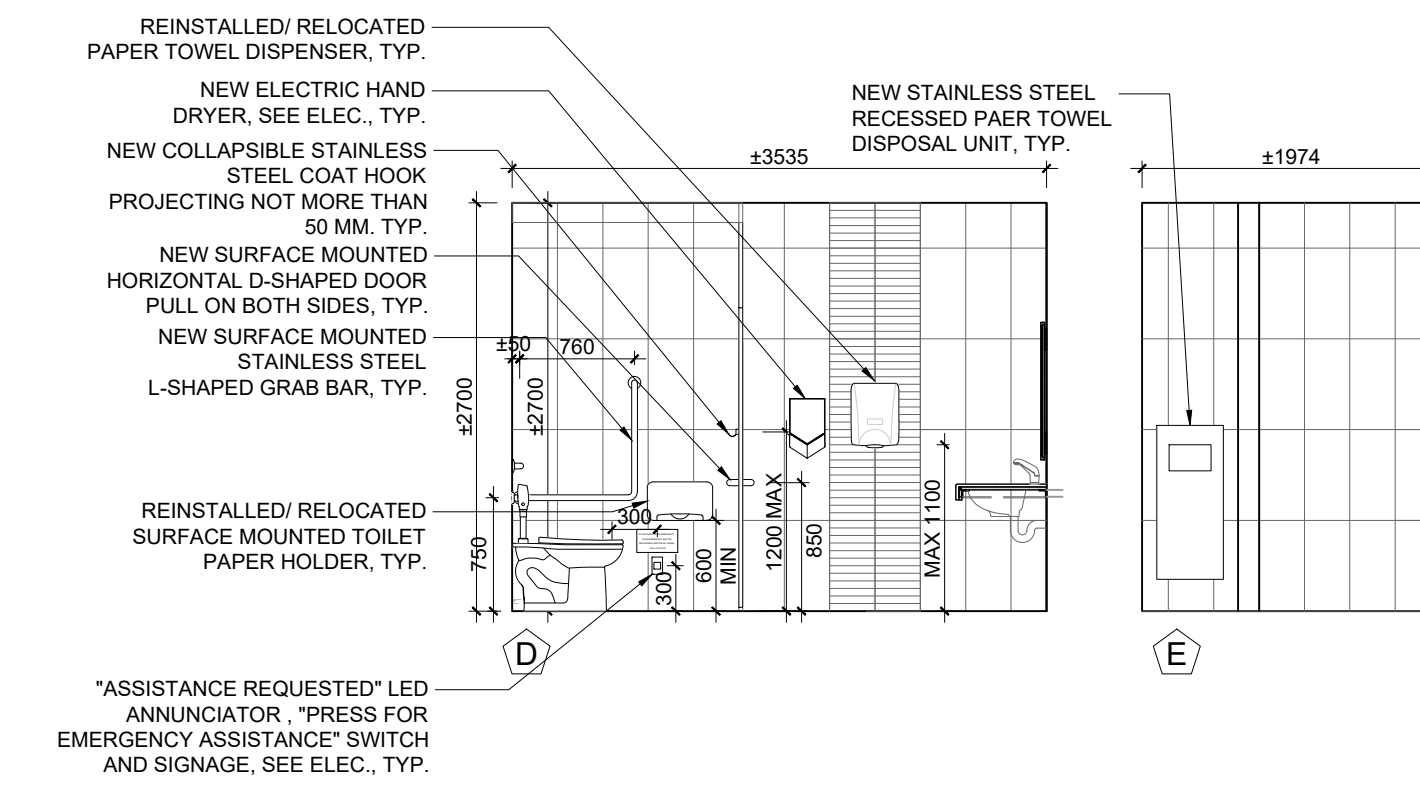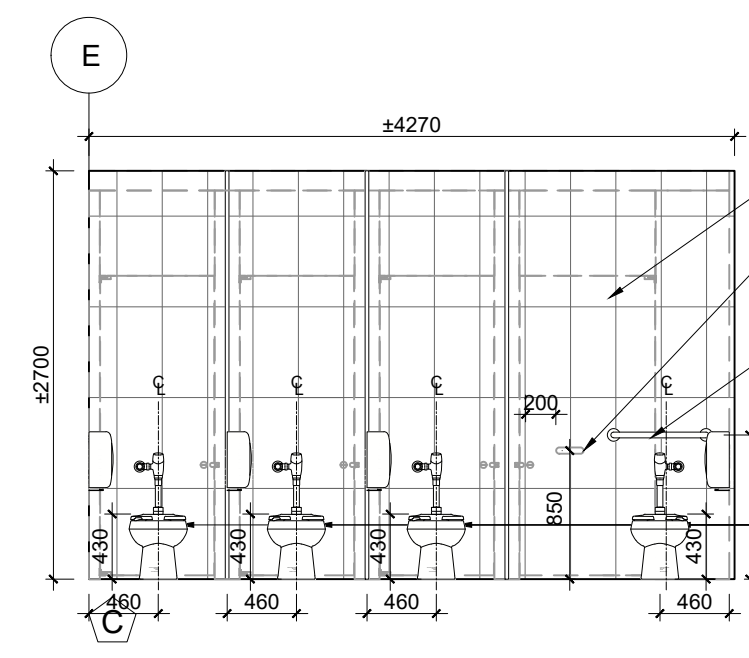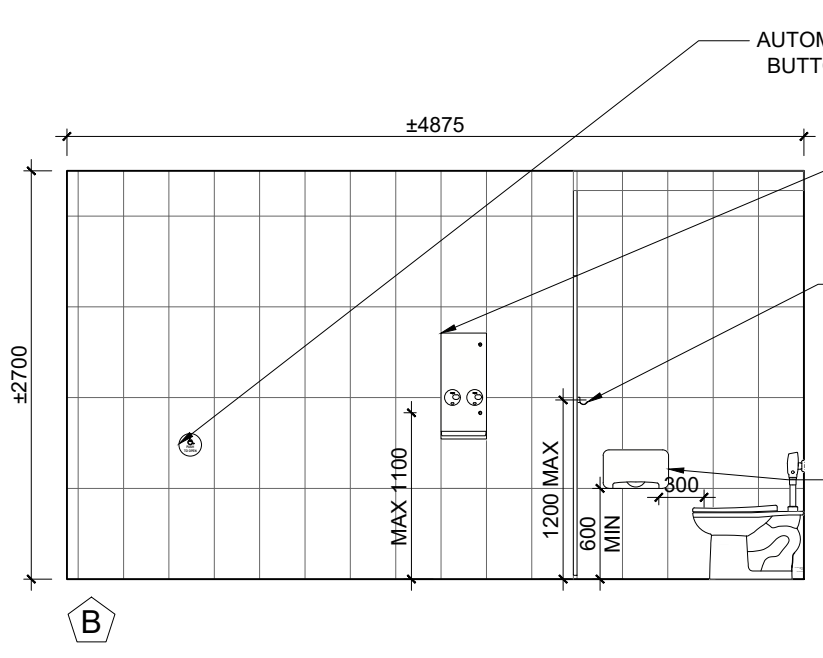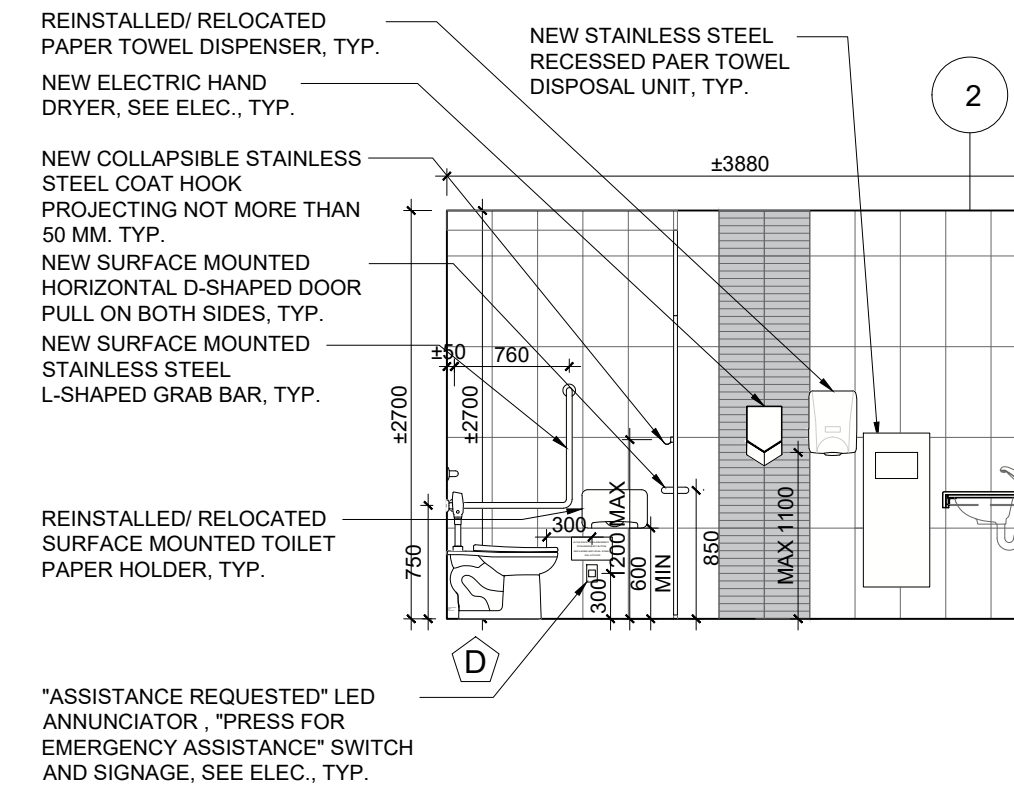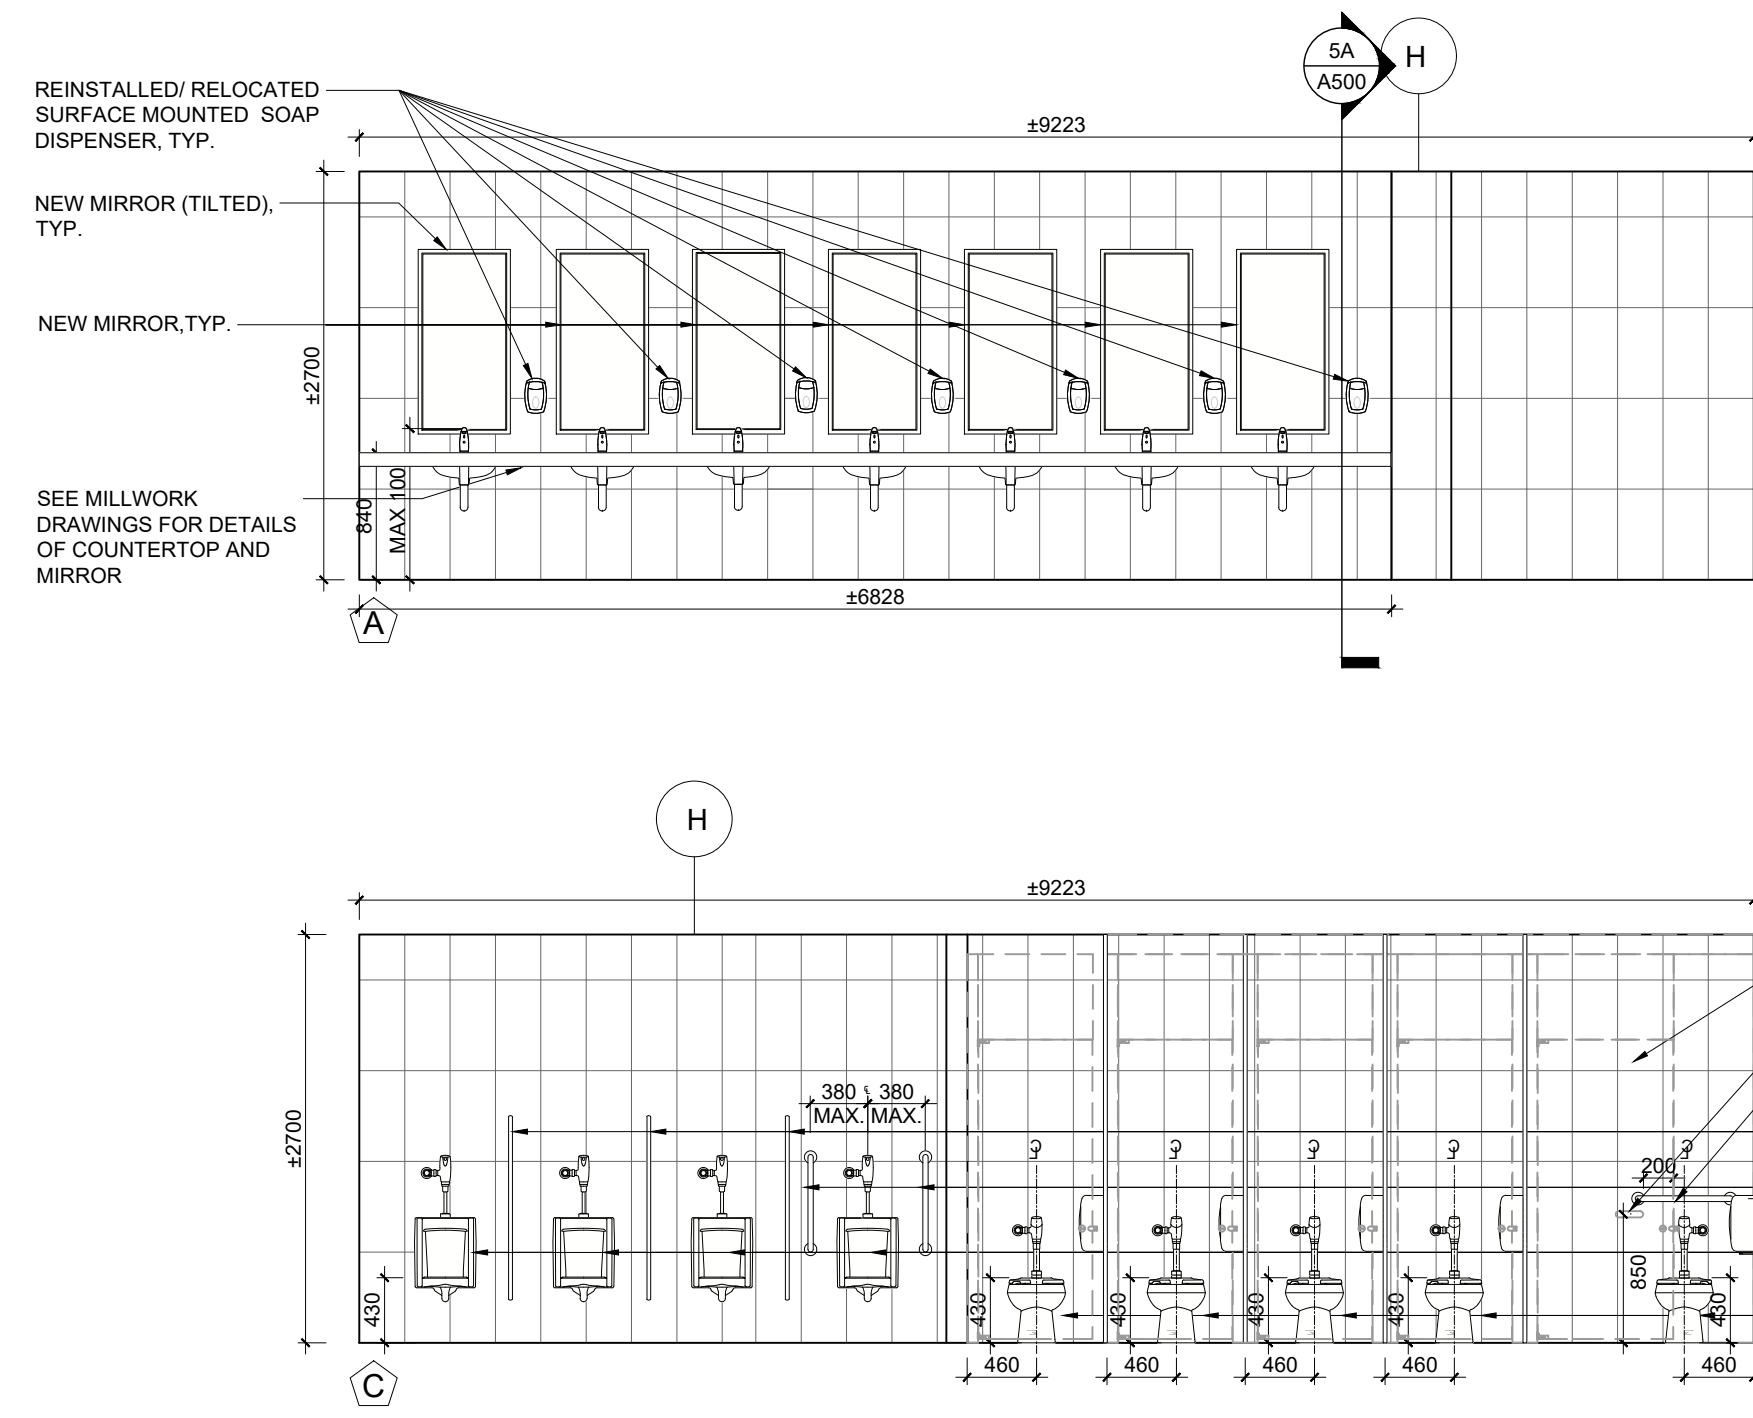


INTERIOR ELEVATIONS LEGEND	
	POR1: 300mm x 610mm PORCELAIN WALL TILE
	GLA1: 300mm x 50mm GLASS TILE, STACK BOND
	GLA2: 300mm x 50mm GLASS TILE, STACK BOND
	NEW HOPE FULL HEIGHT SHOWER PARTITIONS, TYP.
EX.	EXISTING
N.I.C.	NOT IN CONTRACT
TYP.	TYPICAL
INTERIOR ELEVATIONS NOTES	
1. MECHANICAL ACCESS HATCH FOR WASHROOMS AND SHOWER ROOMS NOT TO BE INSTALLED ON THE FEATURE WALL. GC TO COORDINATE WITH MECHANICAL SUBCONTRACTOR AND INFORM THE ARCHITECT GC TO RECEIVE THE APPROVAL FROM THE ARCHITECT REGARDING THE LOCATION OF THE ACCESS HATCH BEFORE STARTING ANY MECHANICAL WORK.	
2. GC IS RESPONSIBLE TO SUPPLY & INSTALL ±18 SOAP/SHAMPOO SHELVES BY SCHLUTER SYSTEMS TO ALL SHOWER. TYP.	


12. ISSUED FOR TENDER	2026.05.01
11. ISSUED FOR BUILDING PERMIT	2026.04.08
10. ISSUED FOR 10% CLIENT REVIEW	2026.03.31
9. ISSUED FOR DESIGN DEVELOPMENT CLIENT REVIEW	2025.10.28
8. ISSUED FOR DESIGN DEVELOPMENT CLIENT REVIEW	2025.10.01
7. ISSUED FOR PRELIMINARY DESIGN CLIENT REVIEW	2025.09.03
6. ISSUED FOR PRELIMINARY DESIGN CLIENT REVIEW	2025.08.18
5. ISSUED FOR PRELIMINARY DESIGN CLIENT REVIEW	2025.08.12
4. ISSUED FOR PRELIMINARY DESIGN CLIENT REVIEW	2025.08.01
3. ISSUED FOR PRELIMINARY DESIGN CLIENT REVIEW	2025.07.30
2. ISSUED FOR PRELIMINARY DESIGN CLIENT REVIEW	2025.07.25
1. ISSUED FOR PRELIMINARY DESIGN CLIENT REVIEW	2025.07.14
NO. DESCRIPTION	DATE
REVISIONS	
PROJECT	
 REGION OF PEEL EMIL V. KOLB CENTRE PEEL REGIONAL POLICE FACILITY INTERIOR RENOVATION PROJECT 181 DENRY ROAD EAST, MISSISSAUGA, ON L5T 2Y5	
 The Corporation shall check and verify all dimensions and report any discrepancies to the architect prior to construction. The architect shall be responsible for the accuracy of the design. The architect shall be responsible for the accuracy of the design. The architect shall be responsible for the accuracy of the design.	
NORTH 	
SHEET TITLE INTERIOR ELEVATIONS- BASEMENT/GROUND FLOOR WASHROOM	
SHEET NO.	A502
DRAWN BY	CC
CHECKED BY	RN
PROJECT NO.	
SCALE	AS NOTED

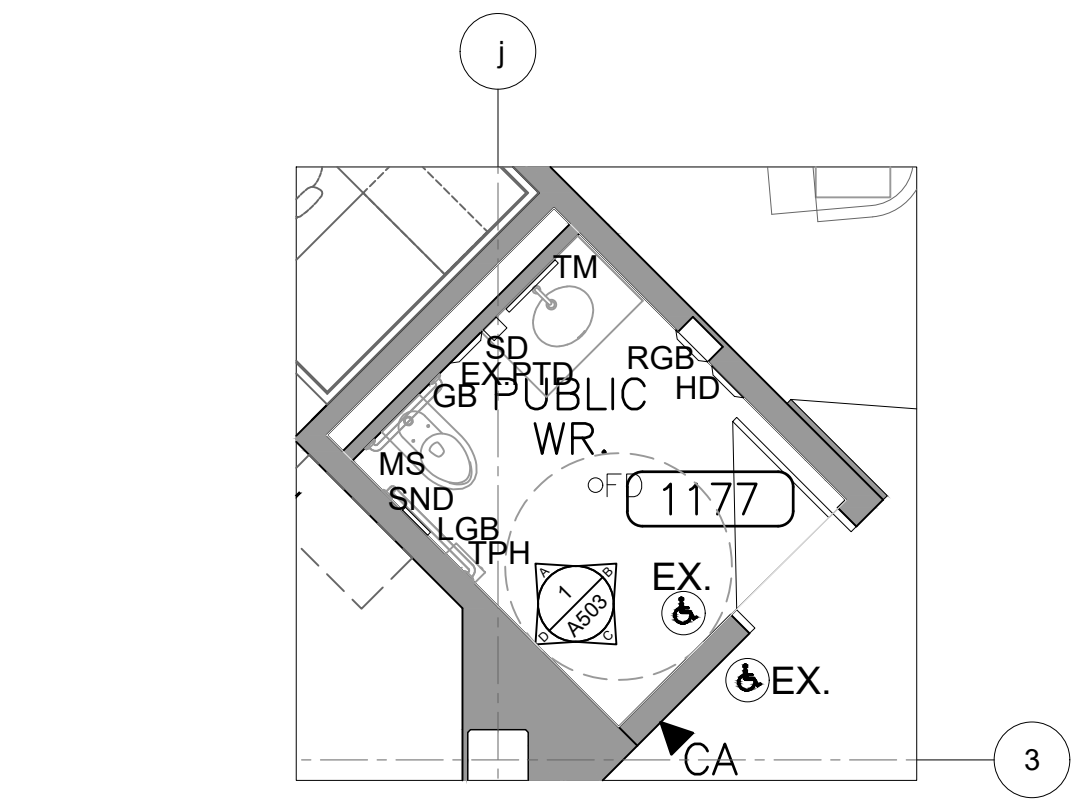



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A503
SCALE: 1:50
INTERIOR ELEVATIONS- GROUND FLOOR PUBLIC WR. (1177)

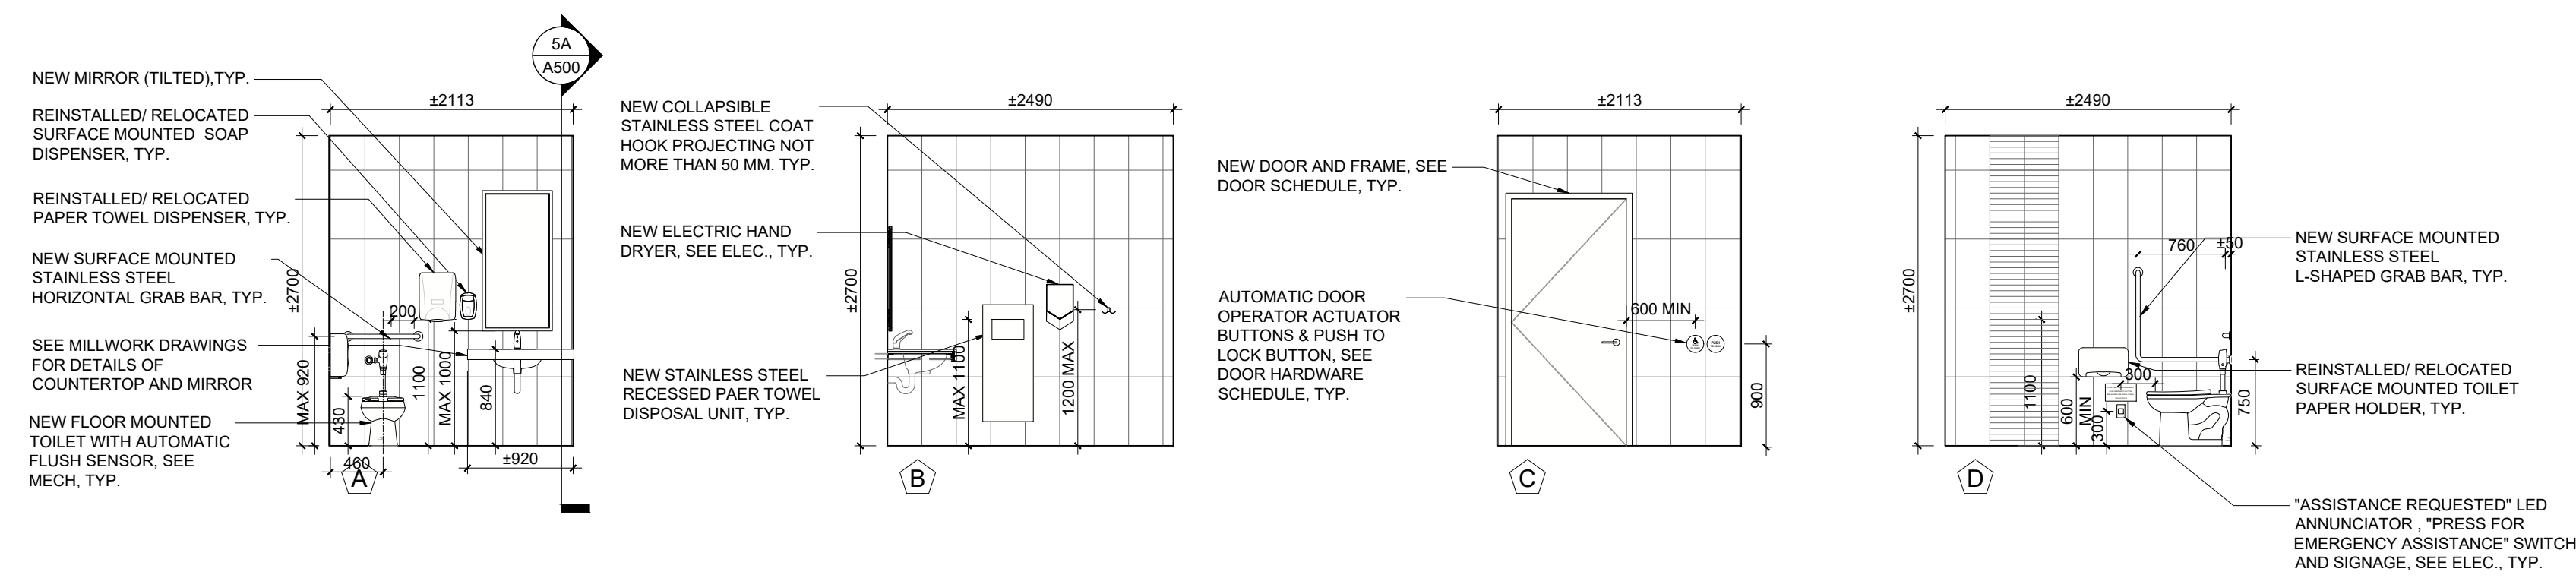



INTERIOR ELEVATIONS LEGEND	
	POR1: 305mm x 610mm PORCELAIN WALL TILE
	GLA1: 300mm x 50mm GLASS TILE, STACK BOND
	GLA2: 300mm x 50mm GLASS TILE, STACK BOND
	NEW HOPE FULL HEIGHT SHOWER PARTITIONS, TYP.
EX.	EXISTING
N.I.C.	NOT IN CONTRACT
TYP.	TYPICAL
INTERIOR ELEVATIONS NOTES	
1. MECHANICAL ACCESS HATCH FOR WASHROOMS AND SHOWER ROOMS NOT TO BE INSTALLED ON THE FEATURE WALL, GC TO COORDINATE WITH MECHANICAL SUBCONTRACTOR AND INFORM THE ARCHITECT. GC TO RECEIVE THE APPROVAL FROM THE ARCHITECT REGARDING THE LOCATION OF THE ACCESS HATCH BEFORE STARTING ANY MECHANICAL WORK.	
2. GC IS RESPONSIBLE TO SUPPLY & INSTALL ±18 SOAP/SHAMPOO SHELVES BY SCHLUTER SYSTEMS TO ALL SHOWERS, TYP.	

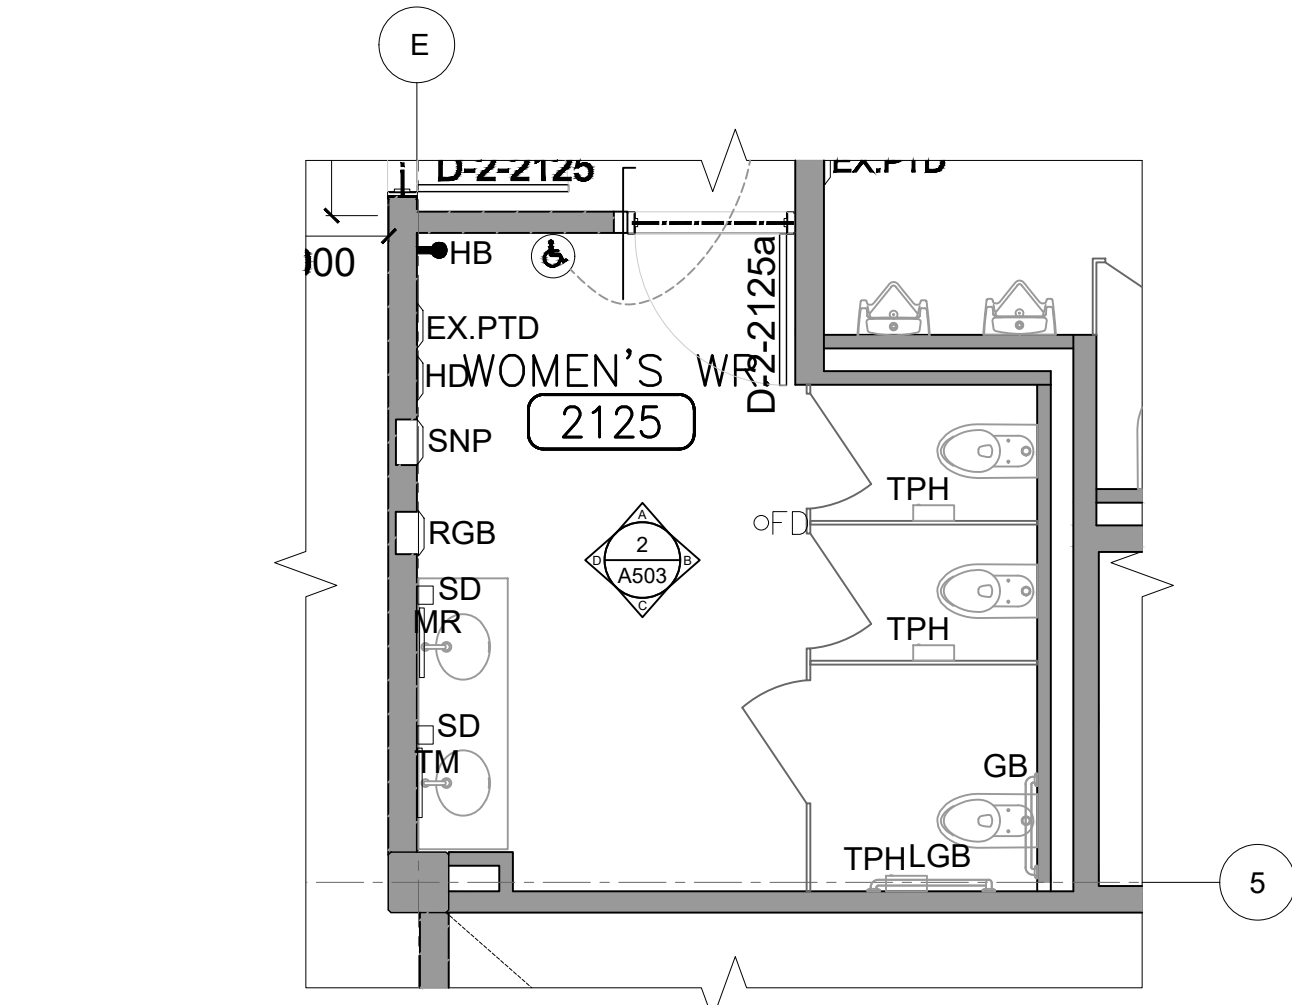



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A503
SCALE: 1:50
INTERIOR ELEVATIONS- SECOND FLOOR WOMEN'S WR (2125)

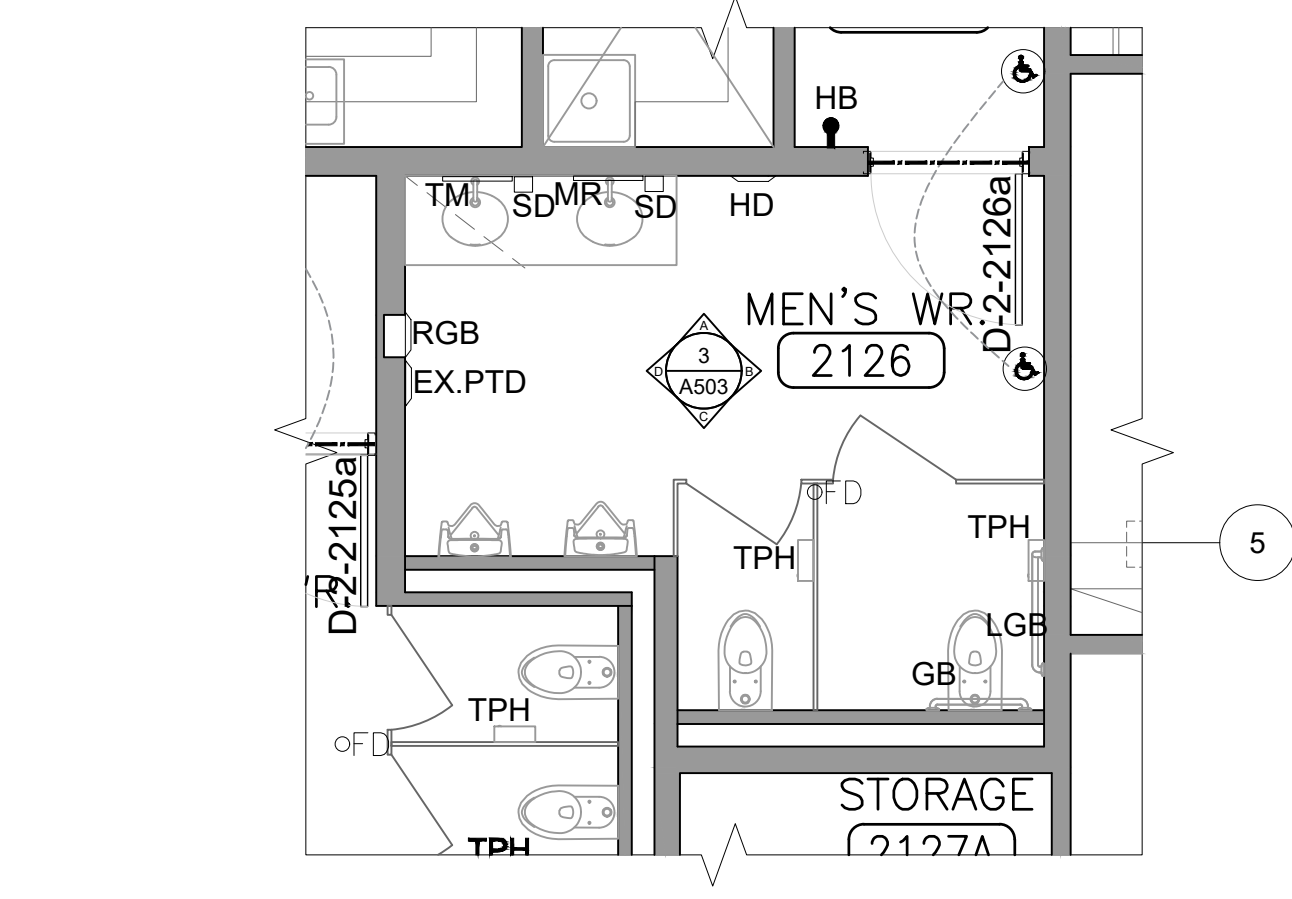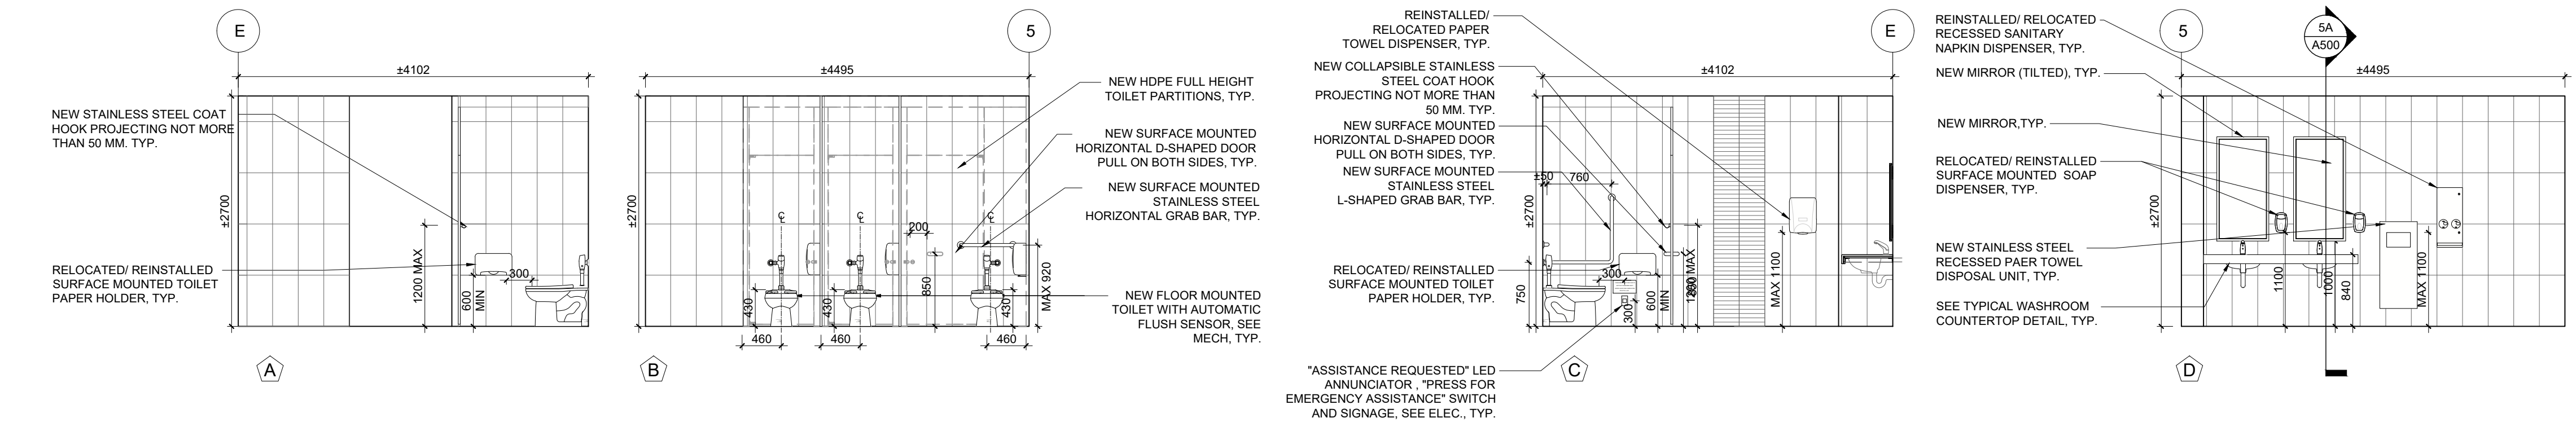


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A503
SCALE: 1:50
INTERIOR ELEVATIONS- SECOND FLOOR MEN'S WR. (2126)

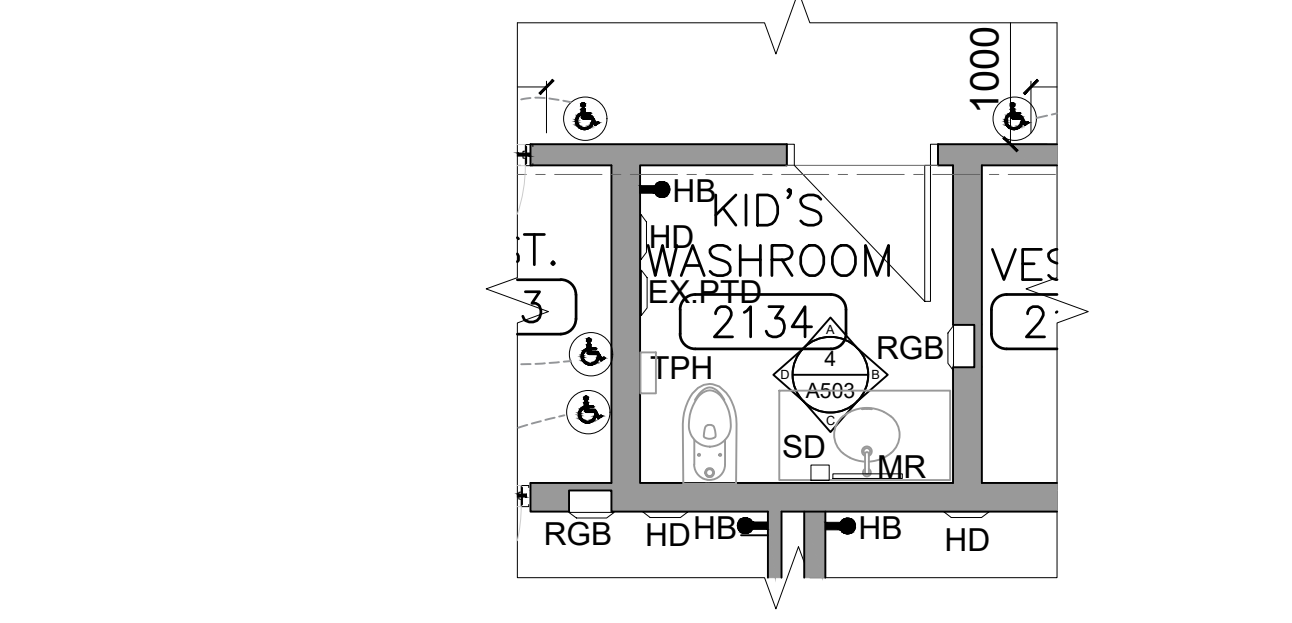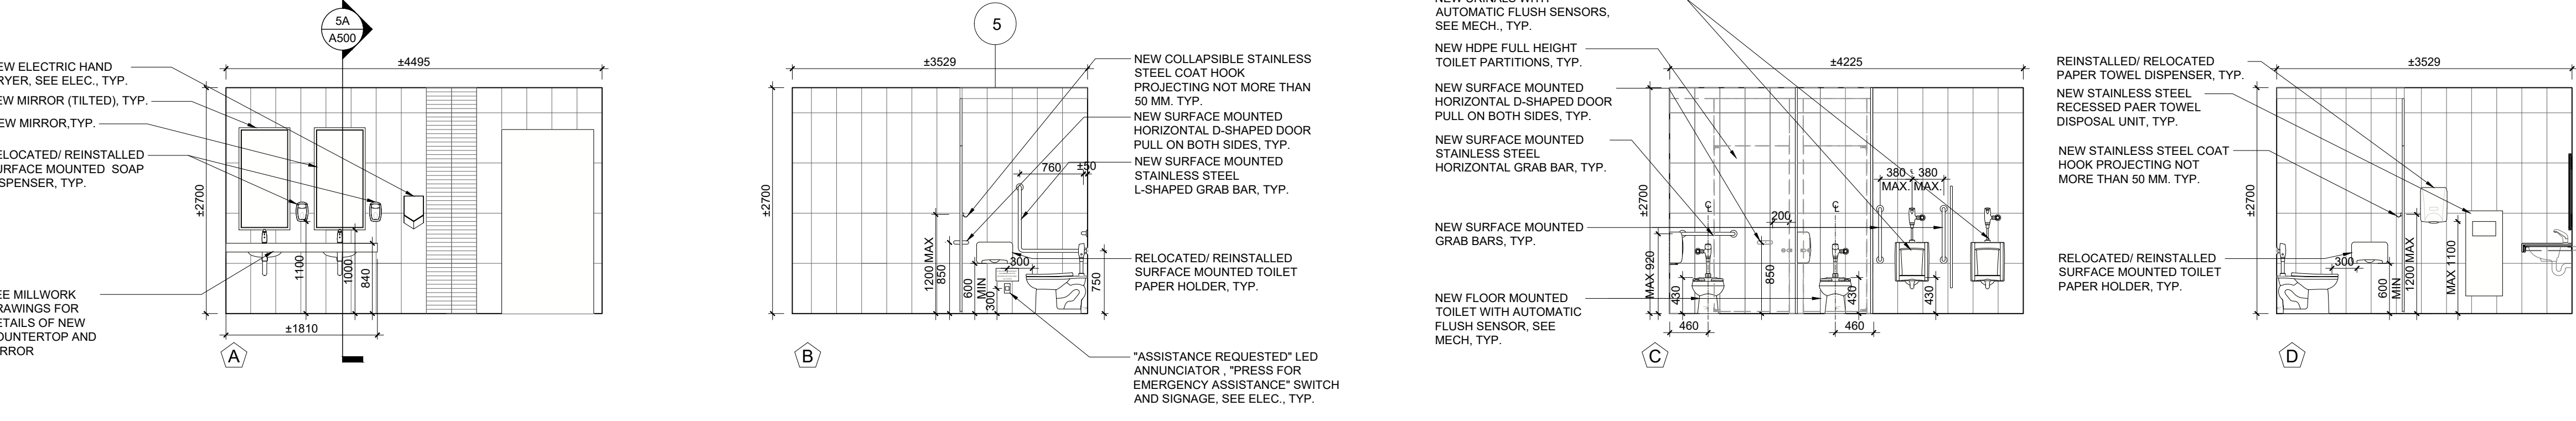


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A503
SCALE: 1:50
INTERIOR ELEVATIONS- SECOND FLOOR KID'S WASHROOM (2134)

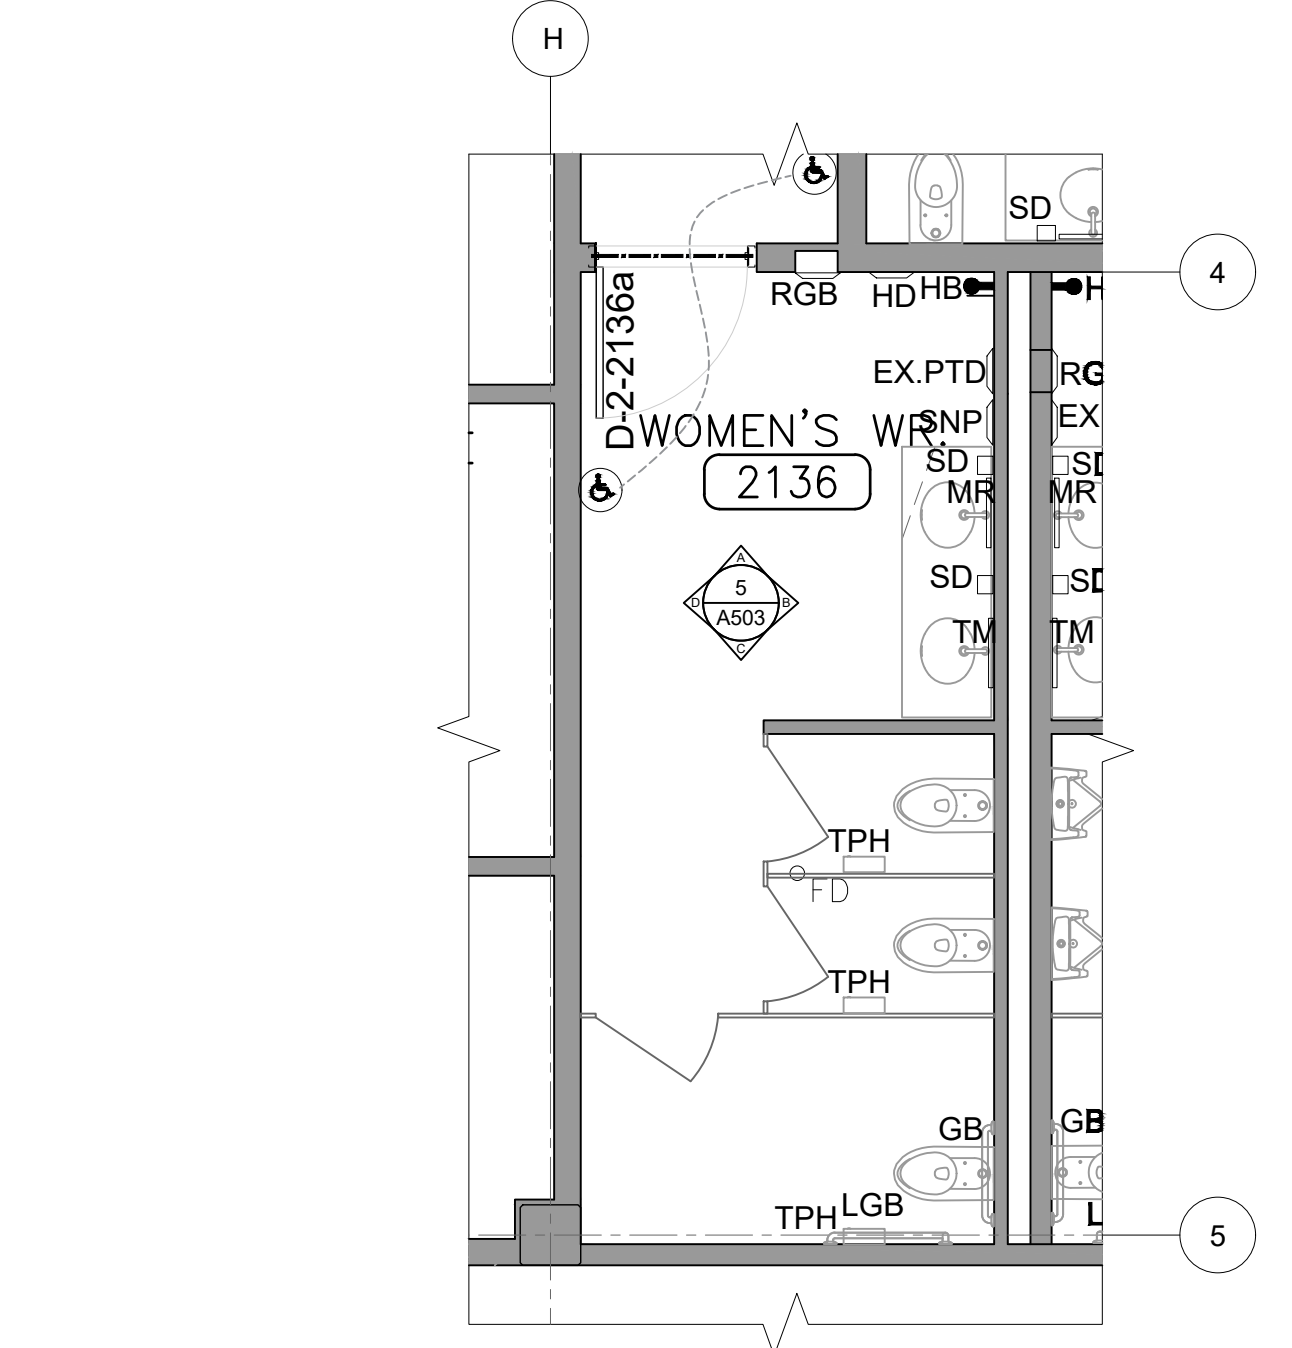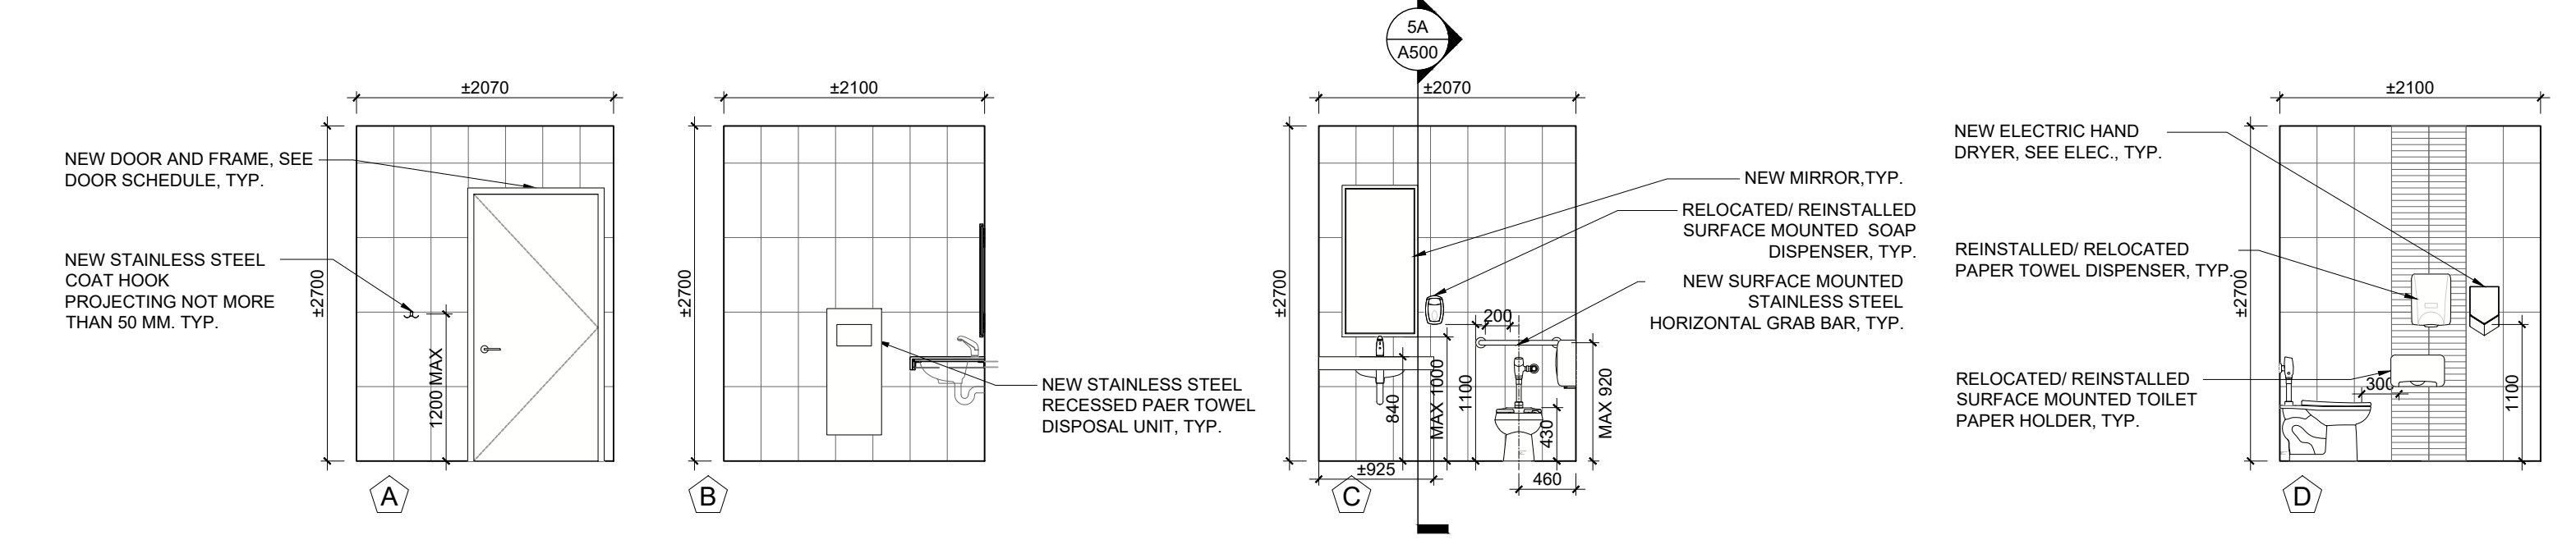


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A503
SCALE: 1:50
INTERIOR ELEVATIONS- SECOND FLOOR WOMEN'S WR. (2136)

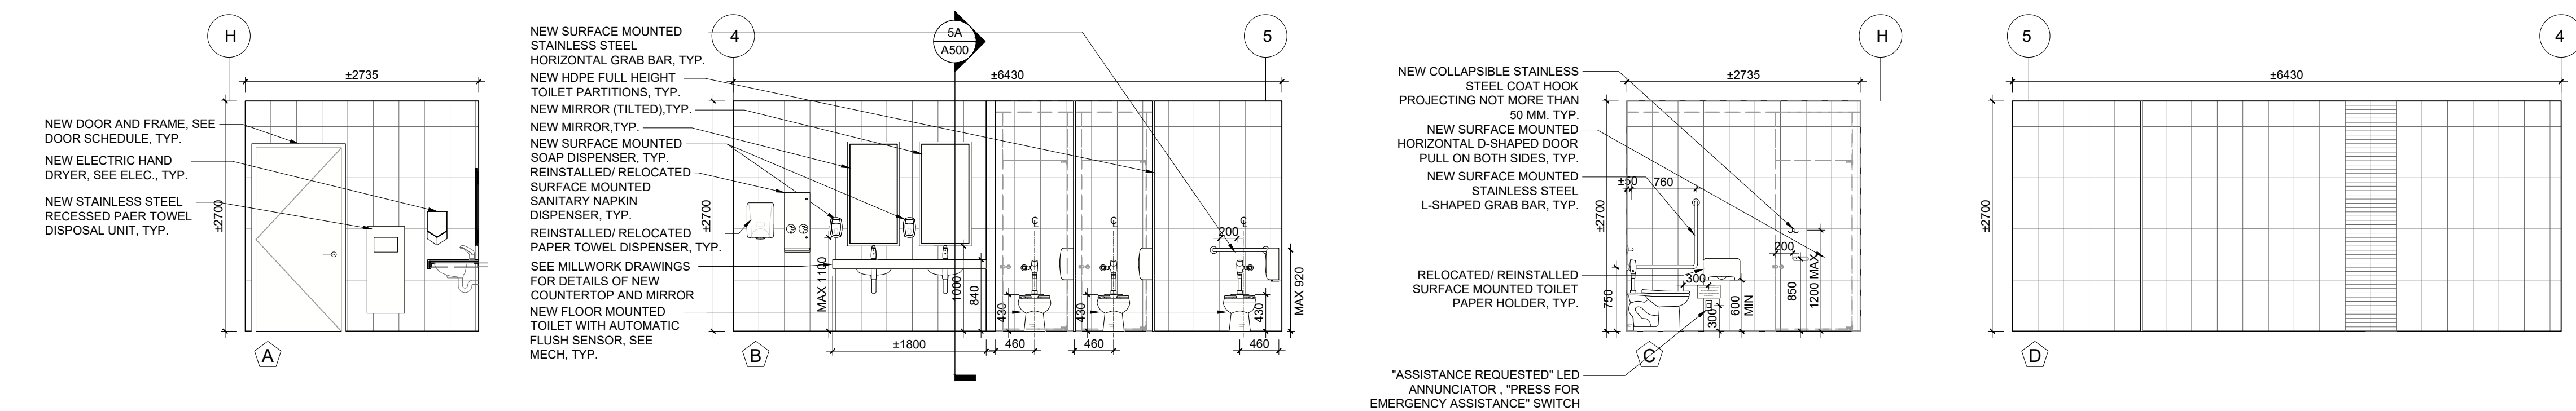


12. ISSUED FOR TENDER	2026.05.01
11. ISSUED FOR BUILDING PERMIT	2026.04.08
10. ISSUED FOR 10% CLIENT REVIEW	2025.03.31
9. ISSUED FOR DESIGN DEVELOPMENT CLIENT REVIEW	2025.10.28
8. ISSUED FOR DESIGN DEVELOPMENT CLIENT REVIEW	2025.10.01
7. ISSUED FOR PRELIMINARY DESIGN CLIENT REVIEW	2025.09.03
6. ISSUED FOR PRELIMINARY DESIGN CLIENT REVIEW	2025.08.18
5. ISSUED FOR PRELIMINARY DESIGN CLIENT REVIEW	2025.08.12
4. ISSUED FOR PRELIMINARY DESIGN CLIENT REVIEW	2025.08.01
3. ISSUED FOR PRELIMINARY DESIGN CLIENT REVIEW	2025.07.30
2. ISSUED FOR PRELIMINARY DESIGN CLIENT REVIEW	2025.07.25
1. ISSUED FOR PRELIMINARY DESIGN CLIENT REVIEW	2025.07.14
NO. DESCRIPTION	DATE
REVISIONS	
PROJECT	
REGION OF PEEL	
EMIL V. KOLB CENTRE PEEL REGIONAL POLICE FACILITY INTERIOR RENOVATION PROJECT 180 DERRY ROAD EAST, MISSISSAUGA, ON L5T 2Y5	
The drawings shall check and verify all dimensions and report all errors and omissions to the client. The drawings shall not be used for construction purposes until approved by the client. The drawings shall not be used for construction purposes until approved by the client.	
PROJECT NO. 2025.08.12	
SHEET NO. 1	
SHEET TITLE	
INTERIOR ELEVATIONS- GROUND FLOOR/SECOND FLOOR WASHROOM	
SHEET NO. 1	
DRAWN BY CC	
CHECKED BY RN	
PROJECT NO. A503	
SCALE AS NOTED	

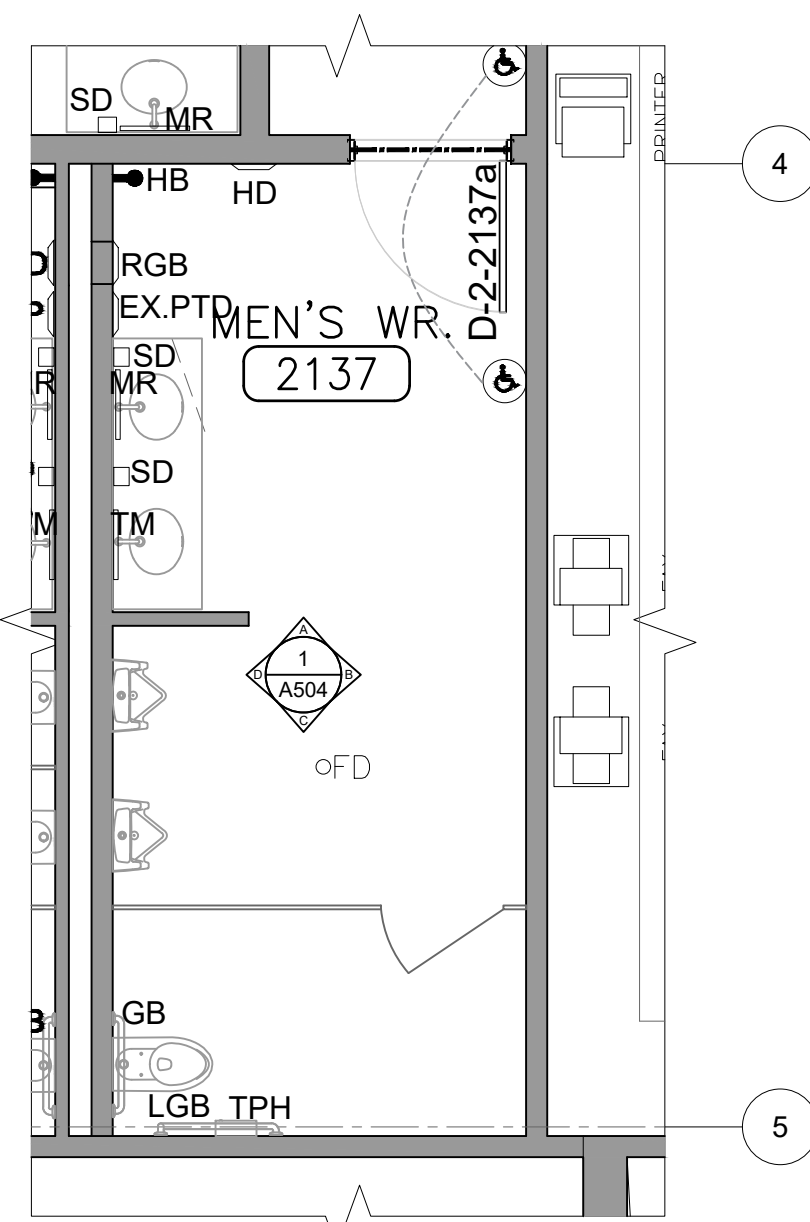


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A504
INTERIOR ELEVATIONS- SECOND FLOOR MEN'S WR. (2137)
SCALE: 1/50

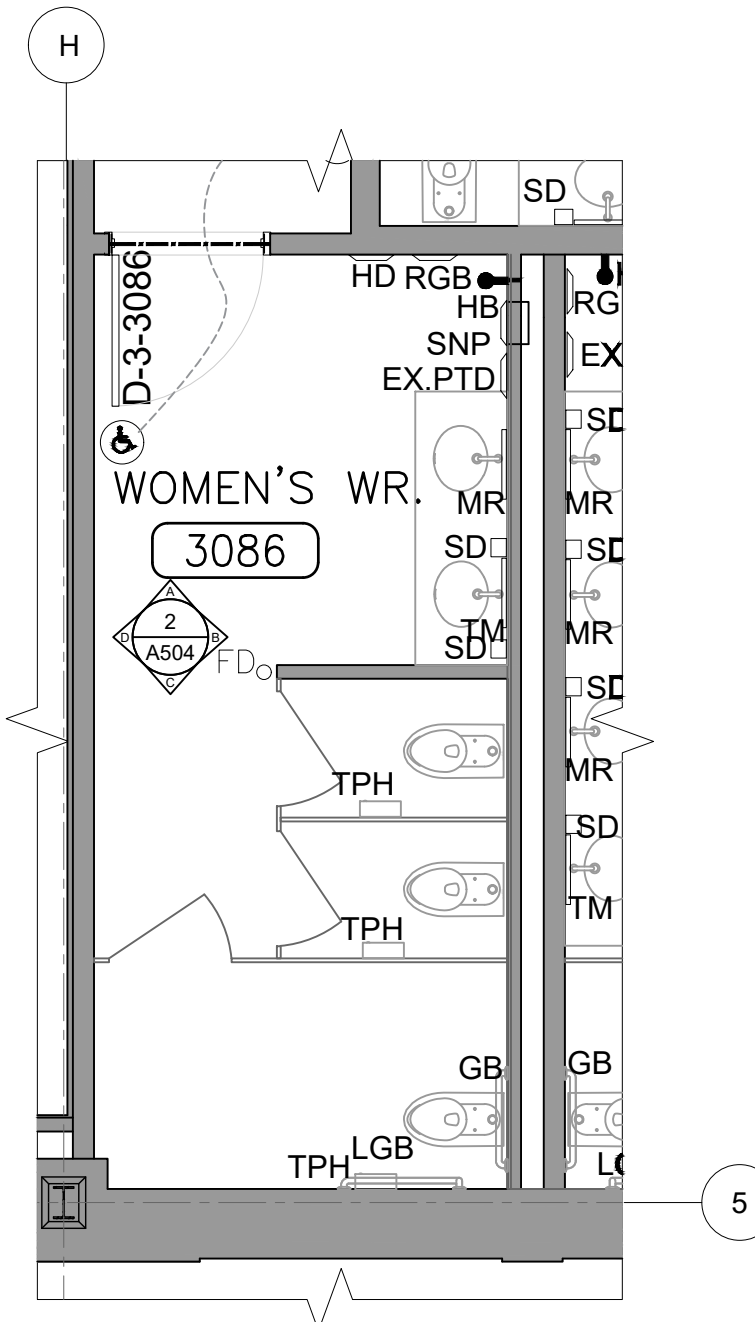


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A504
INTERIOR ELEVATIONS- THIRD FLOOR WOMEN'S WR (3086)
SCALE: 1/50

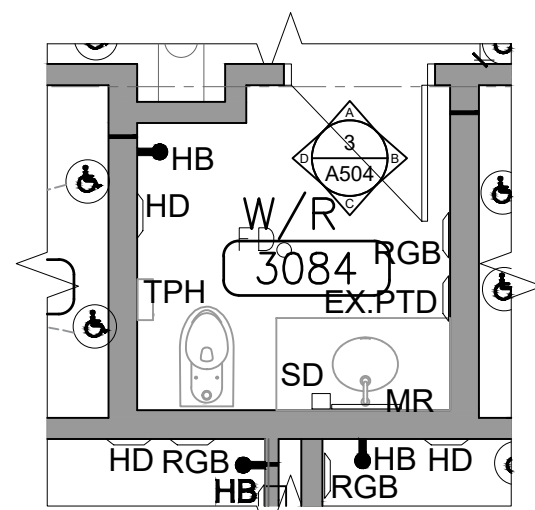























3
A504
INTERIOR ELEVATIONS- THIRD FLOOR W.R. (3184)
SCALE: 1/50

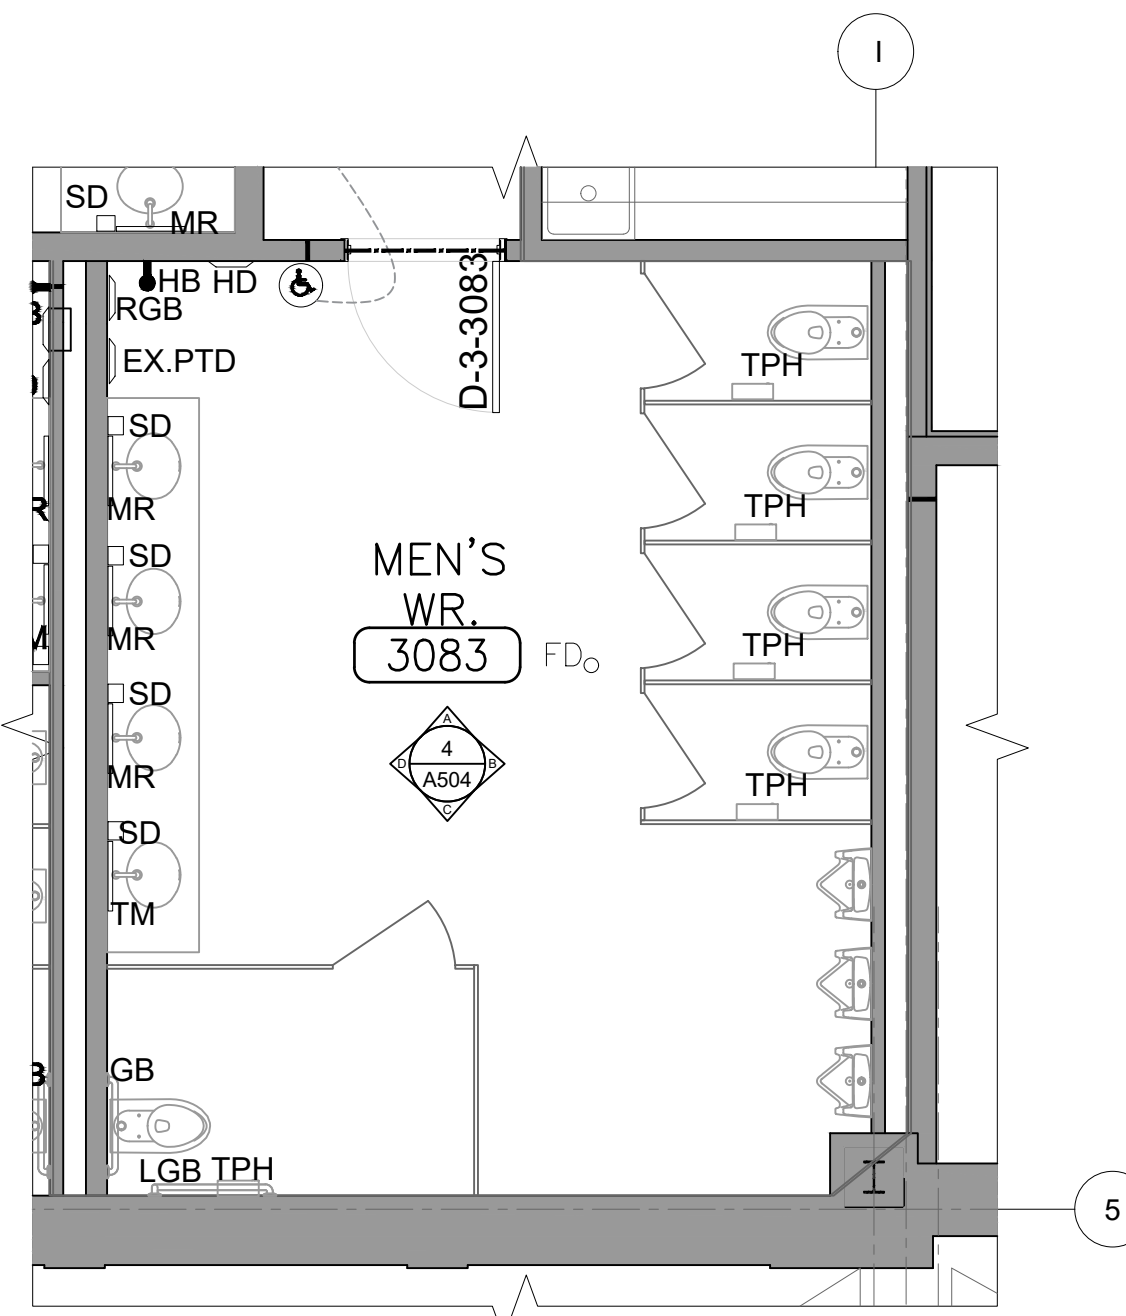

4
A504
INTERIOR ELEVATIONS- THIRD FLOOR MEN'S WASHROOM (3083)
SCALE: 1/50

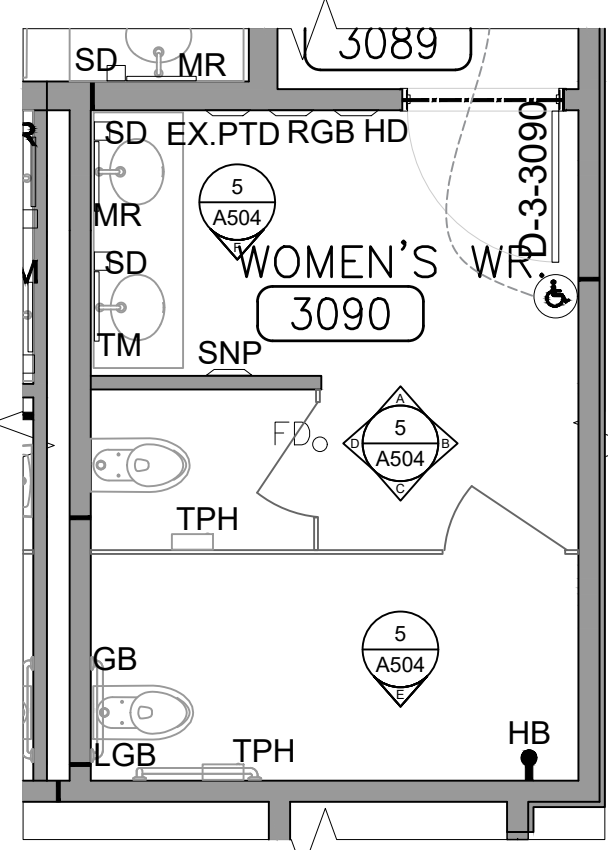

5
A504
INTERIOR ELEVATIONS- THIRD FLOOR WOMEN'S WR. (3090)
SCALE: 1/50

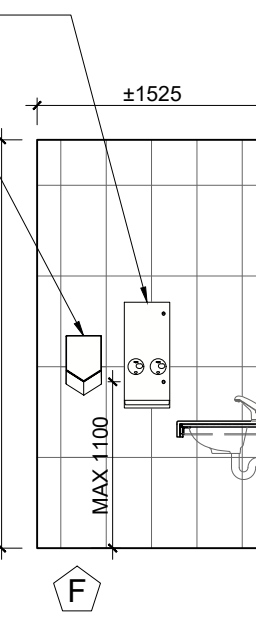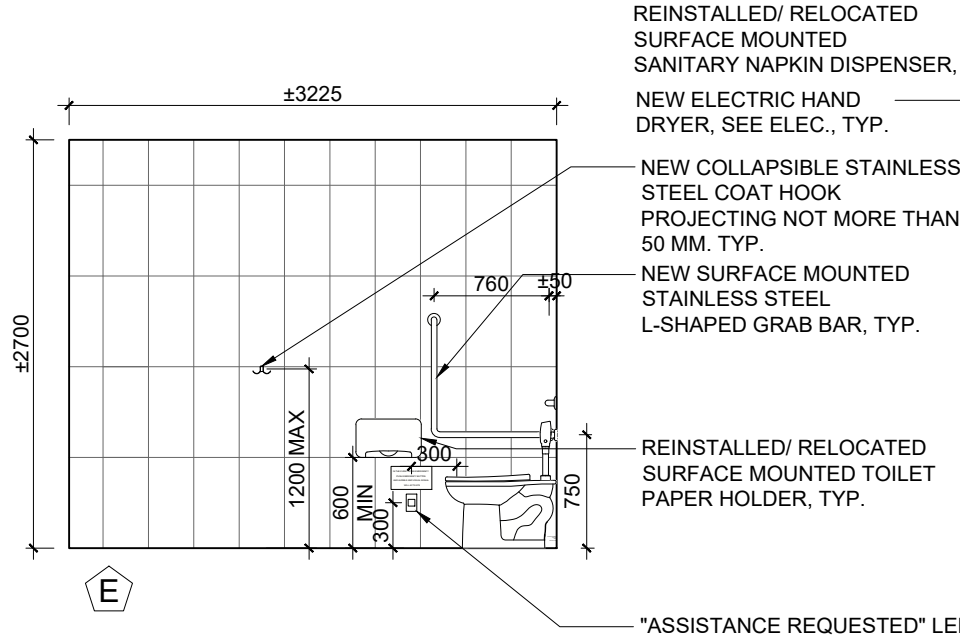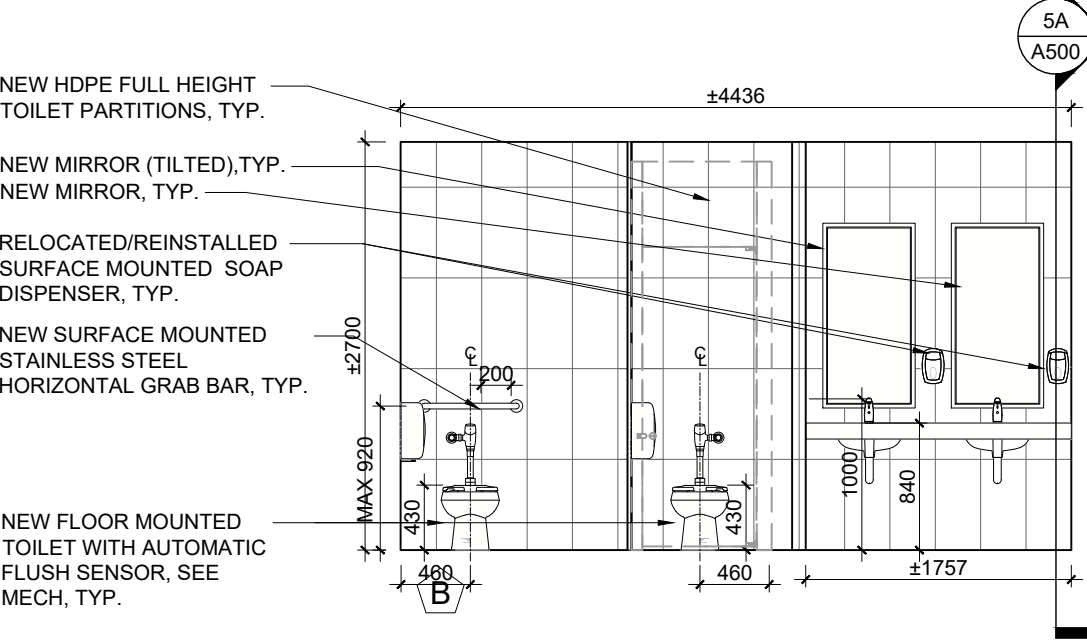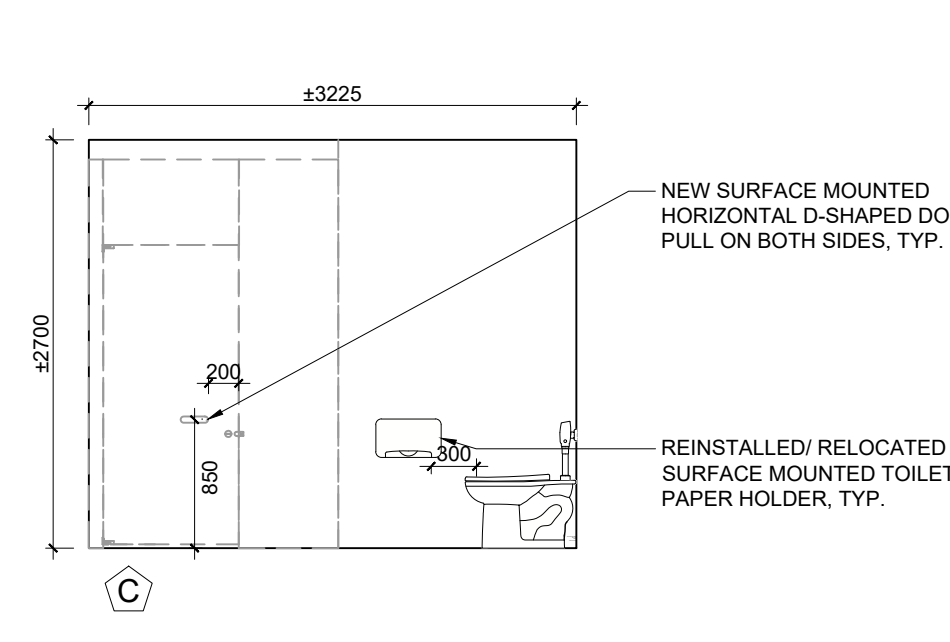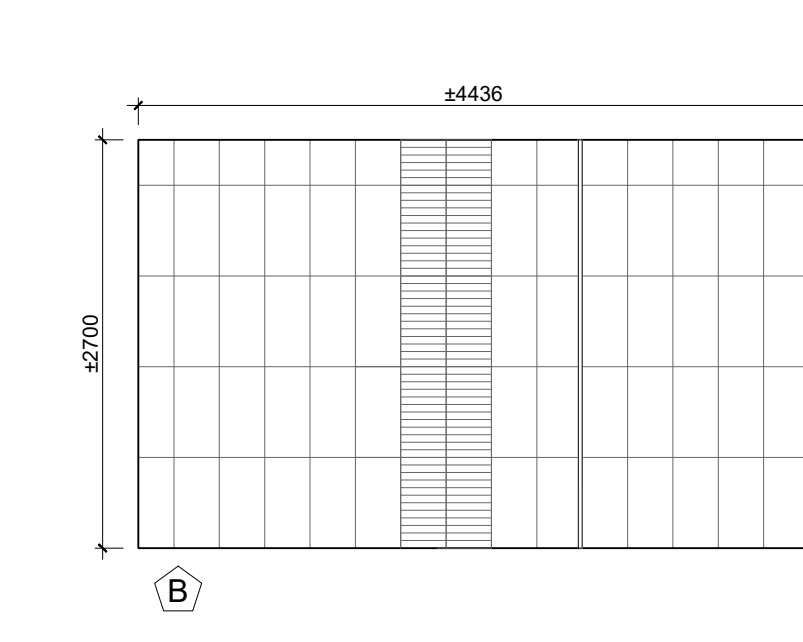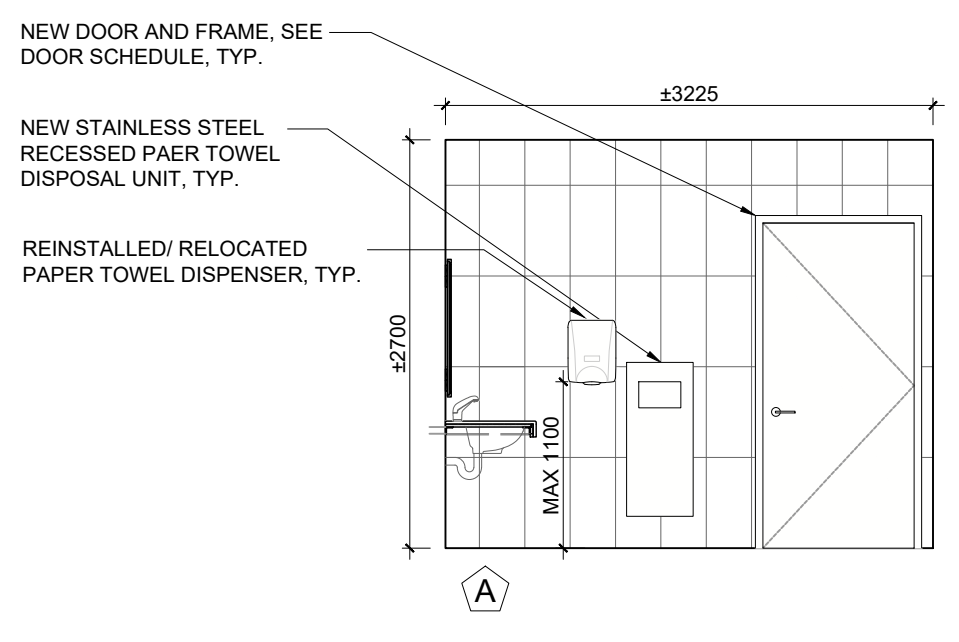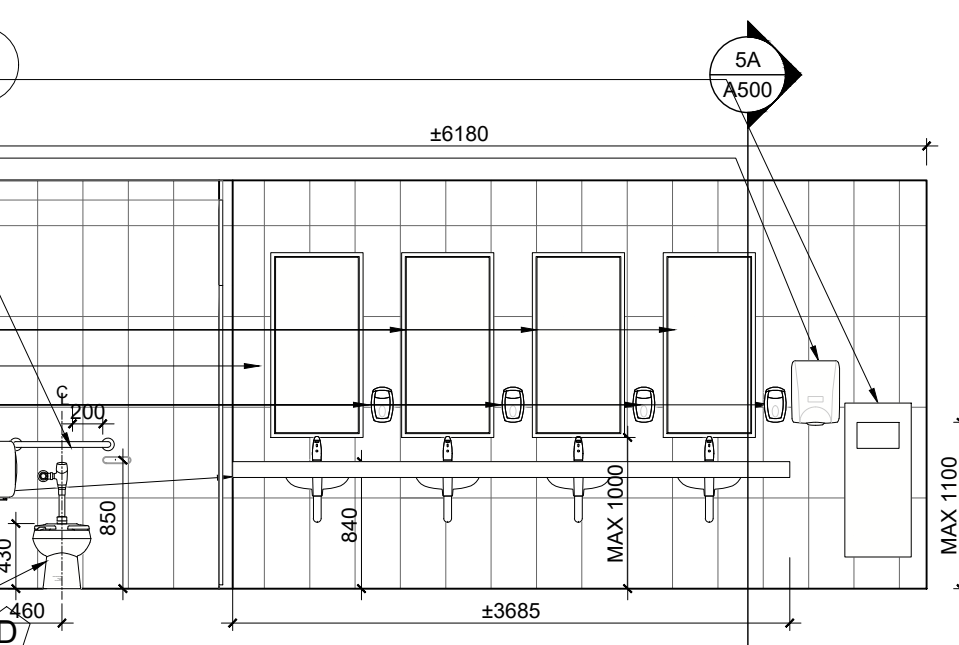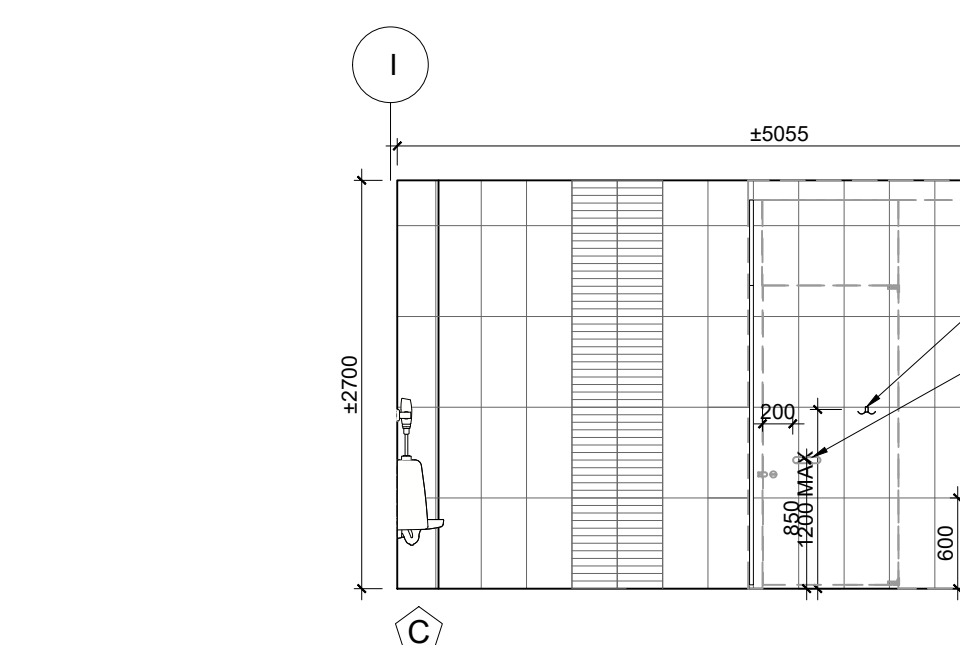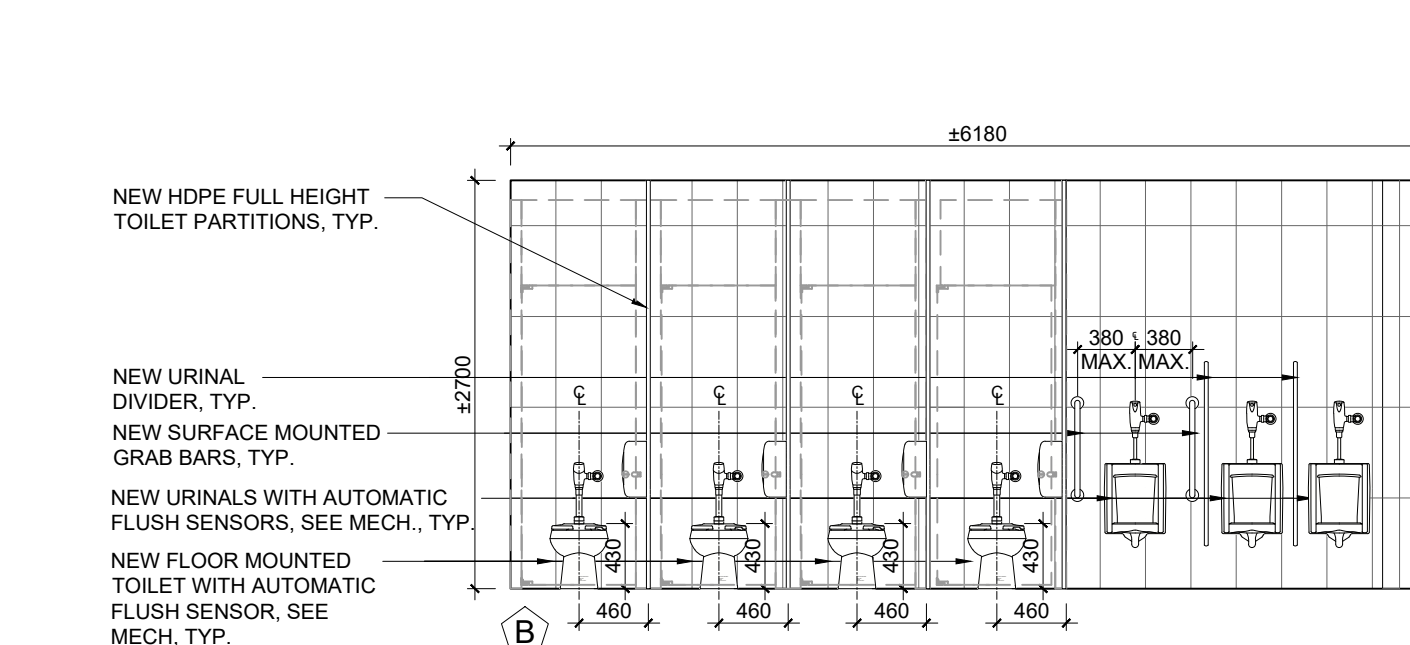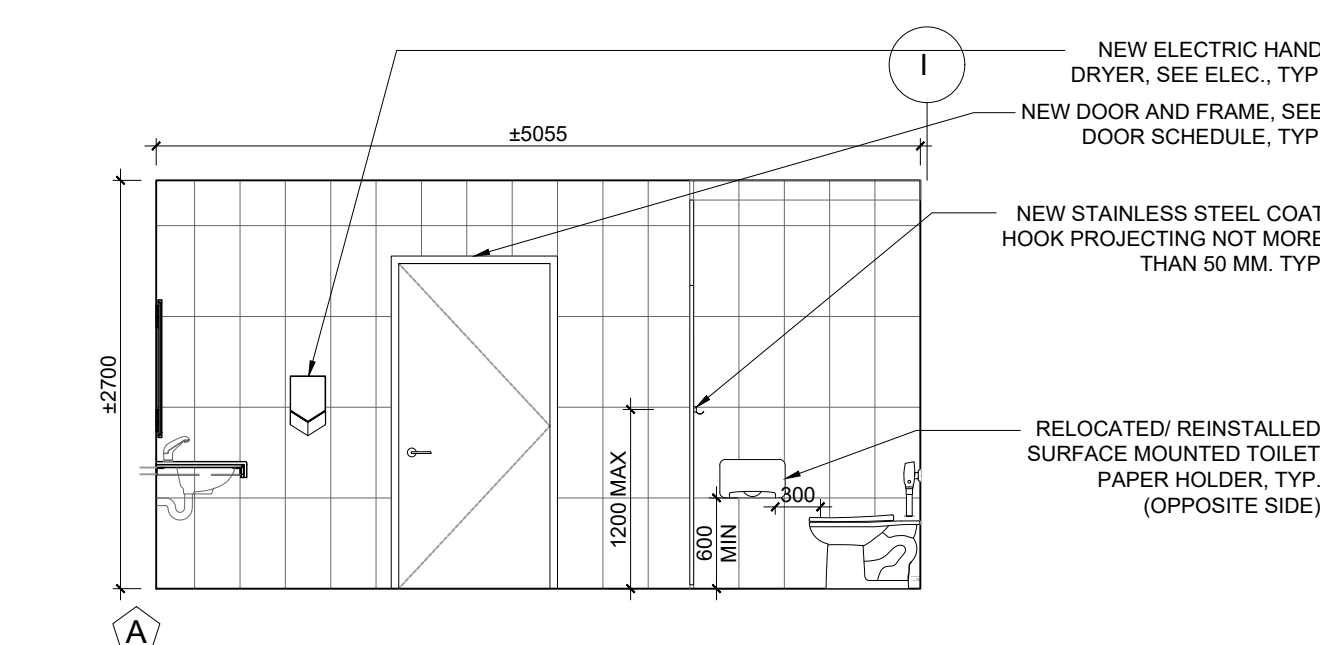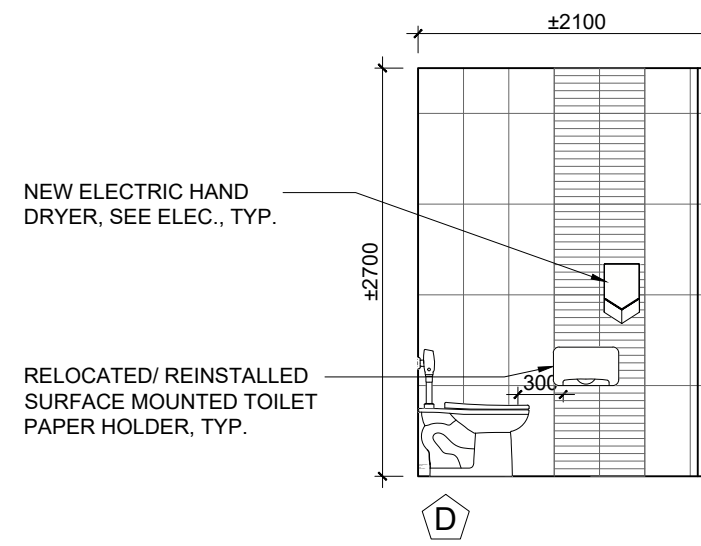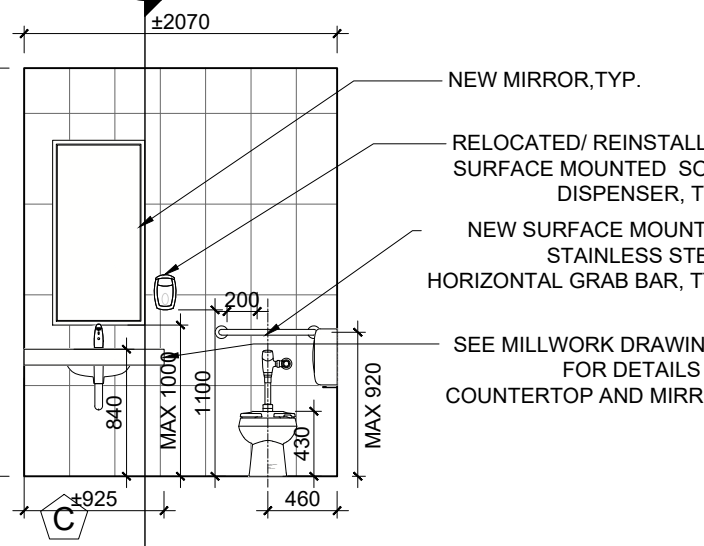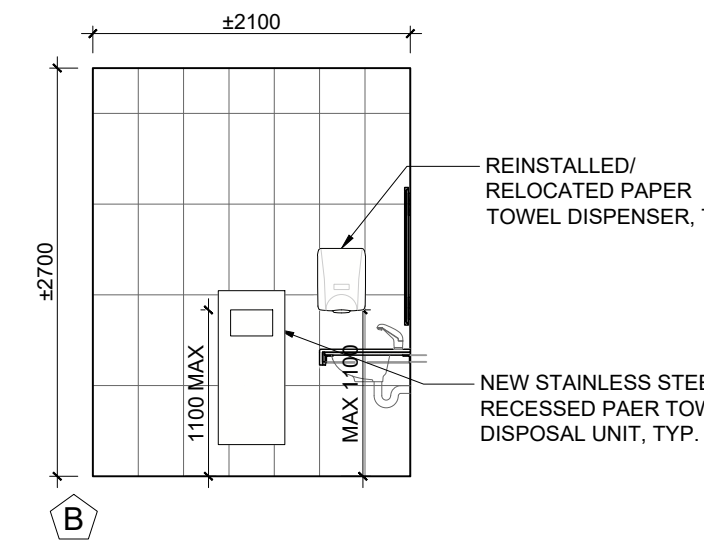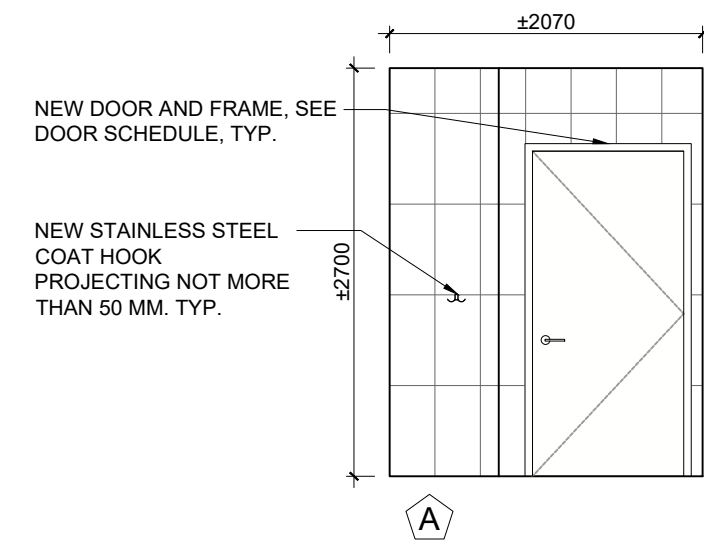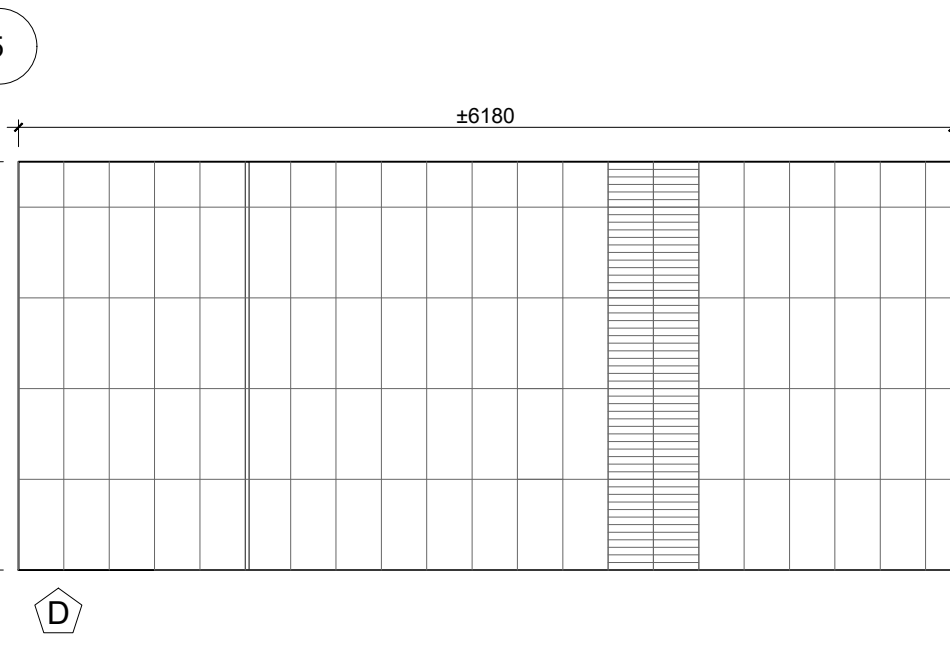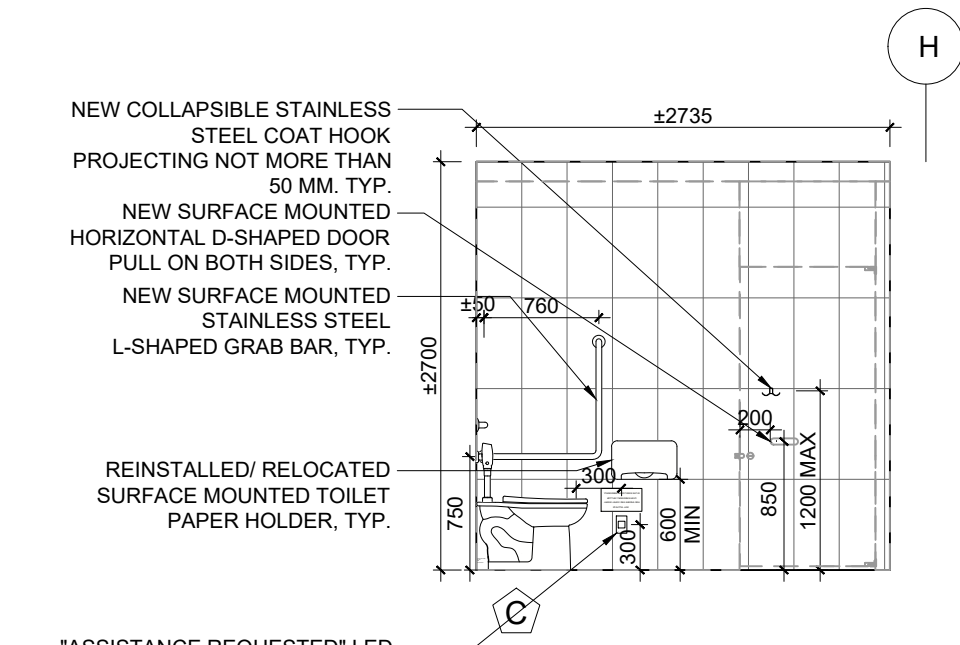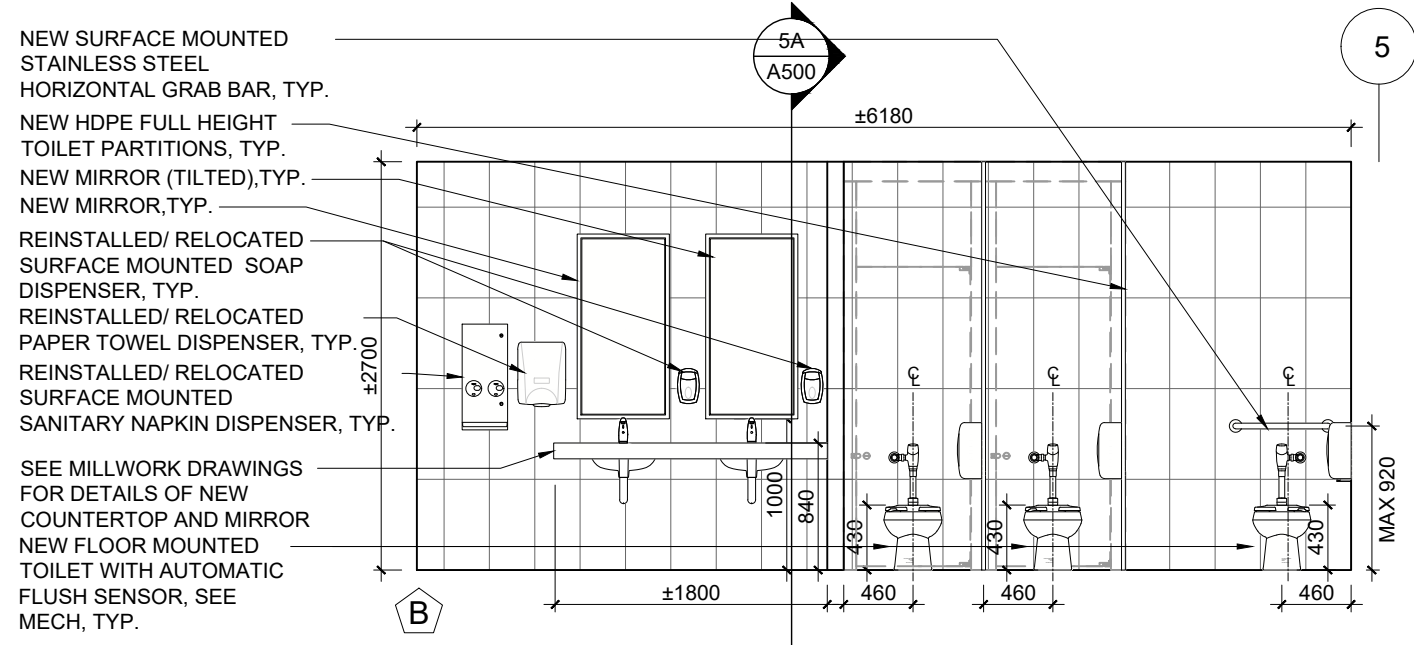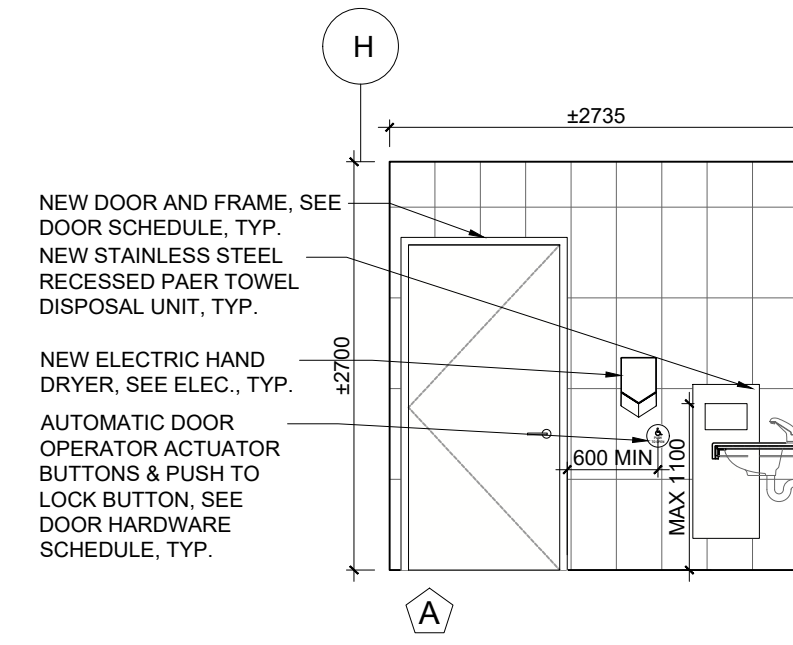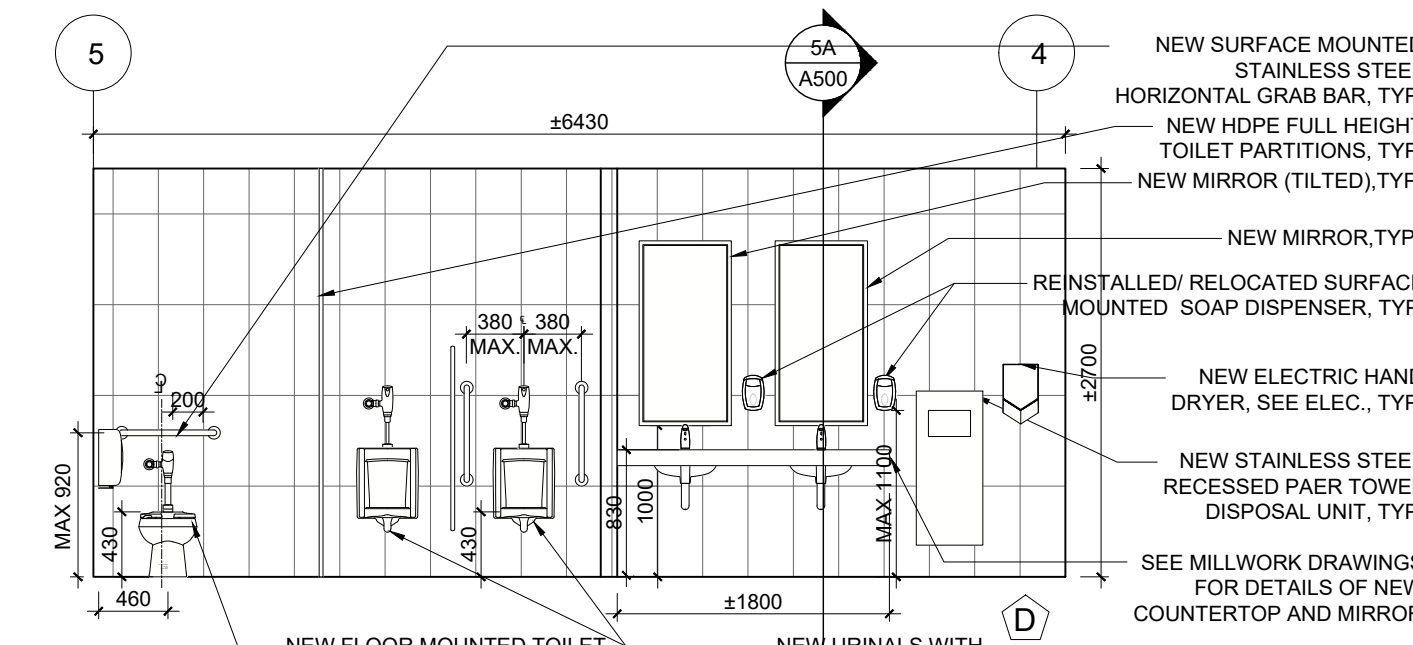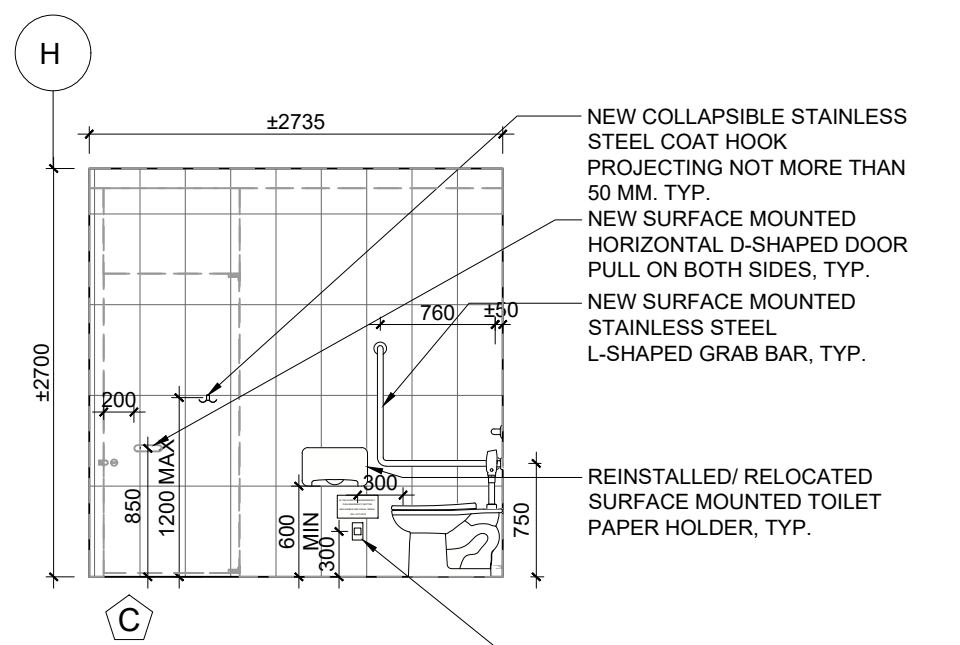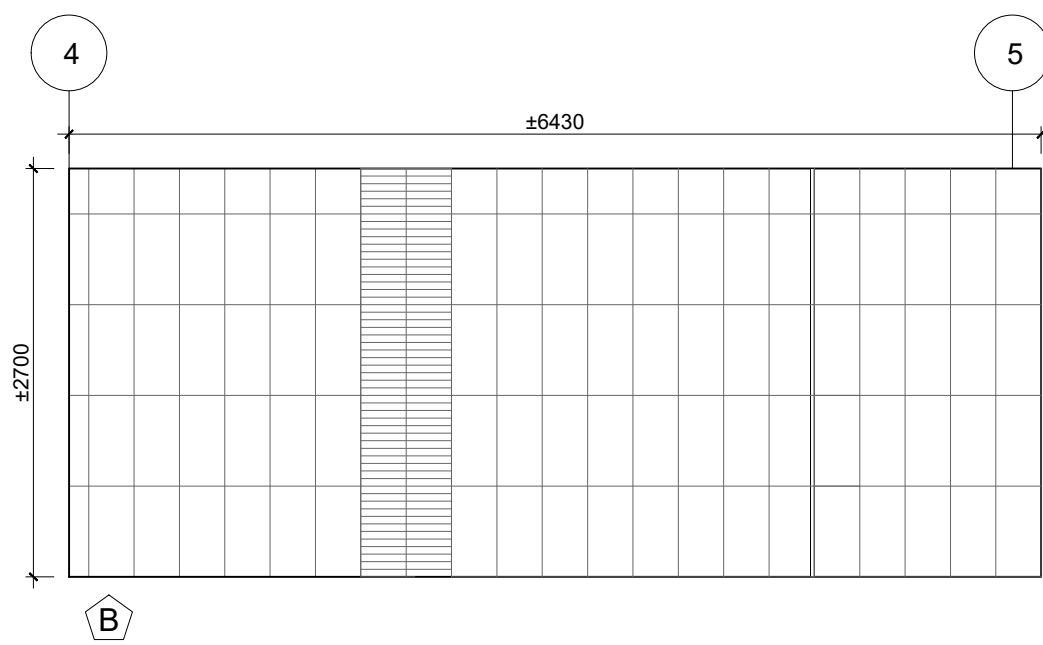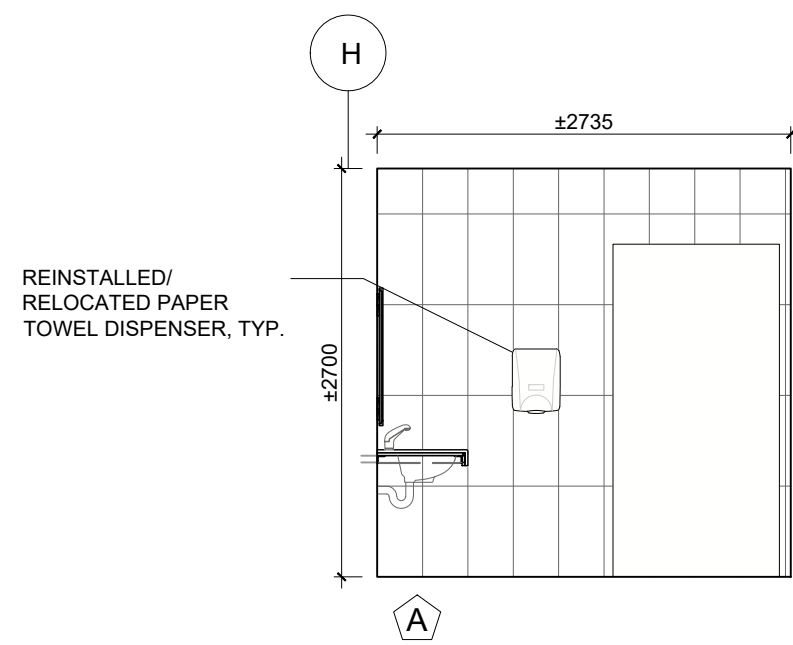




INTERIOR ELEVATIONS LEGEND	
	POR: 300mm x 610mm PORCELAIN WALL TILE
	GLA1: 300mm x 50mm GLASS TILE, STACK BOND
	GLA2: 300mm x 50mm GLASS TILE, STACK BOND
	NEW HOPE FULL HEIGHT SHOWER PARTITIONS, TYP.
EX.	EXISTING
N.I.C.	NOT IN CONTRACT
TYP.	TYPICAL
INTERIOR ELEVATIONS NOTES	
1. MECHANICAL ACCESS HATCH FOR WASHROOMS AND SHOWER ROOMS NOT TO BE INSTALLED ON THE FEATURE WALL. GC TO COORDINATE WITH MECHANICAL SUBCONTRACTOR AND INFORM THE ARCHITECT. GC TO RECEIVE THE APPROVAL FROM THE ARCHITECT REGARDING THE LOCATION OF THE ACCESS HATCH BEFORE STARTING ANY MECHANICAL WORK.	
2. GC IS RESPONSIBLE TO SUPPLY & INSTALL ±18 SOAP/SHAMPOO SHELVES BY SCHLUTER SYSTEMS TO ALL SHOWERS, TYP.	

12. ISSUED FOR TENDER	2026.05.01
11. ISSUED FOR BUILDING PERMIT	2026.04.08
10. ISSUED FOR 10% CLIENT REVIEW	2026.03.31
9. ISSUED FOR DESIGN DEVELOPMENT CLIENT REVIEW	2025.10.28
8. ISSUED FOR DESIGN DEVELOPMENT CLIENT REVIEW	2025.10.01
7. ISSUED FOR PRELIMINARY DESIGN CLIENT REVIEW	2025.09.03
6. ISSUED FOR PRELIMINARY DESIGN CLIENT REVIEW	2025.08.18
5. ISSUED FOR PRELIMINARY DESIGN CLIENT REVIEW	2025.08.12
4. ISSUED FOR PRELIMINARY DESIGN CLIENT REVIEW	2025.08.01
3. ISSUED FOR PRELIMINARY DESIGN CLIENT REVIEW	2025.07.30
2. ISSUED FOR PRELIMINARY DESIGN CLIENT REVIEW	2025.07.25
1. ISSUED FOR PRELIMINARY DESIGN CLIENT REVIEW	2025.07.14
NO. DESCRIPTION	DATE
REVISIONS	
PROJECT	
REGION OF PEEL	
EMIL V. KOLB CENTRE PEEL REGIONAL POLICE FACILITY INTERIOR RENOVATION PROJECT 181 DERRY ROAD EAST, MISSISSAUGA, ON L5T 2Y5	
THE CONSULTANT SHALL CHECK AND VERIFY ALL DIMENSIONS AND REPORT ANY DISCREPANCIES TO THE ARCHITECT. THE CONSULTANT SHALL BE RESPONSIBLE FOR OBTAINING ALL NECESSARY PERMITS AND APPROVALS FROM THE ARCHITECT. THE CONSULTANT SHALL BE RESPONSIBLE FOR OBTAINING ALL NECESSARY PERMITS AND APPROVALS FROM THE ARCHITECT.	
STRUCTURAL CONSULTANT STEPHENSON ENGINEERING	
MECHANICAL CONSULTANT EXP SERVICES INC.	
ELECTRICAL CONSULTANT EXP SERVICES INC.	
SHEET TITLE INTERIOR ELEVATIONS- SECOND/ THIRD FLOOR WASHROOM	
SHEET NO. A504	DRAWN BY CC
PROJECT NO.	CHECKED RN
SCALE AS NOTED	






INTERIOR ELEVATIONS LEGEND	
PORT: 305mm X 610mm PORCELAIN WALL TILE	
GLA1: 300mm X 50mm GLASS TILE, STACK BOND	
GLA2: 300mm X 50mm GLASS TILE, STACK BOND	
NEW HIDE FULL HEIGHT SHOWER PARTITIONS, TYP.	
EX.	EXISTING
N.I.C.	NOT IN CONTRACT
TYP.	TYPICAL
INTERIOR ELEVATIONS NOTES	
1. MECHANICAL ACCESS HATCH FOR WASHROOMS AND SHOWER ROOMS NOT TO BE INSTALLED ON THE FEATURE WALL, GO TO COORDINATE WITH THE SUBCONTRACTOR AND INFORM THE ARCHITECT. GO TO RECEIVE THE APPROVAL FROM THE ARCHITECT REGARDING THE LOCATION OF THE ACCESS HATCH BEFORE STARTING ANY MECHANICAL WORK.	
2. GC IS RESPONSIBLE TO SUPPLY & INSTALL ±15 SQUARE METRE SHESBY SPLITTER SYSTEMS TO ALL SHOWERS, TYP.	


[illegible]

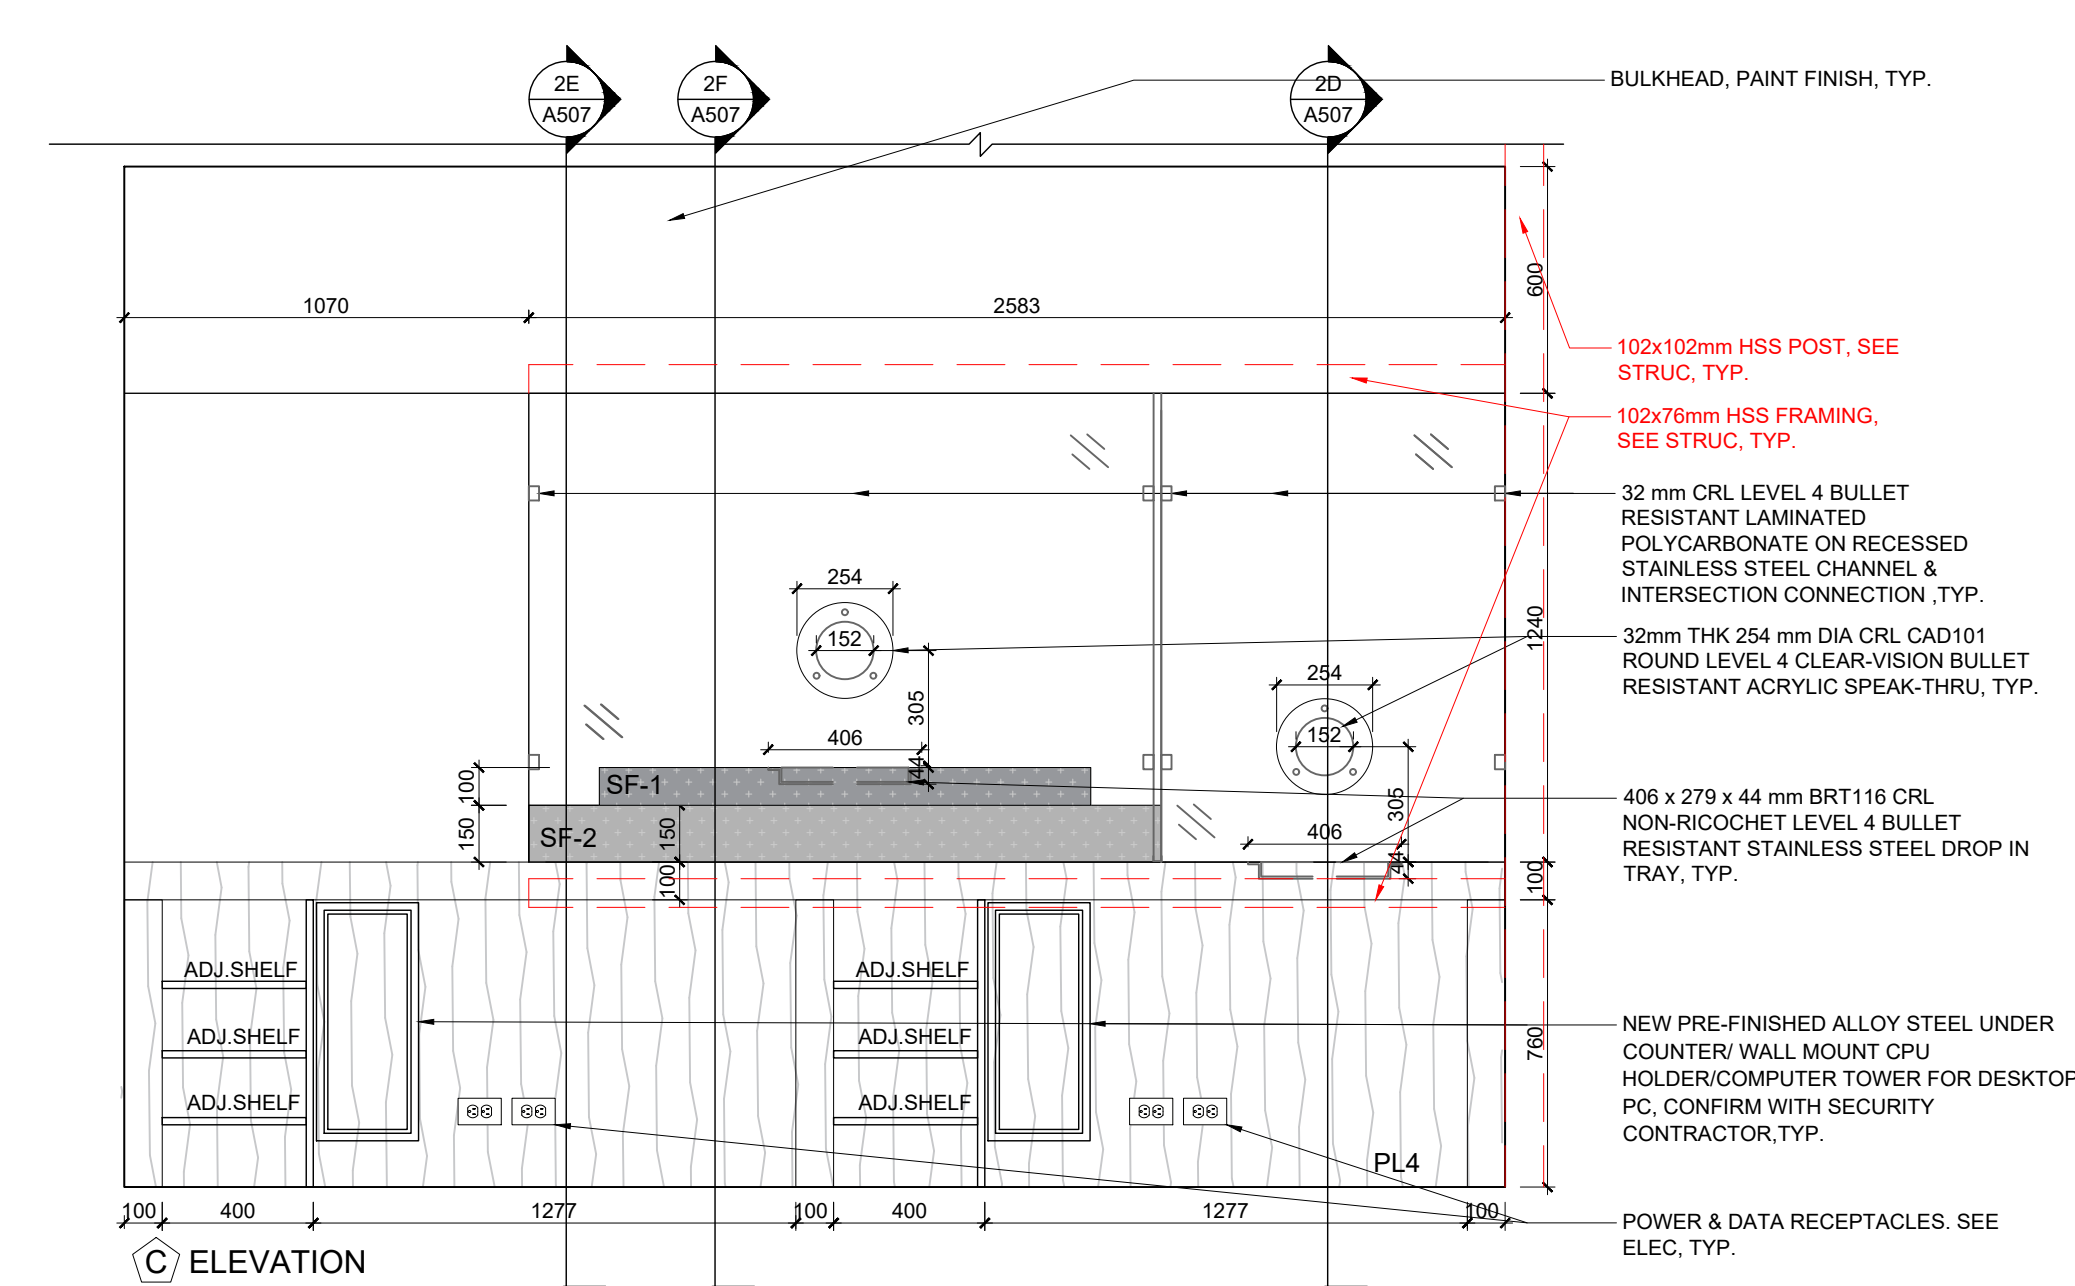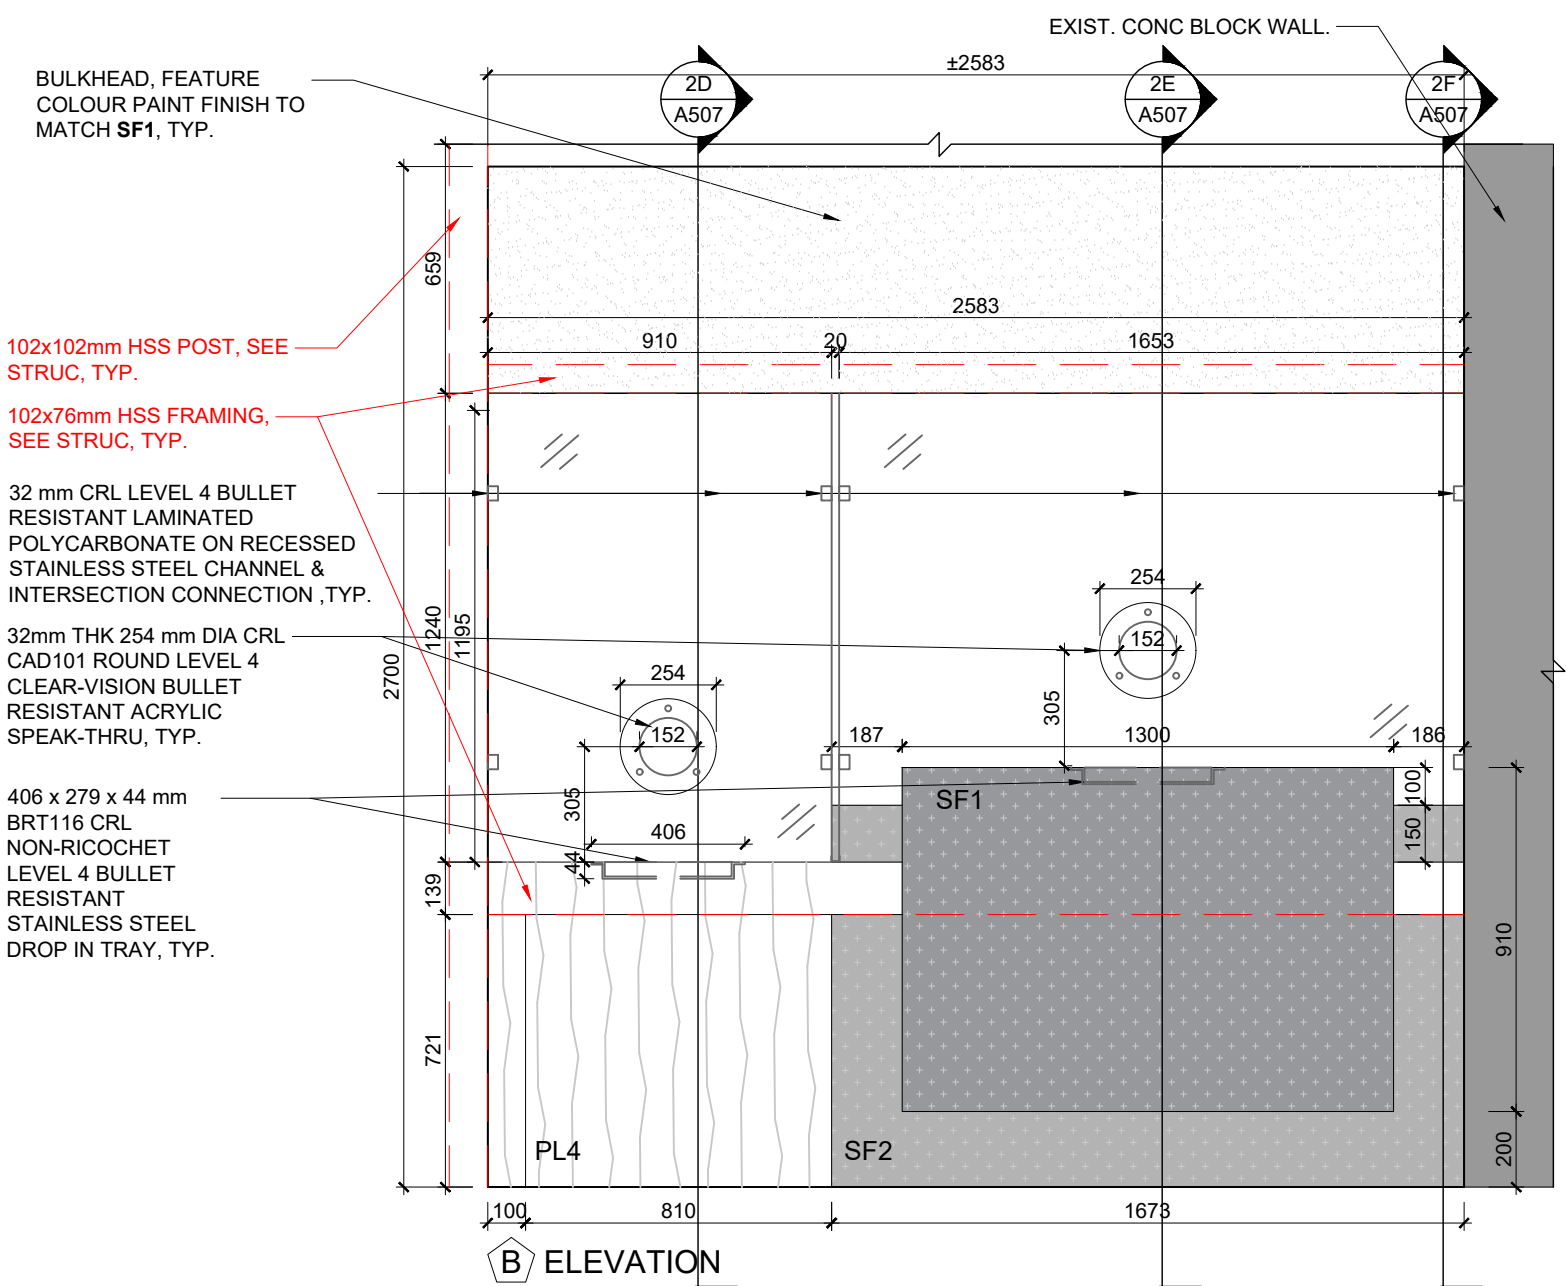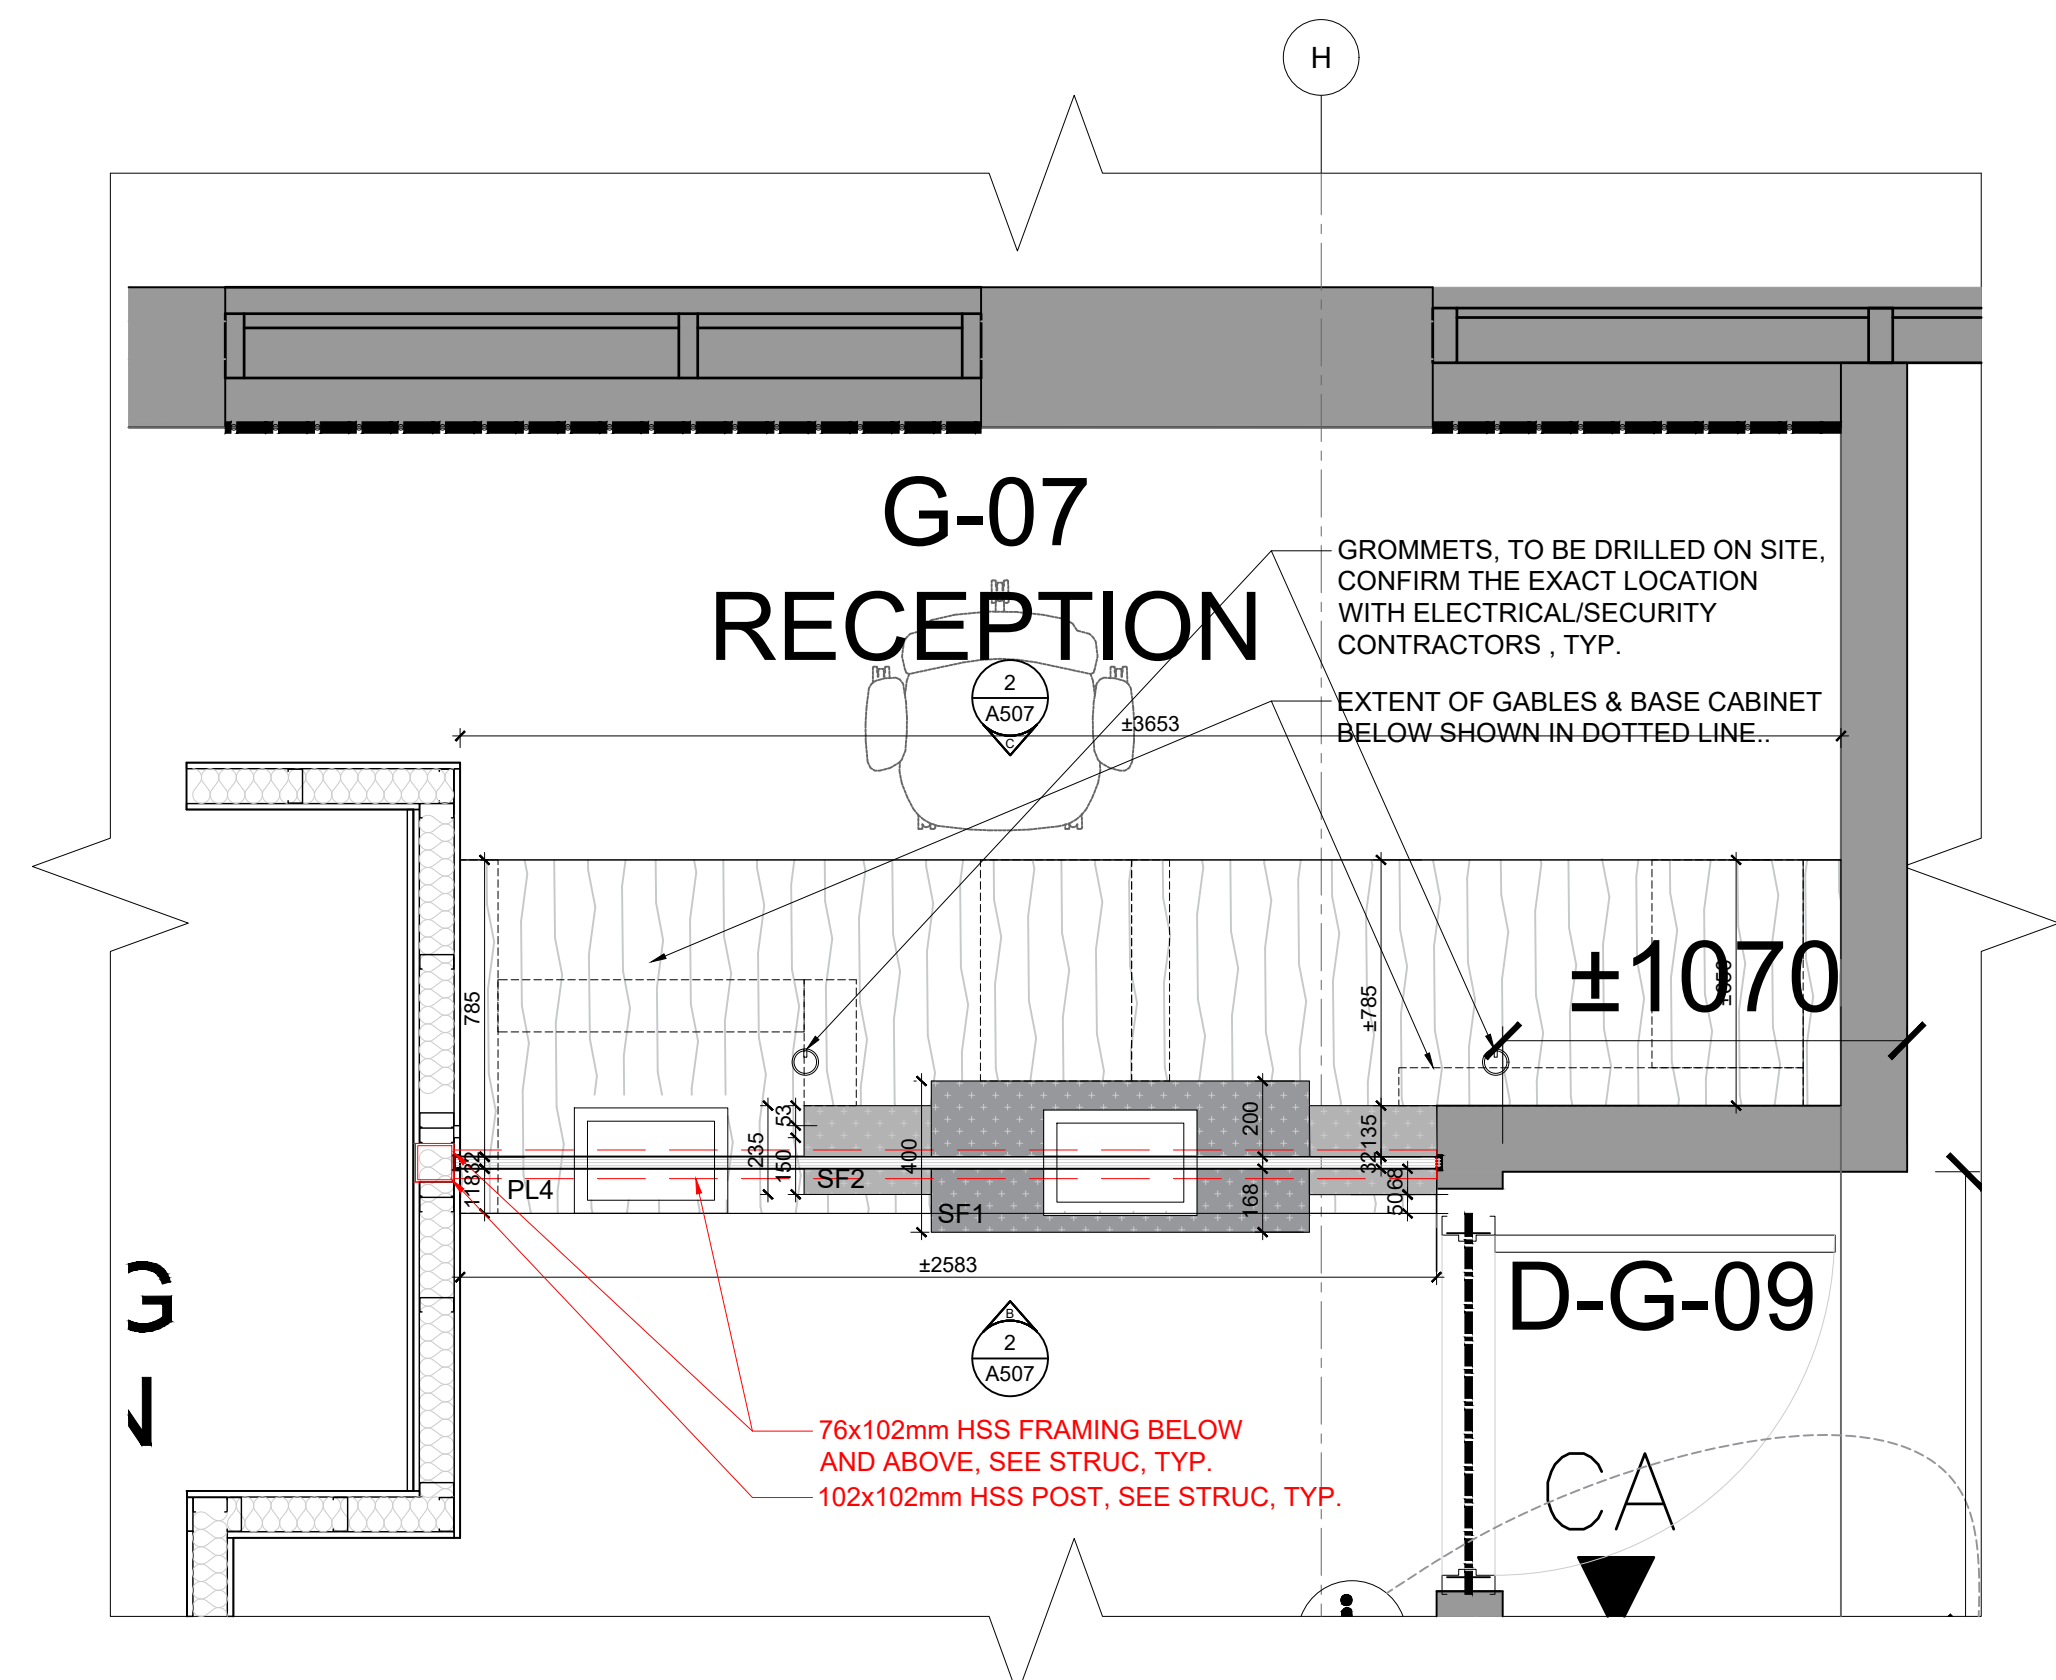

MILLWORK LEGEND	
	PL4: HIGH PRESSURE LAMINATE FINISH- COLOUR 4
	SF1: SOLID SURFACE- COLOUR 1
	SF2: SOLID SURFACE- COLOUR 2
EX	EXISTING
N.I.C.	NOT IN CONTRACT
TYP.	TYPICAL

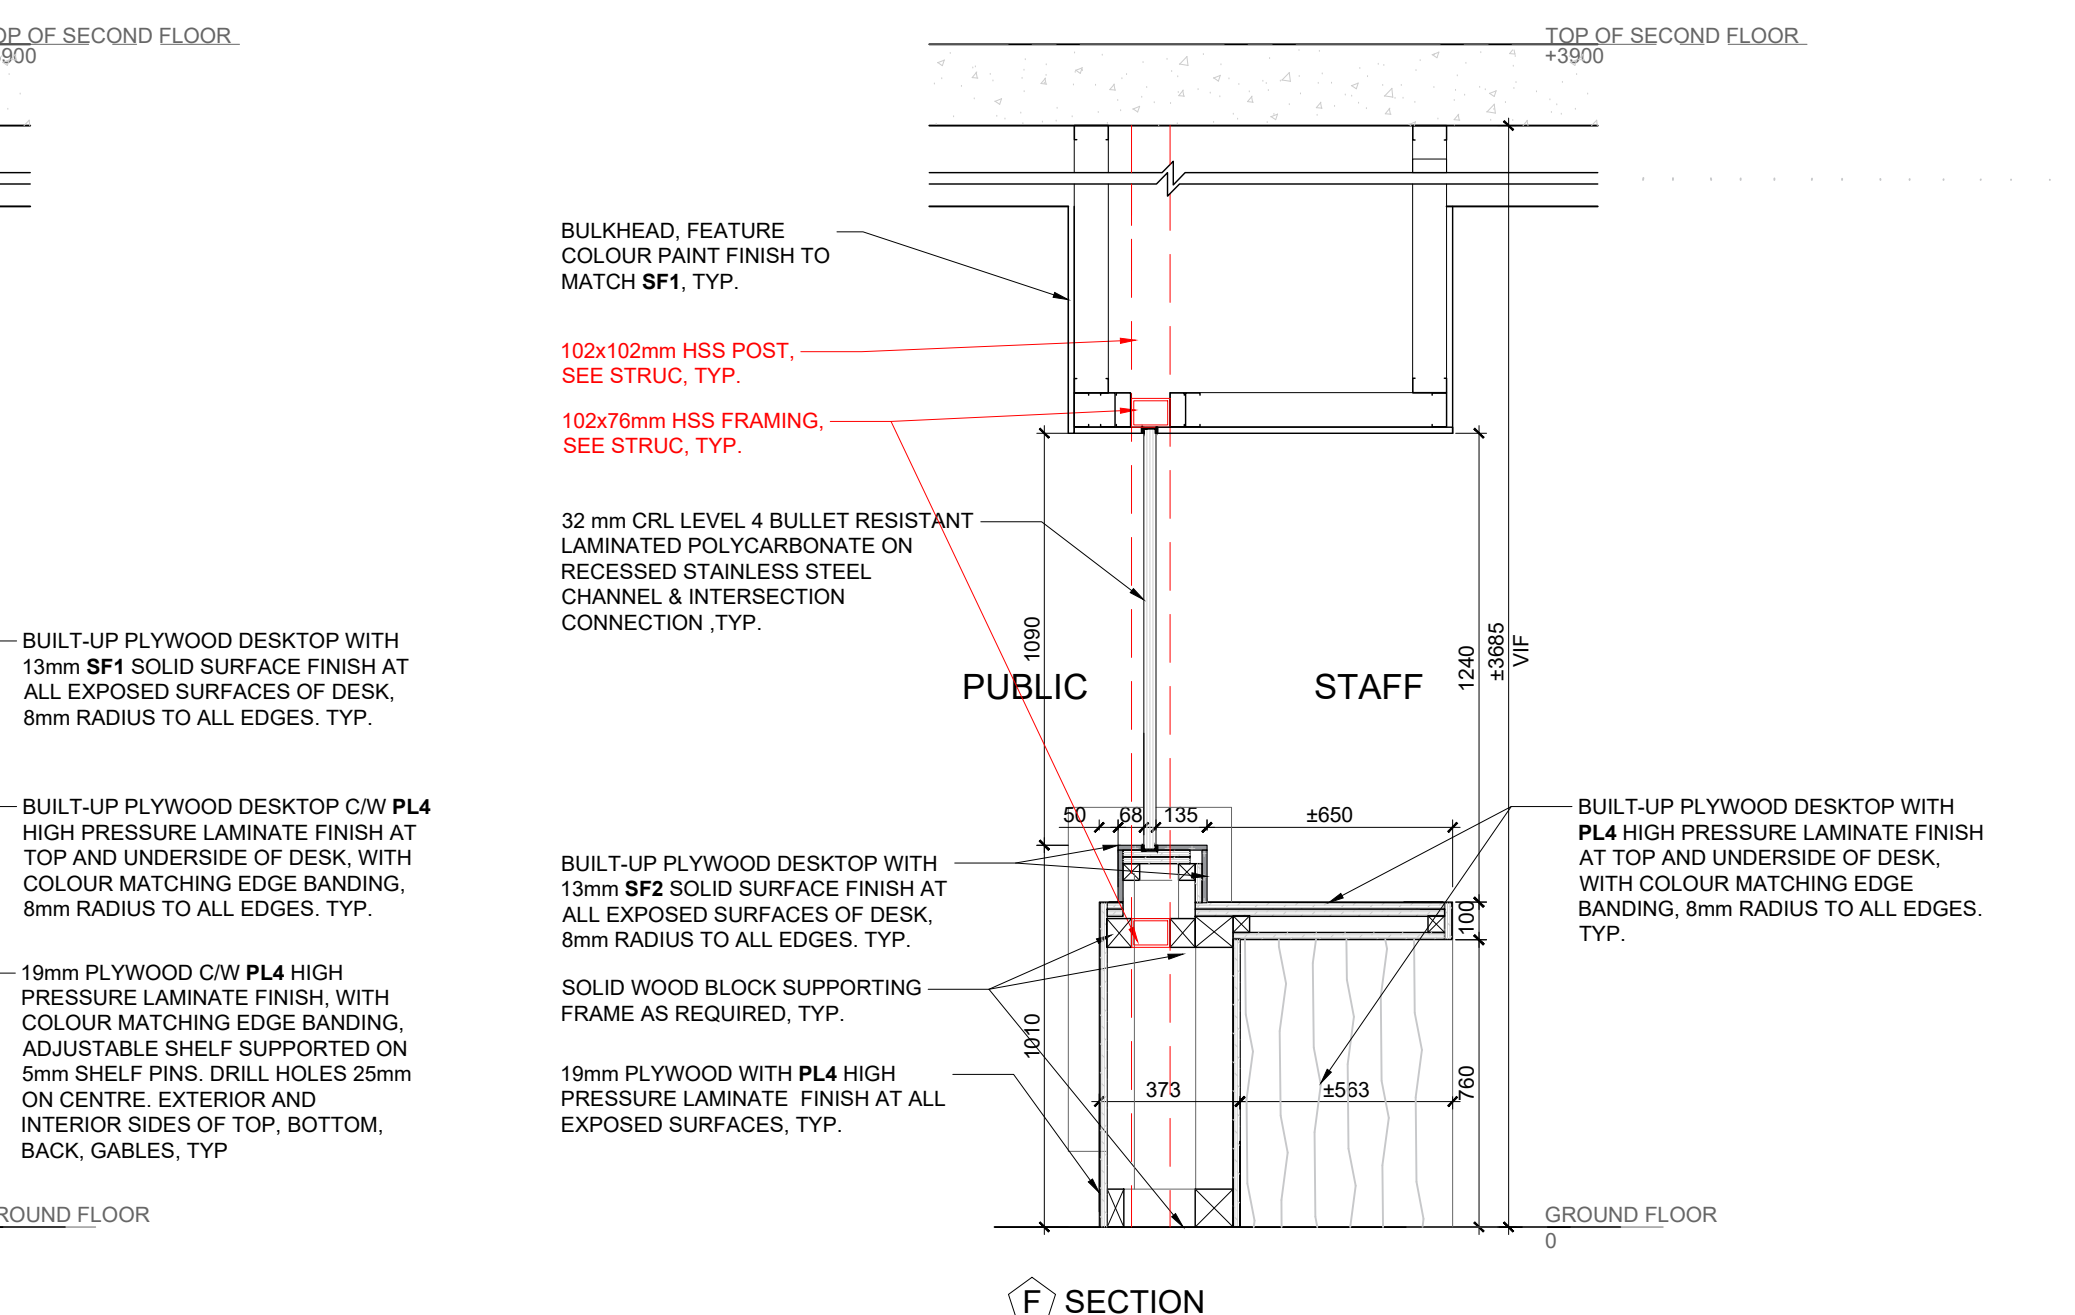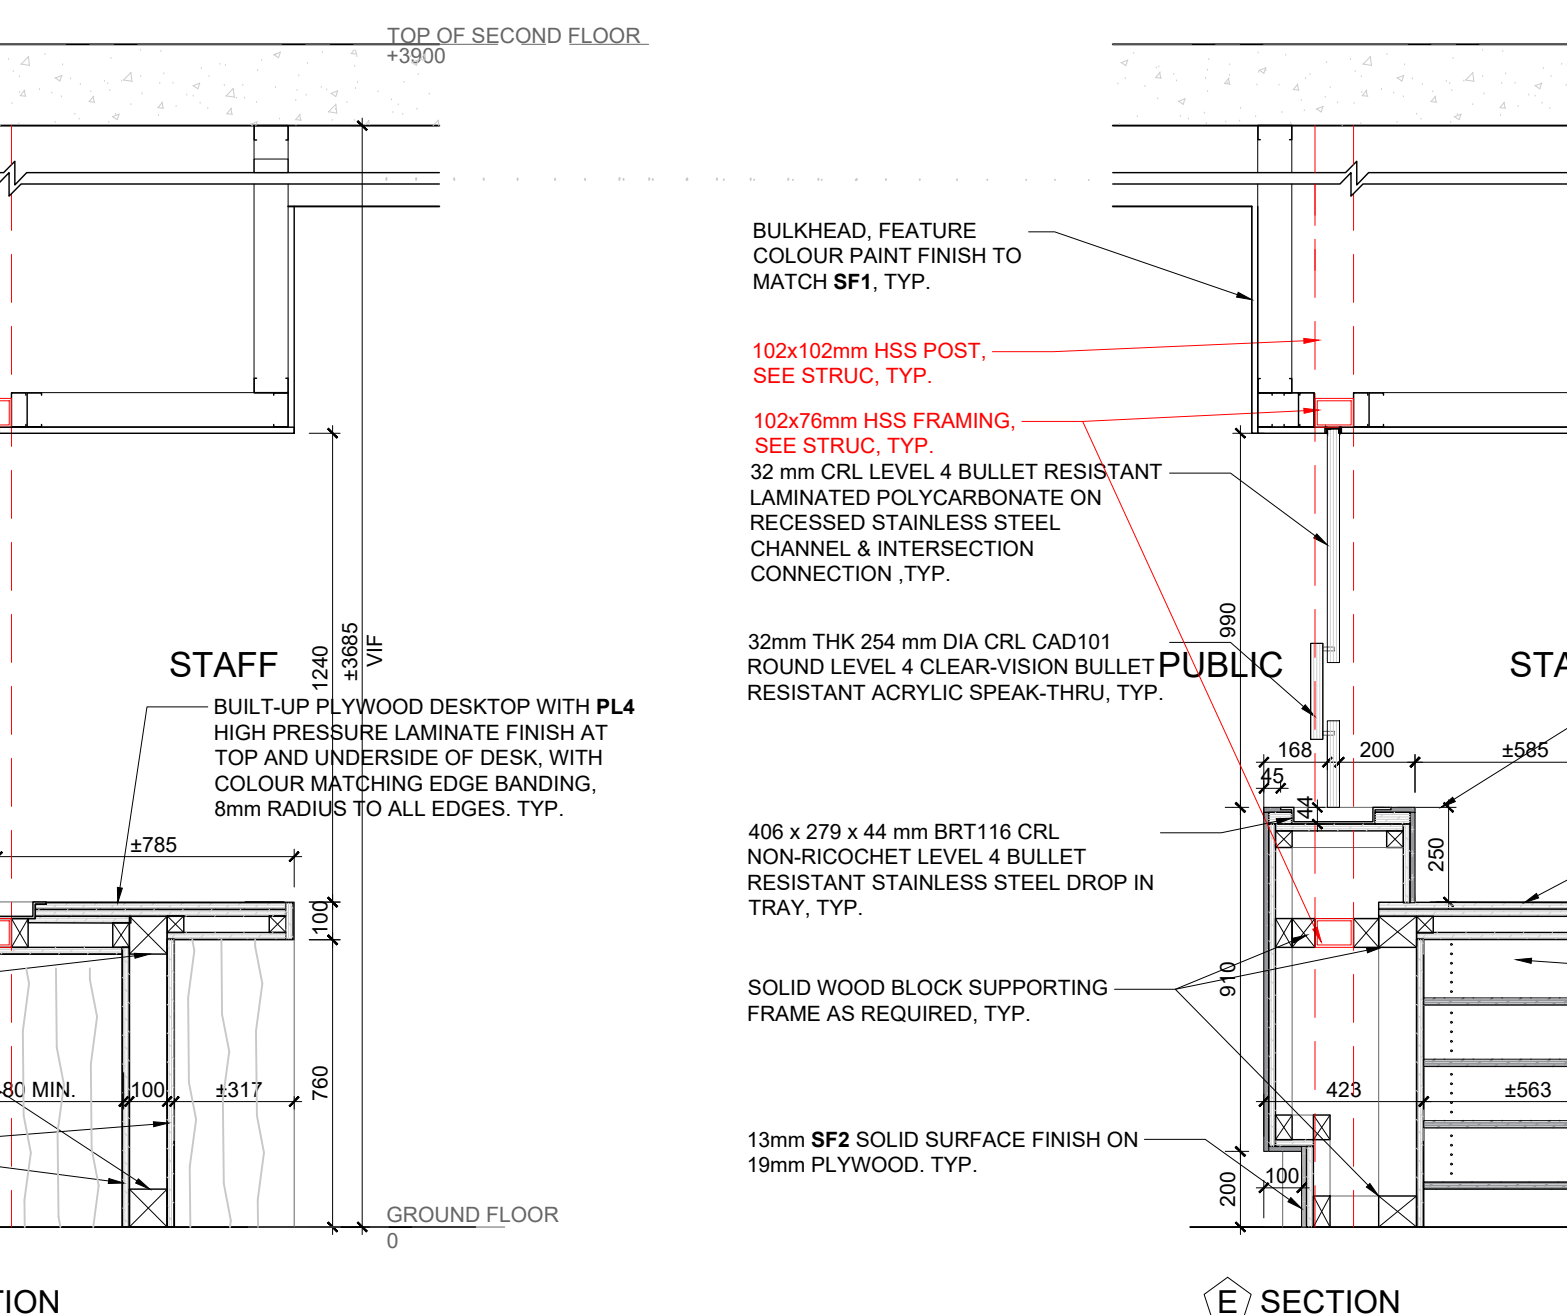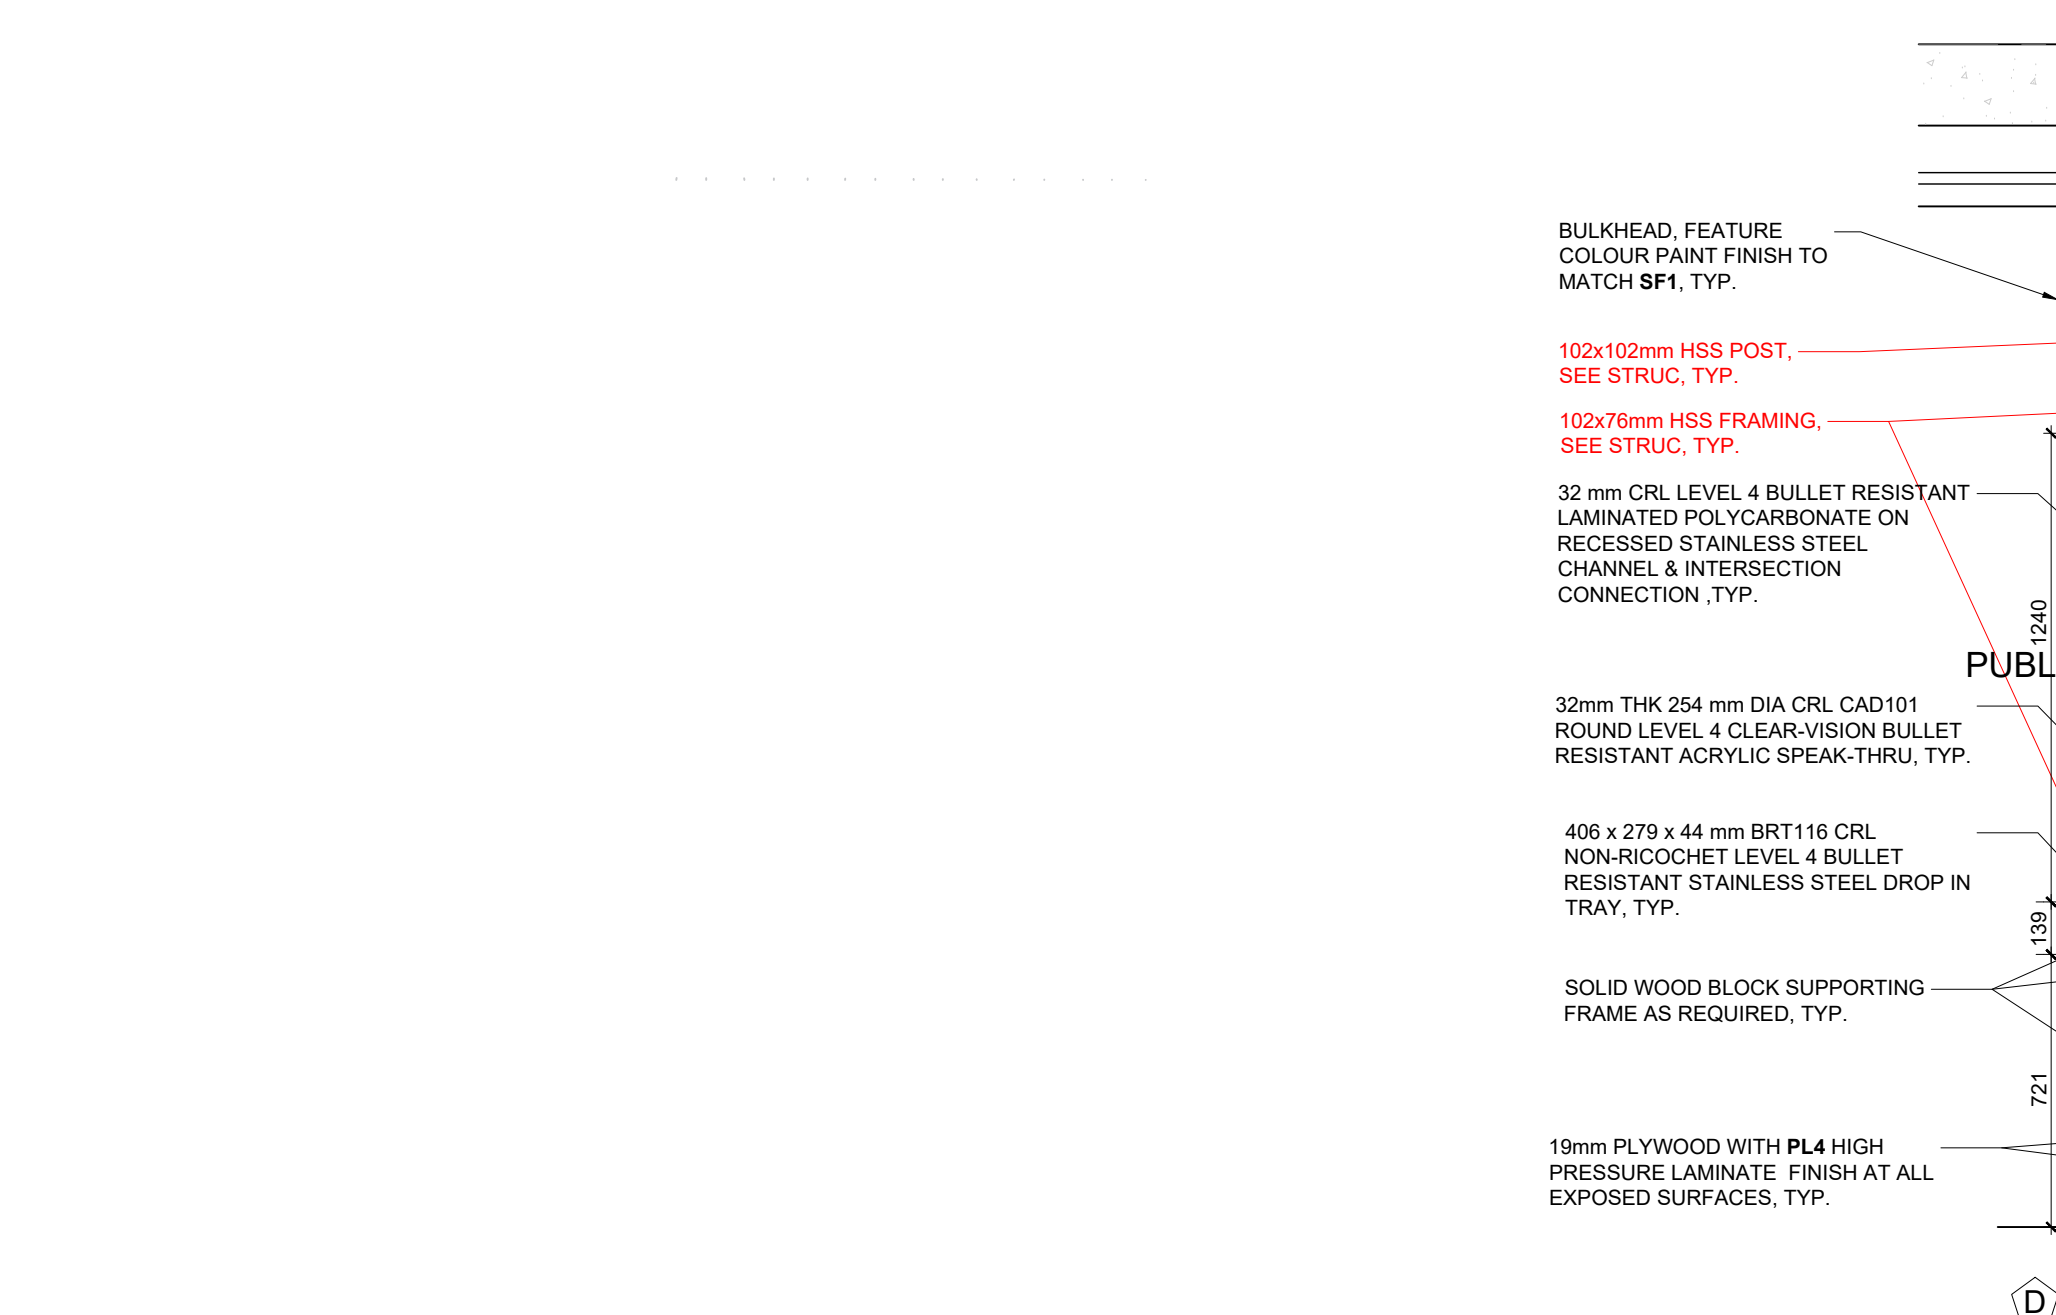

1 A507 INTERIOR ELEVATION- GROUND FLOOR RECEPTION (G-07) / MILLWORK DETAILS M-01 SCALE: 1:20

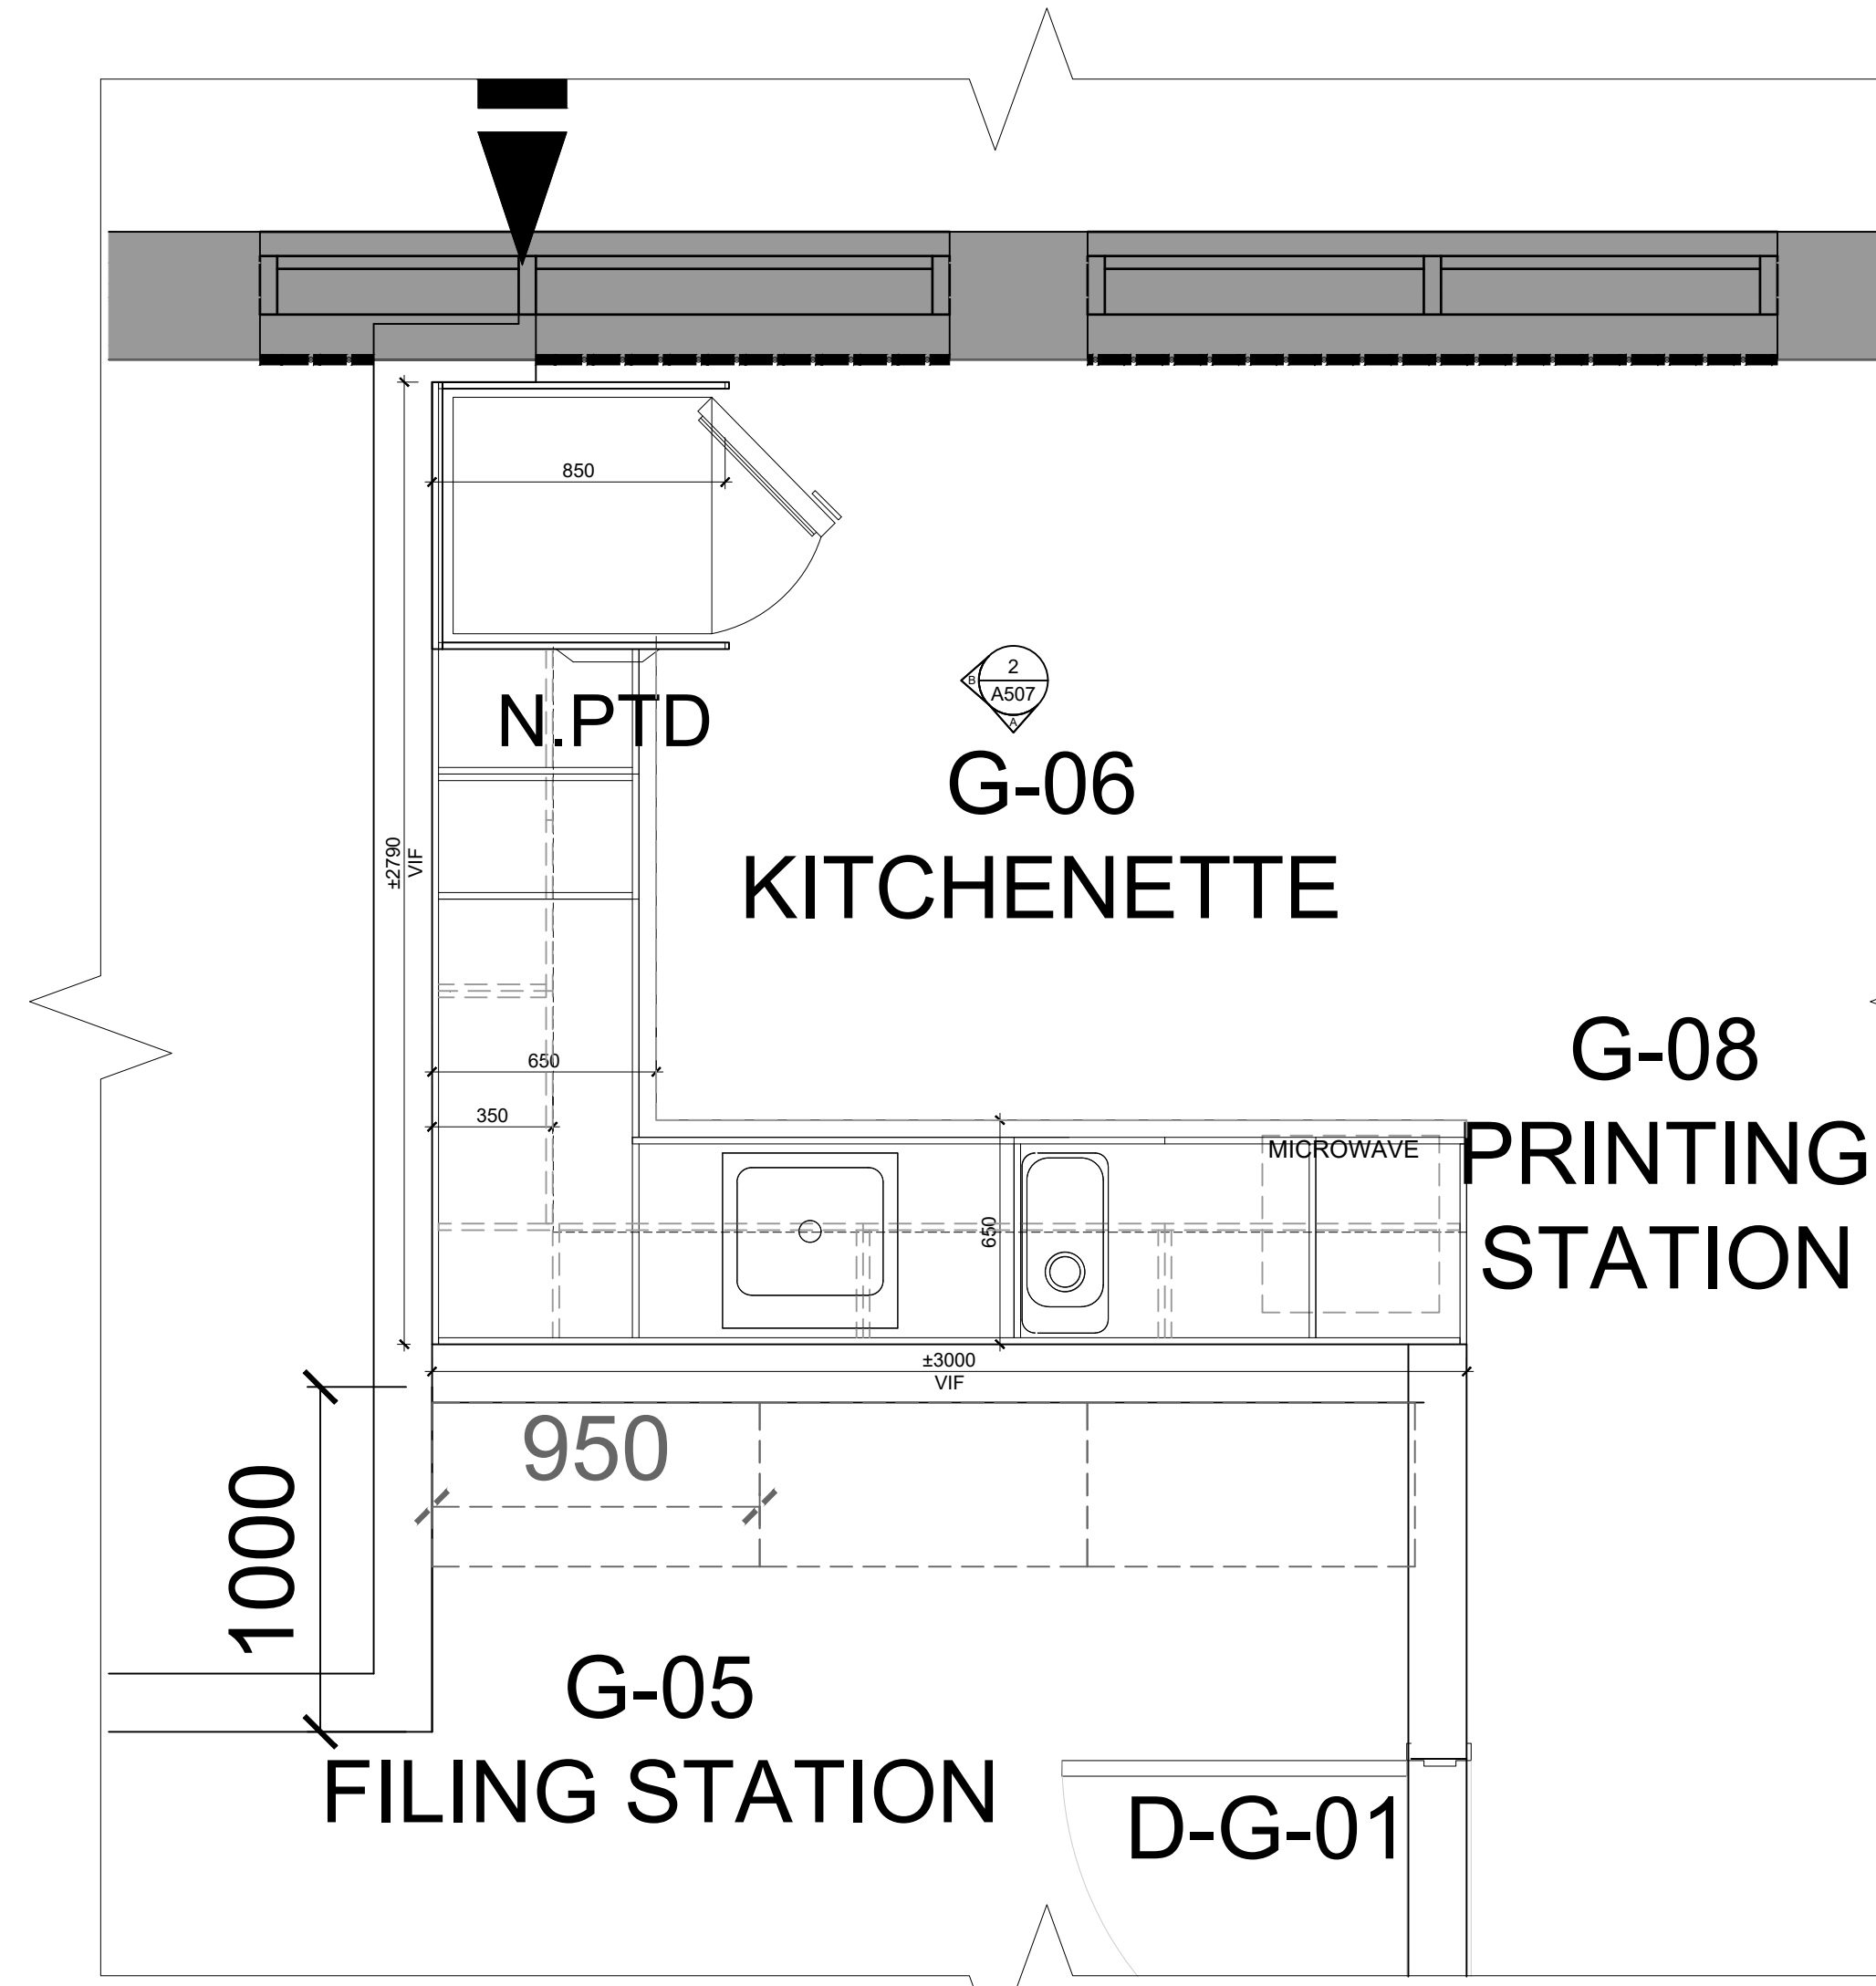

TYP. CONSTRUCTION FOR ALL KITCHEN MILLWORK:


UPPER AND LOWER CABINET GABLES, APRONS, DOORS, AND DRAWER FRONTS, CONSTRUCTED OF 19mm MDF BOARD WITH HIGH PRESSURE LAMINATE FINISH TO ALL SURFACES, TYP.

6mm HIGH PRESSURE LAMINATE FINISH MELAMINE MDF BOARD BACKING ON CONTINUOUS WOOD NAILERS, TYP.

19mm MDF BOARD ADJUSTABLE SHELF WITH HIGH PRESSURE LAMINATE FINISH, SUPPORTED ON 5mm SHELF PINS. DRILL HOLES 25mm ON CENTRE, TYP. FOR ALL CABINETS

DRAWER SIDES CONSTRUCTED OF 13mm MDF BOARD, DRAWER BOTTOMS CONSTRUCTED OF 6mm PLYWOOD, HIGH PRESSURE LAMINATE FINISH, TYP.

COUNTERTOP CONSTRUCTED OF 25mm QUARTZ FINISH SUPPORTED ON 19mm MDF BOARD BACKING, TYP.






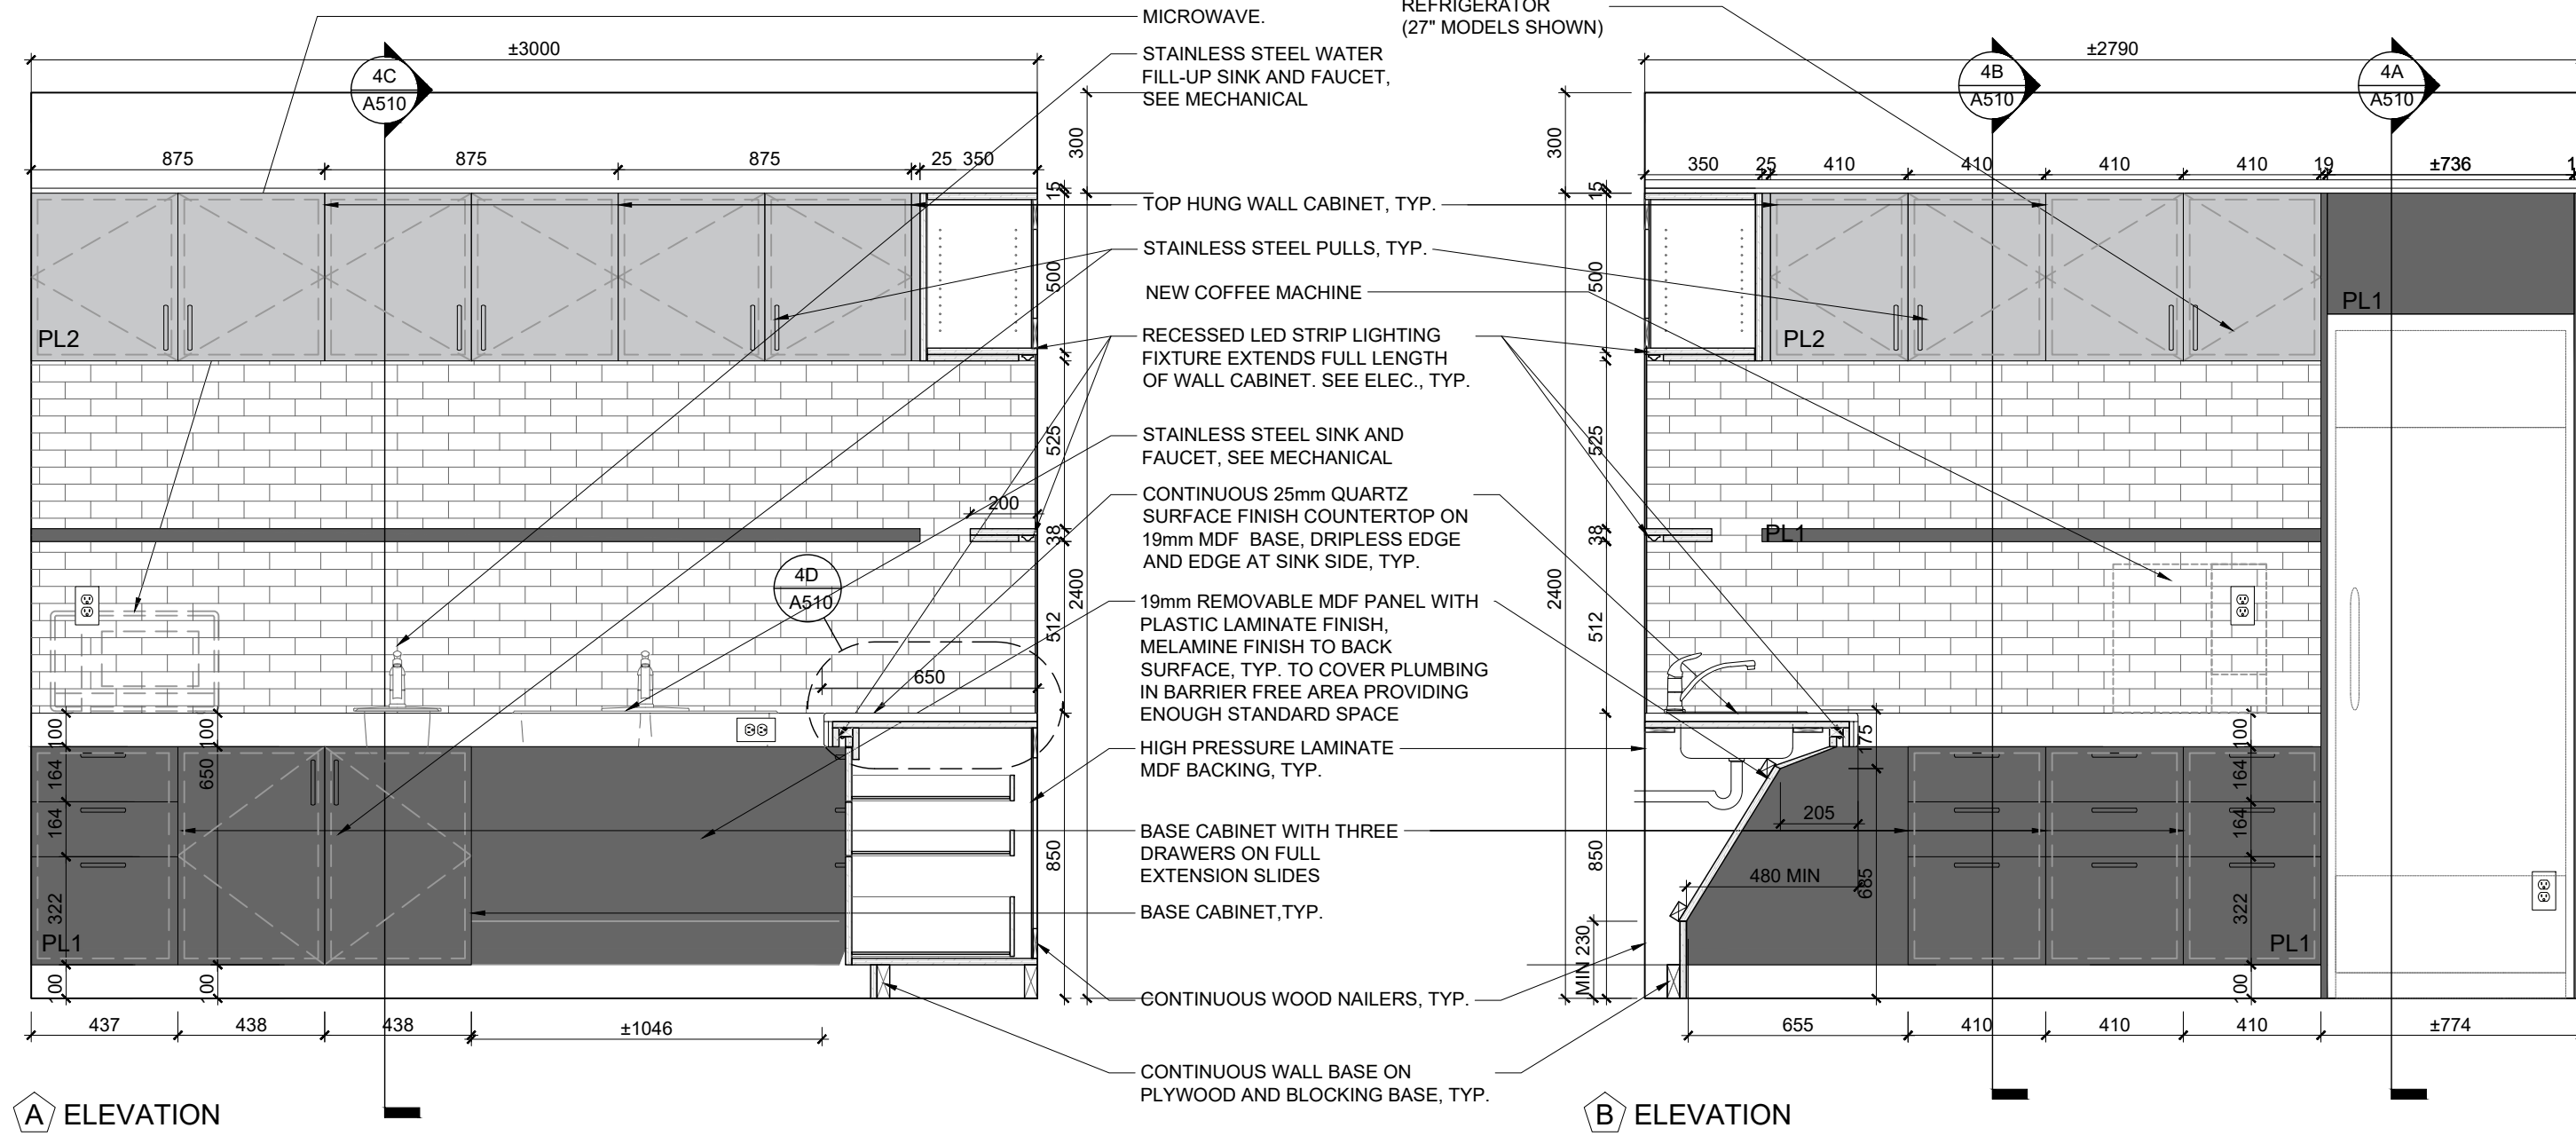


MILLWORK LEGEND	
	GLA1: 300mm x 50mm GLASS BACKSLASH TILE, RUNNING BOND
	PL1: HIGH PRESSURE LAMINATE FINISH- COLOUR 1
	PL2: HIGH PRESSURE LAMINATE FINISH- COLOUR 2
EX	EXISTING
N.I.C.	NOT IN CONTRACT
TYP.	TYPICAL

2 A507 INTERIOR ELEVATION- GROUND FLOOR KITCHENETTE (G-06) / MILLWORK DETAILS M-02 SCALE: 1:20



12.	ISSUED FOR TENDER	2026.05.01
11.	ISSUED FOR BUILDING PERMIT	2026.04.08
10.	ISSUED FOR 10% CLIENT REVIEW	2025.03.31
9.	ISSUED FOR DESIGN DEVELOPMENT CLIENT REVIEW	2025.10.28
8.	ISSUED FOR DESIGN DEVELOPMENT CLIENT REVIEW	2025.10.01
7.	ISSUED FOR PRELIMINARY DESIGN CLIENT REVIEW	2025.09.03
6.	ISSUED FOR PRELIMINARY DESIGN CLIENT REVIEW	2025.08.18
5.	ISSUED FOR PRELIMINARY DESIGN CLIENT REVIEW	2025.08.12
4.	ISSUED FOR PRELIMINARY DESIGN CLIENT REVIEW	2025.08.01
3.	ISSUED FOR PRELIMINARY DESIGN CLIENT REVIEW	2025.07.30
2.	ISSUED FOR PRELIMINARY DESIGN CLIENT REVIEW	2025.07.25
1.	ISSUED FOR PRELIMINARY DESIGN CLIENT REVIEW	2025.07.14
NO.	DESCRIPTION	DATE
REVISIONS		
PROJECT		
<p>REGION OF PEEL</p> <p>EMIL V. KOLB CENTRE PEEL REGIONAL POLICE FACILITY INTERIOR RENOVATION PROJECT 181 DERRY ROAD EAST, MISSISSAUGA, ON L5T 2Y5</p>		
<p>NGA ARCHITECTS</p> <p>The contractor shall check and verify all dimensions and report all errors and omissions to the design team prior to construction. No dimension shall be used as a basis for the design. Do not scale the drawings.</p> <p>The drawings shall not be used for construction purposes until they have been approved by the design team. Any changes to the design shall be made in writing and approved by the design team.</p>		
<p>STRUCTURAL CONSULTANT: Stephenson Engineering</p> <p>MECHANICAL CONSULTANT: EXP Services Inc.</p> <p>ELECTRICAL CONSULTANT: EXP Services Inc.</p>		
<p>SHEET TITLE: INTERIOR ELEVATIONS & MILLWORK DETAILS</p>		
SHEET NO.	DRAWN BY	CHECKED
A507	CC	RN
PROJECT NO.	SCALE	AS NOTED

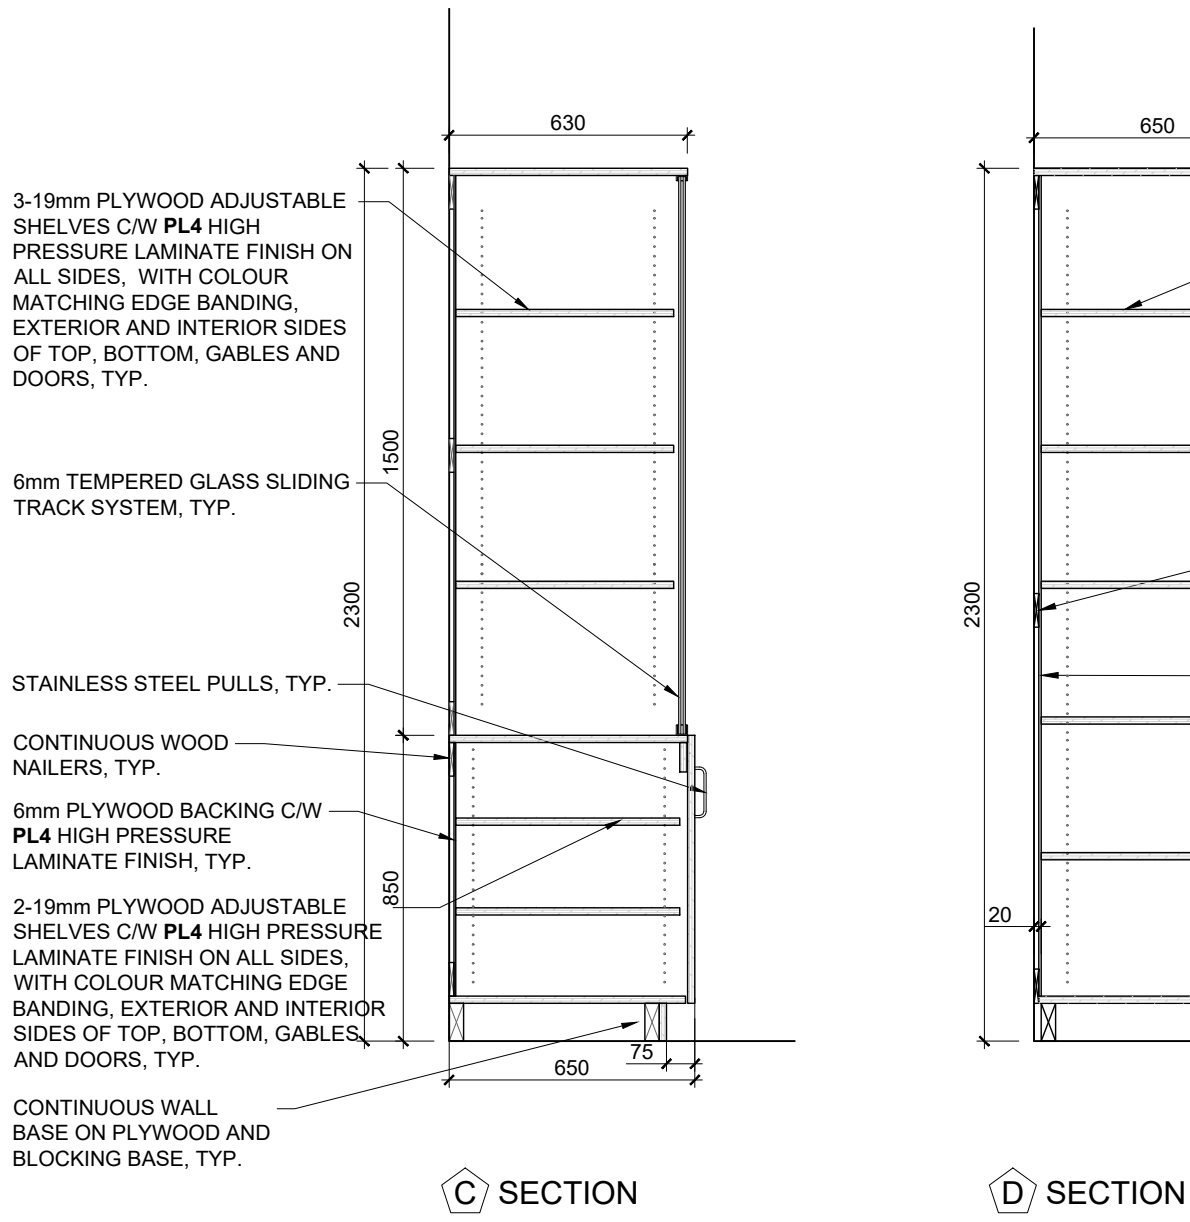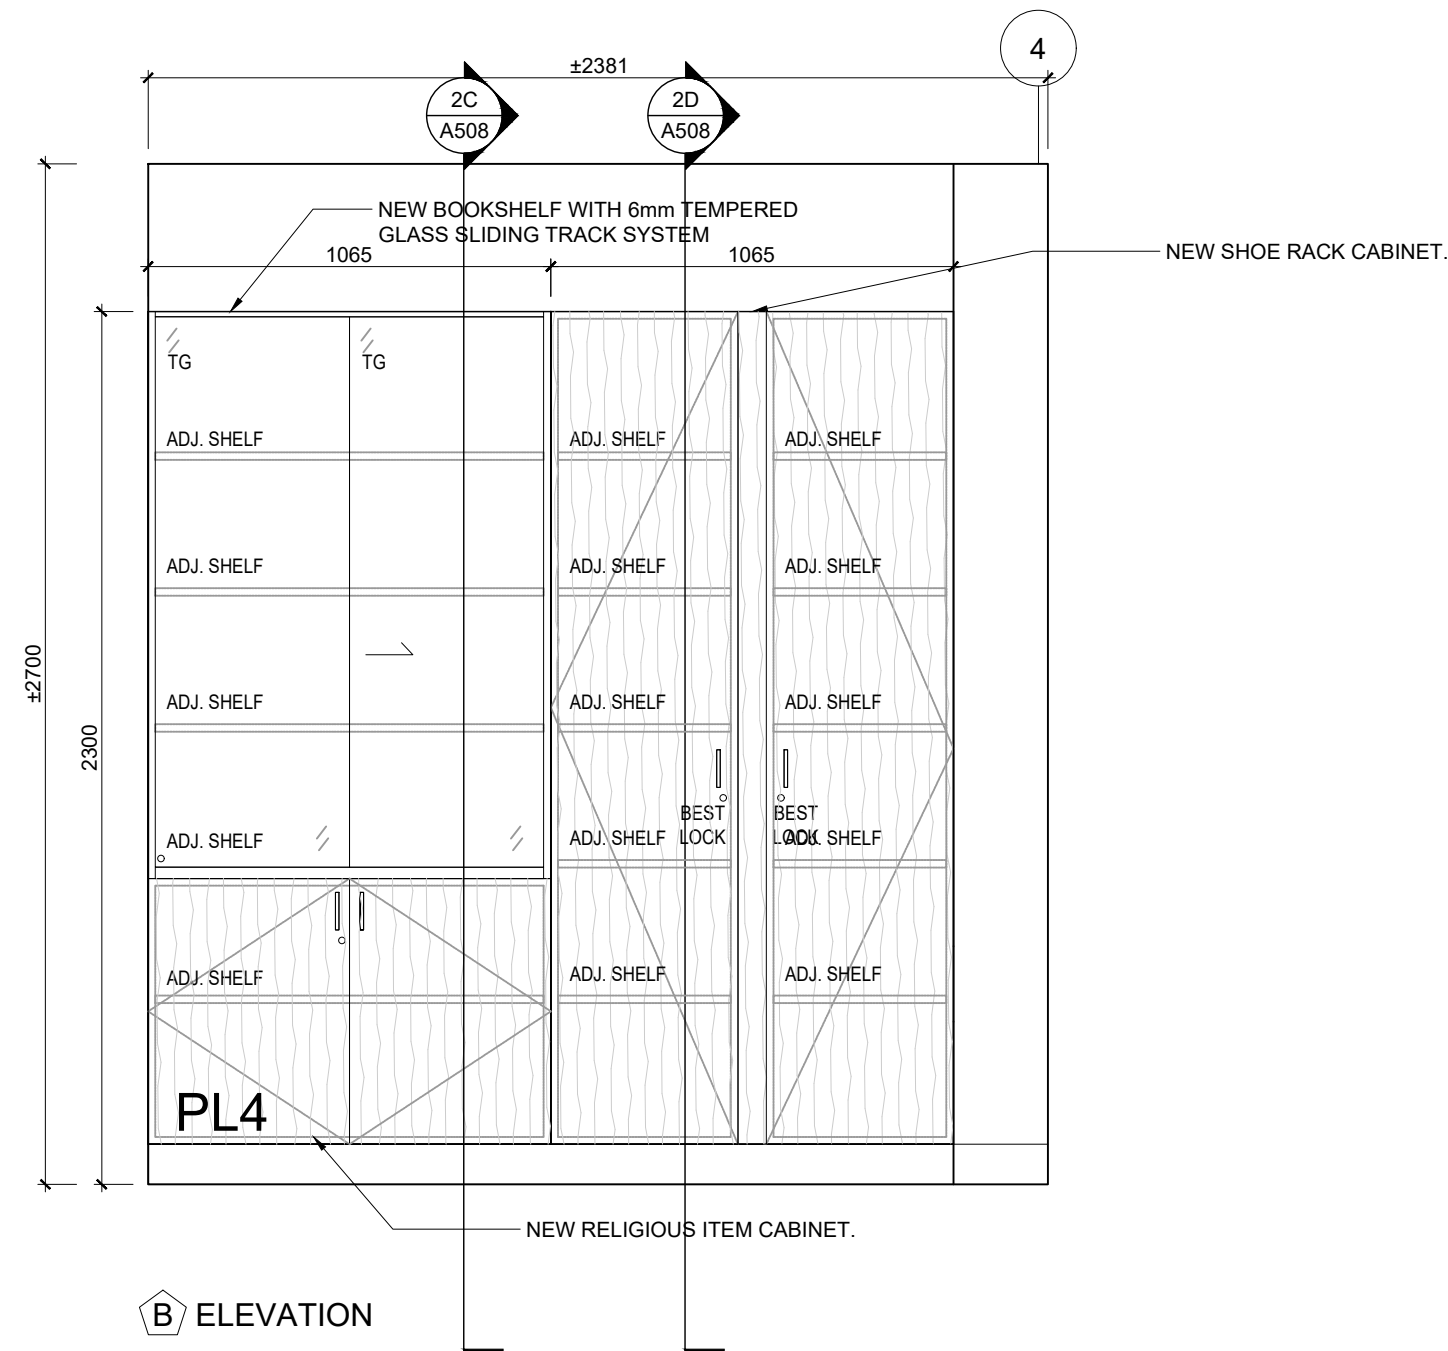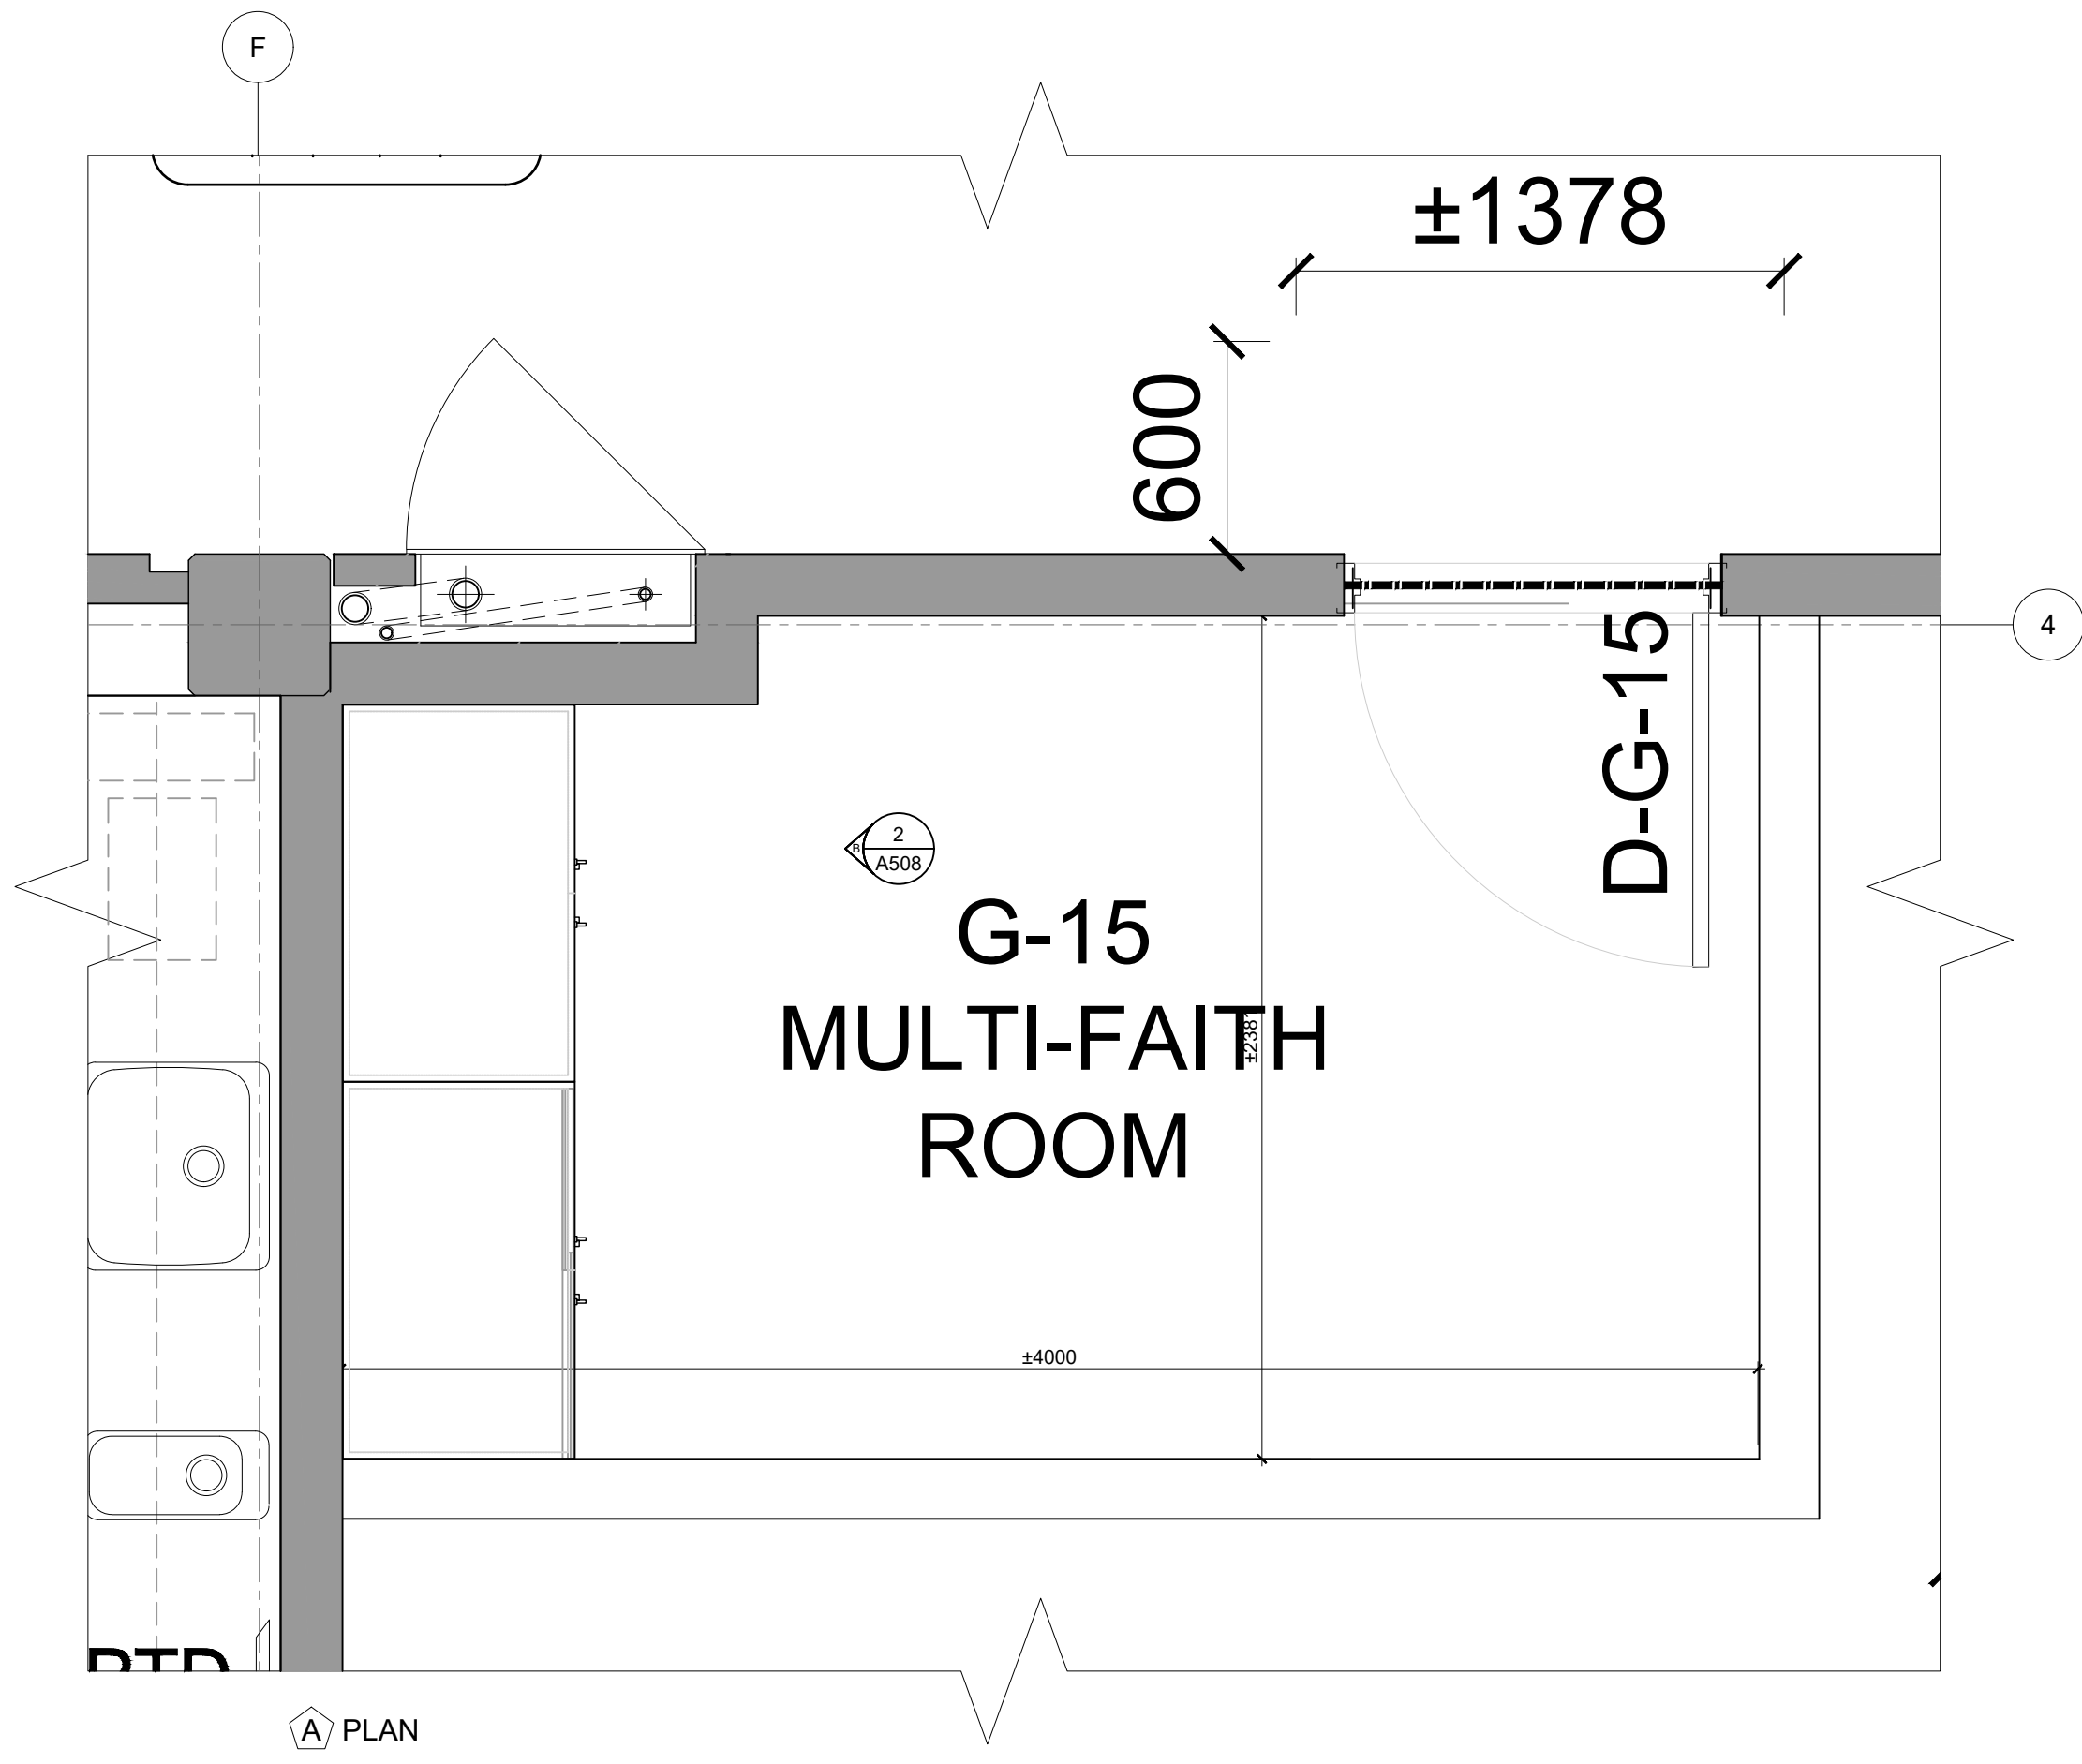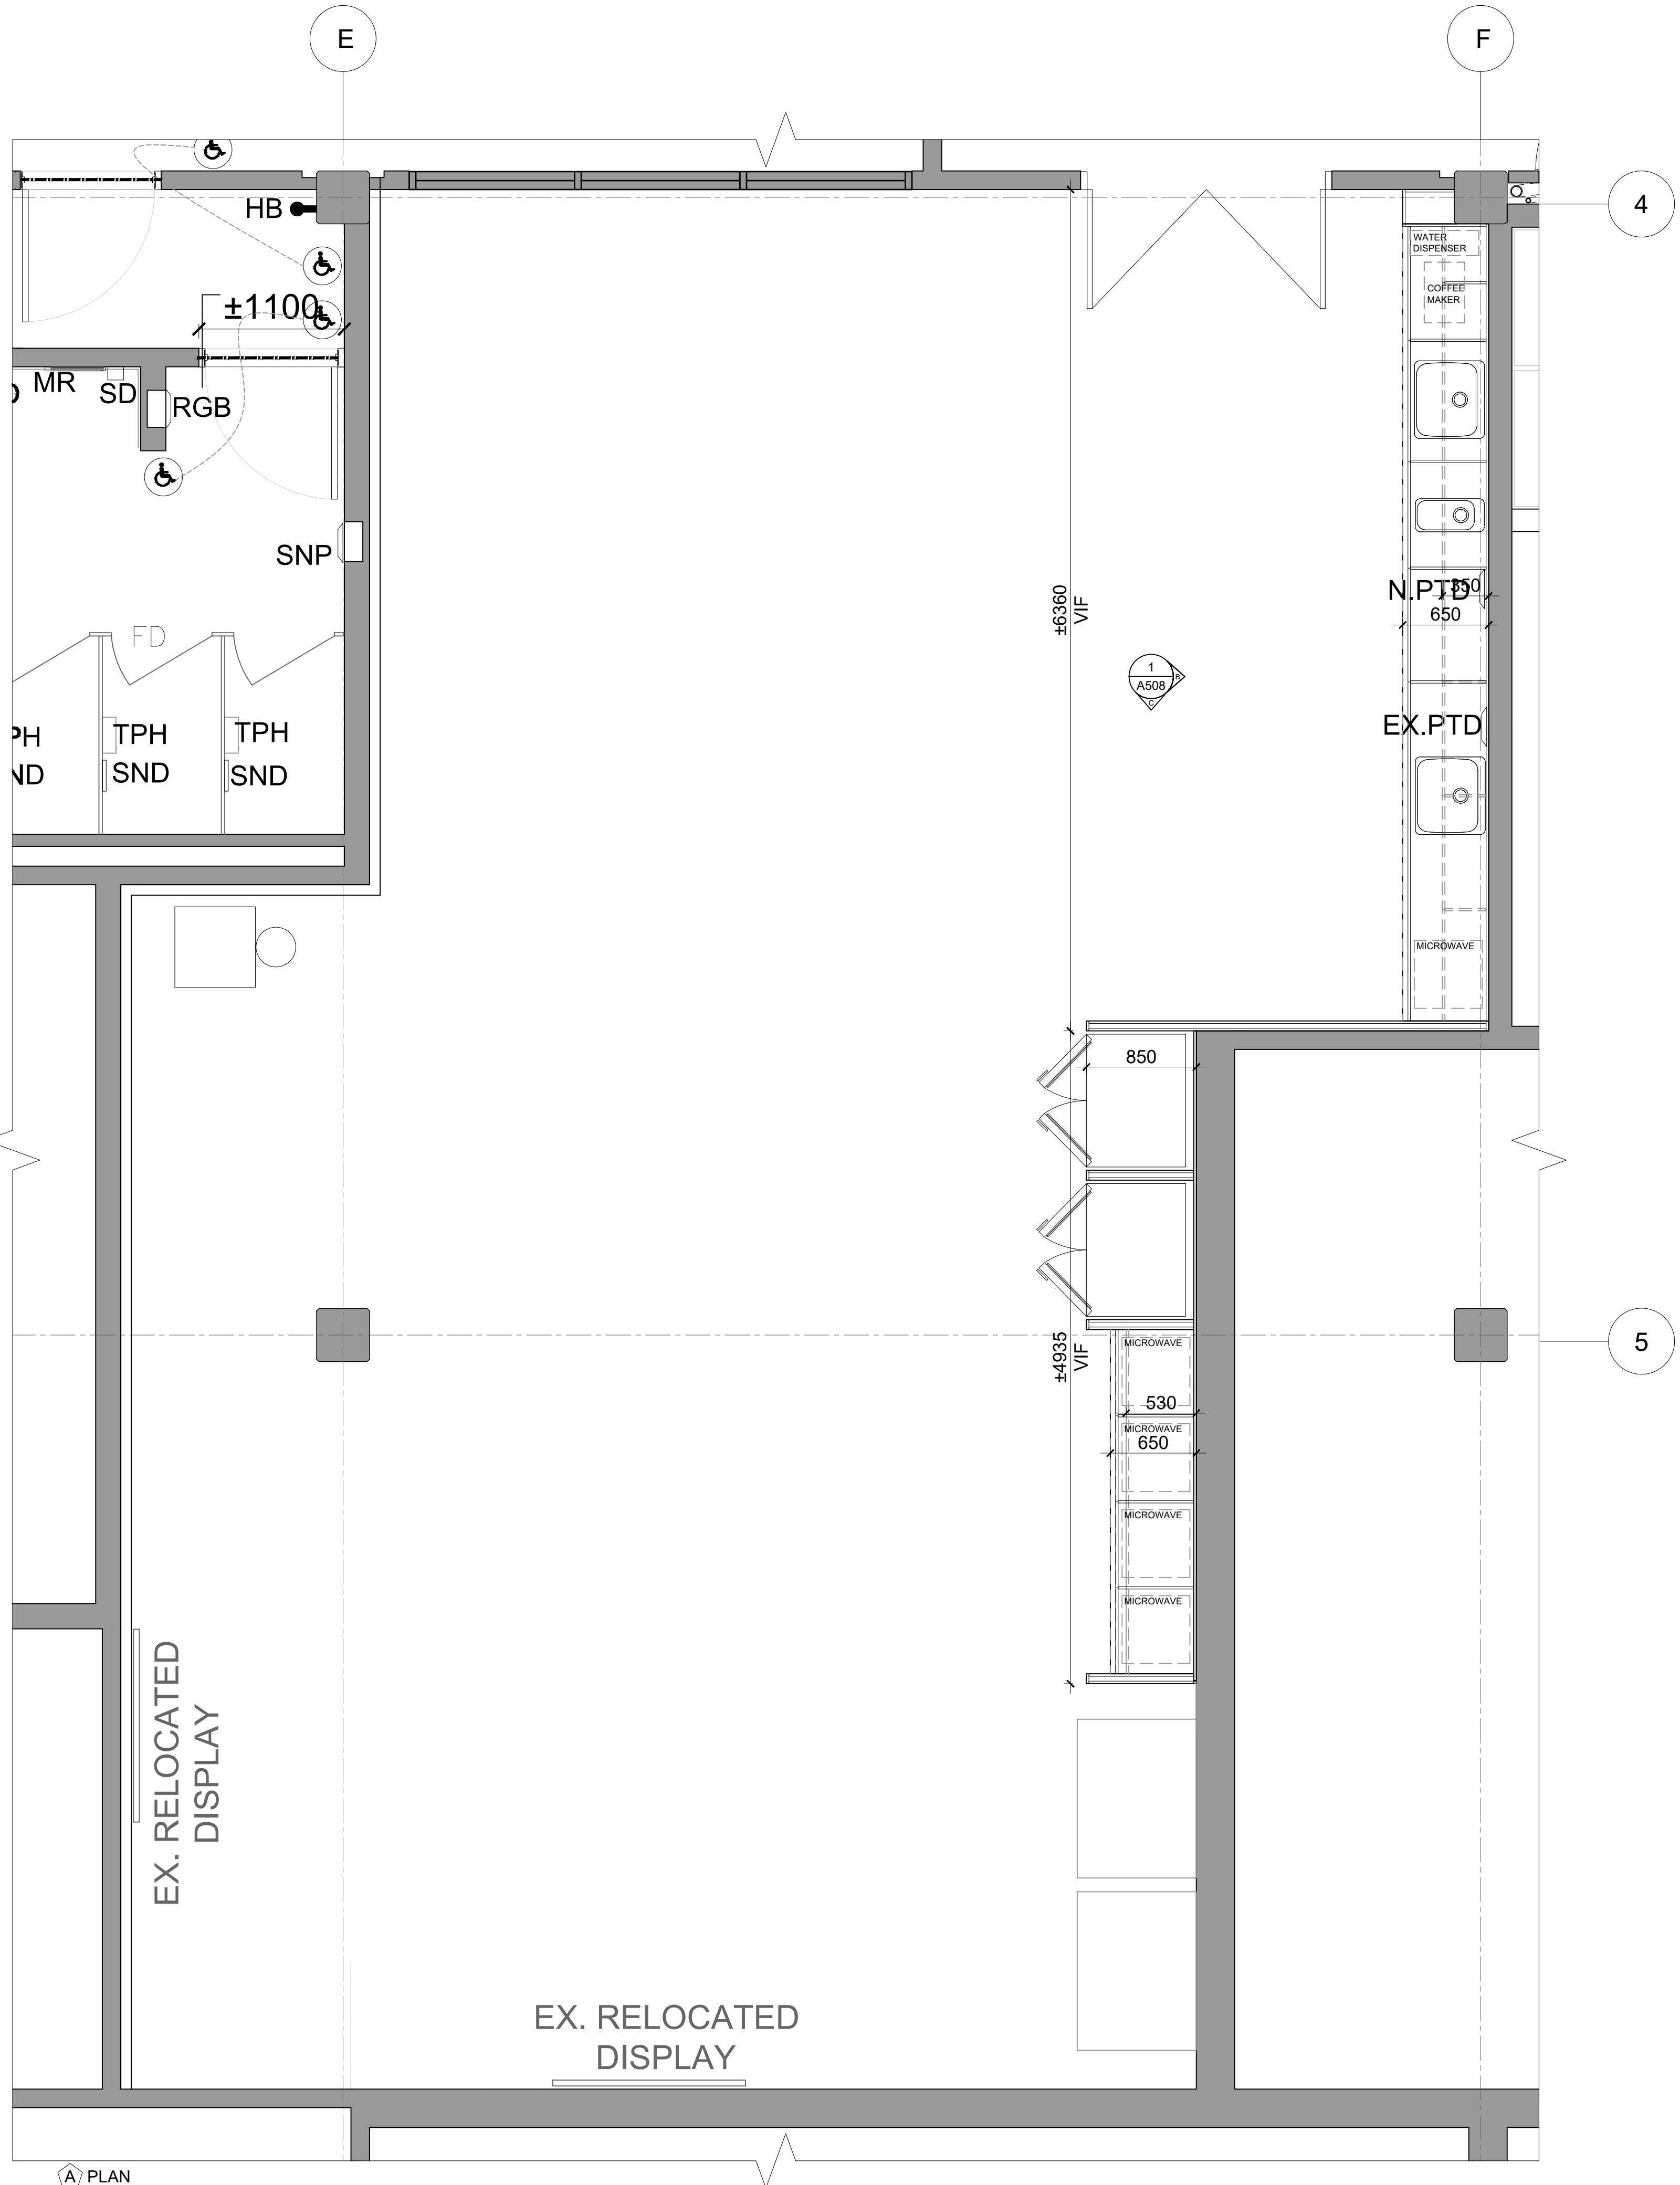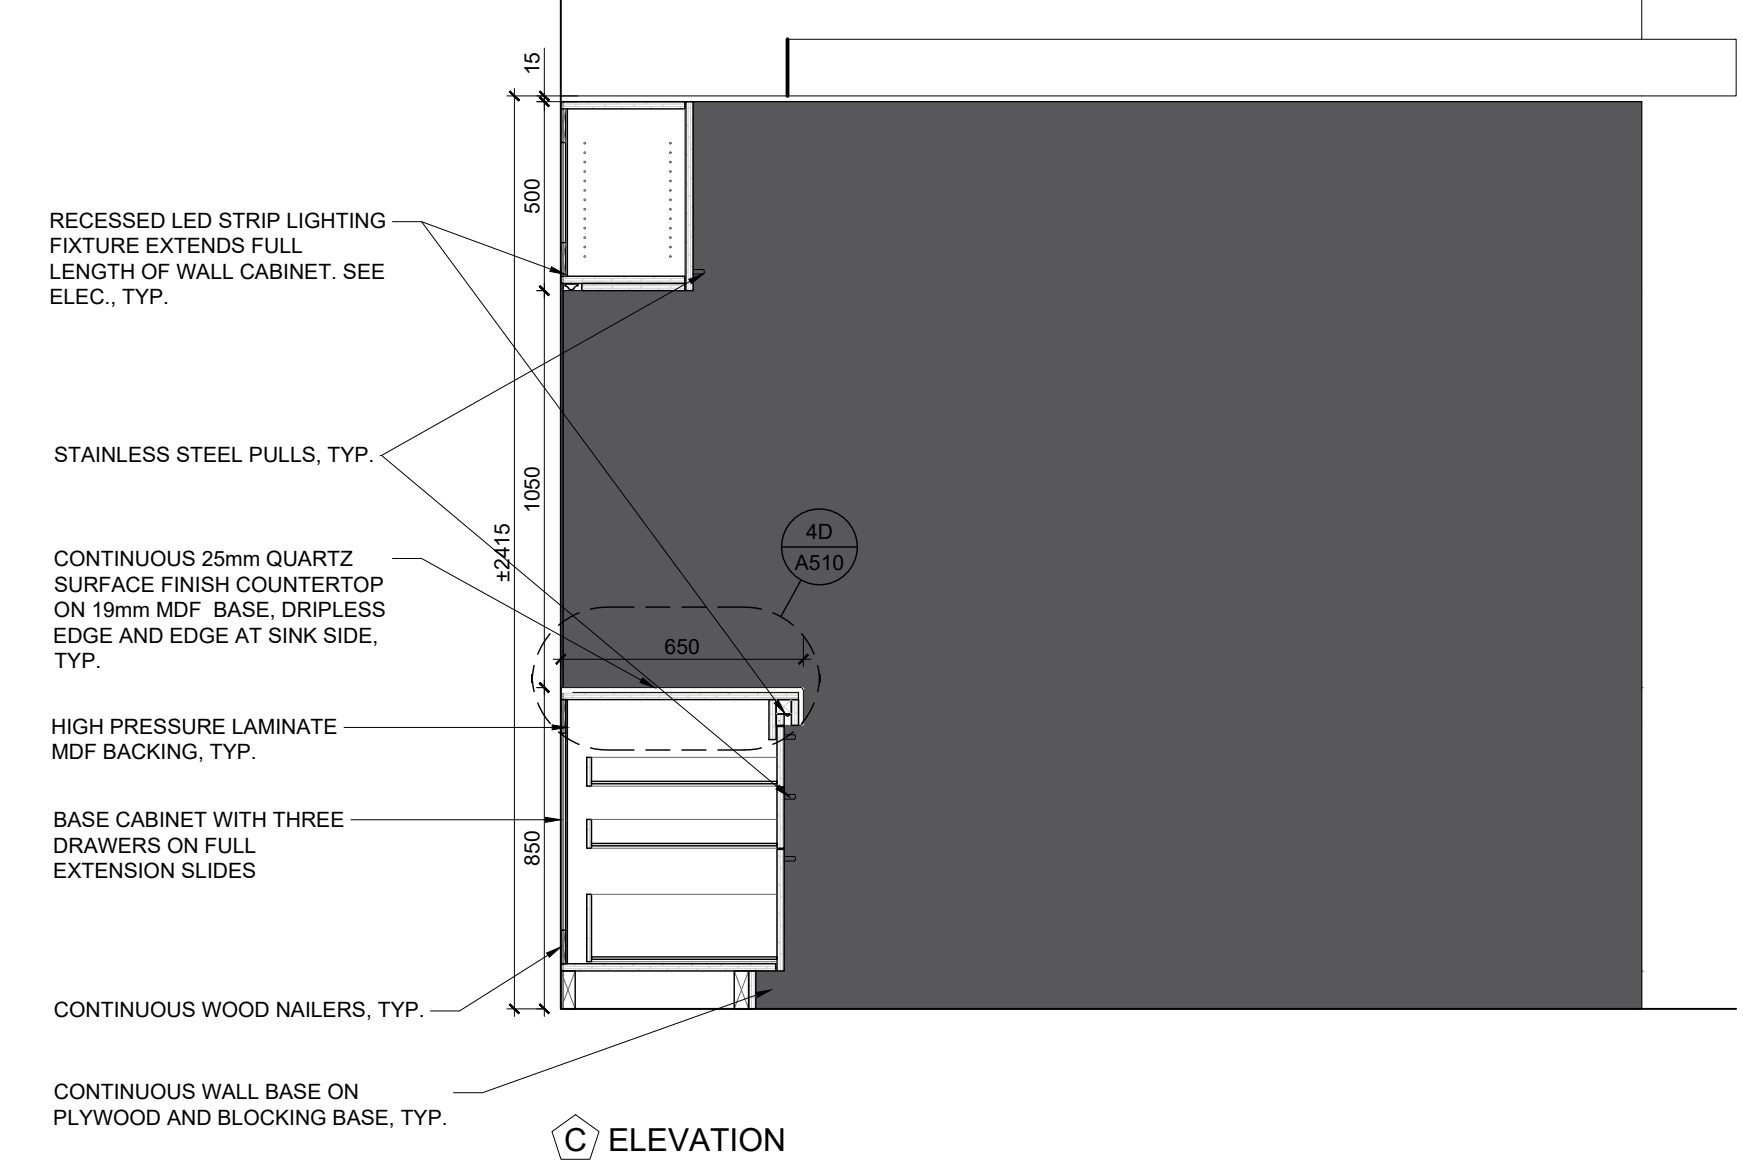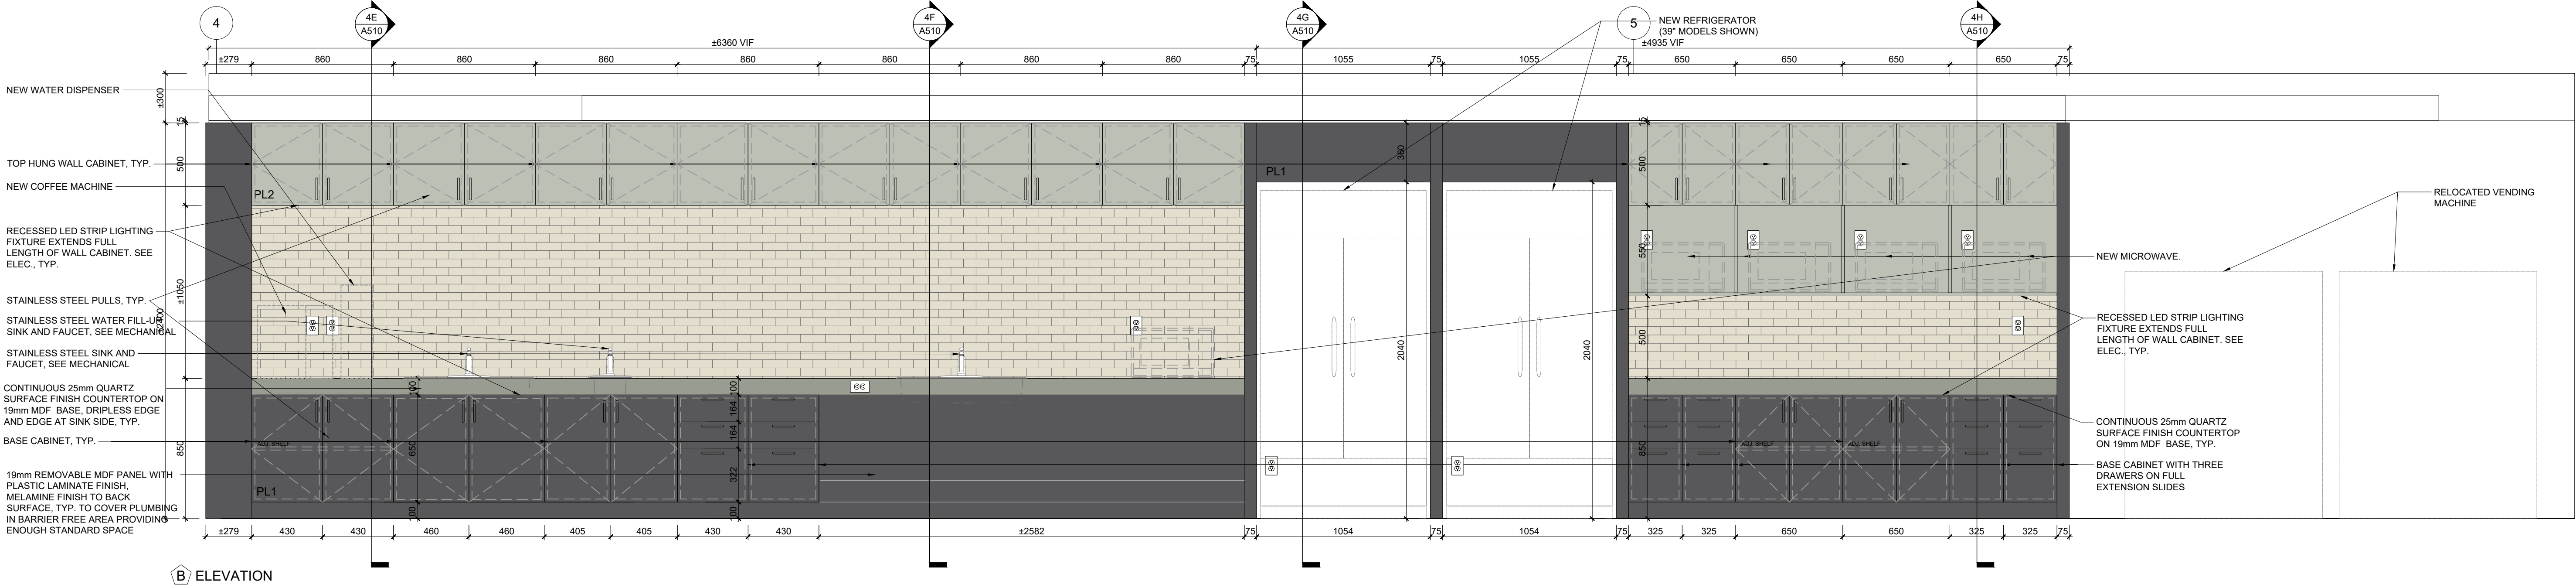
TYP. CONSTRUCTION FOR ALL KITCHEN MILLWORK:
UPPER AND LOWER CABINET GABLES, APRONS, DOORS, AND DRAWER FRONTS, CONSTRUCTED OF 19mm MDF BOARD WITH HIGH PRESSURE LAMINATE FINISH TO ALL SURFACES, TYP.
6mm HIGH PRESSURE LAMINATE FINISH MELAMINE MDF BOARD BACKING ON CONTINUOUS WOOD NAILERS, TYP.
19mm MDF BOARD ADJUSTABLE SHELF WITH HIGH PRESSURE LAMINATE FINISH, SUPPORTED ON 5mm SHELF PINS, DRILL HOLES 25mm ON CENTRE, TYP. FOR ALL CABINETS
DRAWER SIDES CONSTRUCTED OF 13mm MDF BOARD, DRAWER BOTTOMS CONSTRUCTED OF 6mm PLYWOOD, HIGH PRESSURE LAMINATE FINISH, TYP.
COUNTERTOP CONSTRUCTED OF 25mm QUARTZ FINISH SUPPORTED ON 19mm MDF BOARD BACKING, TYP.





MILLWORK LEGEND	
GLA1: 300mm X 50mm GLASS BACKSPLASH TILE, RUNNING BOND	
PL1: HIGH PRESSURE LAMINATE FINISH- COLOUR 1	
PL2: HIGH PRESSURE LAMINATE FINISH- COLOUR 2	
EX.	EXISTING
N.I.C.	NOT IN CONTRACT
TYP.	TYPICAL

MILLWORK LEGEND	
PL4: HIGH PRESSURE LAMINATE FINISH- COLOUR 4	
SP1: SOLID SURFACE- COLOUR 1	
SP2: SOLID SURFACE- COLOUR 2	
EX.	EXISTING
N.I.C.	NOT IN CONTRACT
TYP.	TYPICAL

12. ISSUED FOR TENDER	2026.05.01
11. ISSUED FOR BUILDING PERMIT	2026.04.08
10. ISSUED FOR ITEM CLIENT REVIEW	2026.03.31
9. ISSUED FOR DESIGN DEVELOPMENT CLIENT REVIEW	2025.10.28
8. ISSUED FOR DESIGN DEVELOPMENT CLIENT REVIEW	2025.10.01
7. ISSUED FOR PRELIMINARY DESIGN CLIENT REVIEW	2025.09.03
6. ISSUED FOR PRELIMINARY DESIGN CLIENT REVIEW	2025.08.18
5. ISSUED FOR PRELIMINARY DESIGN CLIENT REVIEW	2025.08.12
4. ISSUED FOR PRELIMINARY DESIGN CLIENT REVIEW	2025.08.01
3. ISSUED FOR PRELIMINARY DESIGN CLIENT REVIEW	2025.07.30
2. ISSUED FOR PRELIMINARY DESIGN CLIENT REVIEW	2025.07.25
1. ISSUED FOR PRELIMINARY DESIGN CLIENT REVIEW	2025.07.14
NO. DESCRIPTION	DATE
REVISIONS	
PROJECT	
 REGION OF PEEL EMIL V. KOLB CENTRE PEEL REGIONAL POLICE FACILITY INTERIOR RENOVATION PROJECT 180 DERRBY ROAD EAST, MISSISSAUGA, ON L5T 2Y5	
 THE CONSULTANT SHALL CHECK AND VERIFY ALL DIMENSIONS AND REPORT ANY DISCREPANCIES TO THE DESIGNER PRIOR TO THE START OF CONSTRUCTION. THE CONSULTANT SHALL NOT BE RESPONSIBLE FOR ANY DISCREPANCIES THAT ARE NOT REPORTED PRIOR TO THE START OF CONSTRUCTION.	
STRUCTURAL CONSULTANT Stephenson Engineering WESTON/COREL/TOY EXP Services Inc. ELECTRICAL CONSULTANT EXP Services Inc.	
SHEET TITLE INTERIOR ELEVATIONS & MILLWORK DETAILS	
SHEET NO. A508	DRAWN BY CC
PROJECT NO. AS NOTED	CHECKED RN

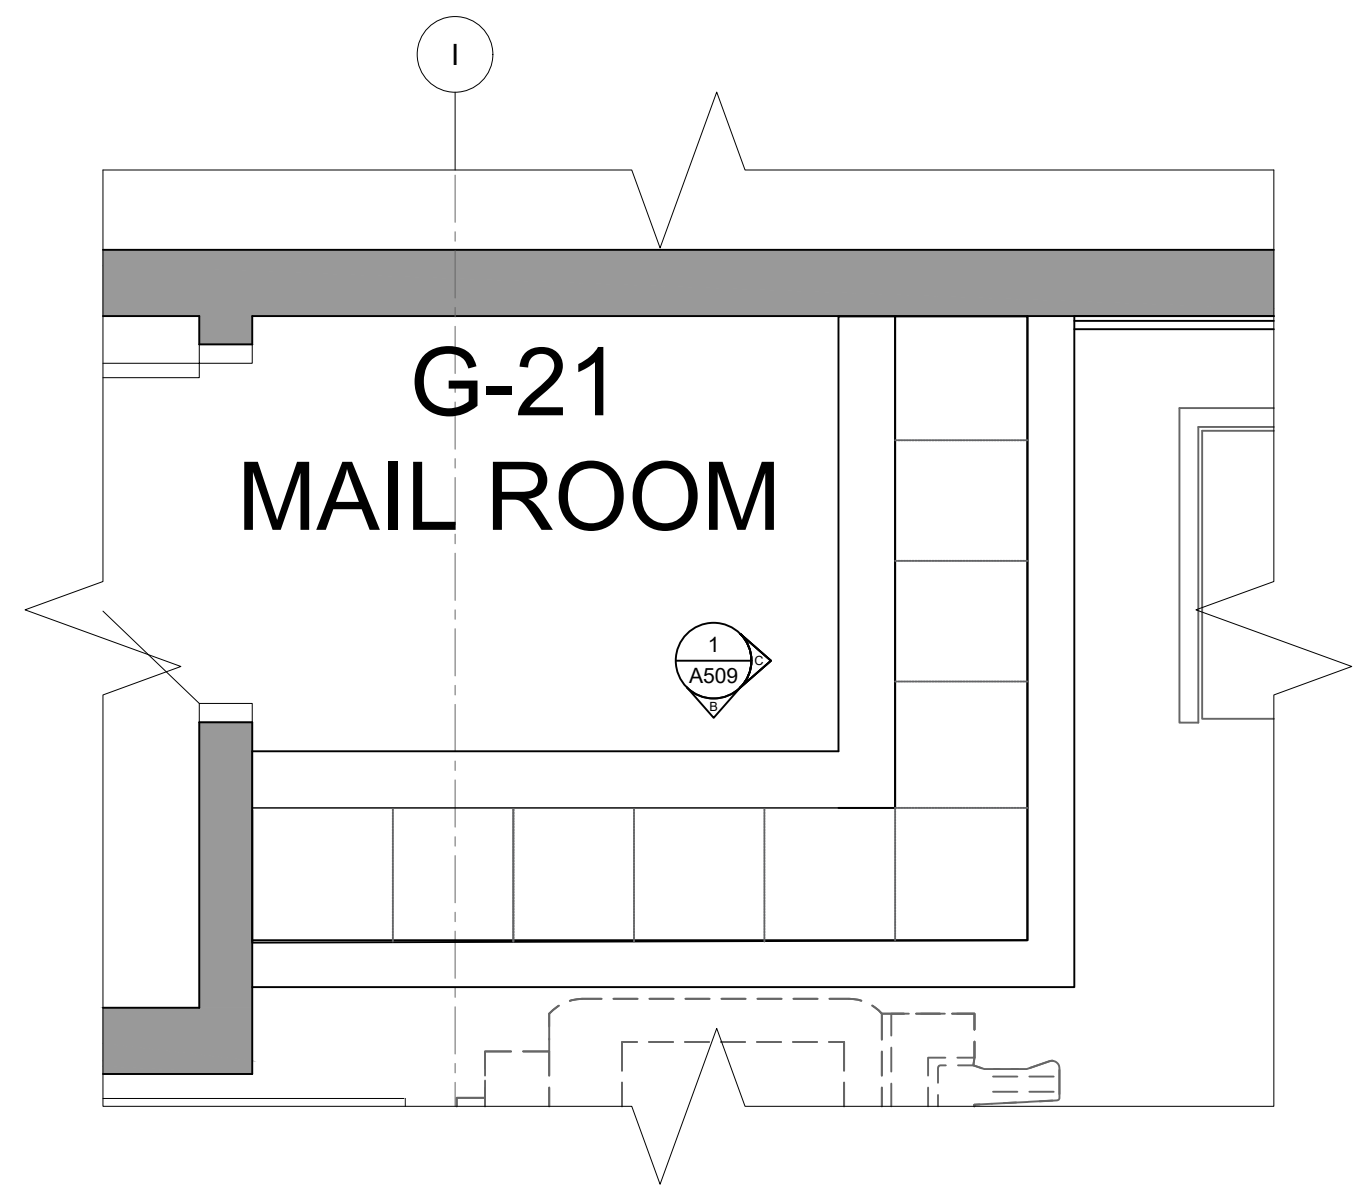

1
A509
INTERIOR ELEVATION- MAIL ROOM (G-21) / MILLWORK DETAILS M-05
SCALE: 1:20

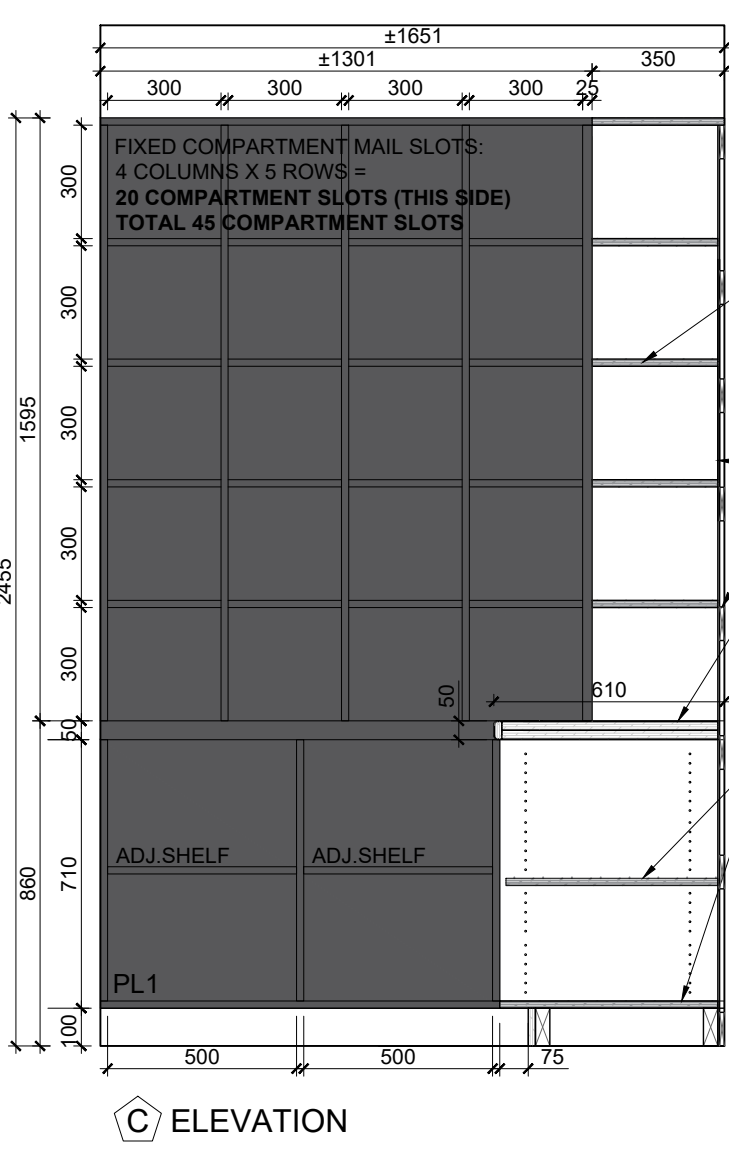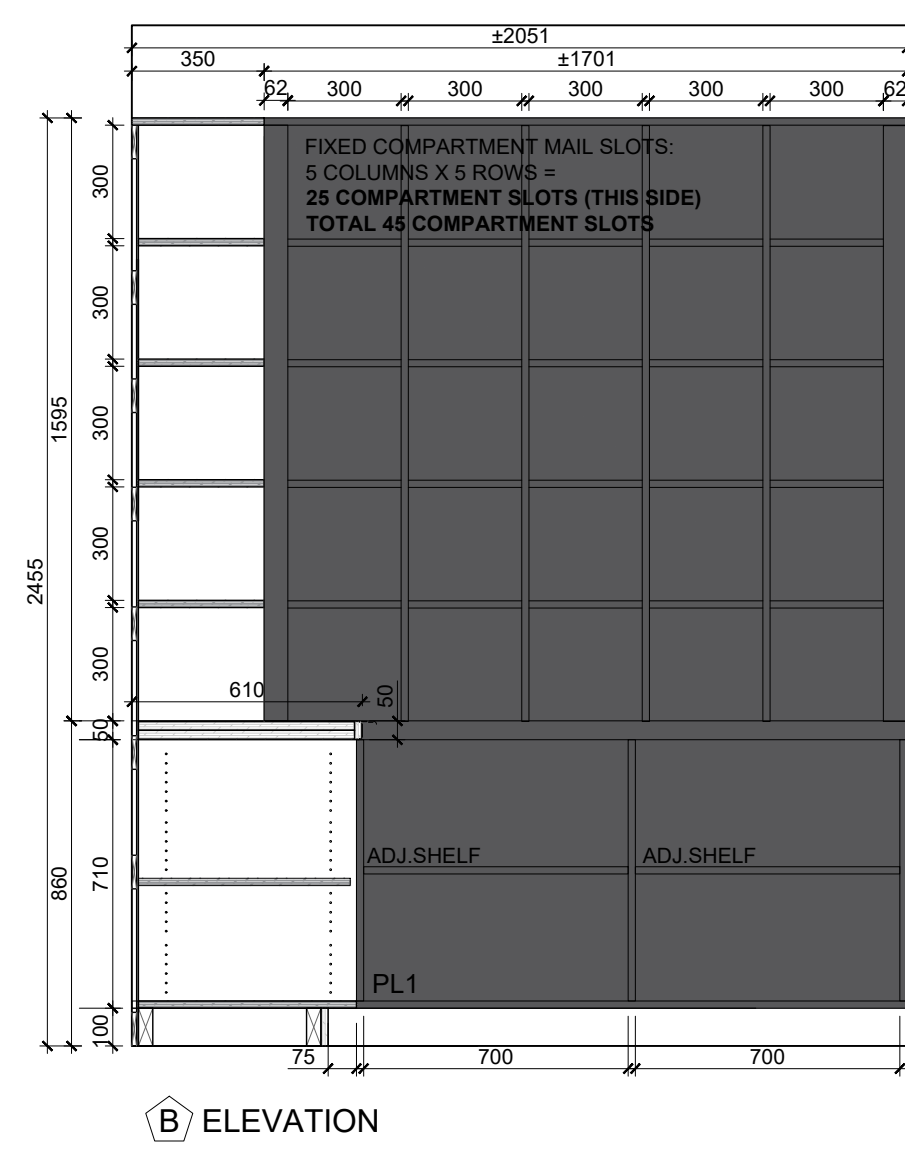

19mm PLYWOOD CW PL1 HIGH PRESSURE LAMINATE FINISH, COLOUR MATCHING EDGE BANDING, EXTERIOR AND INTERIOR SIDES OF TOP, BOTTOM, GABLES, TYP.

6mm MDF BACKING WITH HIGH PRESSURE LAMINATE FINISH, TYP.


CONTINUOUS WOOD NAILERS, TYP.

BUILT-UP PLYWOOD DESKTOP CW PL1 HIGH PRESSURE LAMINATE FINISH AT TOP AND UNDERSIDE OF DESK, WITH COLOUR MATCHING EDGE BANDING, 6mm RADIUS TO ALL EDGES, TYP.

19mm PLYWOOD CW PL1 HIGH PRESSURE LAMINATE FINISH, WITH COLOUR MATCHING EDGE BANDING, ADJUSTABLE SHELF SUPPORTED ON 5mm SHELF PINS, DRILL HOLES 25mm ON CENTRE, EXTERIOR AND INTERIOR SIDES OF TOP, BOTTOM, GABLES, TYP.

CONTINUOUS WALL BASE ON PLYWOOD AND BLOCKING BASE, TYP.

MILLWORK LEGEND	
	GLA1: 300mm x 50mm GLASS BACKSPLASH T.I.E. RUNNING BOND
	PL1: HIGH PRESSURE LAMINATE FINISH- COLOUR 1
	PL2: HIGH PRESSURE LAMINATE FINISH- COLOUR 2
EX.	EXISTING
N.T.C.	NOT IN CONTRACT
TYP.	TYPICAL

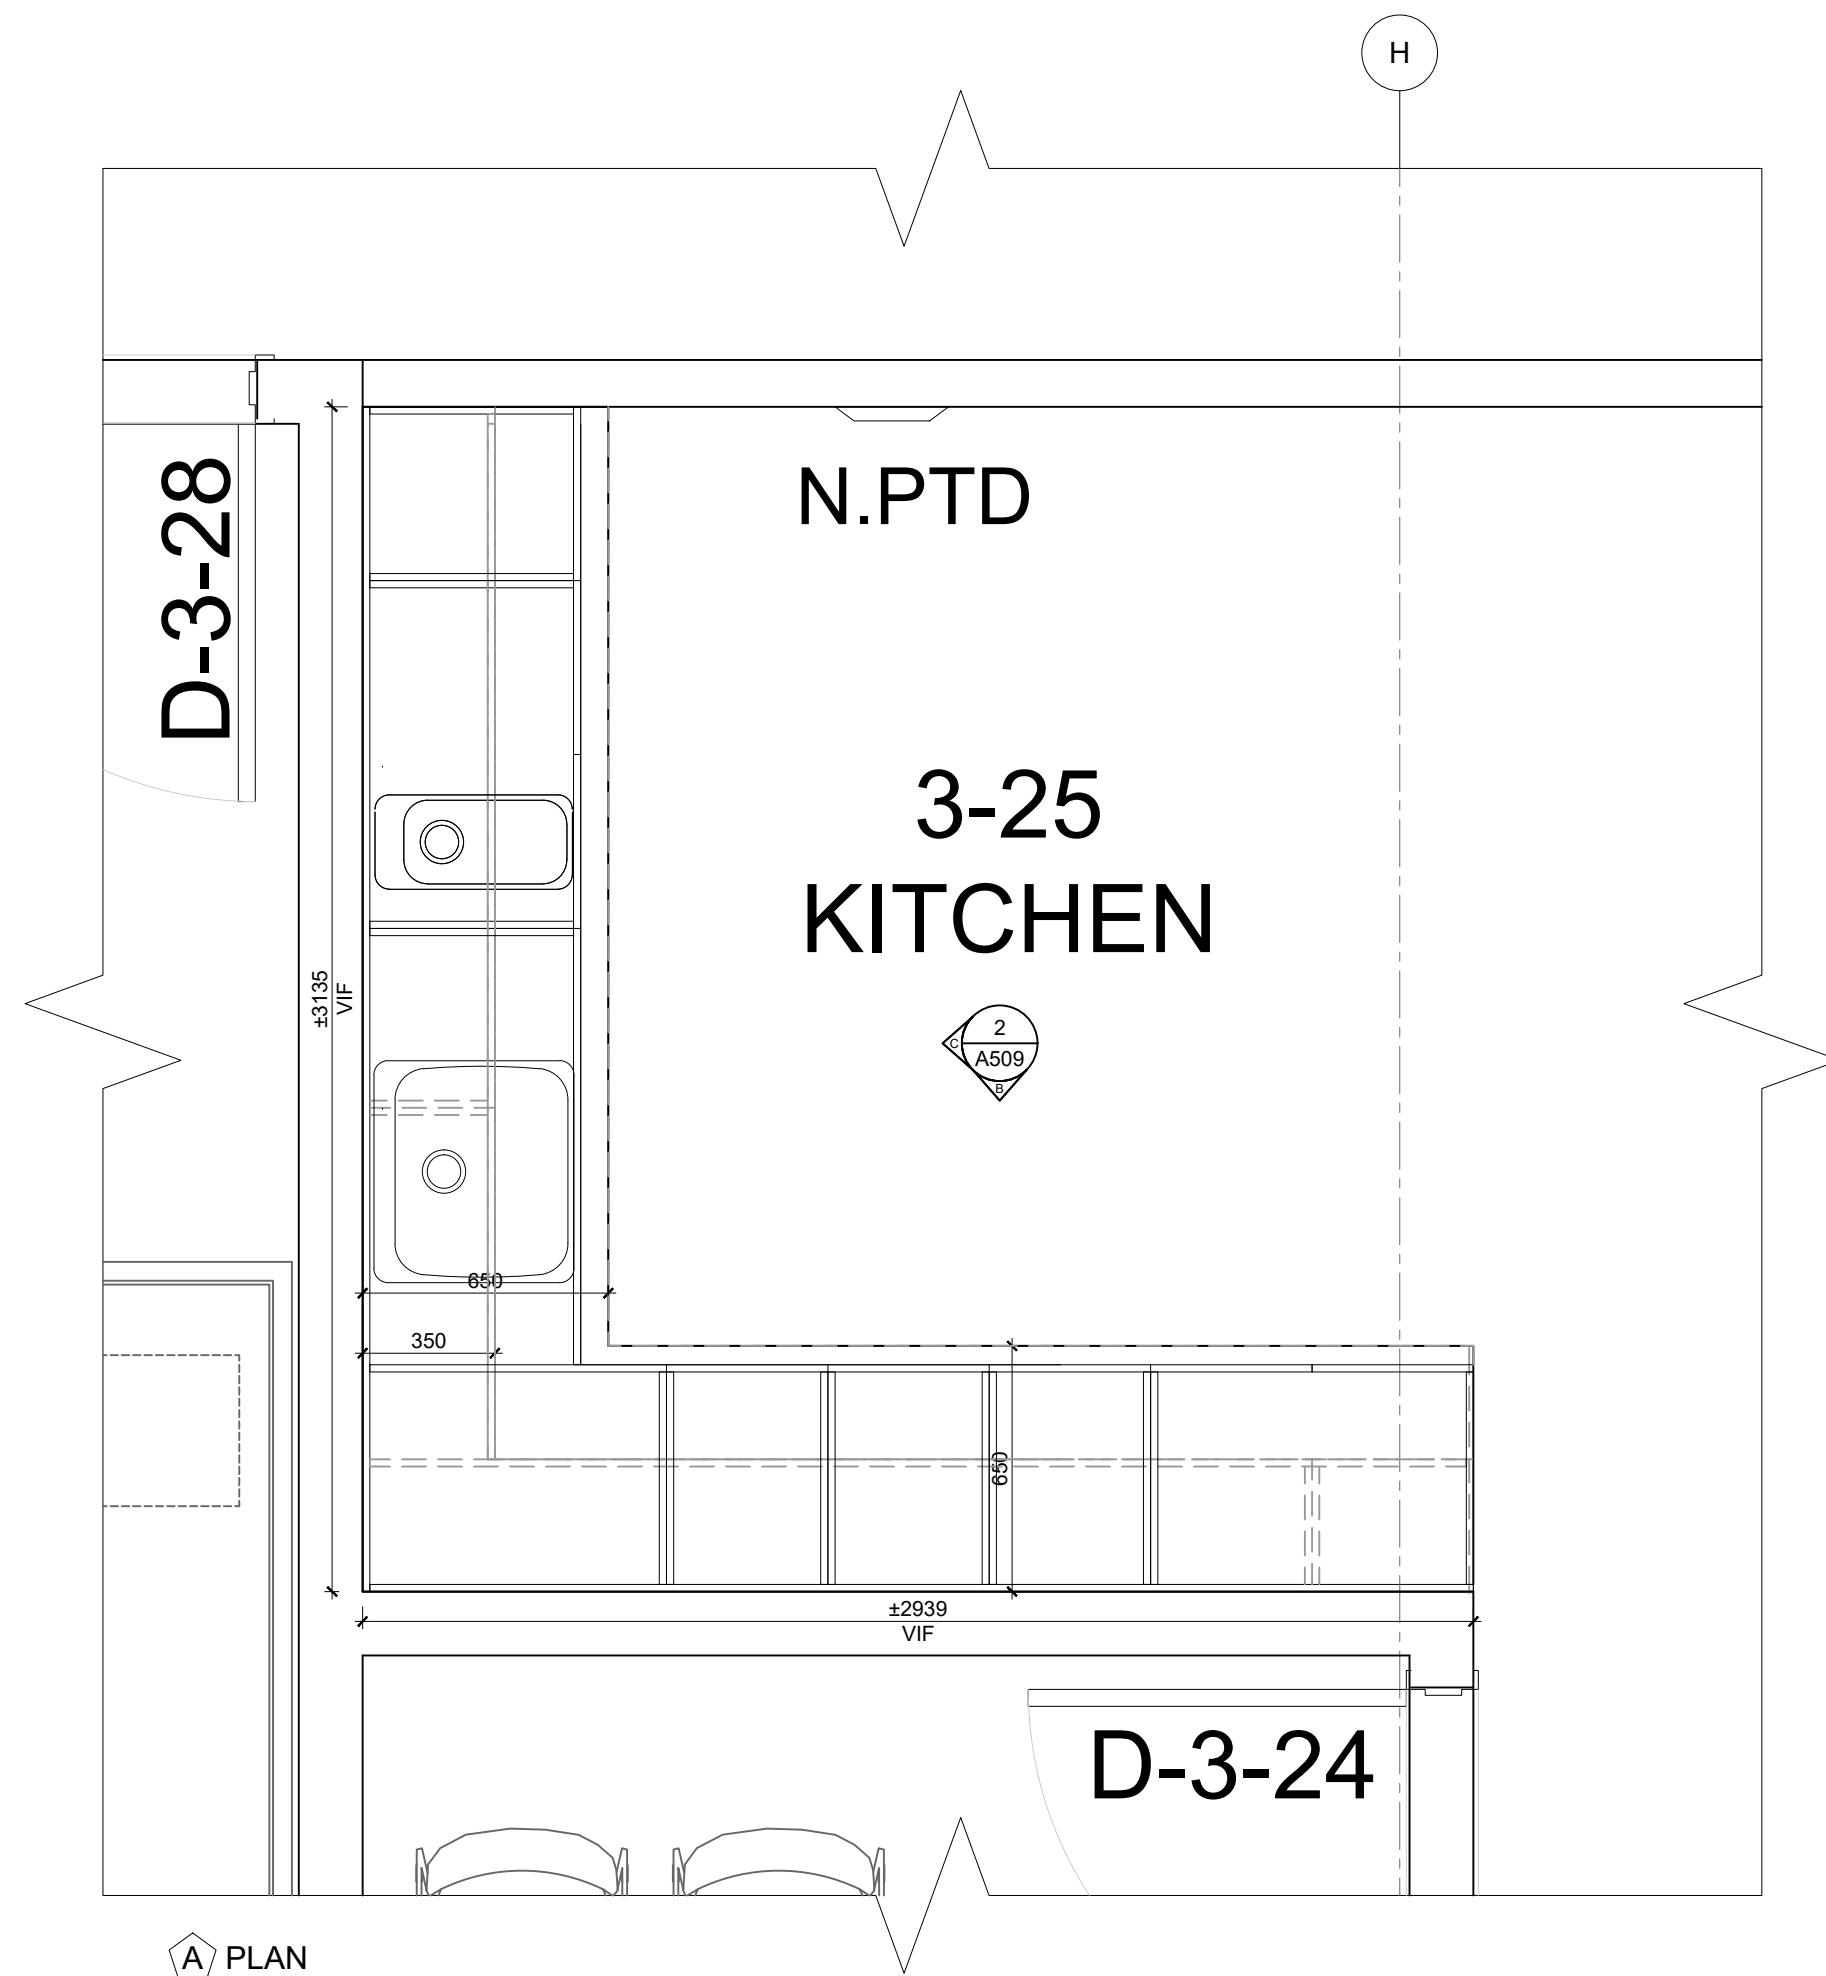

2
A509
INTERIOR ELEVATION- KITCHENETTE (3-25) / MILLWORK DETAILS M-06
SCALE: 1:20

TYP. CONSTRUCTION FOR ALL KITCHEN MILLWORK:



UPPER AND LOWER CABINET GABLES, APRONS, DOORS, AND DRAWER FRONTS, CONSTRUCTED OF 19mm MDF BOARD WITH HIGH PRESSURE LAMINATE FINISH TO ALL SURFACES, TYP.

6mm HIGH PRESSURE LAMINATE FINISH MDF BOARD BACKING ON CONTINUOUS WOOD NAILERS, TYP.

19mm MDF BOARD ADJUSTABLE SHELF WITH HIGH PRESSURE LAMINATE FINISH, SUPPORTED ON 5mm SHELF PINS, DRILL HOLES 25mm ON CENTRE, TYP. FOR ALL CABINETS

DRAWER SIDES CONSTRUCTED OF 13mm MDF BOARD, DRAWER BOTTOMS CONSTRUCTED OF 6mm PLYWOOD, HIGH PRESSURE LAMINATE FINISH, TYP.

COUNTERTOP CONSTRUCTED OF 25mm QUARTZ FINISH SUPPORTED ON 19mm MDF BOARD BACKING, TYP.

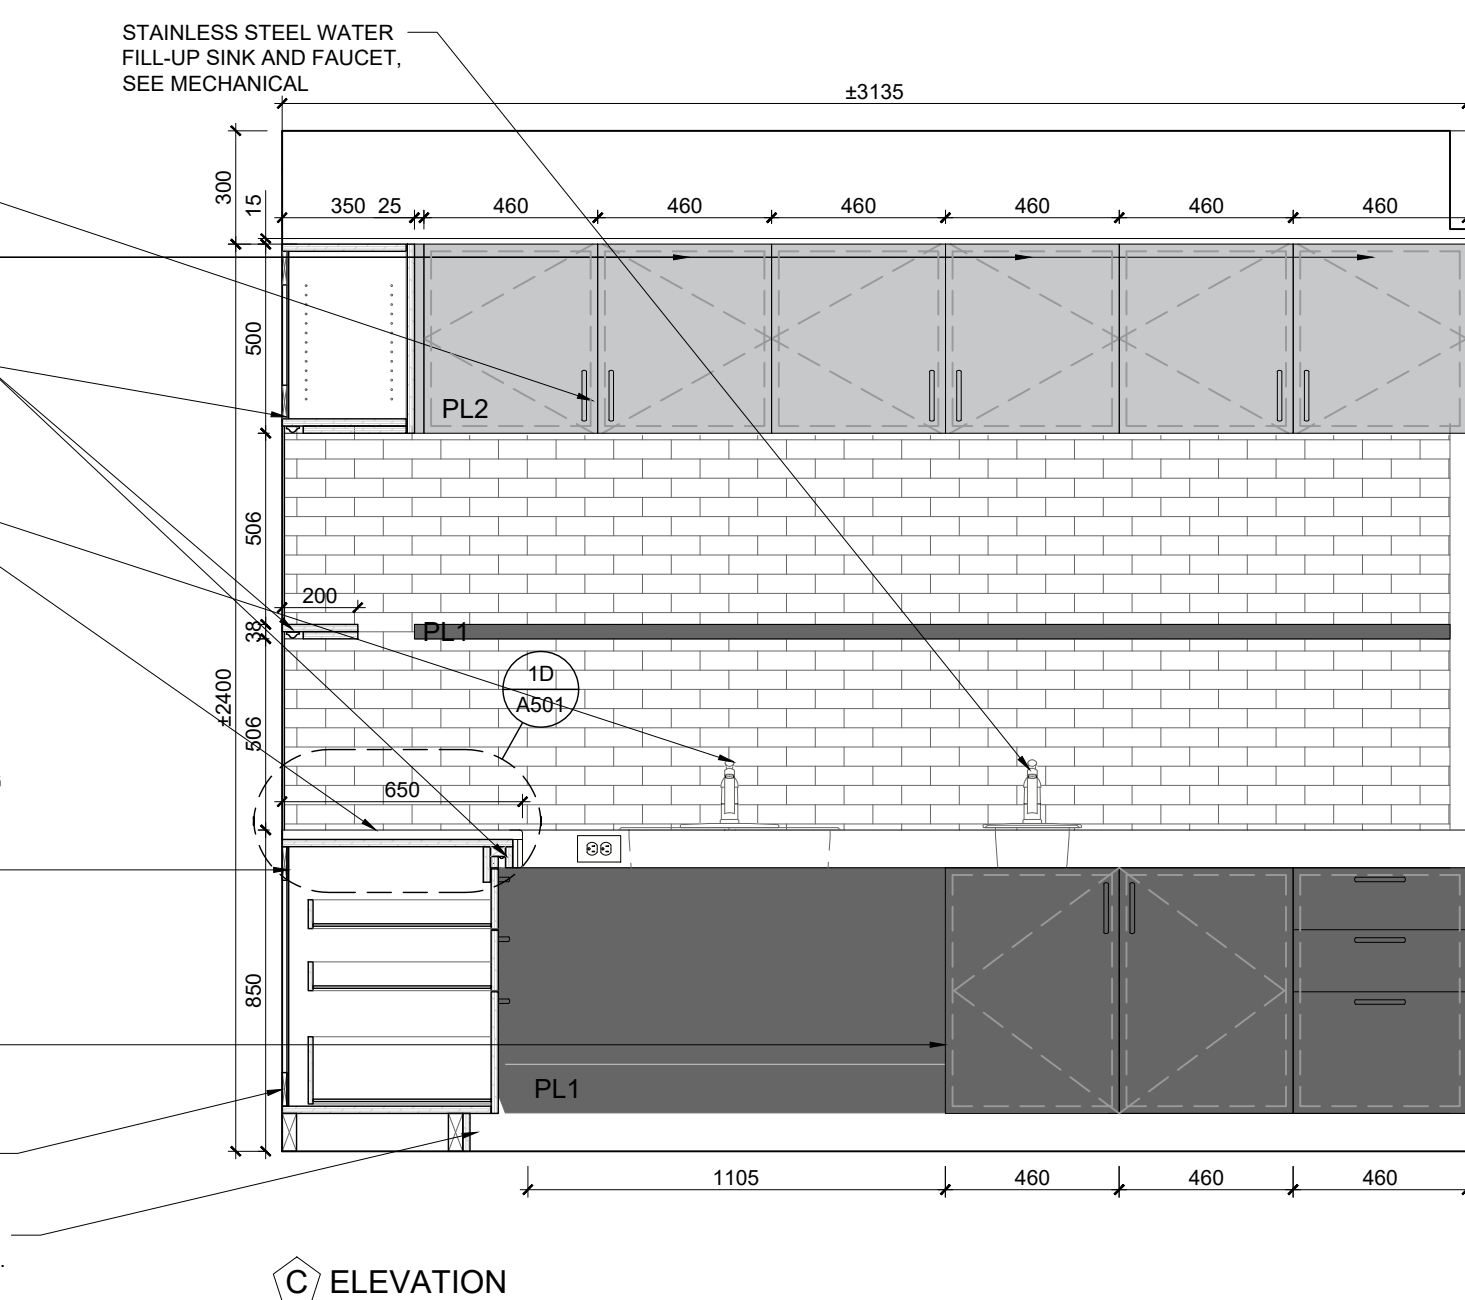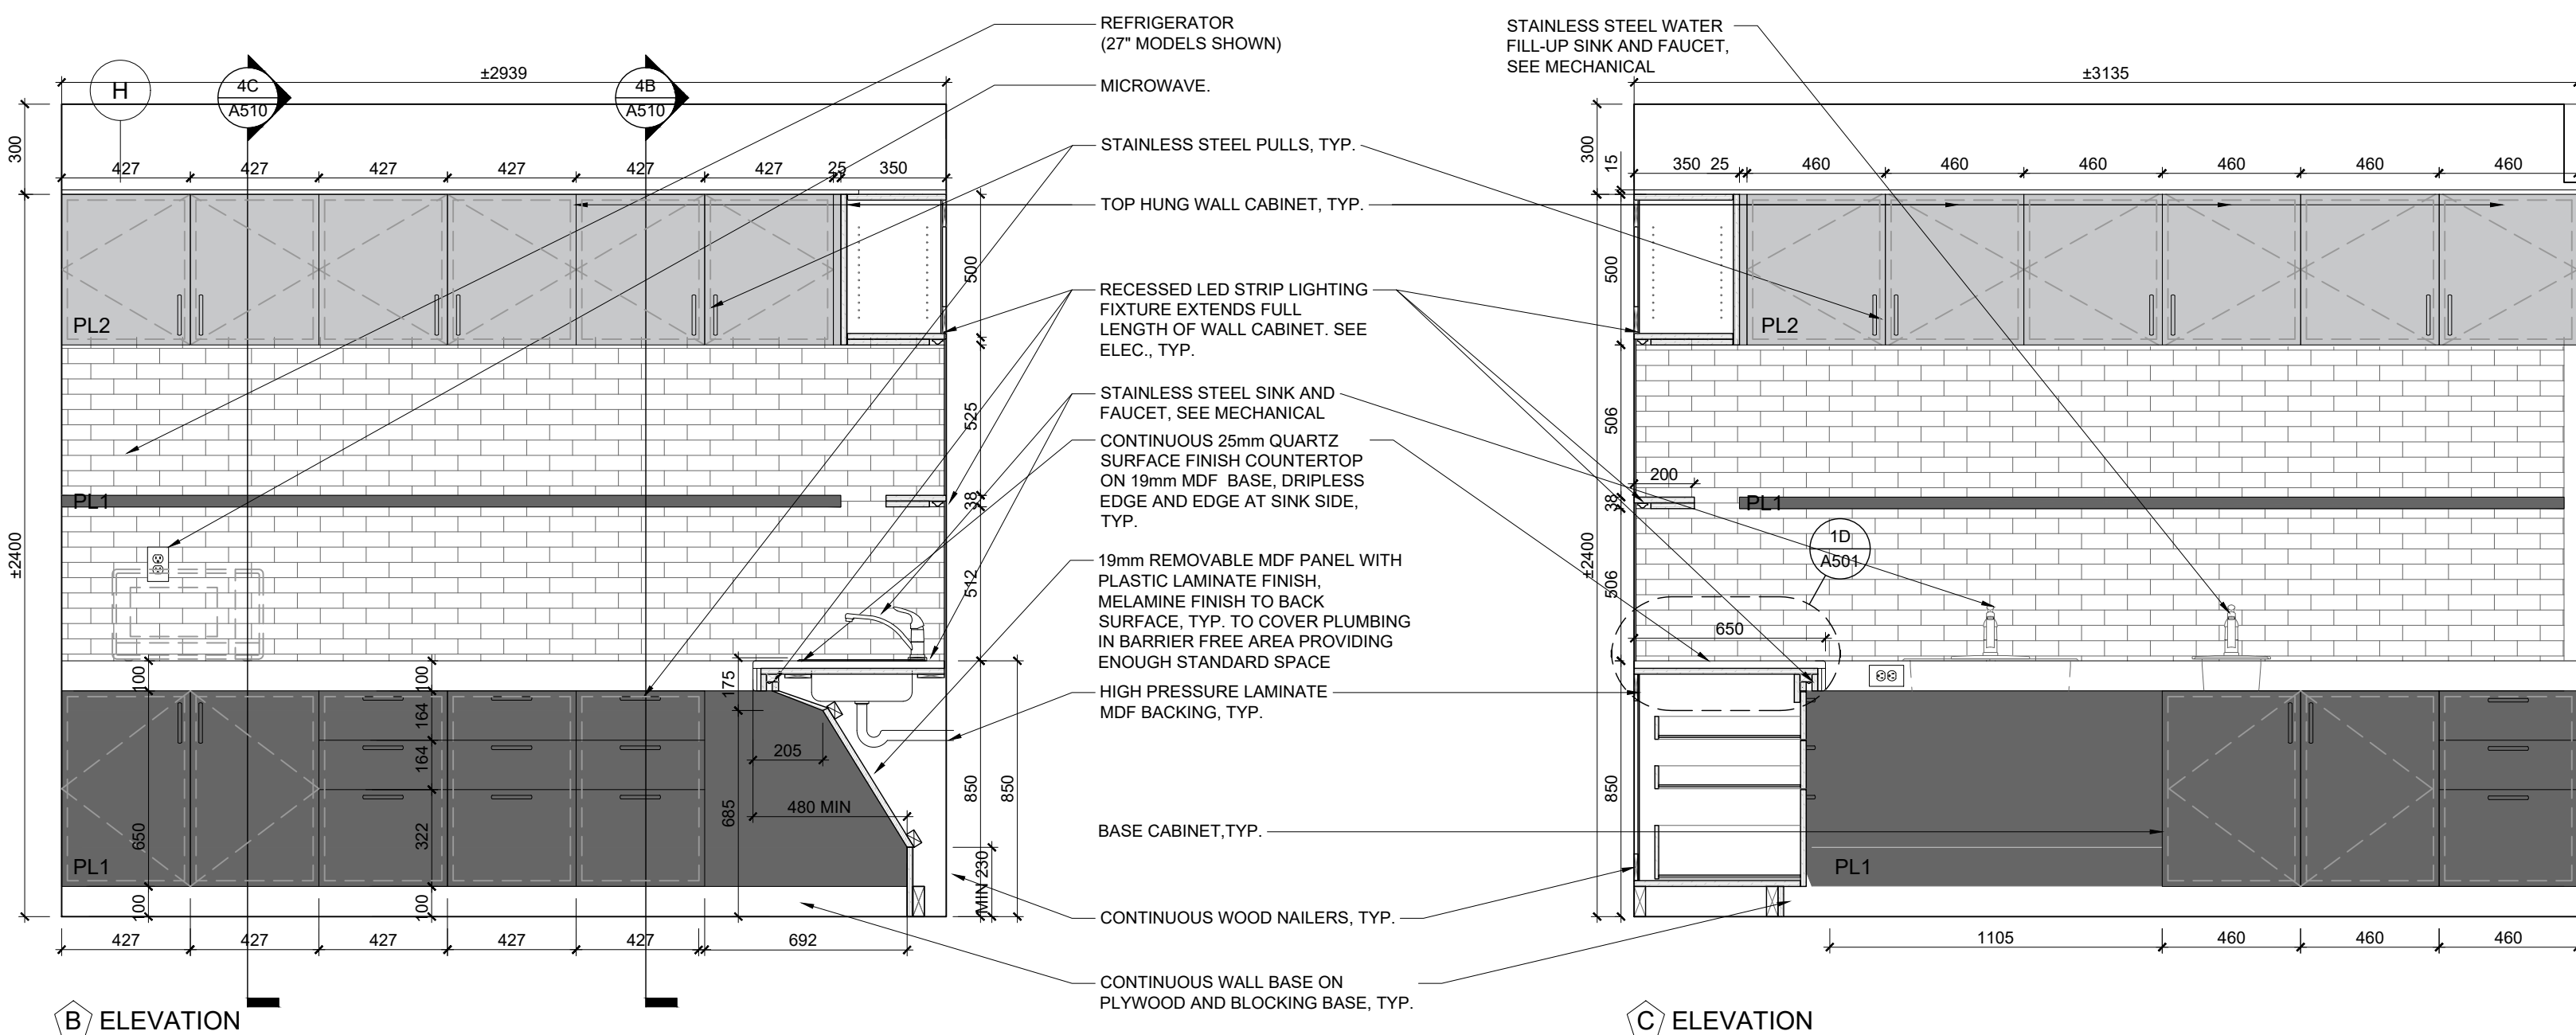

REFRIGERATOR (27" MODELS SHOWN)

MICROWAVE.

STAINLESS STEEL PULLS, TYP.

TOP HUNG WALL CABINET, TYP.

RECESSED LED STRIP LIGHTING FIXTURE EXTENDS FULL LENGTH OF WALL CABINET, SEE ELEC. TYP.

STAINLESS STEEL SINK AND FAUCET, SEE MECHANICAL.

CONTINUOUS 25mm QUARTZ SURFACE FINISH COUNTERTOP ON 19mm MDF BASE, DRIPLESS EDGE AND EDGE AT SINK SIDE, TYP.

19mm REMOVABLE MDF PANEL WITH PLASTIC LAMINATE FINISH, MELAMINE FINISH TO BACK SURFACE, TYP. TO COVER PLUMBING IN BARRIER FREE AREA PROVIDING ENOUGH STANDARD SPACE.

HIGH PRESSURE LAMINATE MDF BACKING, TYP.

BASE CABINET, TYP.

CONTINUOUS WOOD NAILERS, TYP.

CONTINUOUS WALL BASE ON PLYWOOD AND BLOCKING BASE, TYP.

STAINLESS STEEL WATER FILL-UP SINK AND FAUCET, SEE MECHANICAL.

TYP. CONSTRUCTION FOR ALL KITCHEN MILLWORK:


UPPER AND LOWER CABINET GABLES, APRONS, DOORS, AND DRAWER FRONTS, CONSTRUCTED OF 19mm MDF BOARD WITH HIGH PRESSURE LAMINATE FINISH TO ALL SURFACES, TYP.

6mm HIGH PRESSURE LAMINATE FINISH MELAMINE MDF BOARD BACKING ON CONTINUOUS WOOD NAILERS, TYP.



19mm MDF BOARD ADJUSTABLE SHELF WITH HIGH PRESSURE LAMINATE FINISH, SUPPORTED ON 5mm SHELF PINS, DRILL HOLES 25mm ON CENTRE, TYP. FOR ALL CABINETS

DRAWER SIDES CONSTRUCTED OF 13mm MDF BOARD, DRAWER BOTTOMS CONSTRUCTED OF 6mm PLYWOOD, HIGH PRESSURE LAMINATE FINISH, TYP.

COUNTERTOP CONSTRUCTED OF 25mm QUARTZ FINISH SUPPORTED ON 19mm MDF BOARD BACKING, TYP.

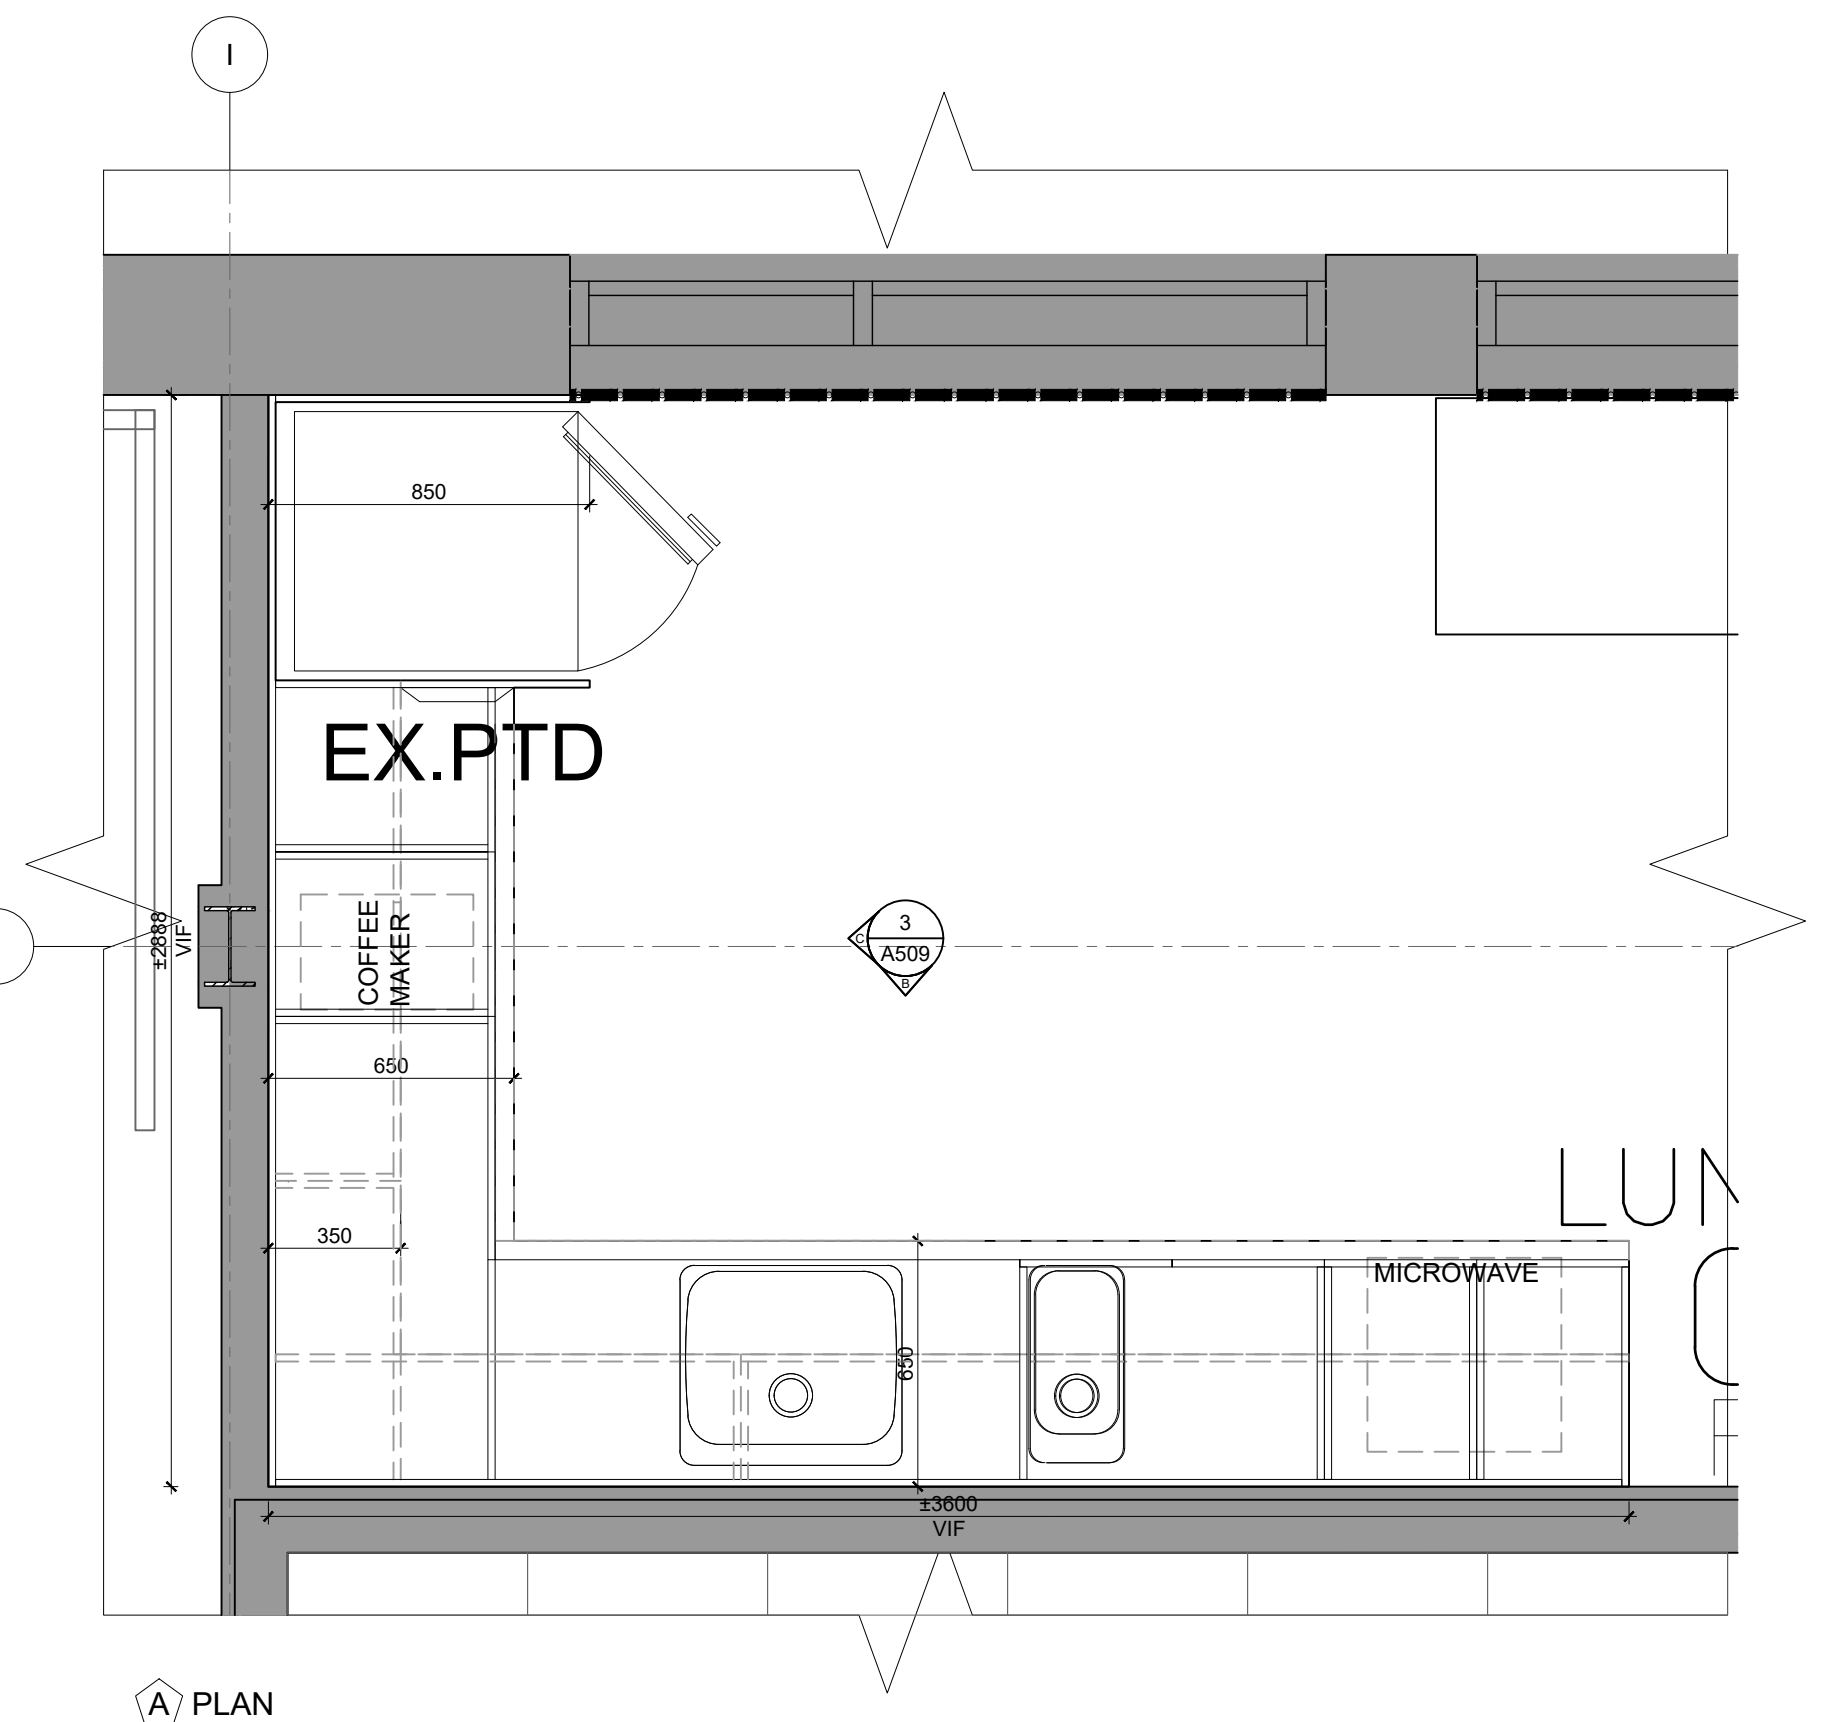

3
A509
INTERIOR ELEVATION- LUNCH ROOM (3057) / MILLWORK DETAILS M-07
SCALE: 1:20

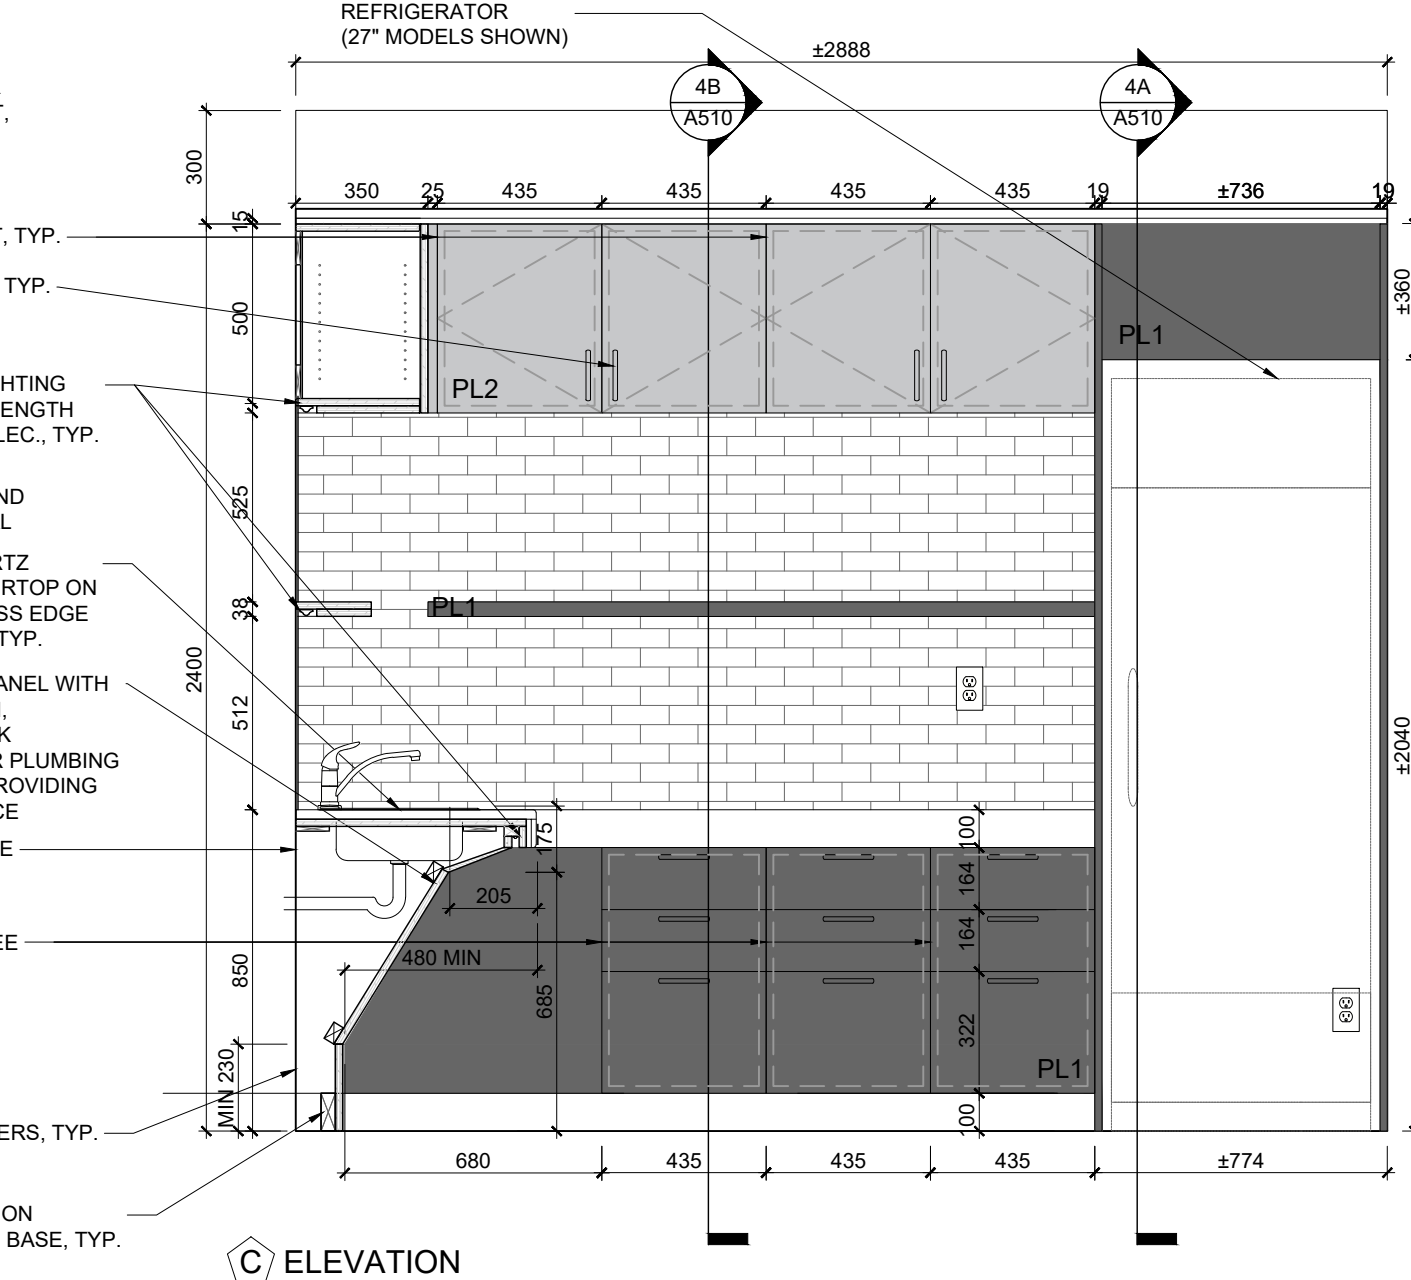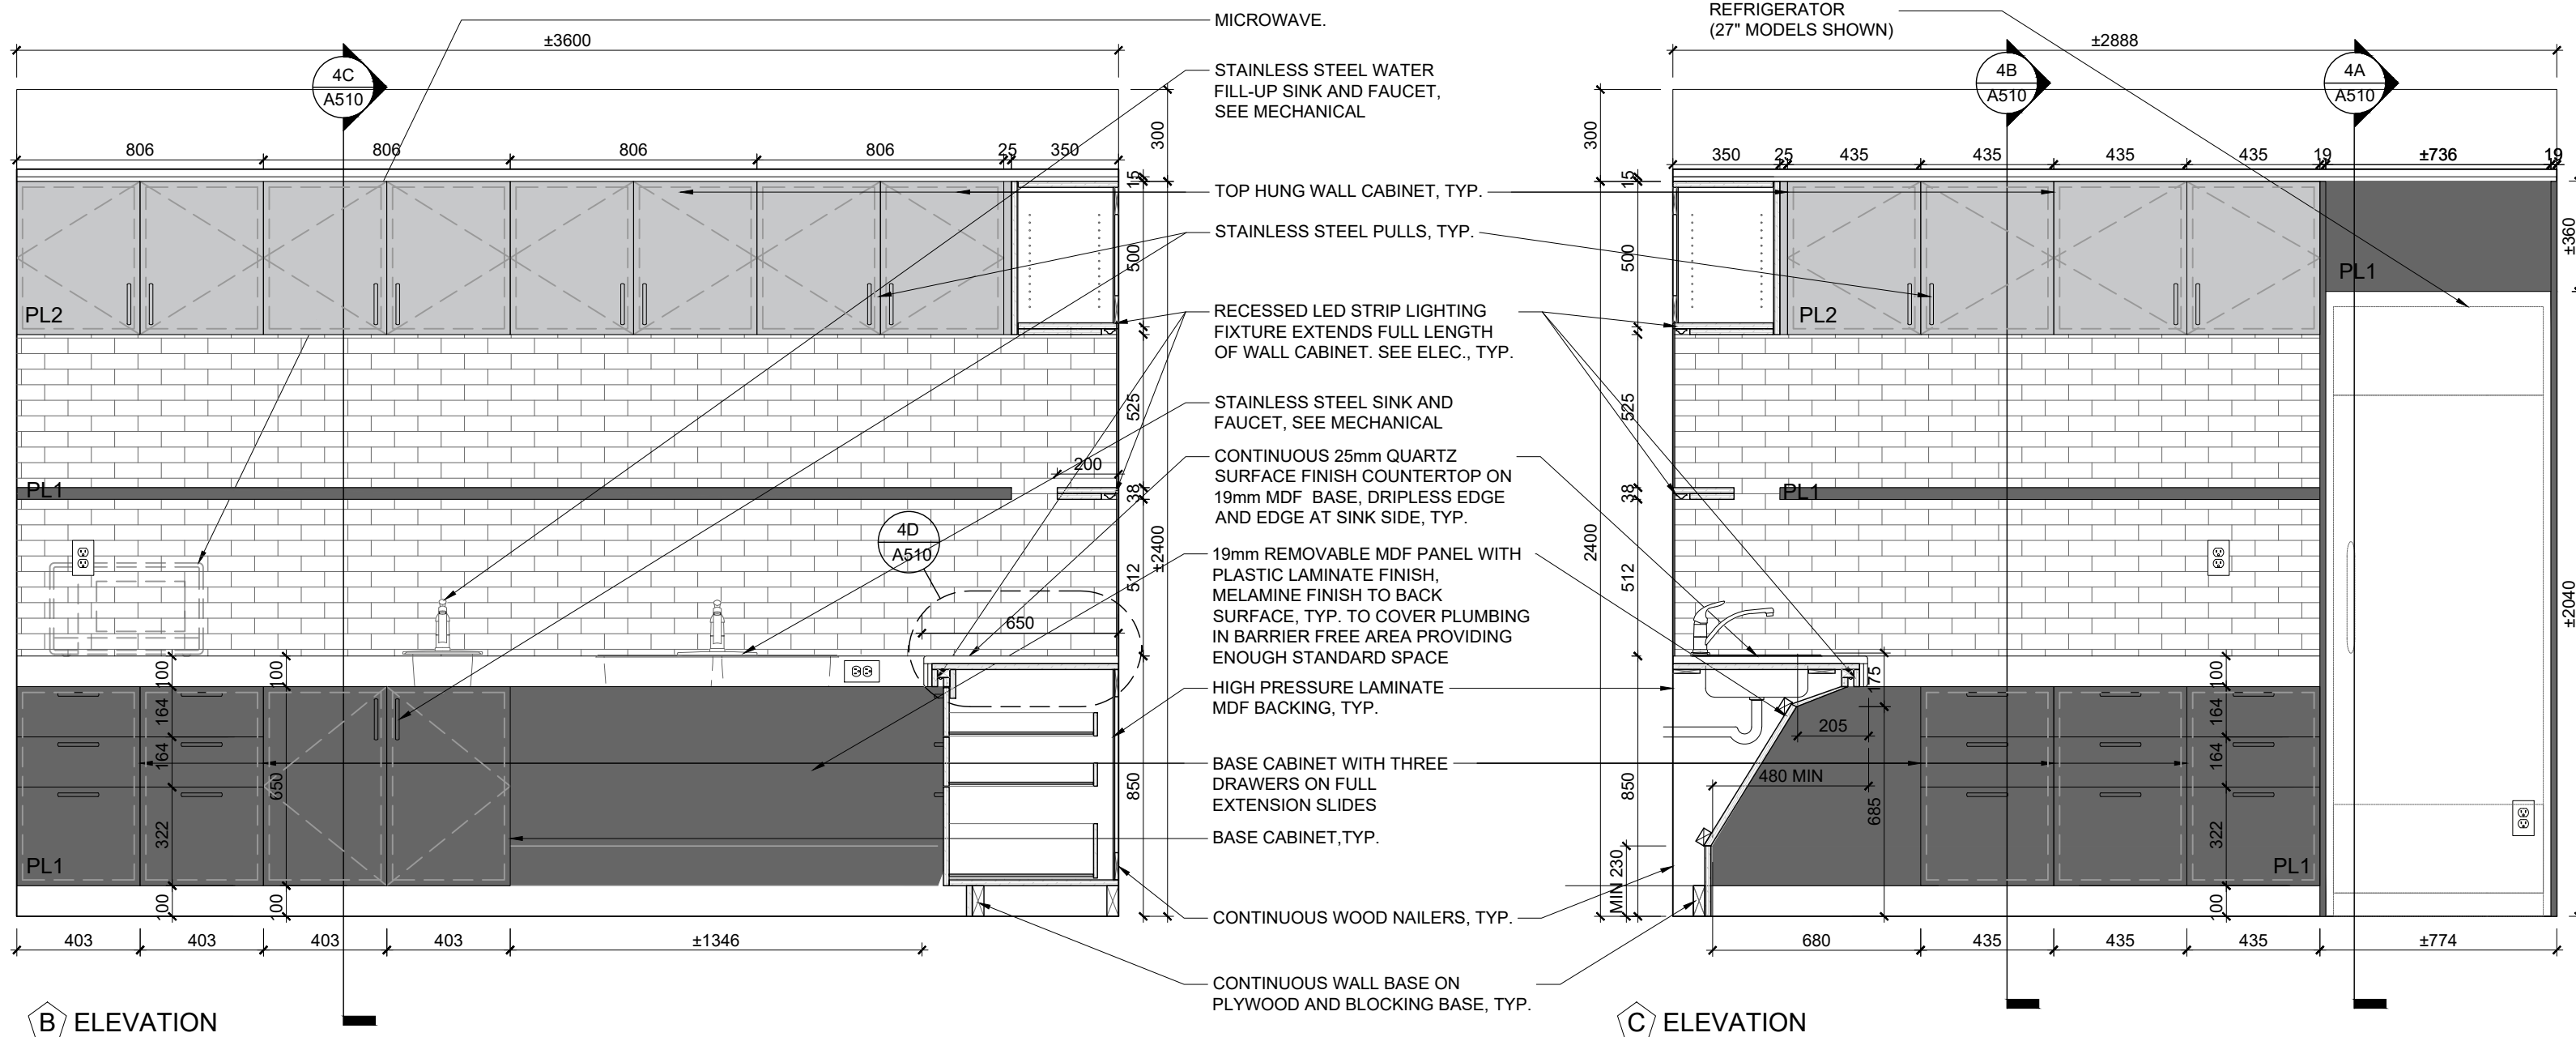

MICROWAVE.

STAINLESS STEEL WATER FILL-UP SINK AND FAUCET, SEE MECHANICAL.

TOP HUNG WALL CABINET, TYP.

STAINLESS STEEL PULLS, TYP.

RECESSED LED STRIP LIGHTING FIXTURE EXTENDS FULL LENGTH OF WALL CABINET, SEE ELEC. TYP.

STAINLESS STEEL SINK AND FAUCET, SEE MECHANICAL.

CONTINUOUS 25mm QUARTZ SURFACE FINISH COUNTERTOP ON 19mm MDF BASE, DRIPLESS EDGE AND EDGE AT SINK SIDE, TYP.

19mm REMOVABLE MDF PANEL WITH PLASTIC LAMINATE FINISH, MELAMINE FINISH TO BACK SURFACE, TYP. TO COVER PLUMBING IN BARRIER FREE AREA PROVIDING ENOUGH STANDARD SPACE.

HIGH PRESSURE LAMINATE MDF BACKING, TYP.

BASE CABINET WITH THREE DRAWERS ON FULL EXTENSION SLIDES.


BASE CABINET, TYP.

CONTINUOUS WOOD NAILERS, TYP.





CONTINUOUS WALL BASE ON PLYWOOD AND BLOCKING BASE, TYP.

REFRIGERATOR (27" MODELS SHOWN)


12. ISSUED FOR TENDER	2026.05.01
11. ISSUED FOR BUILDING PERMIT	2026.04.08
10. ISSUED FOR 10% CLIENT REVIEW	2025.03.31
9. ISSUED FOR DESIGN DEVELOPMENT CLIENT REVIEW	2025.10.28
8. ISSUED FOR DESIGN DEVELOPMENT CLIENT REVIEW	2025.10.01
7. ISSUED FOR PRELIMINARY DESIGN CLIENT REVIEW	2025.09.03
6. ISSUED FOR PRELIMINARY DESIGN CLIENT REVIEW	2025.08.18
5. ISSUED FOR PRELIMINARY DESIGN CLIENT REVIEW	2025.08.12
4. ISSUED FOR PRELIMINARY DESIGN CLIENT REVIEW	2025.08.01
3. ISSUED FOR PRELIMINARY DESIGN CLIENT REVIEW	2025.07.30
2. ISSUED FOR PRELIMINARY DESIGN CLIENT REVIEW	2025.07.25
1. ISSUED FOR PRELIMINARY DESIGN CLIENT REVIEW	2025.07.14
NO. DESCRIPTION	DATE
REVISIONS	
PROJECT	
EMIL V. KOLB CENTRE PEEL REGIONAL POLICE FACILITY INTERIOR RENOVATION PROJECT 180 DENNY ROAD EAST, MISSISSAUGA, ON L5T 2Y5	
The consultant shall check and verify all dimensions and report all errors and omissions to the client in writing. No part of this drawing shall be used for construction purposes until it has been approved by the client in writing. No part of this drawing shall be used for construction purposes until it has been approved by the client in writing.	
SHEET TITLE STRUCTURAL CONSULTANT STEPHENSON ENGINEERING WESTPORTER CONSULTANT EXP Services Inc. ELECTRICAL CONSULTANT EXP Services Inc.	
SHEET NO. A509	
DRAWN BY CC	
CHECKED RN	
PROJECT NO. SCALE AS NOTED	

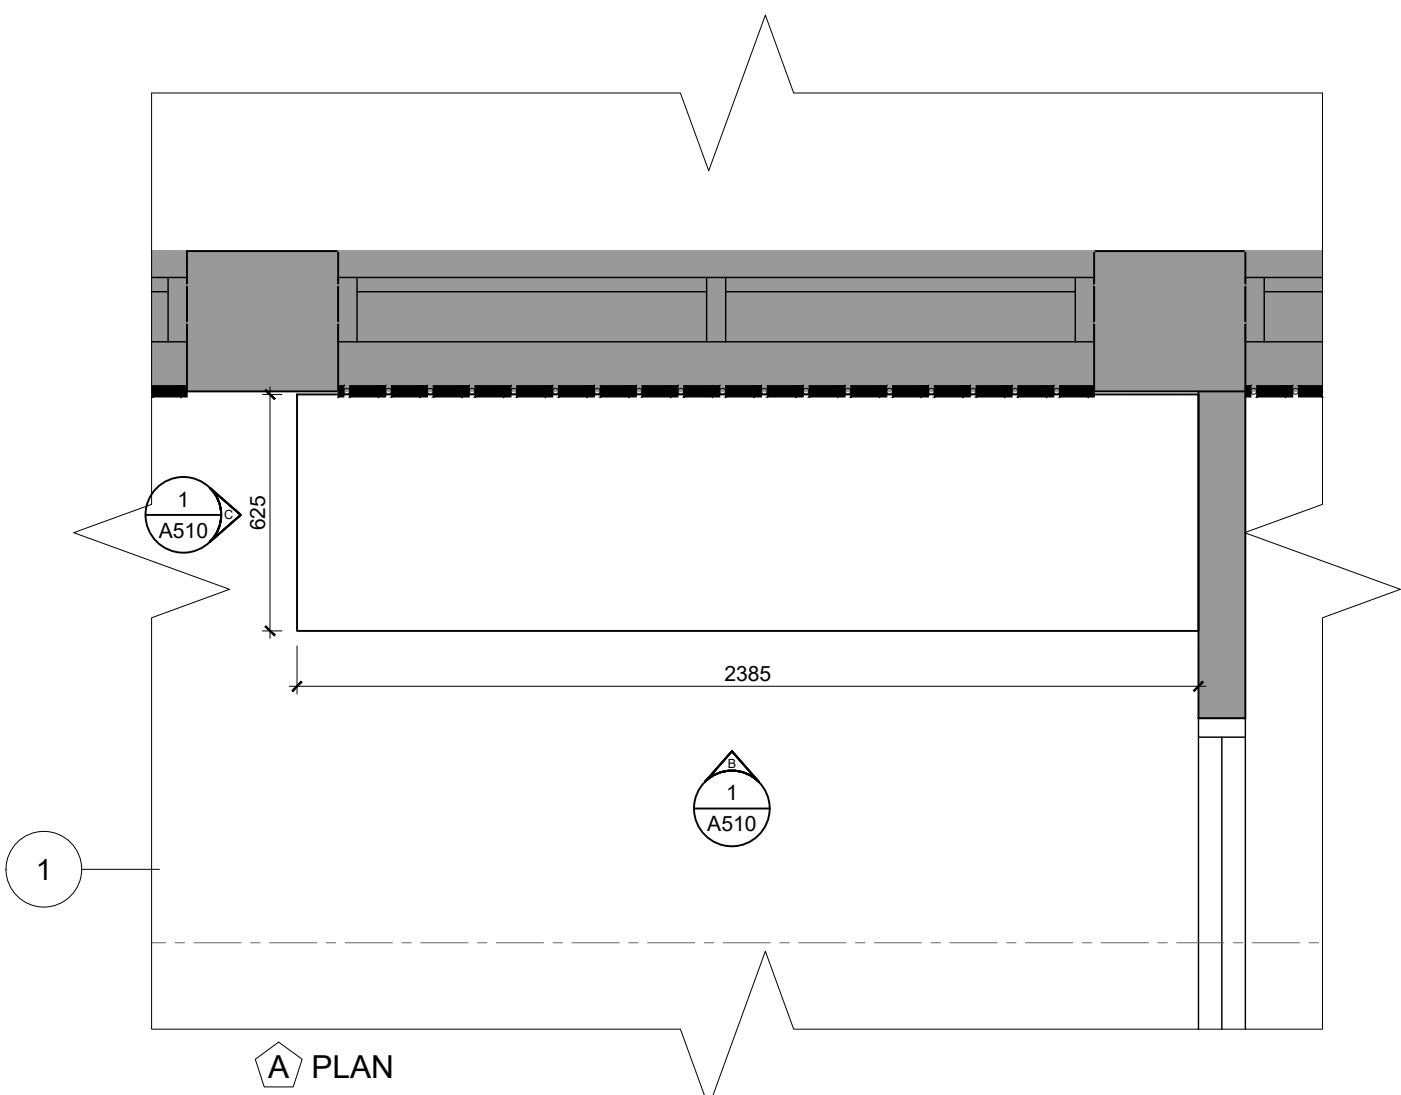





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A510
INTERIOR ELEVATION- LUNCH ROOM (3057) / MILLWORK DETAILS M-08
SCALE: 1:20

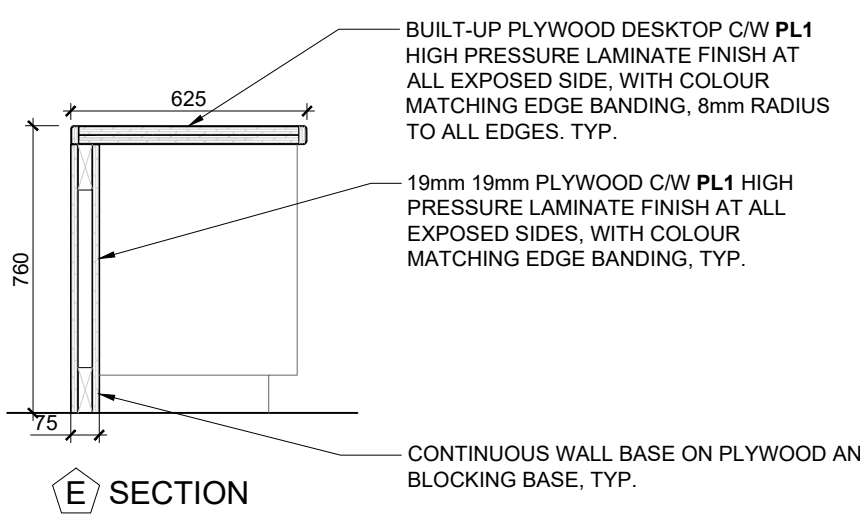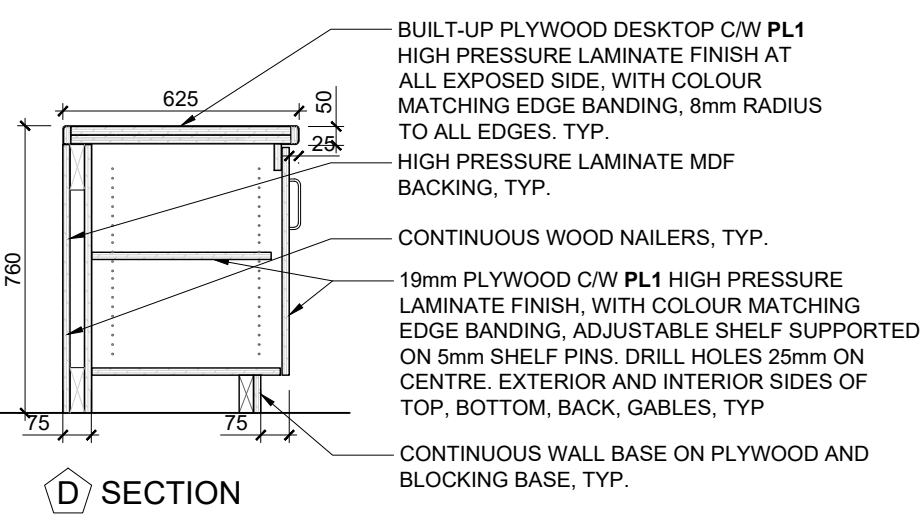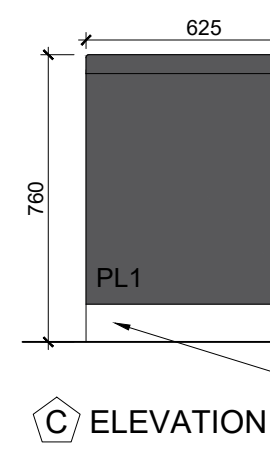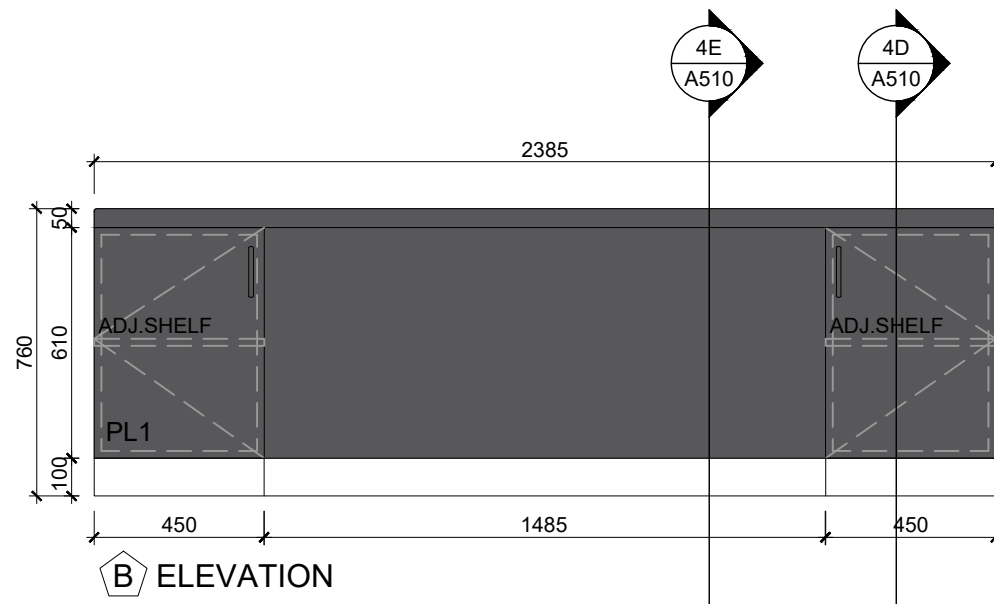


MILLWORK LEGEND	
GLA1: 300mm X 50mm GLASS BACKPLASH TILE, RUNNING BOARD	
PL1: HIGH PRESSURE LAMINATE FINISH- COLOUR 1	
PL2: HIGH PRESSURE LAMINATE FINISH- COLOUR 2	
EX.	EXISTING
N.I.C.	NOT IN CONTRACT
TYP.	TYPICAL

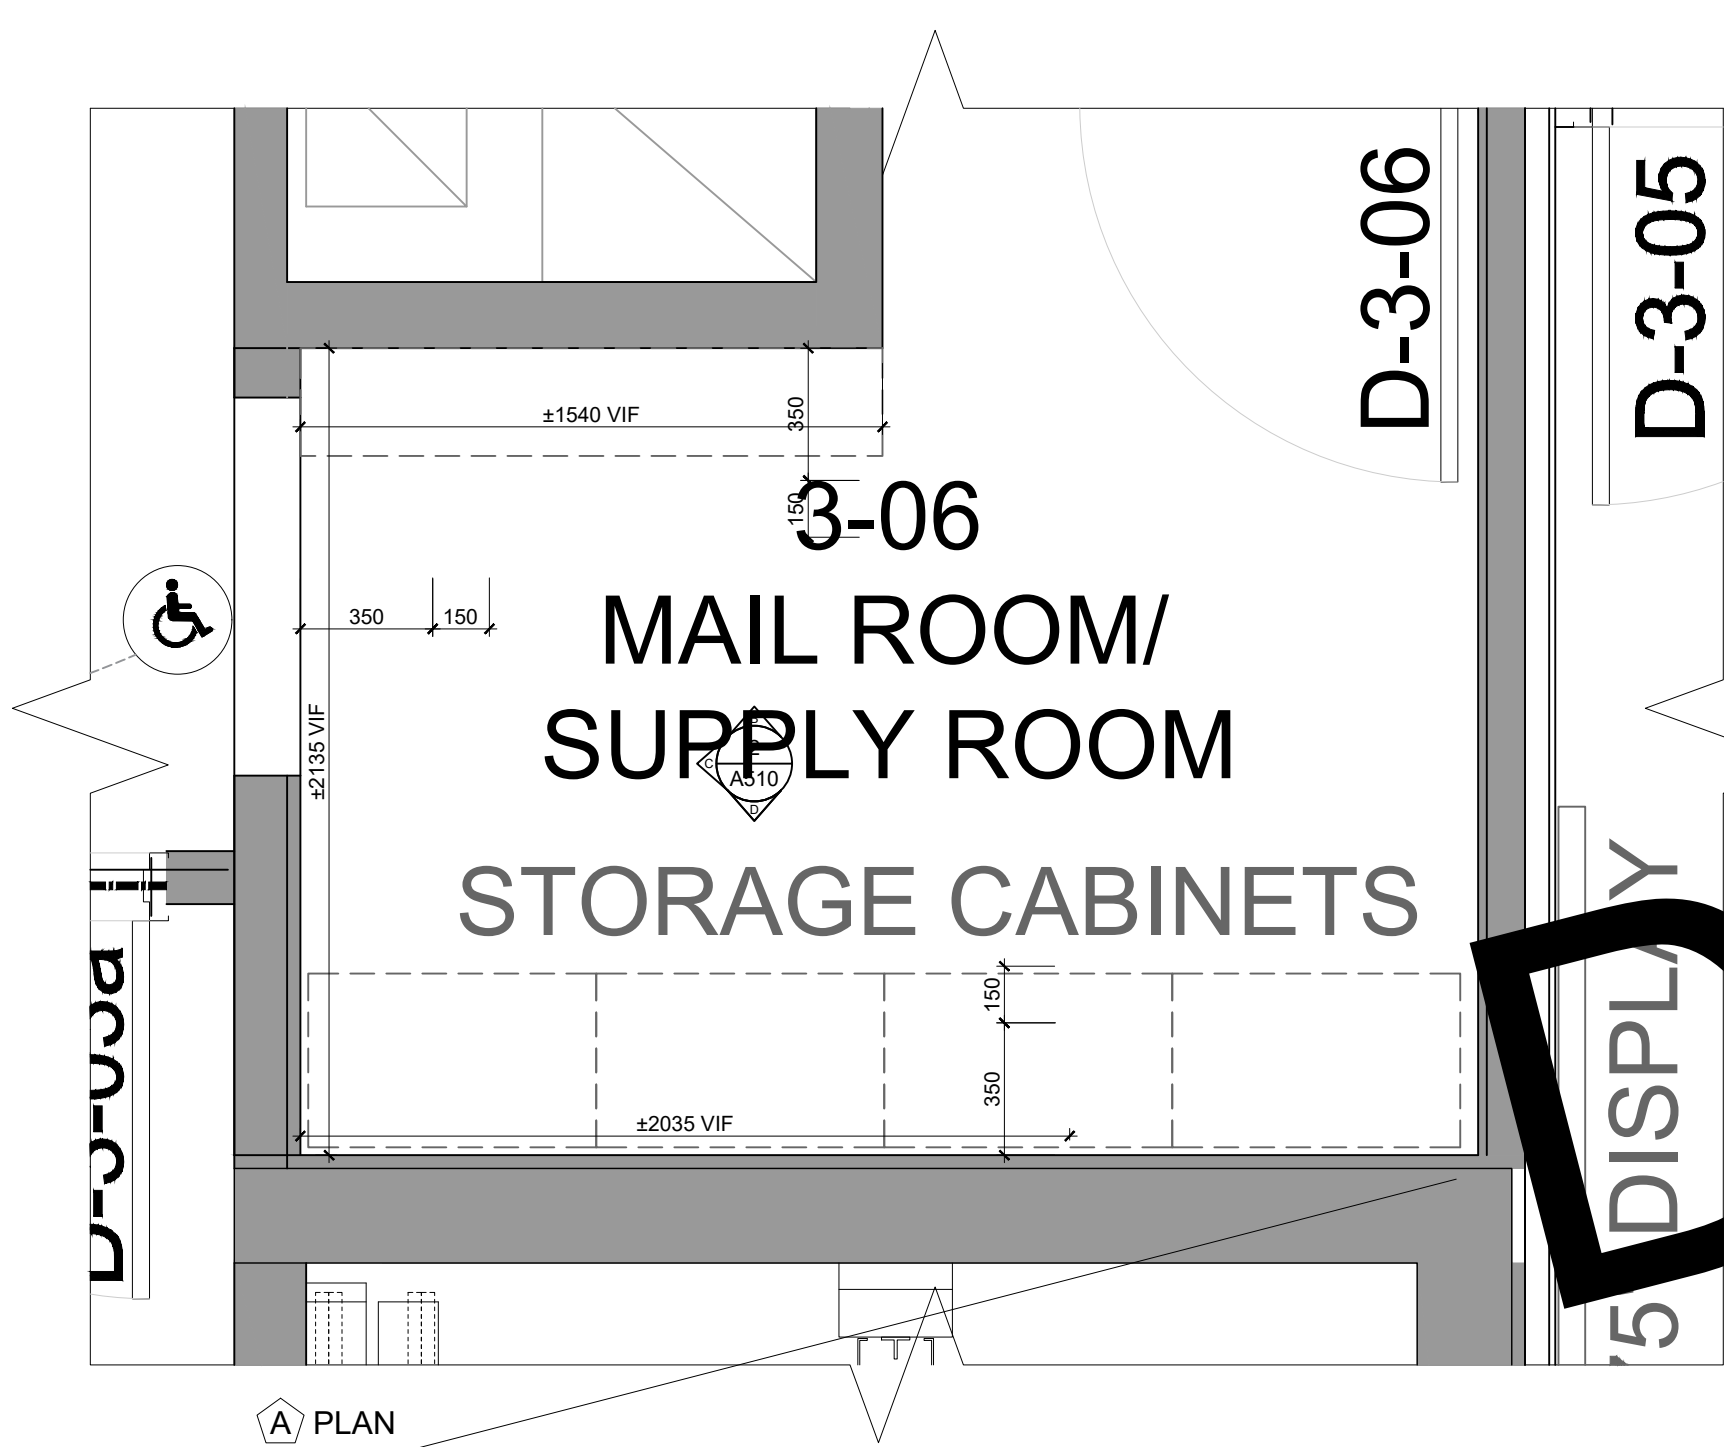









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A510
INTERIOR ELEVATION- MAIL ROOM (3-06) / MILLWORK DETAILS M-09
SCALE: 1:20

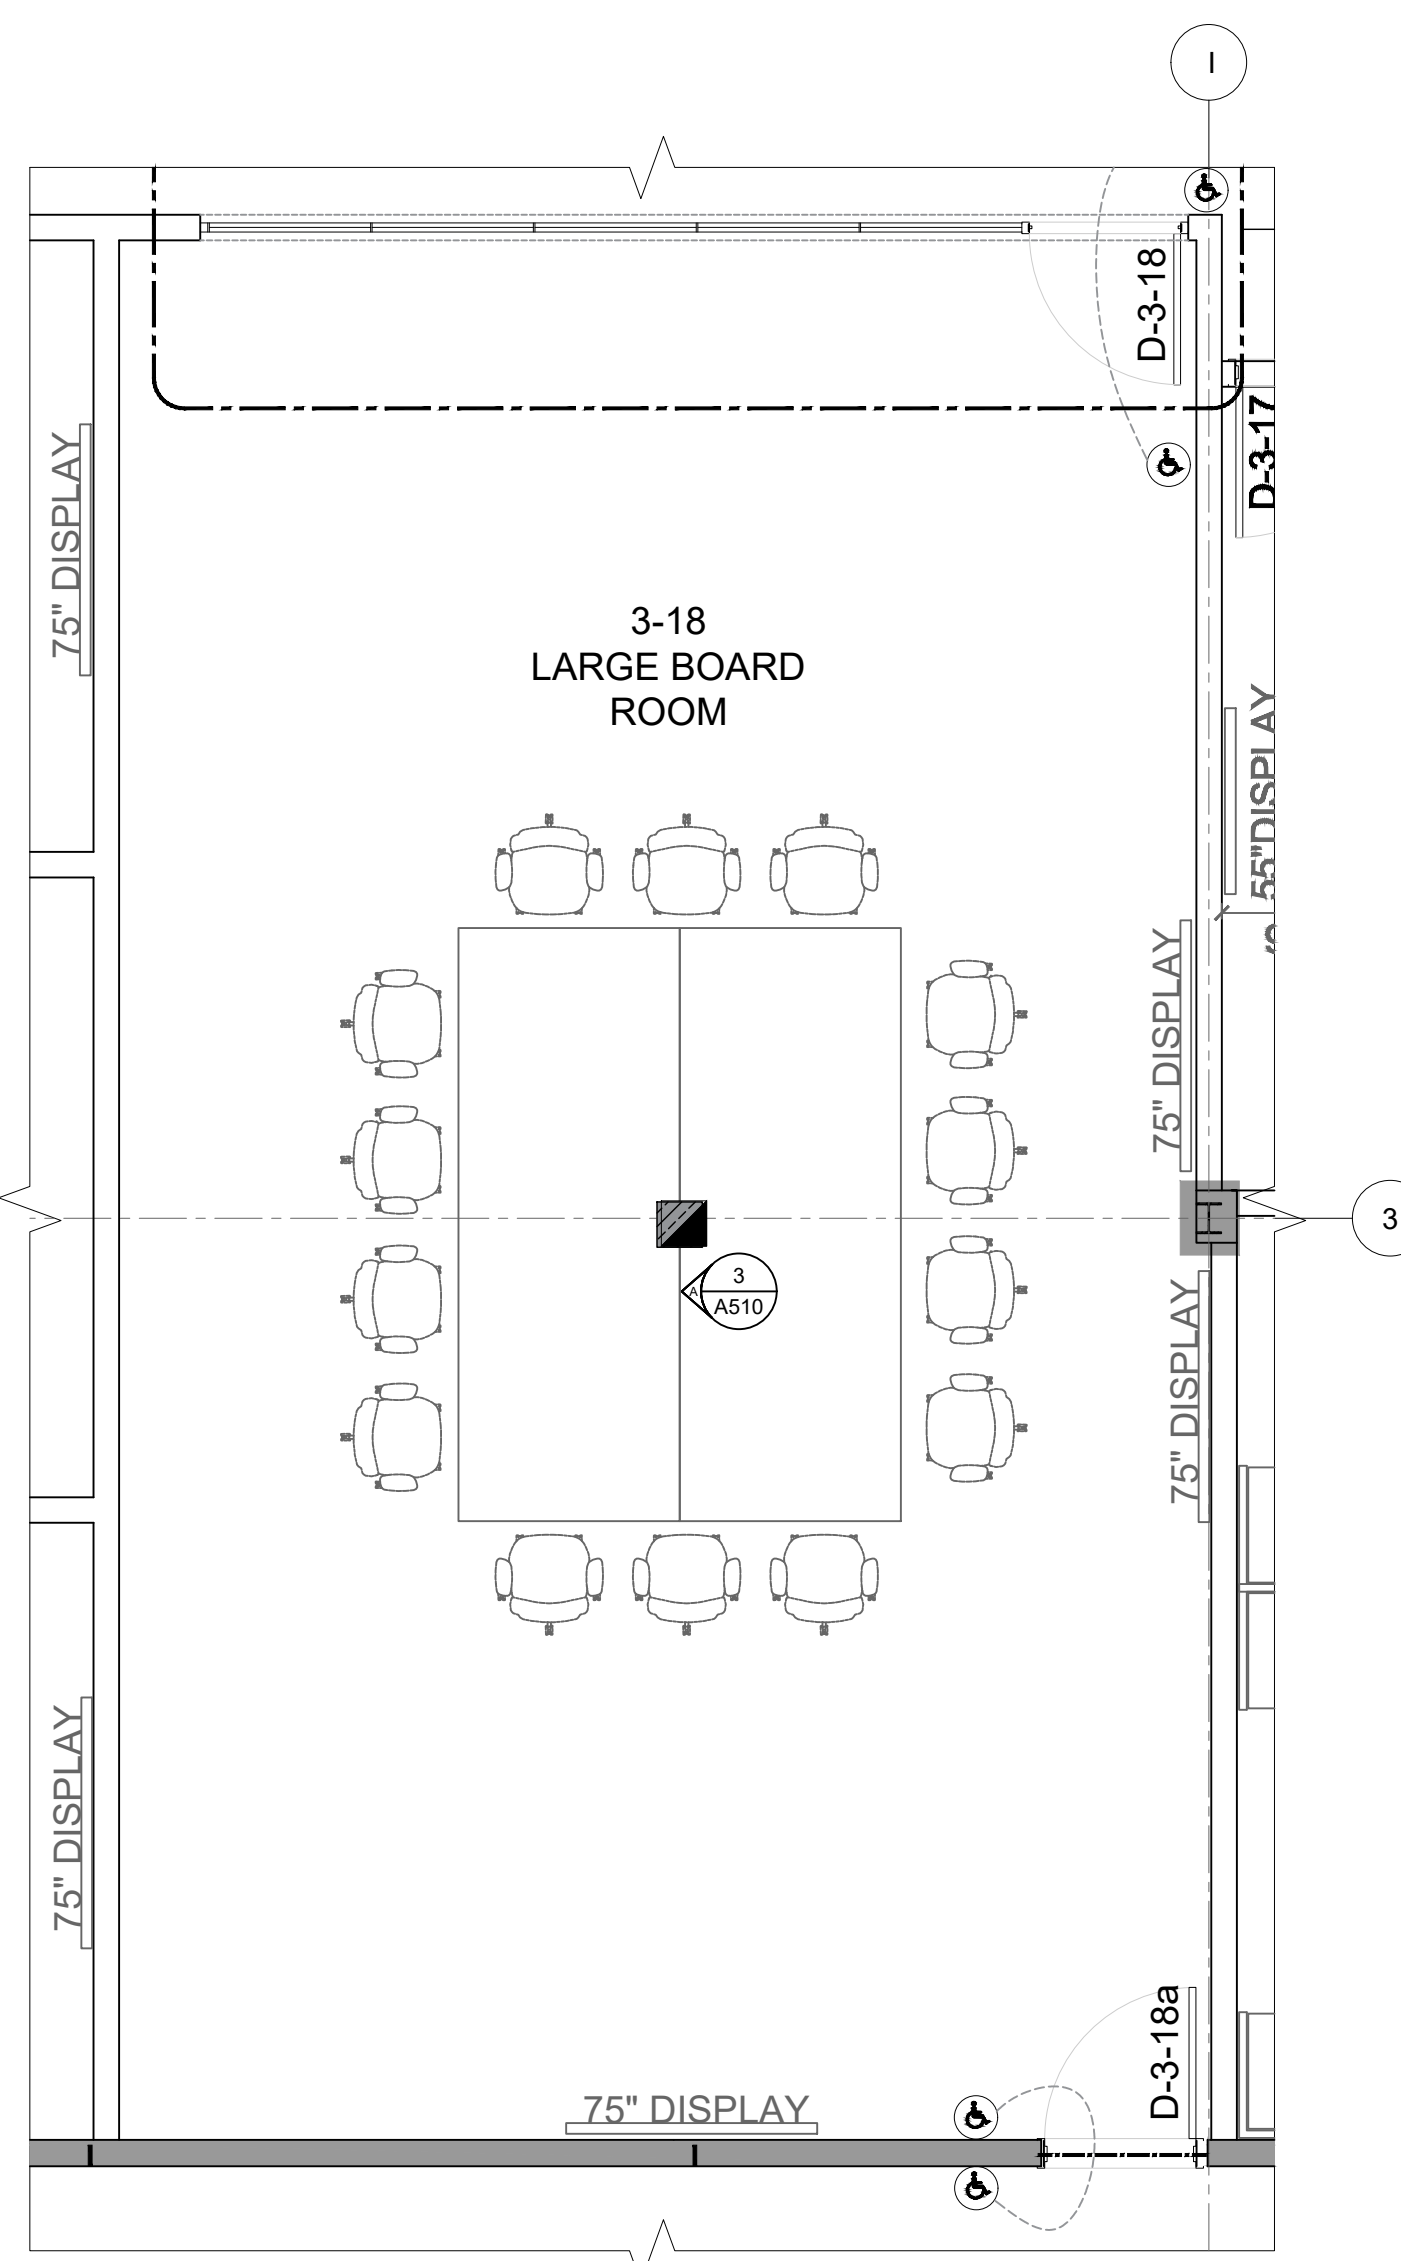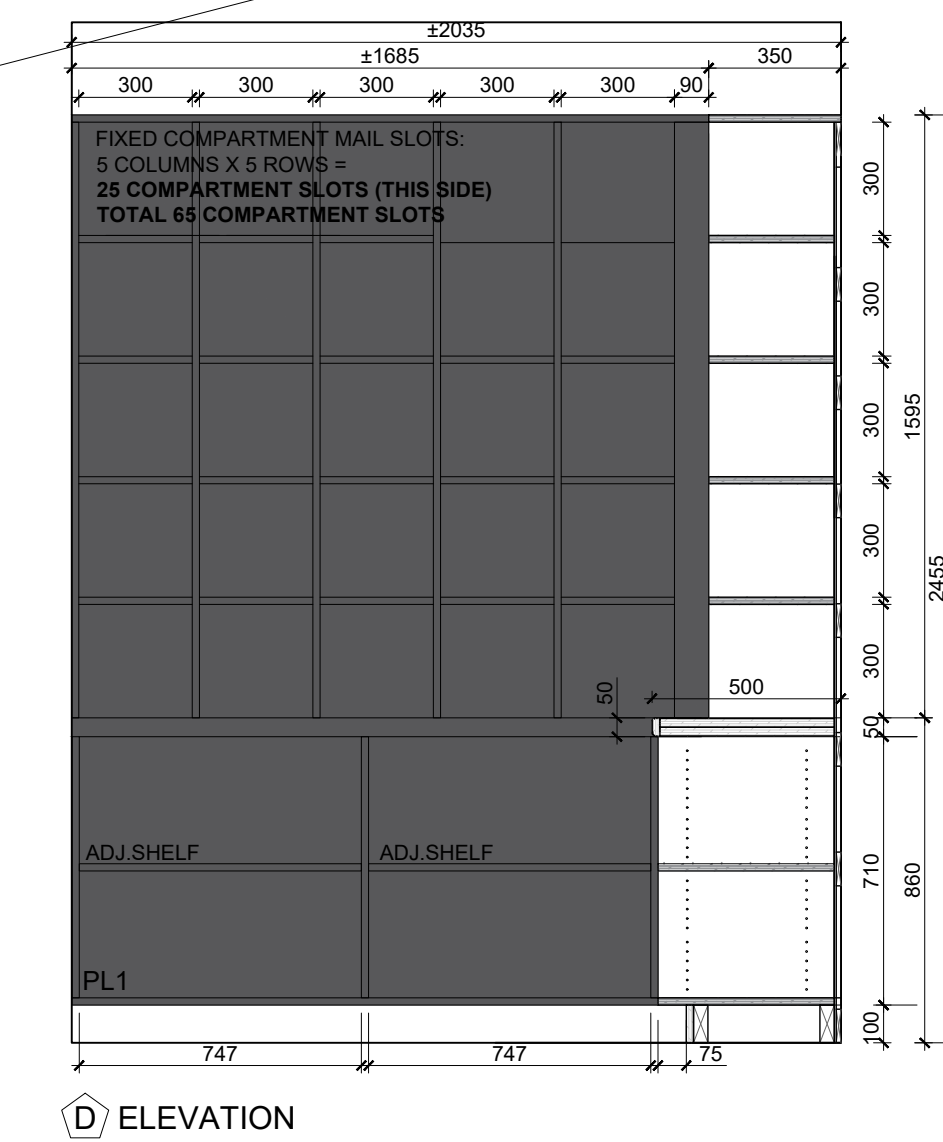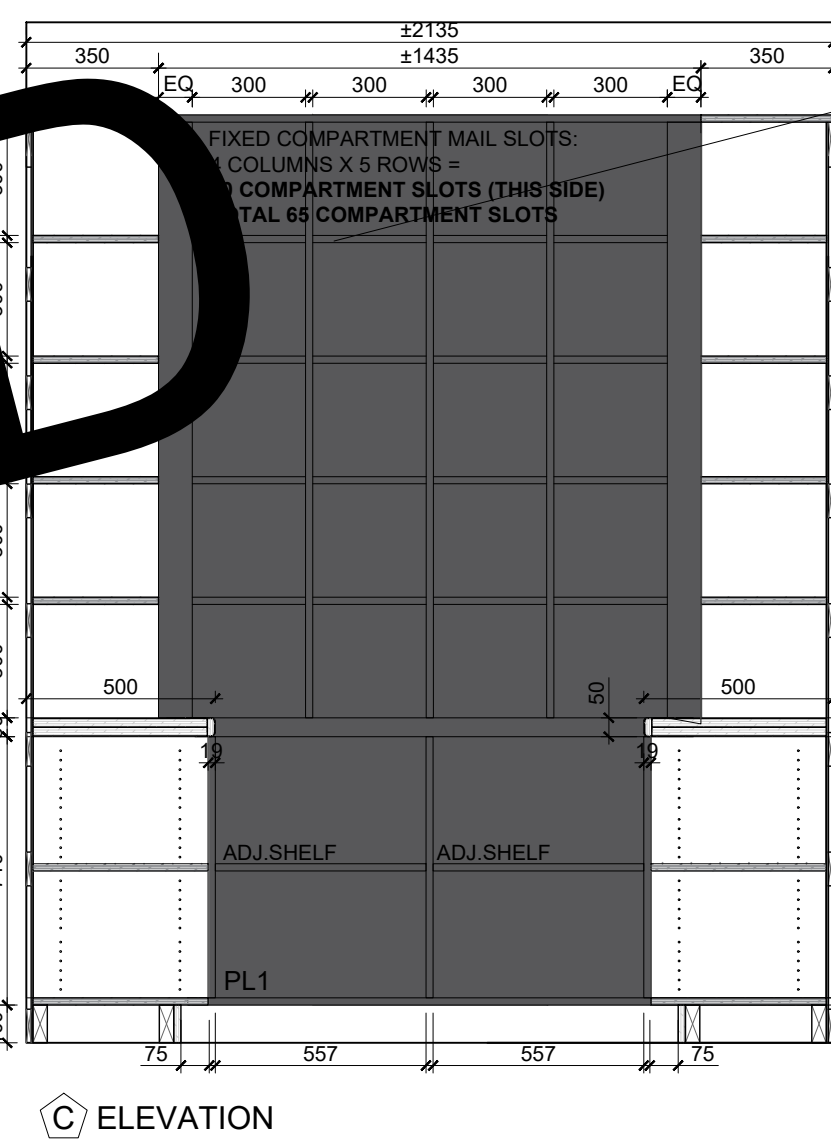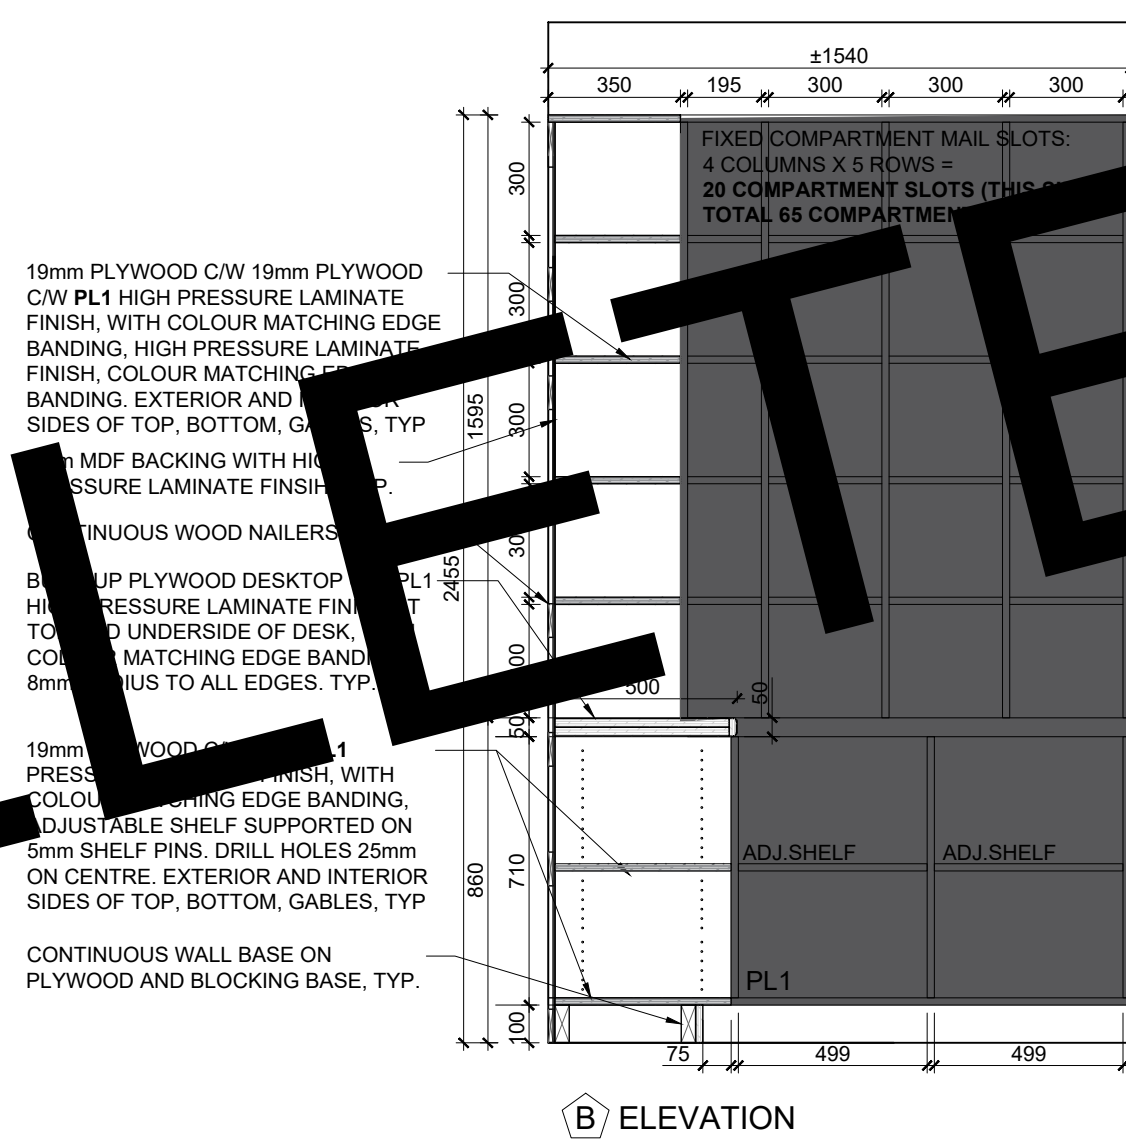

3
A510
INTERIOR ELEVATIONS- THIRD FLOOR LARGE BOARD ROOM
SCALE: 1:50

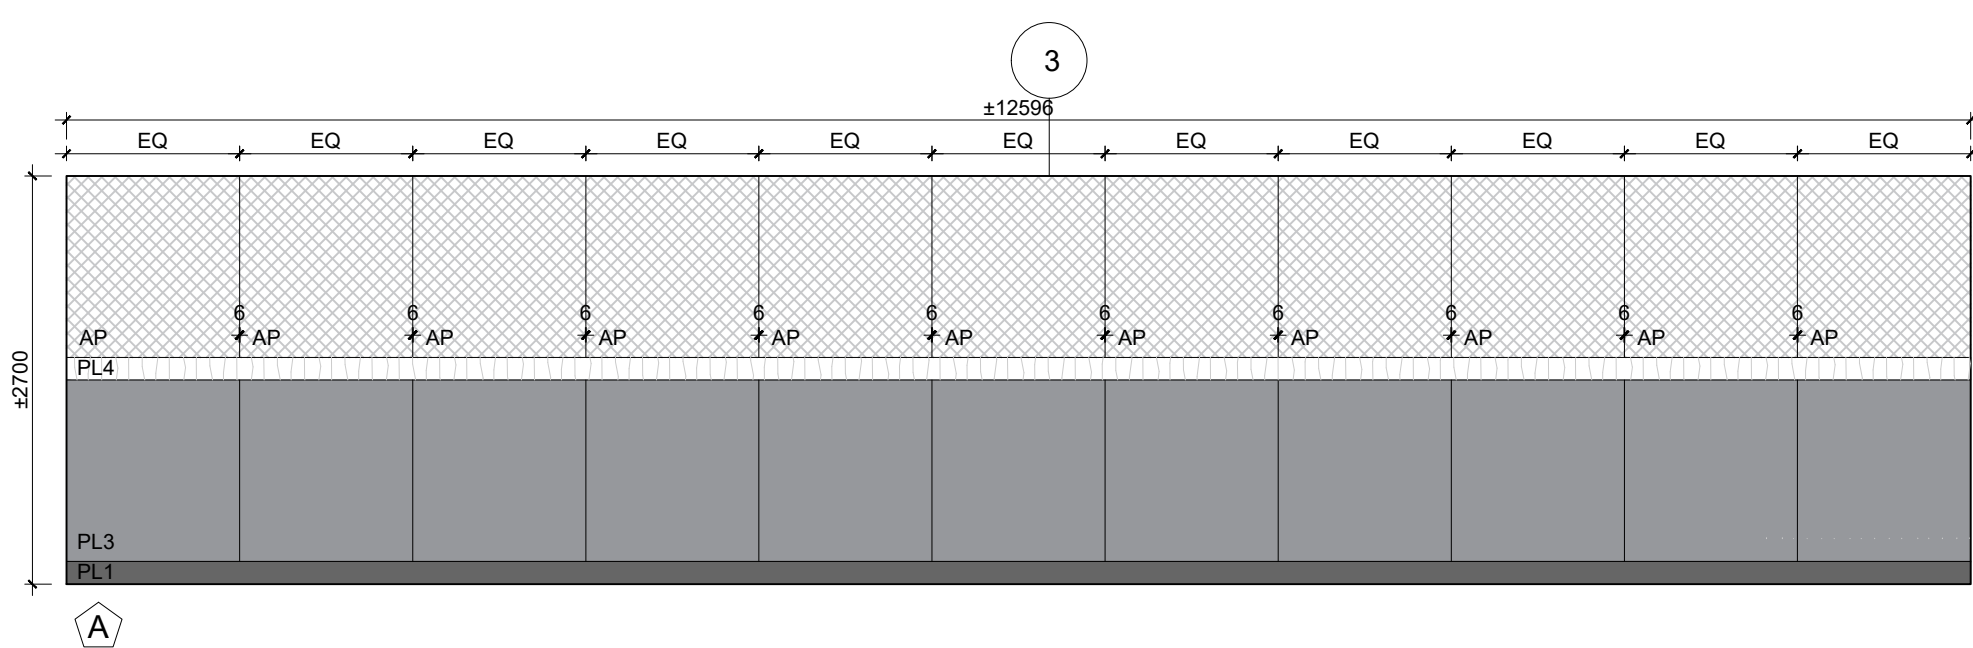

INTERIOR ELEVATIONS LEGEND	
PL1: HIGH PRESSURE LAMINATE FINISH- COLOUR 1	
PL3: HIGH PRESSURE LAMINATE FINISH- COLOUR 3	
PL4: HIGH PRESSURE LAMINATE FINISH- COLOUR 4	
AP: FABRIC WRAPPED ACOUSTIC WALL FINISH PANEL	
EX.	EXISTING
N.I.C.	NOT IN CONTRACT
TYP.	TYPICAL

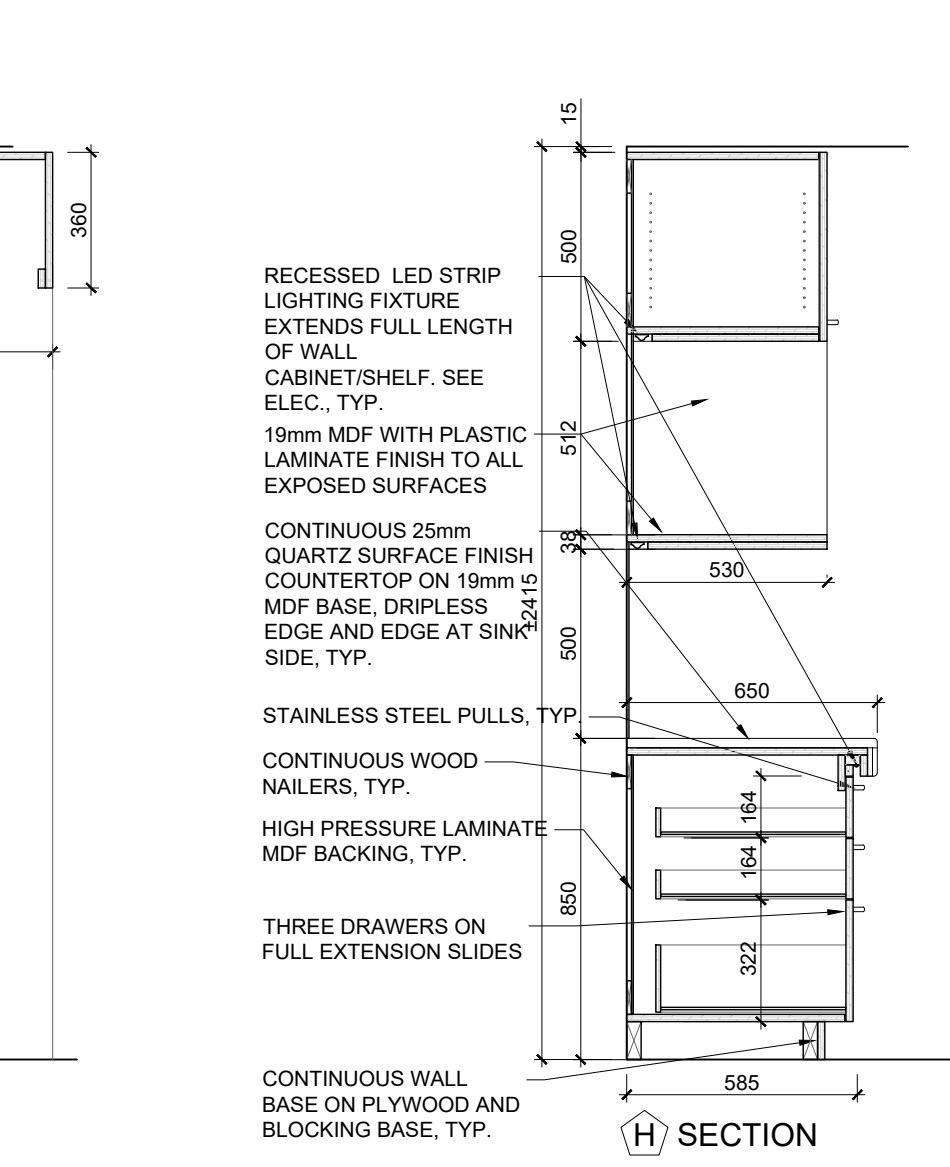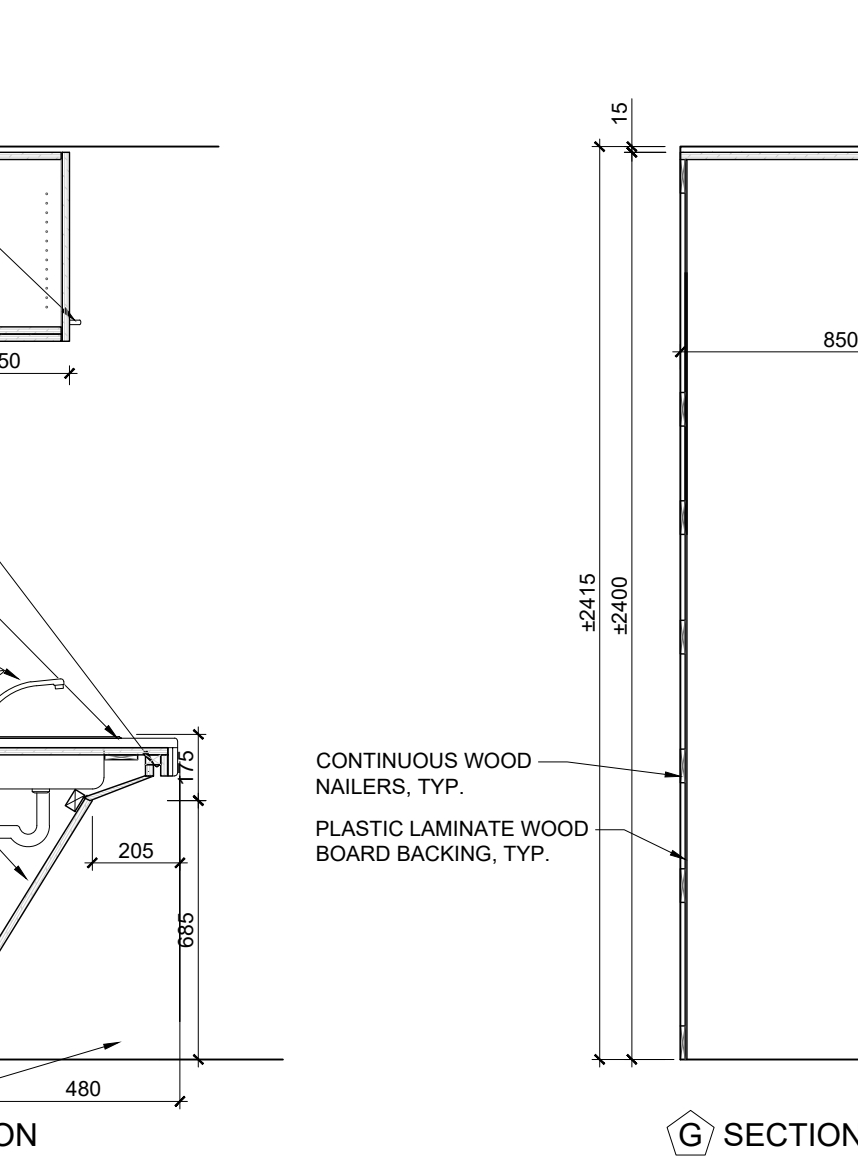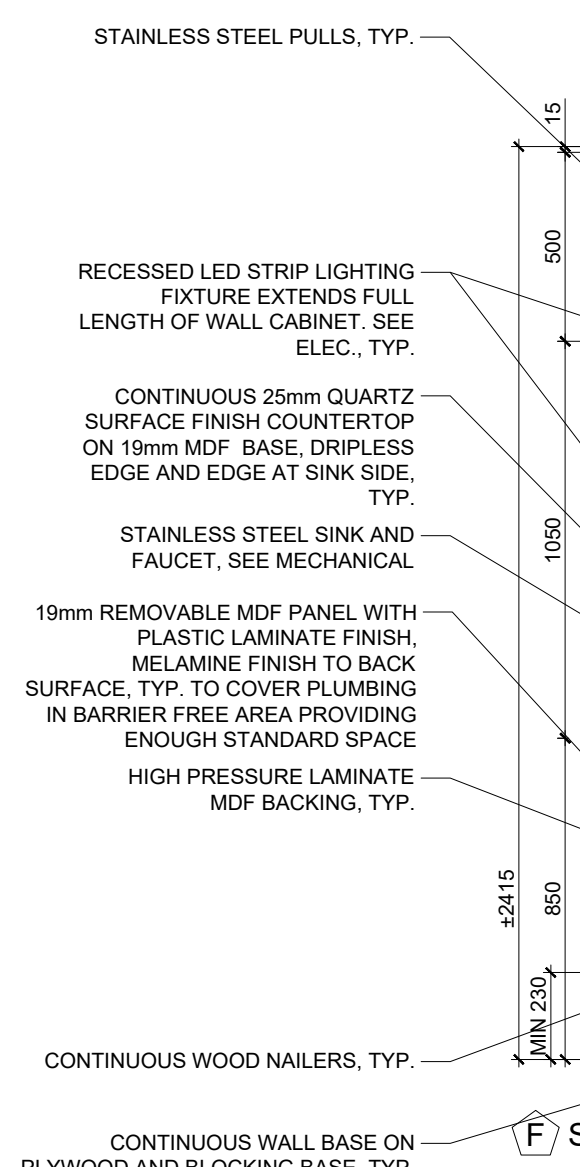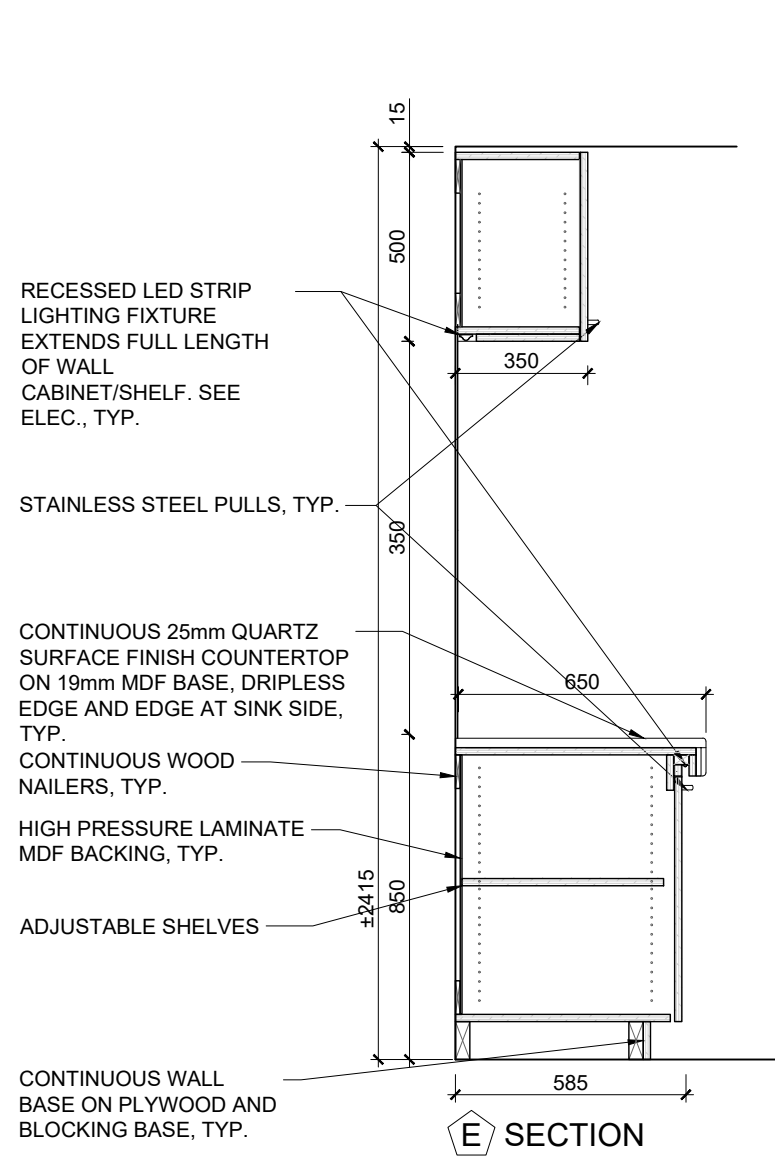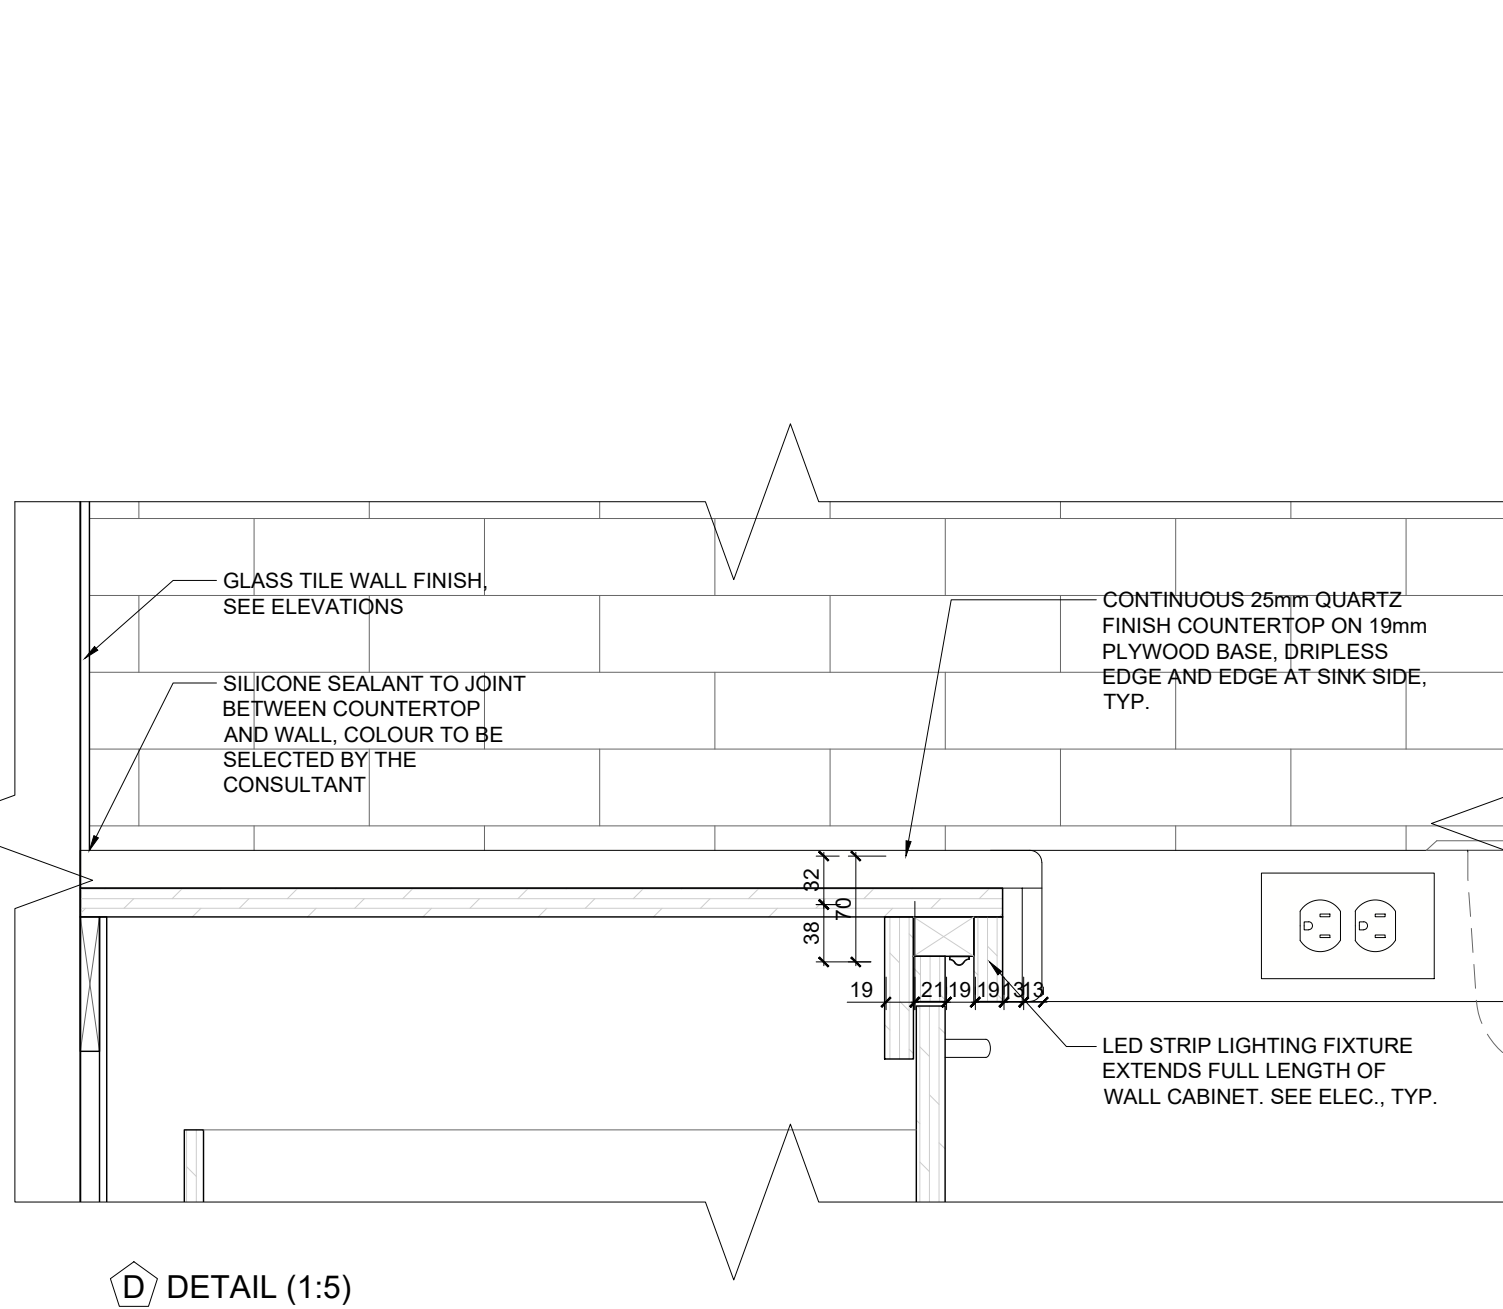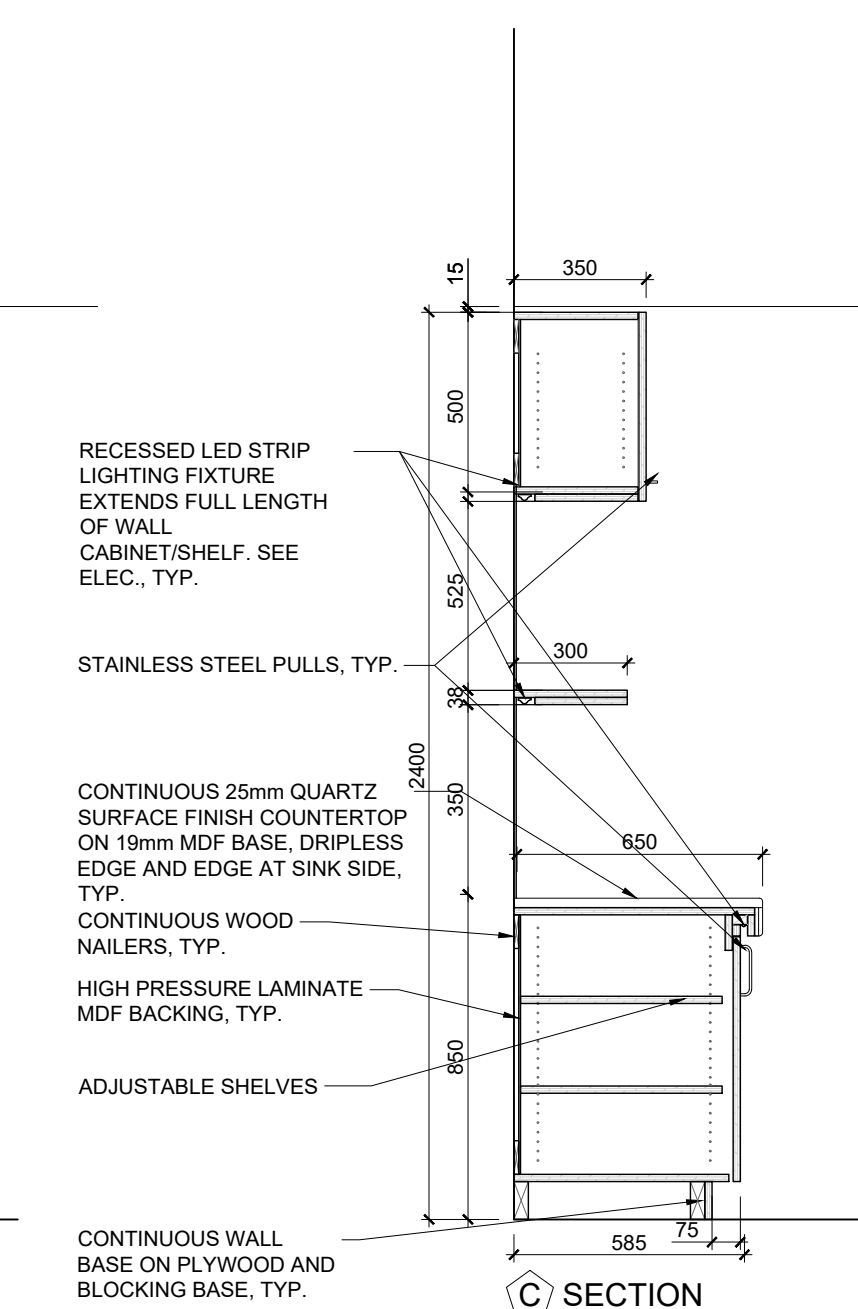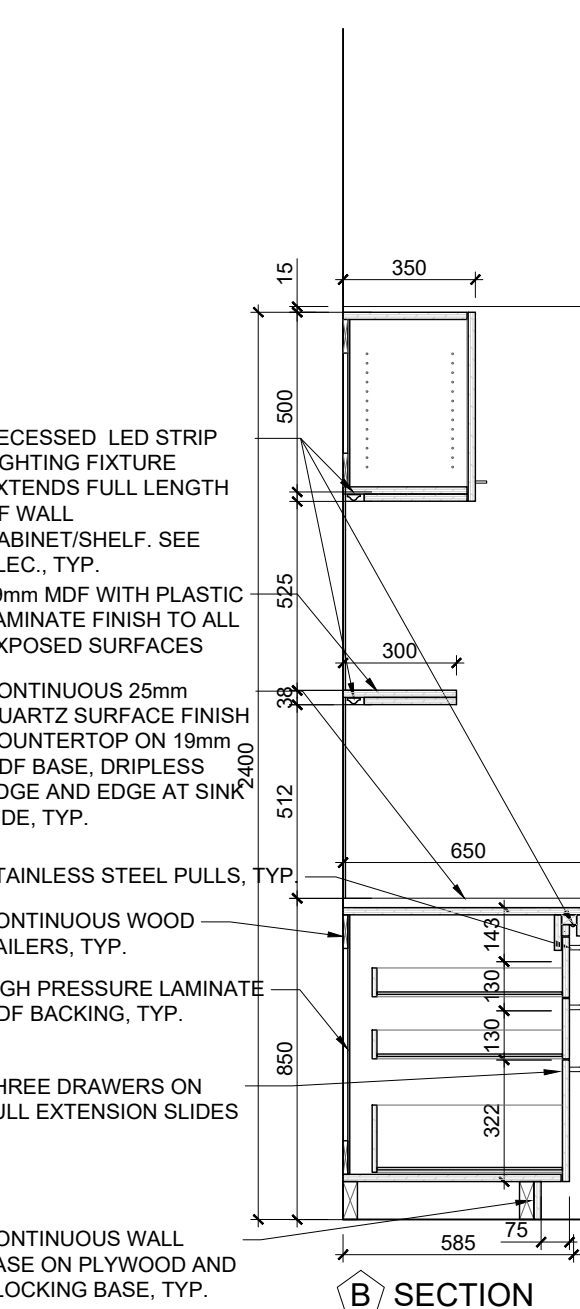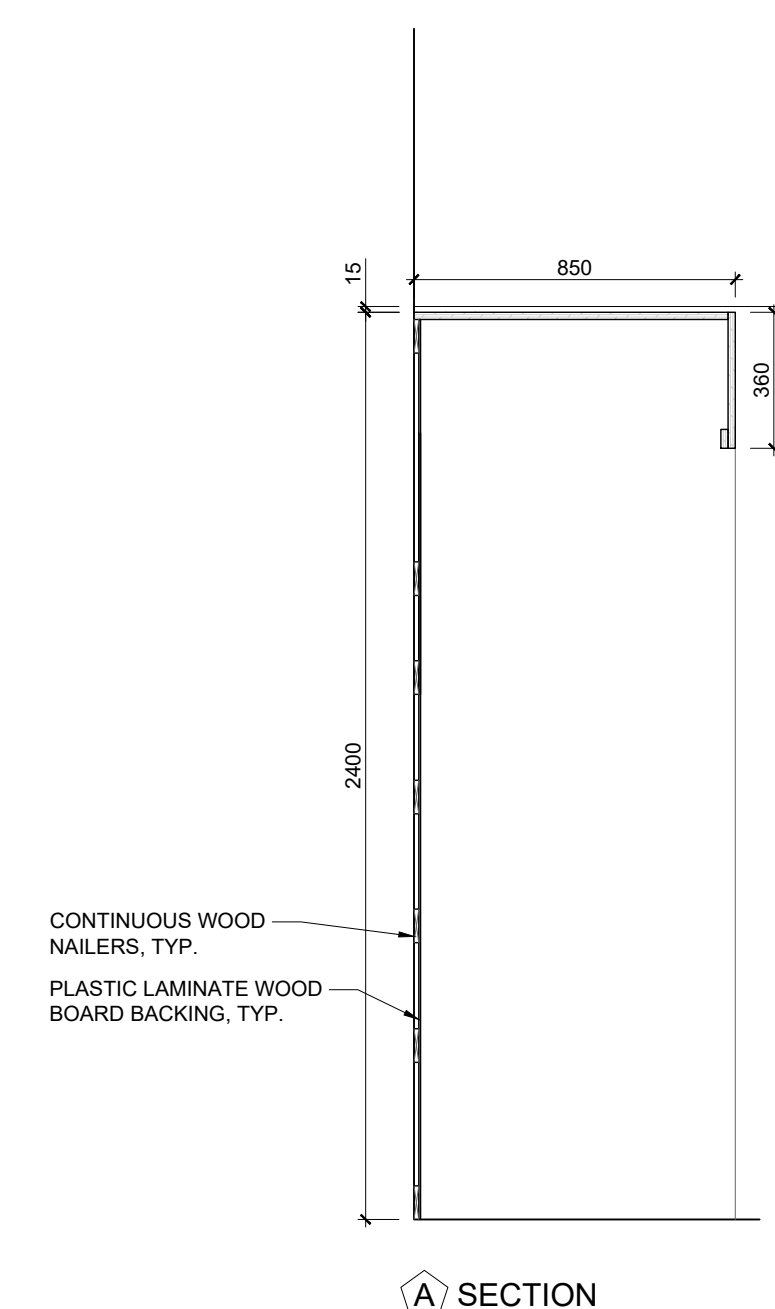

4
A510
TYPICAL KITCHENETTE MILLWORK DETAILS
SCALE: 1:20

12. ISSUED FOR TENDER	2026.05.01
11. ISSUED FOR BUILDING PERMIT	2026.04.08
10. ISSUED FOR 10% CLIENT REVIEW	2026.03.31
9. ISSUED FOR DESIGN DEVELOPMENT CLIENT REVIEW	2025.10.28
8. ISSUED FOR DESIGN DEVELOPMENT CLIENT REVIEW	2025.10.01
7. ISSUED FOR PRELIMINARY DESIGN CLIENT REVIEW	2025.09.03
6. ISSUED FOR PRELIMINARY DESIGN CLIENT REVIEW	2025.08.18
5. ISSUED FOR PRELIMINARY DESIGN CLIENT REVIEW	2025.08.12
4. ISSUED FOR PRELIMINARY DESIGN CLIENT REVIEW	2025.08.01
3. ISSUED FOR PRELIMINARY DESIGN CLIENT REVIEW	2025.07.30
2. ISSUED FOR PRELIMINARY DESIGN CLIENT REVIEW	2025.07.25
1. ISSUED FOR PRELIMINARY DESIGN CLIENT REVIEW	2025.07.14

NO. DESCRIPTION DATE

REVISIONS

PROJECT



REGION OF PEEL


EMIL V. KOLB CENTRE
PEEL REGIONAL POLICE FACILITY
INTERIOR RENOVATION PROJECT
181 DERRY ROAD EAST, MISSISSAUGA, ON L5T 2Y5



DESIGNED FOR: CONTRACTOR
STRUCTURAL CONSULTANT
STEPHENSON ENGINEERING
ELECTRICAL CONSULTANT
EXP SERVICES INC.

SHEET TITLE
INTERIOR ELEVATIONS & MILLWORK DETAILS

SHEET NO.	DRAWN BY	CHECKED
A510	CC	RN
SCALE	AS NOTED	

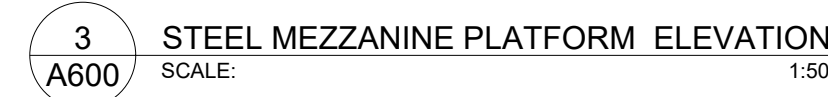

NOTES

1. GC IS RESPONSIBLE TO SUBMIT ENGINEER STAMPED SHOP DRAWINGS OF STEEL STAIRCASE, STEEL MEZZANINE PLATFORM, SLIDING DOOR AND TRACK SYSTEM DETAILS FOR ARCHITECT & ENGINEER'S APPROVAL.





REGION OF PEE


**EMIL V. KOLB CENTRE
PEEL REGIONAL POLICE FACILITY
INTERIOR RENOVATION PROJECT**
180 DERRY ROAD EAST, MISSISSAUGA, ON L5T 2Y5




<p>NORTH</p> <p>PROJECT LOCATION</p>	<p>ISSUED FOR CONSTRUCTION: _____ DATE: _____</p>
	<p>STRUCTURAL CONSULTANT</p> <p>Stephenson Engineering</p>
	<p>MECHANICAL CONSULTANT</p> <p>EXP Services Inc.</p>
	<p>ELECTRICAL CONSULTANT</p> <p>EXP Services Inc.</p>

SHEET TITLE	EXP. SERVICES INC.
STEEL PLATFORM & STAIRCASE DETAILS	


SHEET NO. A600	DRAWN BY CC	CHECKED RN
	PROJECT NO. 2520797	
	SCALE AS NOTED	

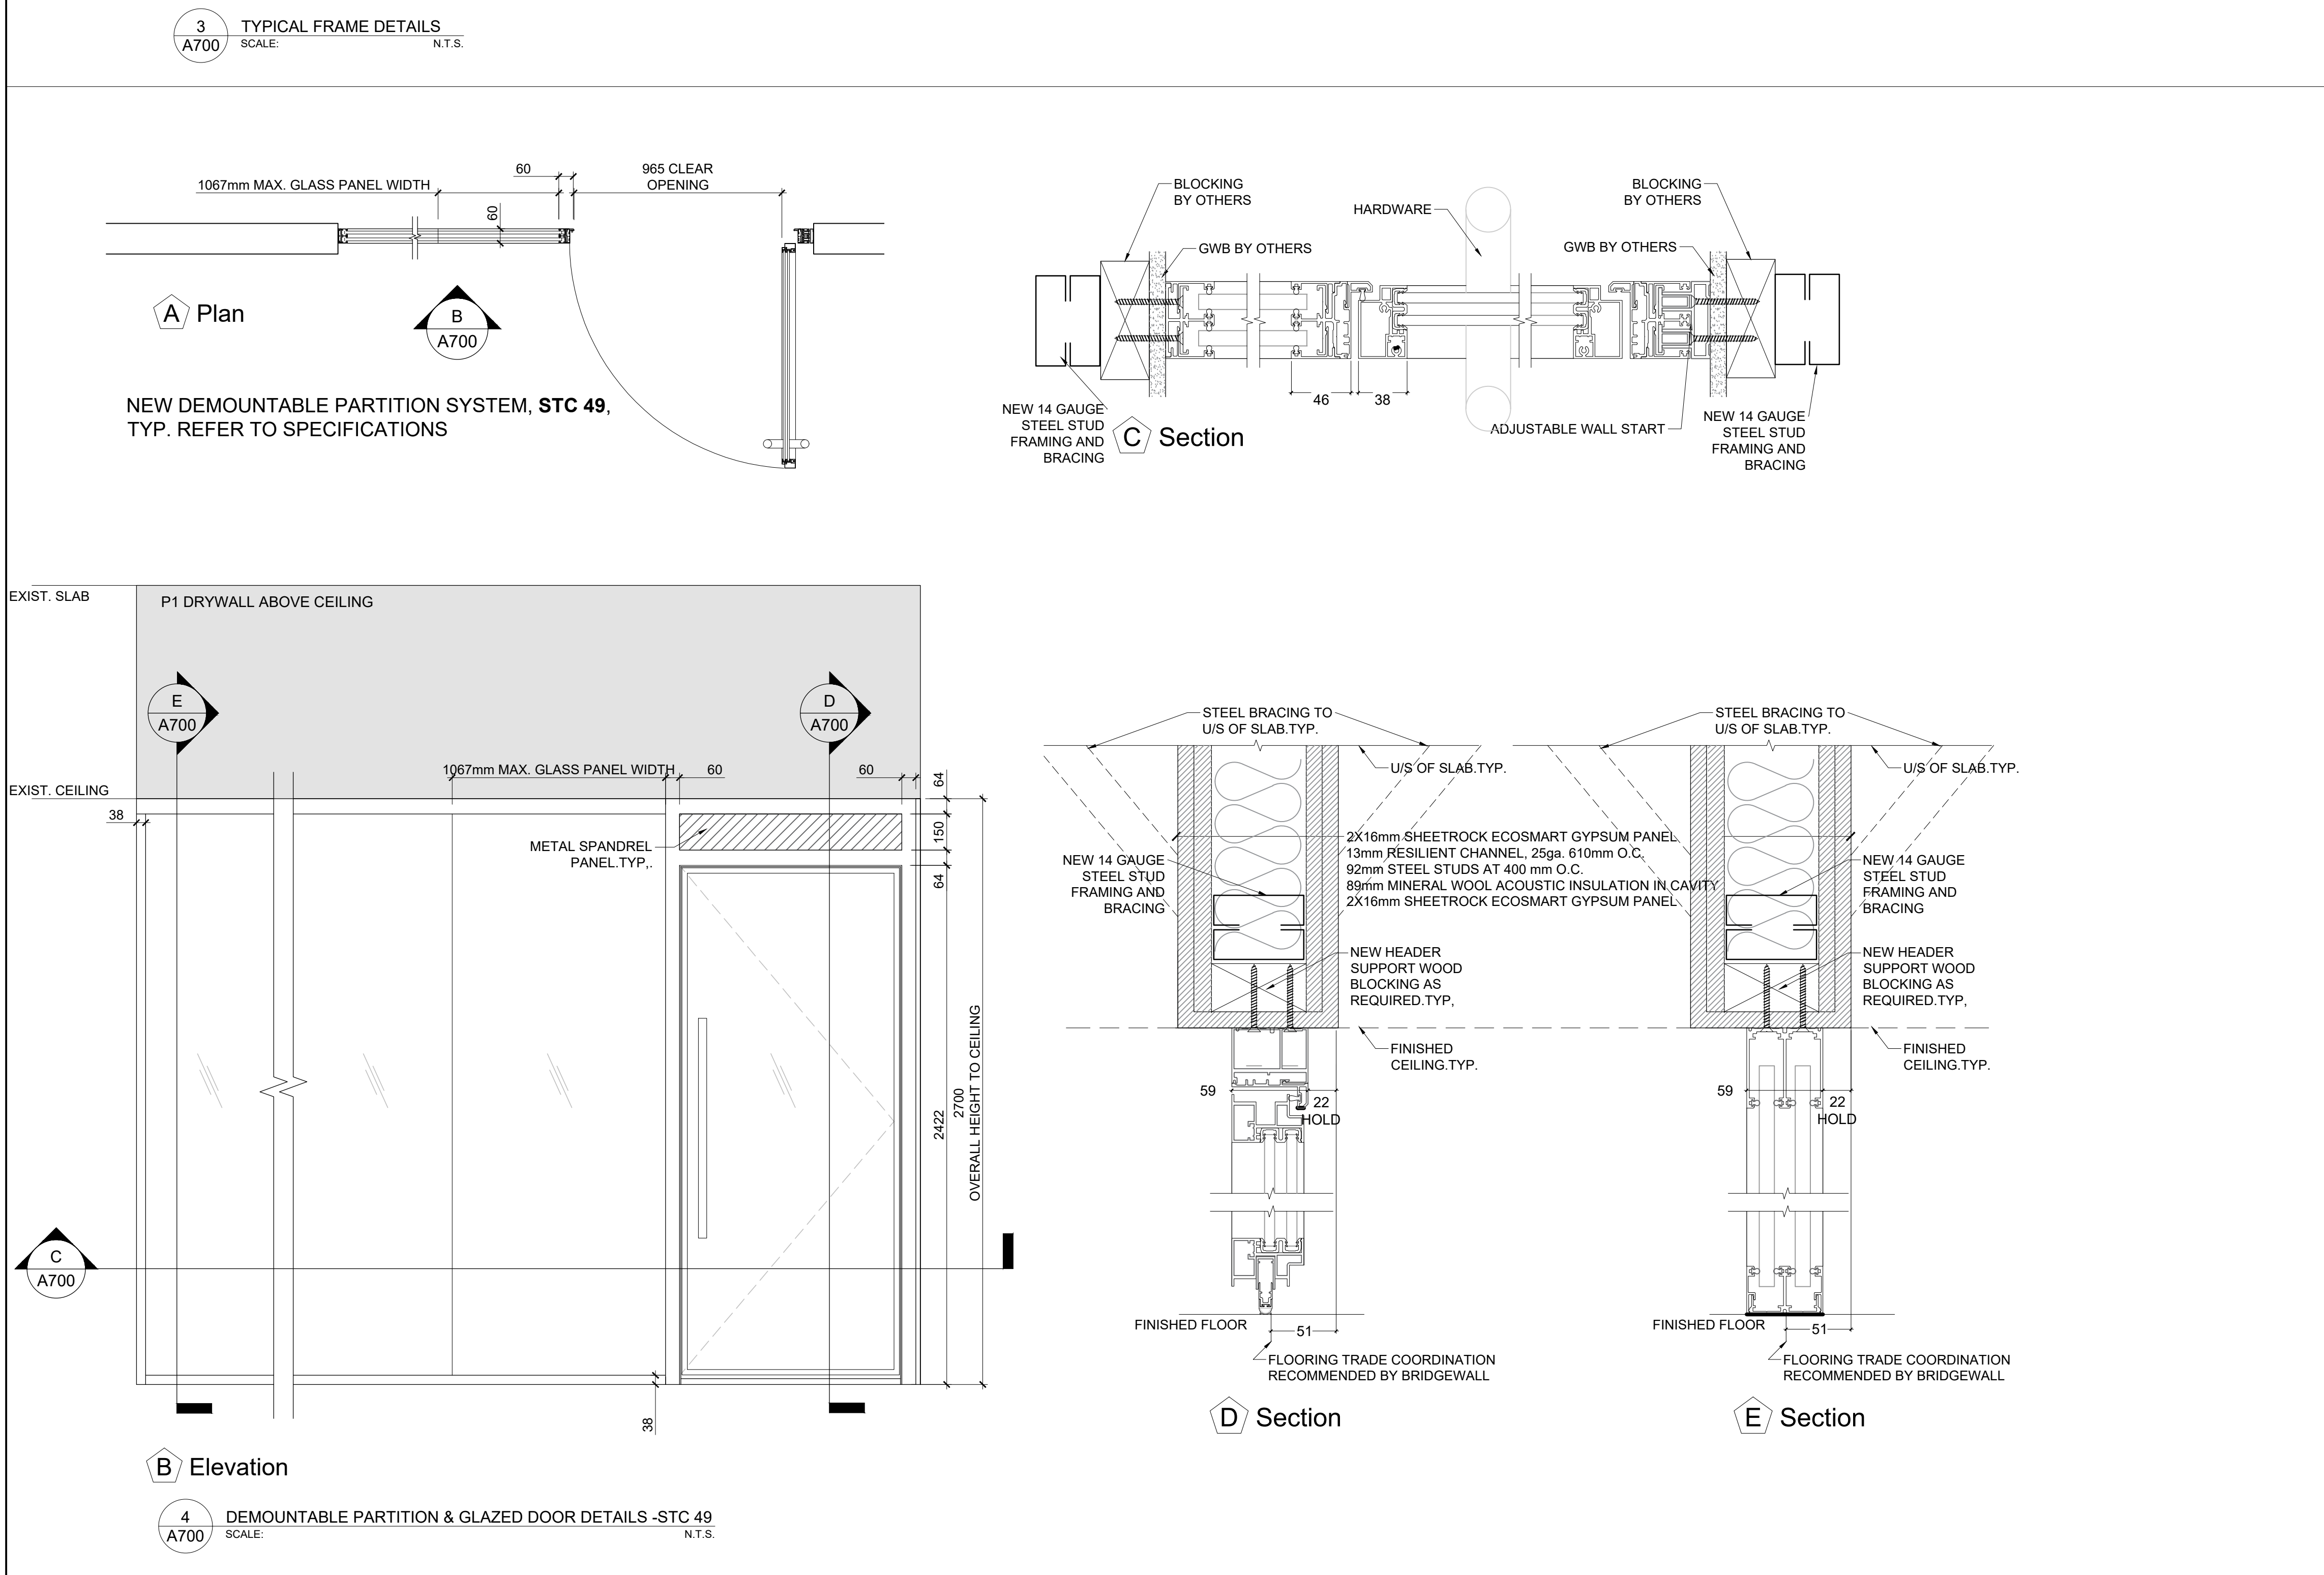[illegible]

ROOM FINISH SCHEDULE																	
BASEMENT FLOOR																	
ROOM NUMBER	ROOM NAME	FLOOR	FINISH	BASE MATERIAL	FINISH	NORTH WALL MATERIAL	FINISH	EAST WALL MATERIAL	FINISH	SOUTH WALL MATERIAL	FINISH	WEST WALL MATERIAL	FINISH	CEILING MATERIAL	FINISH	HEIGHT	NOTES
B0103a	VESTIBUL	EX	-	EX	-	EX	PT	EX	PT	EX	PT	EX	PT	EX	PT	22700	CEILING HEIGHT TO MATCH THE EXISTING CEILING HEIGHT
B0104	MEN'S WASHROOM	PCT	-	PTB	-	EX	PWT	EX	PWT	EX	PWT/GWT	EX	PWT	WGB	PT	22700	CEILING HEIGHT TO MATCH THE EXISTING CEILING HEIGHT HIGH DENSITY POLYETHYLENE (HDPE) TOILET PARTITIONS
B0105	MEN'S SHOWERS	PCT	-	PTB	-	CB/EX	PWT/GWT	CB/EX	PWT	CB/EX	PWT	CB/EX	PWT	WGB	PT	22700	CEILING HEIGHT TO MATCH THE EXISTING CEILING HEIGHT
B0105a	VESTIBUL	EX	-	EX	-	EX	PT	EX	PT	EX	PT	EX	PT	EX	PT	22700	CEILING HEIGHT TO MATCH THE EXISTING CEILING HEIGHT
B0107	WOMEN'S WASHROOM	PCT	-	PTB	-	EX	PWT	EX	PWT/GWT	EX	PWT	EX	PWT	WGB	PT	22700	CEILING HEIGHT TO MATCH THE EXISTING CEILING HEIGHT HIGH DENSITY POLYETHYLENE (HDPE) TOILET PARTITIONS
B0108	WOMEN'S SHOWERS	PCT	-	PTB	-	CB/EX	PWT/GWT	CB/EX	PWT	CB/EX	PWT/GWT	CB/EX	PWT	WGB	PT	22700	CEILING HEIGHT TO MATCH THE EXISTING CEILING HEIGHT
B0131	WOMEN'S WASHROOM	PCT	-	PTB	-	EX	PWT/GWT	EX	PWT	EX	PWT	EX	PWT	WGB	PT	22700	CEILING HEIGHT TO MATCH THE EXISTING CEILING HEIGHT HIGH DENSITY POLYETHYLENE (HDPE) TOILET PARTITIONS
B0132	WOMEN'S SHOWERS	PCT	-	PTB	-	CB	PWT/GWT	CB	PWT	CB	PWT	CB	PWT	WGB	PT	22700	CEILING HEIGHT TO MATCH THE EXISTING CEILING HEIGHT
B0138	MEN'S SHOWERS	PCT	-	PTB	-	CB	PWT/GWT	CB	PWT	CB	PWT/GWT	CB	PWT	WGB	PT	22700	CEILING HEIGHT TO MATCH THE EXISTING CEILING HEIGHT
B0139	MEN'S WASHROOM	PCT	-	PTB	-	EX	PWT	EX	PWT	EX	PWT	EX	PWT/GWT	WGB	PT	22700	CEILING HEIGHT TO MATCH THE EXISTING CEILING HEIGHT HIGH DENSITY POLYETHYLENE (HDPE) TOILET PARTITIONS
GROUND FLOOR																	
G-01	UNIFORM RECRUITING	CPT	-	RB	-	GB	PT	GB/EX	PT	EX/GB	PT	EX	PT	ACT	-	22700	CEILING HEIGHT TO MATCH THE EXISTING CEILING HEIGHT
G-02	INSPECTOR - I	CPT	-	RB	-	EX	PT	GB	PT	GB	PT	GB	PT	ACT	-	22700	CEILING HEIGHT TO MATCH THE EXISTING CEILING HEIGHT
G-03	STAFF SERGEANT	CPT	-	RB	-	EX	PT	GB	PT	GB	PT	GB	PT	ACT	-	22700	CEILING HEIGHT TO MATCH THE EXISTING CEILING HEIGHT
G-04	STAFF SERGEANT	CPT	-	RB	-	EX	PT	GB	PT	GB	PT	GB	PT	ACT	-	22700	CEILING HEIGHT TO MATCH THE EXISTING CEILING HEIGHT
G-05	FILED STATION	CPT	-	RB	-	GB	PT	GB	PT	GB	PT	GB	PT	ACT	-	22700	CEILING HEIGHT TO MATCH THE EXISTING CEILING HEIGHT
G-06	KITCHENETTE	LVT	-	RB	-	EX	PT	GB	PT	GB	PT/CT	GB	PT/CT	WGB/ACT	PT	22700	CEILING HEIGHT TO MATCH THE EXISTING CEILING HEIGHT
G-07	RECEPTION	LVT	-	RB	-	EX	PT	EX	PT	EX	PT	GB	PT	ACT/GB	PT	22700	CEILING HEIGHT TO MATCH THE EXISTING CEILING HEIGHT
G-08	PRINTING STATION	LVT	-	RB	-	GB	PT	GB	PT	GB	PT	GB	PT	ACT/GB	-	22700	CEILING HEIGHT TO MATCH THE EXISTING CEILING HEIGHT
G-09	WAITING AREA	LVT	-	RB	-	EX/GB	PT	EX	PT	GB	PT	GB	PT	ACT/GB	-	22700	CEILING HEIGHT TO MATCH THE EXISTING CEILING HEIGHT
G-10	BREAKOUT ROOM	CPT	-	RB	-	GB	PT	EX	PT	GB	PT	GB	PT	GB	-	22700	CEILING HEIGHT TO MATCH THE EXISTING CEILING HEIGHT
G-11	BREAKOUT ROOM	CPT	-	RB	-	GB	PT	EX	PT	GB	PT	GB	PT	GB	-	22700	CEILING HEIGHT TO MATCH THE EXISTING CEILING HEIGHT
G-12	BREAKOUT ROOM	CPT	-	RB	-	GB	PT	EX	PT	GB	PT	GB	PT	GB	-	22700	CEILING HEIGHT TO MATCH THE EXISTING CEILING HEIGHT
G-13	BREAKOUT ROOM	CPT	-	RB	-	GB	PT	EX	PT	EX	PT	GB	PT	GB	-	22700	CEILING HEIGHT TO MATCH THE EXISTING CEILING HEIGHT
G-14	CORRIDOR	CPT	-	RB	-	EX	PT	GB	PT	EX	PT	GB	PT	ACT	-	22700	CEILING HEIGHT TO MATCH THE EXISTING CEILING HEIGHT
G-15	MULTI-FAITH ROOM	LVT	-	RB	-	EX	PT	GB	PT	GB	PT	EX	PT	GB	-	22700	CEILING HEIGHT TO MATCH THE EXISTING CEILING HEIGHT
G-16	FITNESS UNIT	CPT	-	RB	-	EX/GB	PT	EX	PT	EX/GB	PT	EX/GB	PT	ACT	-	22700	CEILING HEIGHT TO MATCH THE EXISTING CEILING HEIGHT
G-17	BREAKOUT ROOM	CPT	-	RB	-	GB	PT	GB	PT	EX	PT	EX	PT	GB	-	22700	CEILING HEIGHT TO MATCH THE EXISTING CEILING HEIGHT
G-18	HEALTH ROOM	SV	-	RB	-	GB	PT	EX	PT	EX	PT	EX/GB	PT	ACT	-	22700	CEILING HEIGHT TO MATCH THE EXISTING CEILING HEIGHT
G-19	TREATMENT ROOM	SV	-	RB	-	EX	PT	EX	PT	GB	PT	EX	PT	ACT	-	22700	CEILING HEIGHT TO MATCH THE EXISTING CEILING HEIGHT
G-20	RECRUITER TALENT ACQUISITION	CPT	-	RB	-	EX/GB	PT	EX	PT	GB	PT	EX	PT	ACT	-	22700	CEILING HEIGHT TO MATCH THE EXISTING CEILING HEIGHT
G-21	MAIL ROOM	LVT	-	RB	-	EX	PT	GB	PT	GB	PT	EX	PT	ACT	-	22700	CEILING HEIGHT TO MATCH THE EXISTING CEILING HEIGHT
G-22(a,b)	SUPERVISOR CIVILIAN RECRUITING & EMPLOYMENT	CPT	-	RB	-	EX/GB	PT	EX/GB	PT	EX	PT	EX/GB	PT	ACT	-	22700	CEILING HEIGHT TO MATCH THE EXISTING CEILING HEIGHT
G-23	TEST ROOM	CPT	-	RB	-	GB	PT	GB	PT	GB	PT	GB	PT	ACT	-	22700	CEILING HEIGHT TO MATCH THE EXISTING CEILING HEIGHT
G-24	TEST ROOM	CPT	-	RB	-	GB	PT	EX	PT	GB	PT	GB	PT	ACT	-	22700	CEILING HEIGHT TO MATCH THE EXISTING CEILING HEIGHT
1092	WOMEN'S WASHROOM	PCT	-	PTB	-	EX	PWT	EX	PWT	EX	PWT	EX	PWT/GWT	WGB	PT	22700	CEILING HEIGHT TO MATCH THE EXISTING CEILING HEIGHT HIGH DENSITY POLYETHYLENE (HDPE) TOILET PARTITIONS
1093	MEN'S WASHROOM	PCT	-	PTB	-	EX	PWT	EX	PWT/GWT	EX	PWT	EX	PWT	WGB	PT	22700	CEILING HEIGHT TO MATCH THE EXISTING CEILING HEIGHT HIGH DENSITY POLYETHYLENE (HDPE) TOILET PARTITIONS
1095	LUNCH ROOM	LVT	-	RB	-	EX	PT	EX	PT/CT	EX	PT	EX	PT	ACT/GB	PT	22700	VARIES REFER TO RCP
1096	KITCHENETTE	LVT	-	RB	-	EX	PT	EX	PT/CT	EX	PT	EX	PT	ACT/GB	PT	22700	VARIES REFER TO RCP
1098	GYM EQUIPMENT	EX*	-	PTB	-	EX	PT	EX	PT	EX	PT	EX	PT	EX	-	-	* PATCH AND REPAIR CONCRETE TO MATCH EXISTING. M & A 1, TYP.
1137a	VESTIBUL	PCT	-	PTB	-	EX	PWT	EX	PWT	EX	PWT	EX	PWT	WGB	PT	22700	CEILING HEIGHT TO MATCH THE EXISTING CEILING HEIGHT
1137	WOMEN'S WASHROOM	PCT	-	PTB	-	EX	PWT	EX	PWT	EX	PWT	EX	PWT/GWT	WGB	PT	22700	CEILING HEIGHT TO MATCH THE EXISTING CEILING HEIGHT HIGH DENSITY POLYETHYLENE (HDPE) TOILET PARTITIONS
1138	MEN'S WASHROOM	PCT	-	PTB	-	EX	PWT	EX	PWT	EX	PWT	EX	PWT/GWT	WGB	PT	22700	CEILING HEIGHT TO MATCH THE EXISTING CEILING HEIGHT HIGH DENSITY POLYETHYLENE (HDPE) TOILET PARTITIONS
1177	PUBLIC WASHROOM	PCT	-	PTB	-	EX	PWT	EX	PWT	EX	PWT	EX	PWT/GWT	WGB	PT	22700	CEILING HEIGHT TO MATCH THE EXISTING CEILING HEIGHT HIGH DENSITY POLYETHYLENE (HDPE) TOILET PARTITIONS
SECOND FLOOR																	
2-01	COMMERCIAL AUTO CRIME	PCT	-	RB	-	EX	PT	EX/GB	PT	EX/GB/GB	PT	EX	PT	ACT	-	22700	CEILING HEIGHT TO MATCH THE EXISTING CEILING HEIGHT
2-02	OFFICE	PCT	-	RB	-	GB	PT	EX	PT	GB	PT	GB	PT	ACT	-	22700	CEILING HEIGHT TO MATCH THE EXISTING CEILING HEIGHT
2124	VESTIBULE	PCT	-	PTB	-	EX	PWT	EX	PWT	EX	PWT	EX	PWT	WGB	PT	22700	CEILING HEIGHT TO MATCH THE EXISTING CEILING HEIGHT
2125a	VESTIBULE	PCT	-	PTB	-	EX	PWT	EX	PWT	EX	PWT	EX	PWT	WGB	PT	22700	CEILING HEIGHT TO MATCH THE EXISTING CEILING HEIGHT
2125	WOMEN'S WASHROOM	PCT	-	PTB	-	EX	PWT	EX	PWT	EX	PWT/GWT	EX	PWT	WGB	PT	22700	CEILING HEIGHT TO MATCH THE EXISTING CEILING HEIGHT HIGH DENSITY POLYETHYLENE (HDPE) TOILET PARTITIONS
2126	MEN'S WASHROOM	PCT	-	PTB	-	EX	PWT/GWT	EX	PWT	EX	PWT	EX	PWT	WGB	PT	22700	CEILING HEIGHT TO MATCH THE EXISTING CEILING HEIGHT HIGH DENSITY POLYETHYLENE (HDPE) TOILET PARTITIONS
2133	VESTIBUL	PCT	-	PTB	-	EX	PWT	EX	PWT	EX	PWT	EX	PWT	WGB	PT	22700	CEILING HEIGHT TO MATCH THE EXISTING CEILING HEIGHT
2134	KID'S WASHROOM	PCT	-	PTB	-	EX	PWT	EX	PWT	EX	PWT	EX	PWT/GWT	WGB	PT	22700	CEILING HEIGHT TO MATCH THE EXISTING CEILING HEIGHT
2135	VESTIBULE	PCT	-	PTB	-	EX	PWT	EX	PWT	EX	PWT	EX	PWT	WGB	PT	22700	CEILING HEIGHT TO MATCH THE EXISTING CEILING HEIGHT
2136	WOMEN'S WASHROOM	PCT	-	PTB	-	EX	PWT	EX	PWT	EX	PWT	EX	PWT/GWT	WGB	PT	22700	CEILING HEIGHT TO MATCH THE EXISTING CEILING HEIGHT HIGH DENSITY POLYETHYLENE (HDPE) TOILET PARTITIONS
2137	MEN'S WASHROOM	PCT	-	PTB	-	WGB	PWT	EX	PWT/GWT	EX	PWT	WGB	PWT	WGB	PT	22700	CEILING HEIGHT TO MATCH THE EXISTING CEILING HEIGHT HIGH DENSITY POLYETHYLENE (HDPE) TOILET PARTITIONS
THIRD FLOOR																	
3-01	COVERT	CPT	-	RB	-	EX	PT	EX	PT	EX	PT	EX	PT	ACT	-	22710	CEILING HEIGHT TO MATCH THE EXISTING CEILING HEIGHT
3-02	WARD	CPT	-	RB	-	EX	PT	EX	PT	EX	PT	EX	PT	ACT	-	22710	CEILING HEIGHT TO MATCH THE EXISTING CEILING HEIGHT
3-03	CORRIDOR	CPT	-	RB	-	EX/GB	PT	EX	PT	EX	PT	EX	PT	ACT	-	22710	CEILING HEIGHT TO MATCH THE EXISTING CEILING HEIGHT
3-03a	CORRIDOR	CPT	-	RB	-	EX	PT	EX/GB	PT	-	-	EX	PT	ACT	-	22710	CEILING HEIGHT TO MATCH THE EXISTING CEILING HEIGHT
3-04	SUPERINTENDENT	CPT	-	RB	-	GB	PT	EX	PT	GB	PT	GB	PT	ACT	-	22710	CEILING HEIGHT TO MATCH THE EXISTING CEILING HEIGHT
3-05	MEDIUM BOARD ROOM	CPT	-	RB	-	GB	PT	GB	PT	EX	PT	GB	PT	ACT/GB	PT	22710±2400	CEILING HEIGHT TO MATCH THE EXISTING CEILING HEIGHT
3-06	MAIL ROOM	LVT	-	RB	-	EX/GB	PT	EX	PT	EX	PT	EX/GB	PT	ACT	-	22710	CEILING HEIGHT TO MATCH THE EXISTING CEILING HEIGHT
3-07	INSPECTOR	CPT	-	RB	-	GB	PT	GB	PT	GB	PT	GB	PT	ACT	-	22710	CEILING HEIGHT TO MATCH THE EXISTING CEILING HEIGHT
3-08	INSPECTOR	CPT	-	RB	-	GB	PT	GB	PT	GB	PT	GB	PT	ACT	-	22710	CEILING HEIGHT TO MATCH THE EXISTING CEILING HEIGHT
3-09	D/S OFFICE	CPT	-	RB	-	GB	PT	GB	PT	GB	PT	GB	PT	ACT	-	22710	CEILING HEIGHT TO MATCH THE EXISTING CEILING HEIGHT
3-10	D/S OFFICE	CPT	-	RB	-	GB	PT	GB	PT	GB	PT	GB	PT	ACT	-	22710	CEILING HEIGHT TO MATCH THE EXISTING CEILING HEIGHT
3-11	D/S OFFICE	CPT	-	RB	-	GB	PT	GB	PT	GB	PT	GB	PT	ACT	-	22710	CEILING HEIGHT TO MATCH THE EXISTING CEILING HEIGHT
3-12	ADMIN	CPT	-	RB	-	GB	PT	GB	PT	-	-	GB	PT	ACT	-	22710	CEILING HEIGHT TO MATCH THE EXISTING CEILING HEIGHT
3-13	CORRIDOR	CPT	-	RB	-	GB	PT	GB	PT	EX/GB	PT	EX/GB	PT	ACT	-	22710	CEILING HEIGHT TO MATCH THE EXISTING CEILING HEIGHT
3-14	CORRIDOR	CPT	-	RB	-	GB	PT	GB	PT	GB	PT	GB	PT	ACT	-	22710	CEILING HEIGHT TO MATCH THE EXISTING CEILING HEIGHT
3-15	ISS	CPT	-	RB	-	GB	PT	EX	PT	EX	PT	GB	PT	ACT	-	22710	CEILING HEIGHT TO MATCH THE EXISTING CEILING HEIGHT
3-16	BREAKOUT ROOM	CPT	-	RB	-	GB	PT	GB	PT	EX	PT	GB	PT	GB	-	22710	CEILING HEIGHT TO MATCH THE EXISTING CEILING HEIGHT
3-17	AFU	CPT	-	RB	-	GB	PT	GB	PT	EX	PT	GB	PT	ACT	-	22710	CEILING HEIGHT TO MATCH THE EXISTING CEILING HEIGHT
3-18	LARGE BOARD ROOM	CPT	-	RB	-	GB/DMP	PT	GB	PT	EX	PT	GB	APHPL	ACT/GB	PT	22710±2400	CEILING HEIGHT TO MATCH THE EXISTING CEILING HEIGHT
3-19	PROJECT ROOM	CPT	-	RB	-	GB	PT	GB	PT	GB	PT	GB	PT	ACT	-	22710	CEILING HEIGHT TO MATCH THE EXISTING CEILING HEIGHT
3-20	PROJECT ROOM	CPT	-	RB	-	GB	PT	GB	PT	GB	PT	GB	PT	ACT	-	22710	CEILING HEIGHT TO MATCH THE EXISTING CEILING HEIGHT
3-21	PROJECT ROOM	CPT	-	RB	-	GB	PT	GB	PT	EX	PT	GB	PT	ACT	-	22710	CEILING HEIGHT TO MATCH THE EXISTING CEILING HEIGHT
3-22	CORRIDOR	CPT	-	RB	-	GB	PT	GB	PT	-	-	EX/GB	PT	ACT	-	22710	CEILING HEIGHT TO MATCH THE EXISTING CEILING HEIGHT
3-23	PROJECT ROOM	CPT	-	RB	-	GB	PT	GB	PT	GB	PT	GB	PT	ACT	-	22710	CEILING HEIGHT TO MATCH THE EXISTING CEILING HEIGHT
3-24	BREAKOUT ROOM	CPT	-	RB	-	GB	PT	GB	PT	GB	PT	GB	PT	GB	-	22710	CEILING HEIGHT TO MATCH THE EXISTING CEILING HEIGHT
3-25	KITCHEN	LVT	-	RB	-	GB	PT	GB	PT								

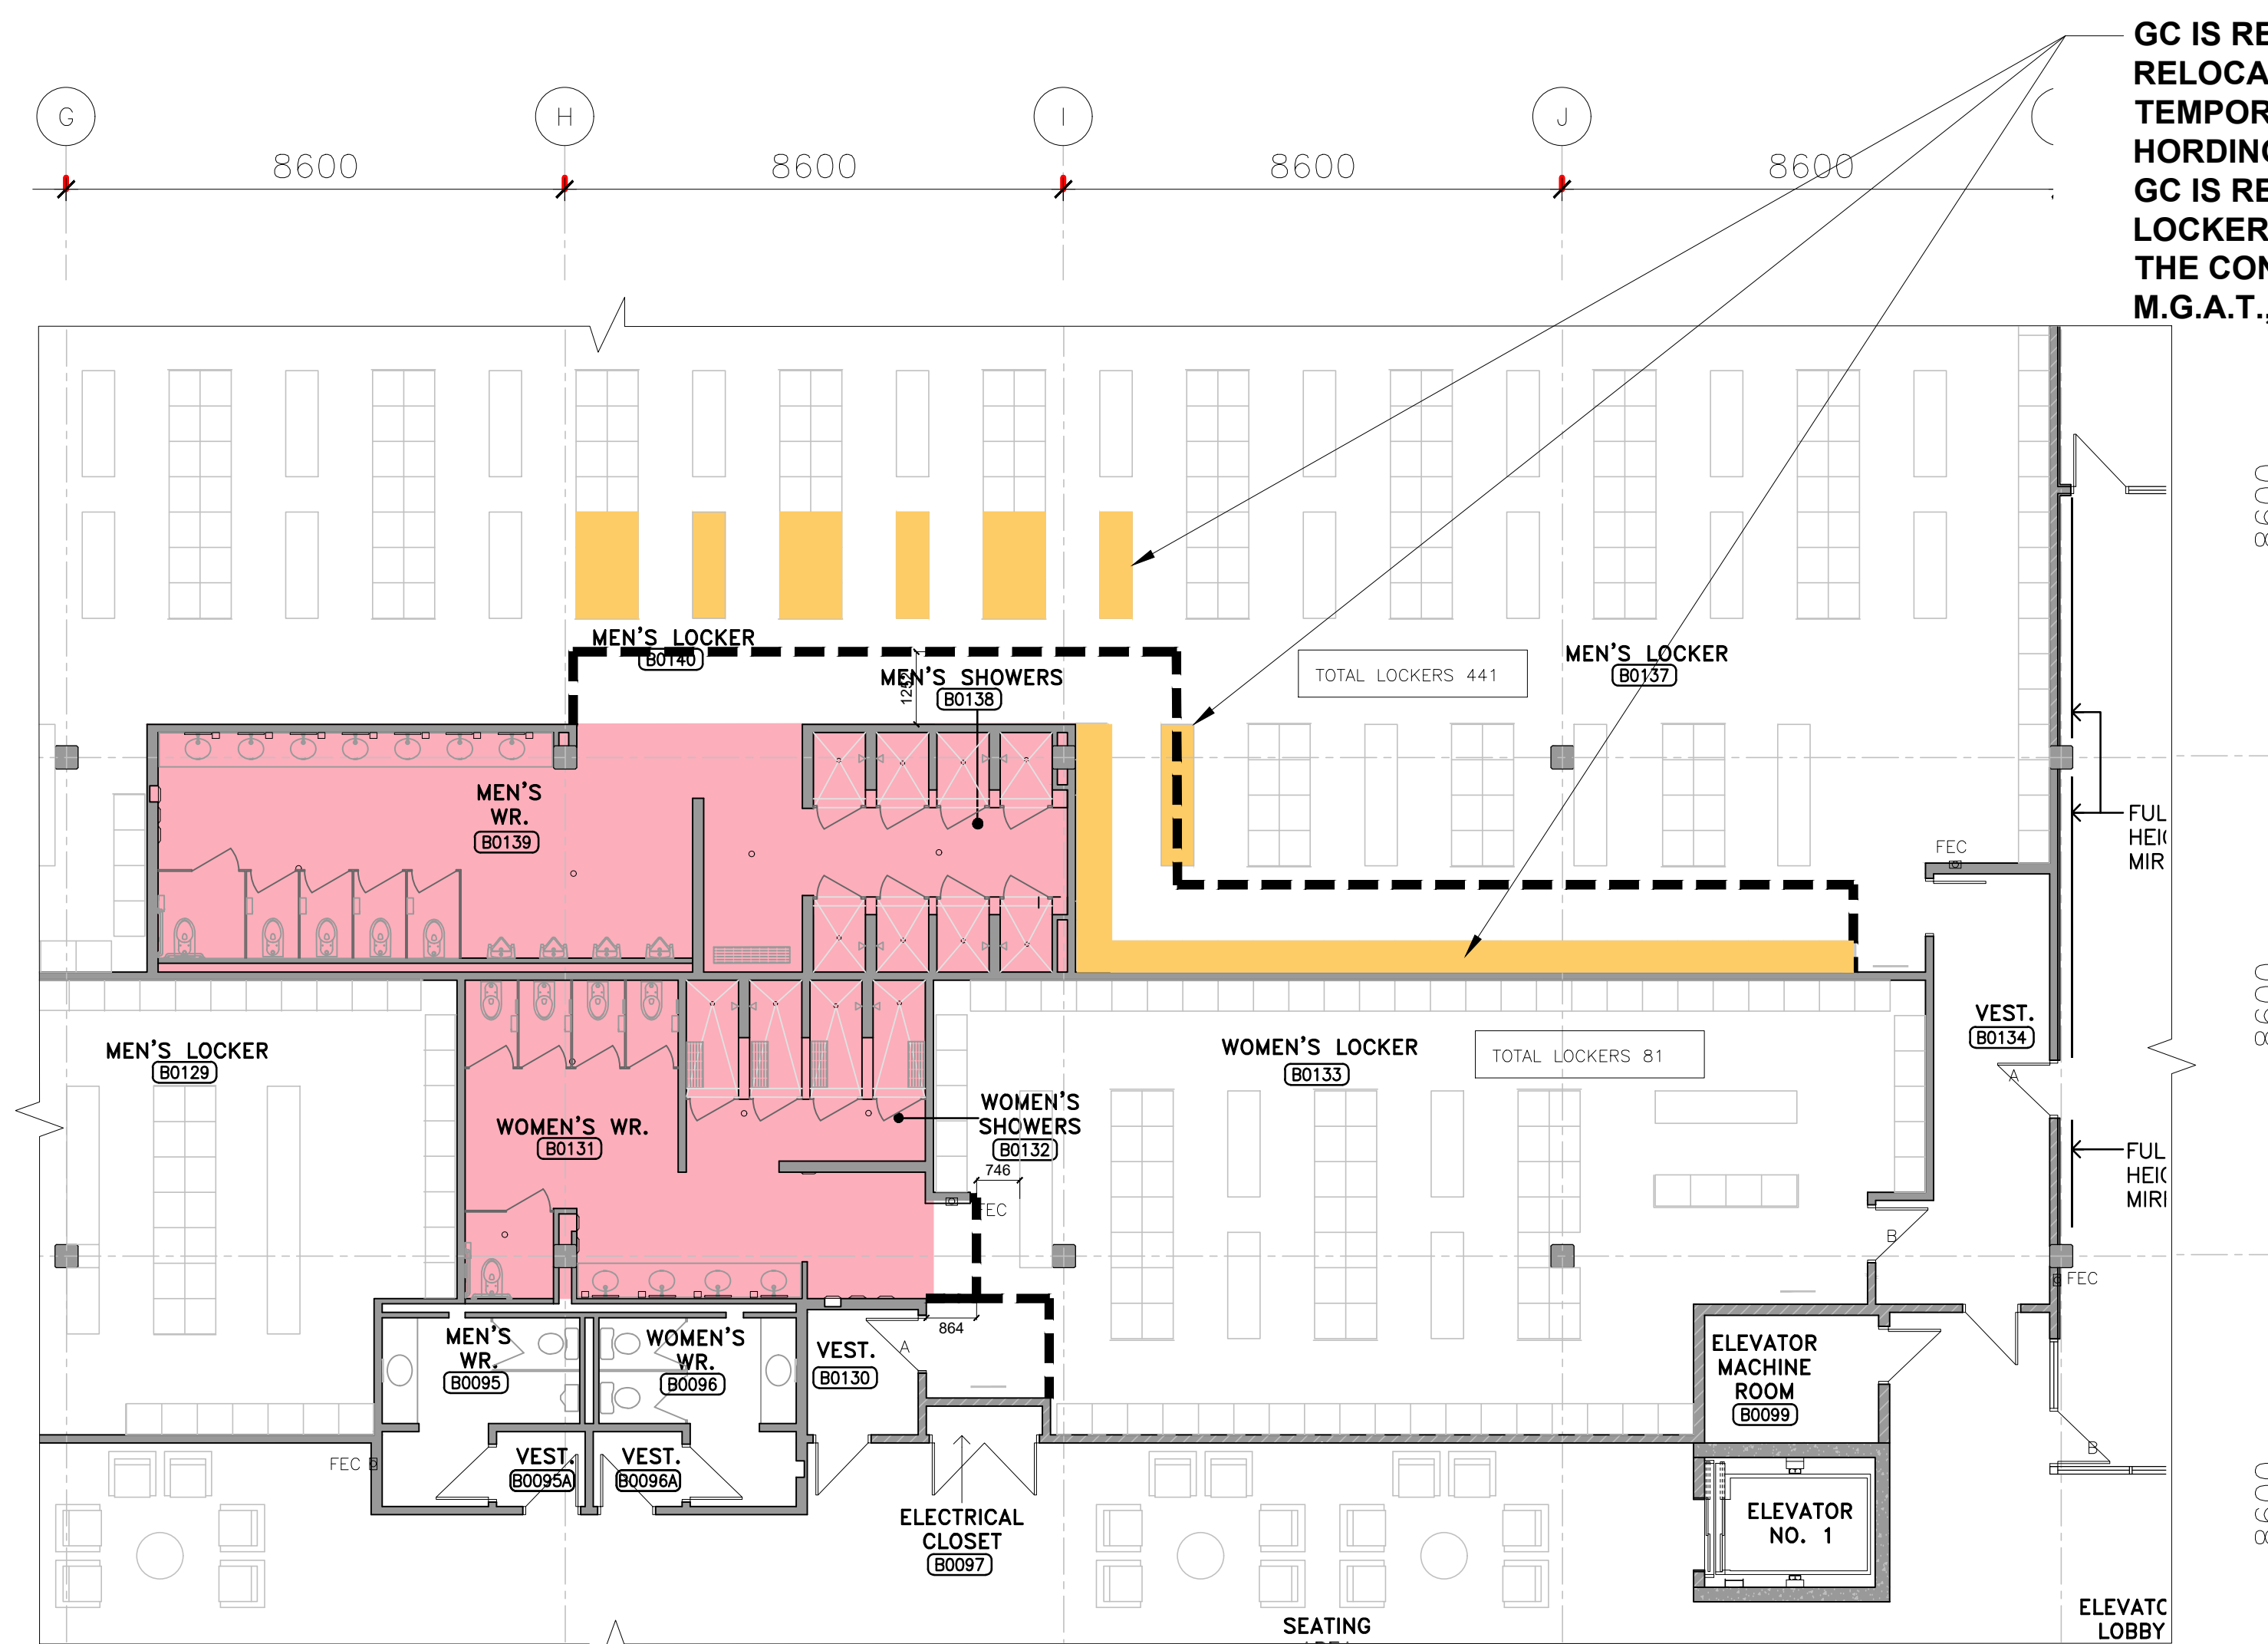

1 PHASING PLAN - BASEMENT FLOOR (B0131, B0132, B0138, B0139)
SCALE: 1:100

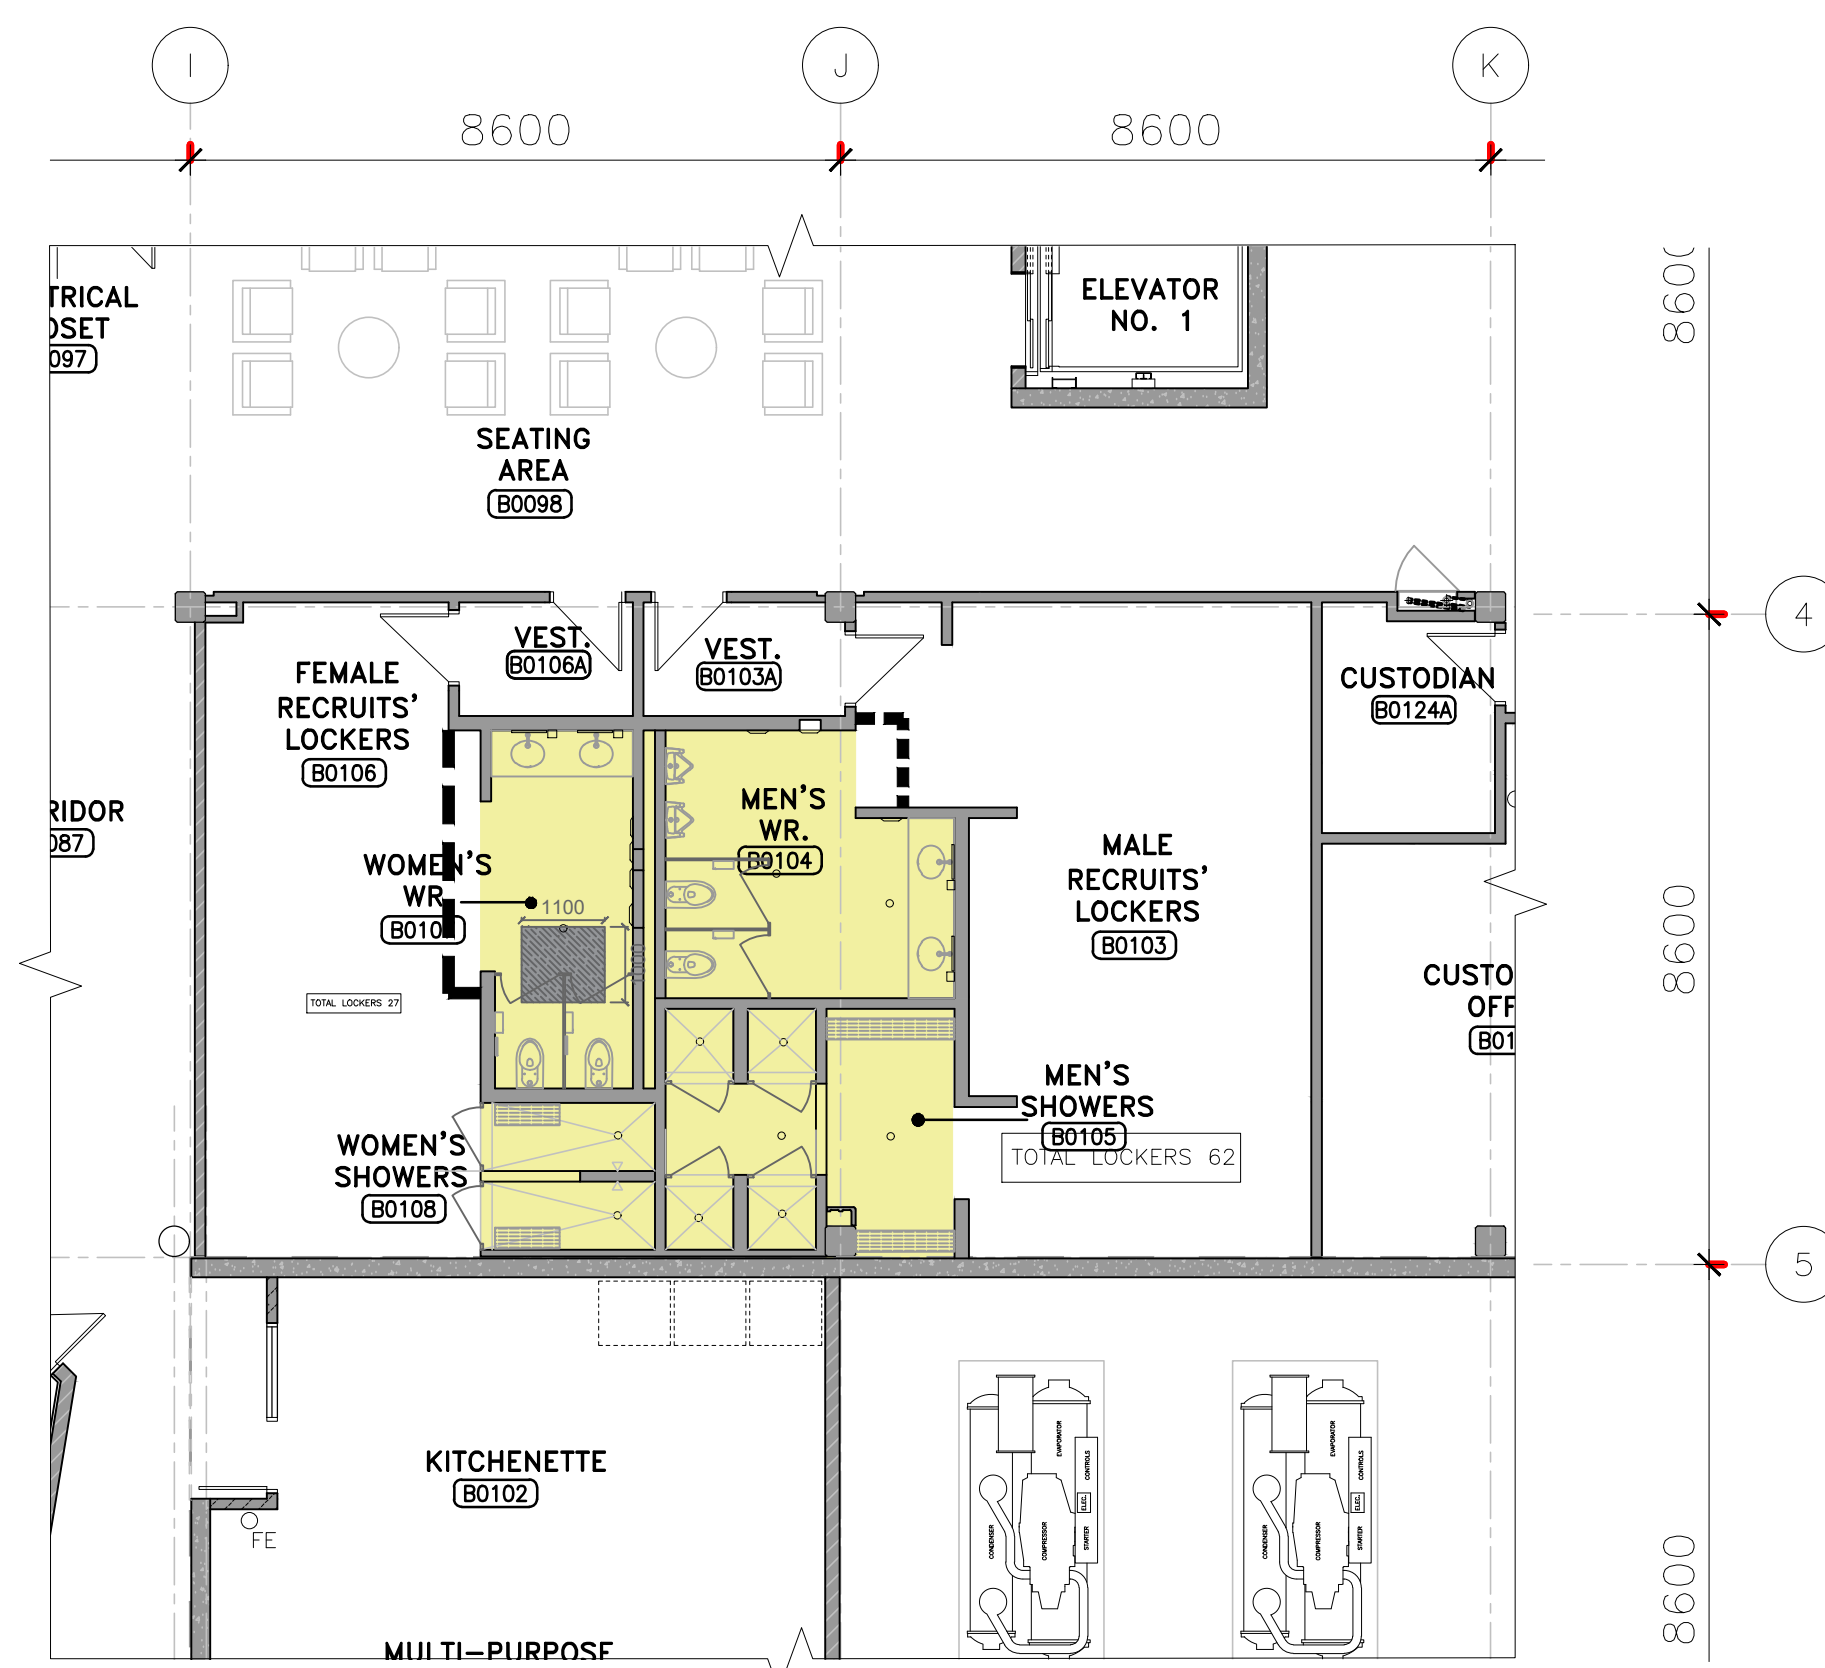


2 PHASING PLAN - BASEMENT FLOOR (B0104, B0105, B0106, B0107)
SCALE: 1:100

- PHASE 1 - APPROXIMATELY 24 WEEKS (INCLUDING 14 WEEKS FOR FURNITURE DELIVERY)
- PHASE 2 - APPROXIMATELY 16 WEEKS
- PHASE 3 - APPROXIMATELY 12 WEEKS

1 HOUR RATED CONSTRUCTION HOARDING PARTITION ULC W407 16 SHEETROCK FIRECODE "C" PANELS TO EACH SIDE OF 92-25 GA. STEEL STUDS. EXTEND TO U/S OF SECOND FLOOR EXISTING CEILING / SLAB. PROVIDE SMOKE AND FIRE SEALS AT JUNCTIONS. ENTIRE HOARDING ENCLOSURE TO BE AIR TIGHT & DUST PROOF (TYP). PROVIDE TEMPORARY CONSTRUCTION DOORS WITH LOCKS. PATCH AND REPAIR EXISTING CEILING IF REQUIRED AFTER DISMANTLING HOARDING. M.G.A.T., TYP.

IMPORTANT NOTE:


- THE SUGGESTED CONSTRUCTION PHASING PLAN AND EXTENT OF HOARDING IS FOR REFERENCE ONLY. A DETAILED PHASING AND HOARDING PLAN SHALL BE ESTABLISHED AND DETERMINED BY THE GENERAL CONTRACTOR AND TO BE SUBMITTED FOR PEEL REGIONAL POLICE APPROVAL BEFORE COMMENCING THE CONSTRUCTION.
- ALL DEMOLITION WORK HAS TO BE CARRIED OUT AFTER HOURS AND OR ON WEEKENDS.

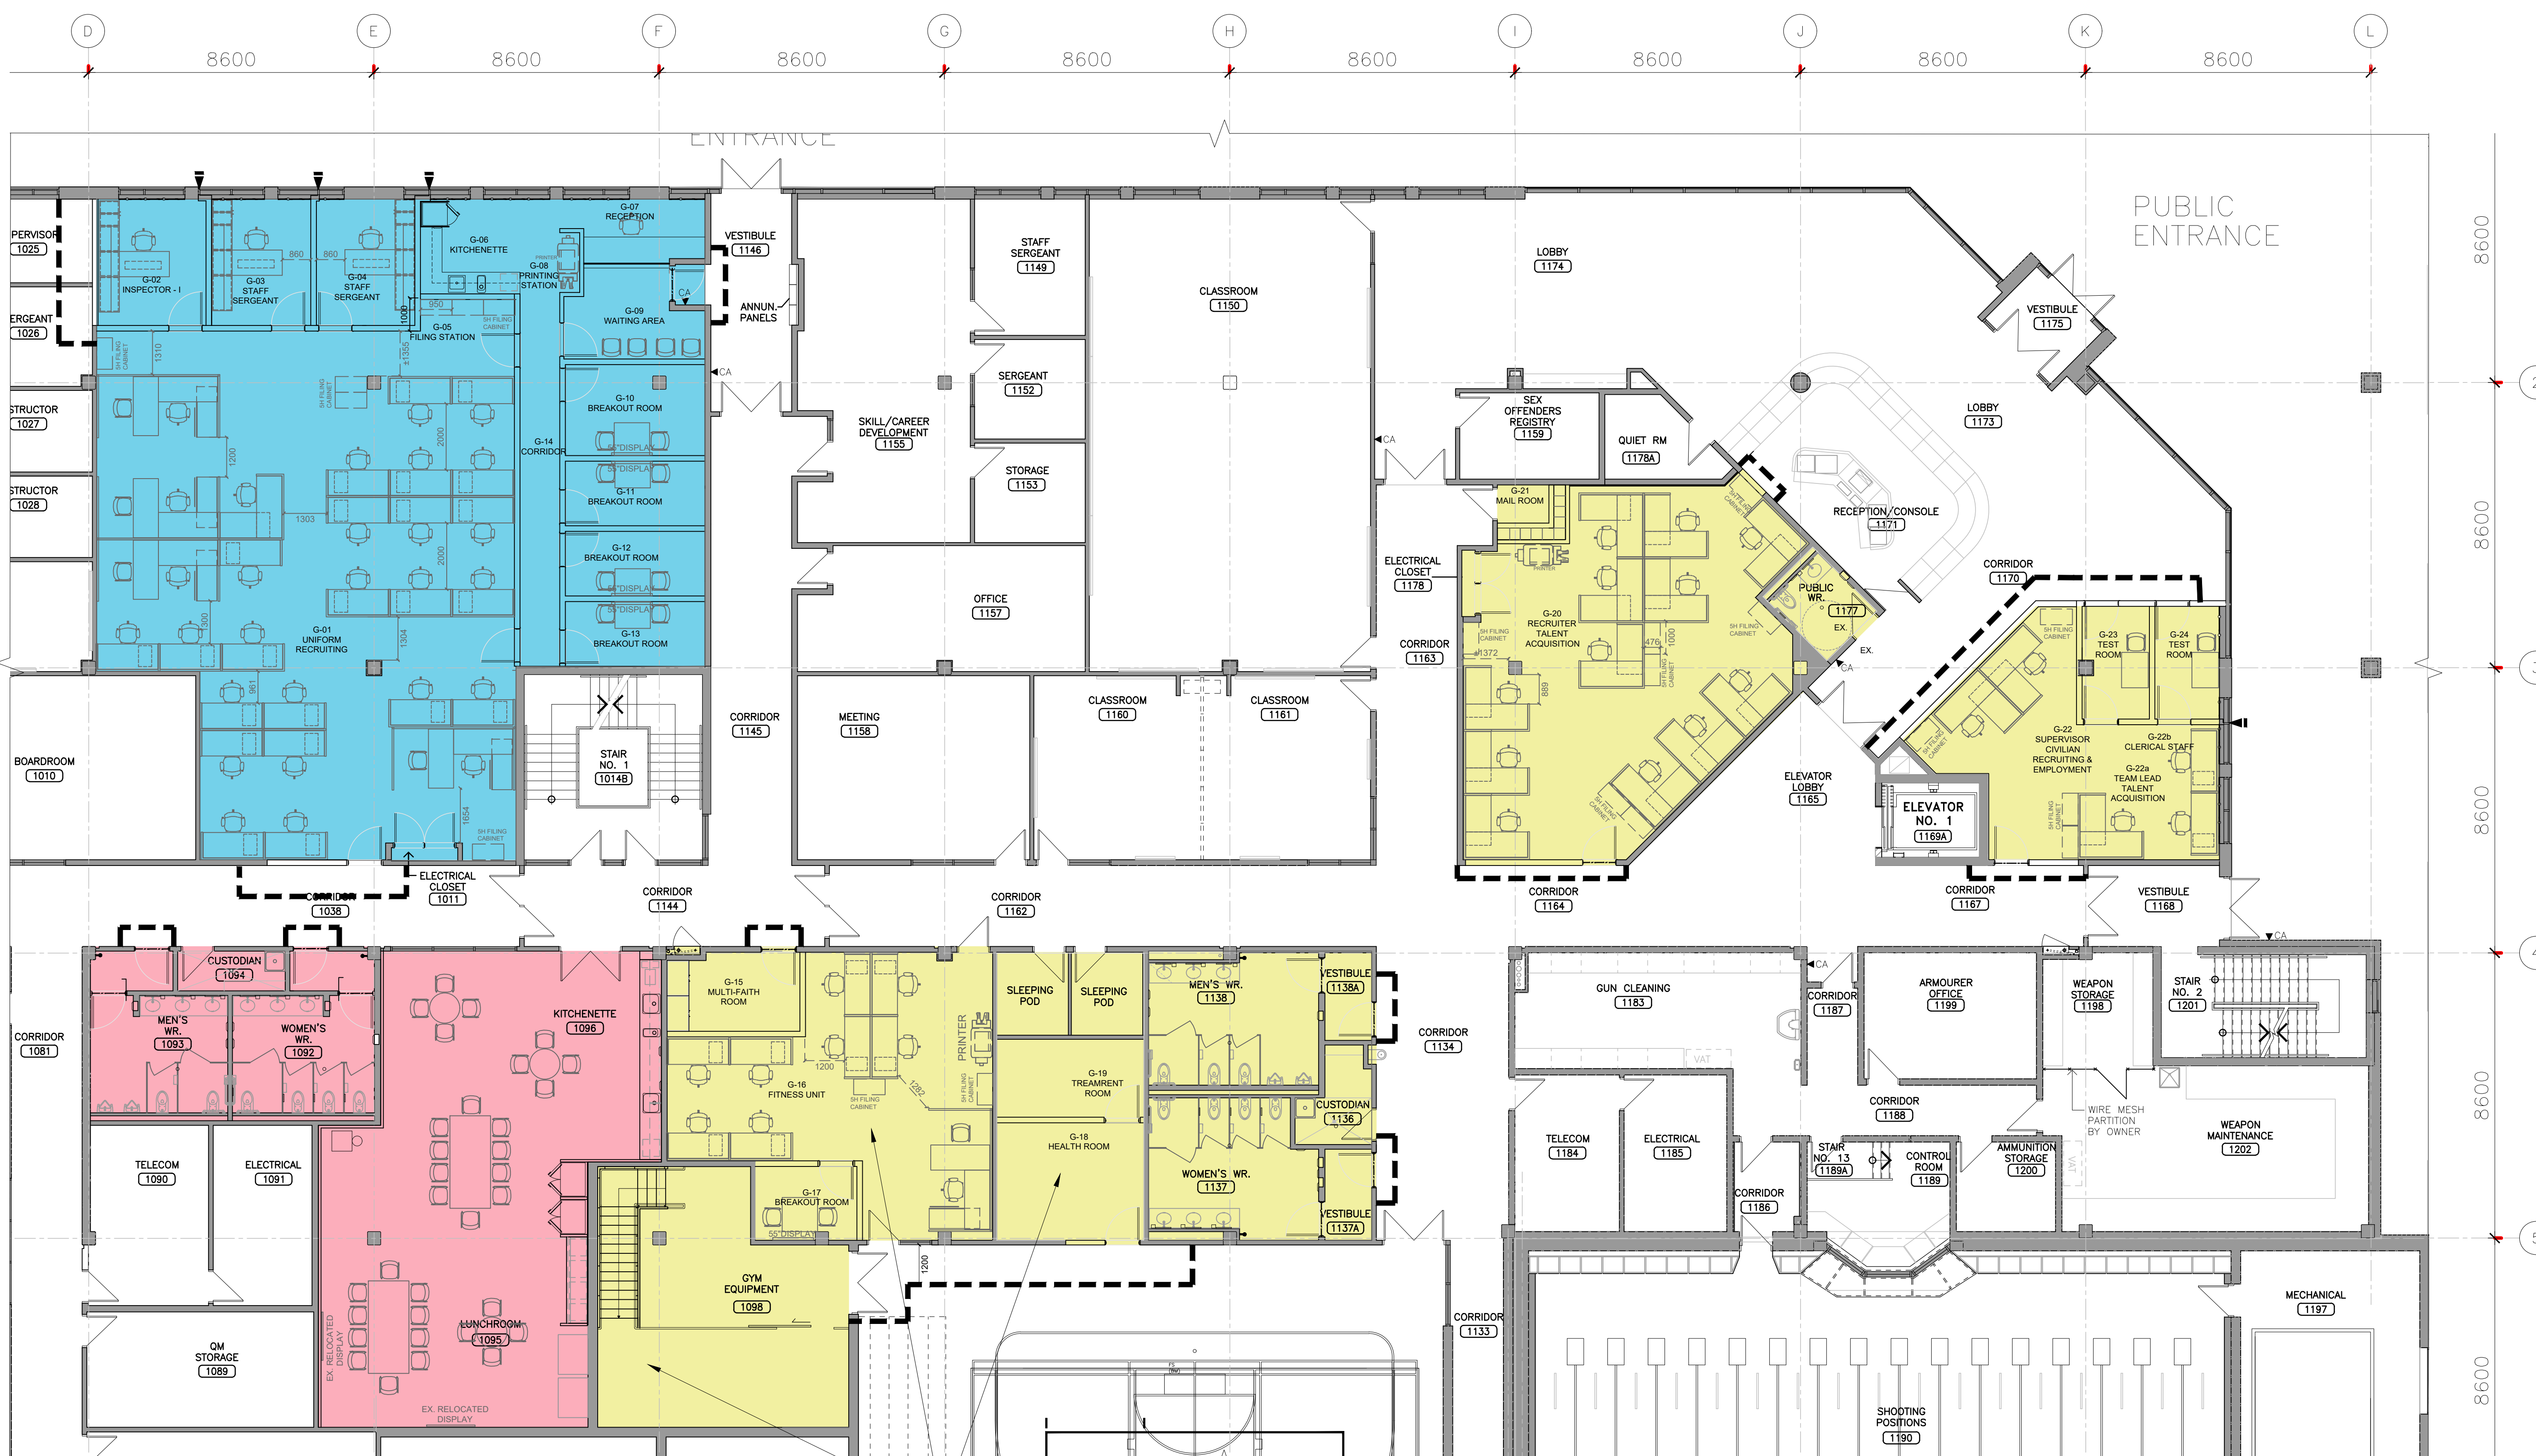

3 PHASING PLAN - GROUND FLOOR
SCALE: 1:100

EXISTING EQUIPMENT ROOM TO BE ACCESSIBLE DURING RENOVATION. THE FITNESS EQUIPMENT TO BE TEMPORARILY RELOCATED TO G-16, G-18, G-19 AND PROVIDE ACCESS. THE FITNESS EQUIPMENT TO BE MOVED BACK TO THE ORIGINAL LOCATION WHEN ROOM 1098 IS COMPLETE.


13. ISSUED FOR TENDER	2026.05.01
12. ISSUED FOR BUILDING PERMIT	2026.04.08
11. ISSUED FOR 10% CLIENT REVIEW	2026.03.31
10. ISSUED FOR 20% CLIENT REVIEW	2026.01.09
9. ISSUED FOR DESIGN DEVELOPMENT CLIENT REVIEW	2025.10.24
8. ISSUED FOR PRELIMINARY DESIGN CLIENT REVIEW	2025.10.01
7. ISSUED FOR PRELIMINARY DESIGN CLIENT REVIEW	2025.09.03
6. ISSUED FOR PRELIMINARY DESIGN CLIENT REVIEW	2025.08.18
5. ISSUED FOR PRELIMINARY DESIGN CLIENT REVIEW	2025.08.12
4. ISSUED FOR PRELIMINARY DESIGN CLIENT REVIEW	2025.08.01
3. ISSUED FOR PRELIMINARY DESIGN CLIENT REVIEW	2025.07.30
2. ISSUED FOR PRELIMINARY DESIGN CLIENT REVIEW	2025.07.25
1. ISSUED FOR PRELIMINARY DESIGN CLIENT REVIEW	2025.07.14
NO. DESCRIPTION	DATE
REVISIONS	
PROJECT	
<p>REGION OF PEEL</p> <p>EMIL V. KOLB CENTRE PEEL REGIONAL POLICE FACILITY 181 DERRY ROAD EAST, MISSISSAUGA, ON L5T 2Y5</p>	
<p>NGA ARCHITECTS</p> <p>The contractor shall check and verify all details and report all errors and omissions to the design team prior to construction. The design team shall be responsible for any errors and omissions. The design team shall be responsible for any errors and omissions. The design team shall be responsible for any errors and omissions.</p>	
<p>PROJECT: PEEL REGIONAL POLICE FACILITY INTERIOR RENOVATION PROJECT</p> <p>STRUCTURAL CONSULTANT: Stephenson Engineering</p> <p>MECHANICAL CONSULTANT: EXP Services Inc.</p> <p>ELECTRICAL CONSULTANT: EXP Services Inc.</p>	
<p>SHEET TITLE: PHASING & HORDING PLAN - BASEMENT & GROUND FLOOR</p> <p>SHEET NO.: A900</p> <p>PROJECT NO.: AA</p> <p>SCALE: AS NOTED</p>	

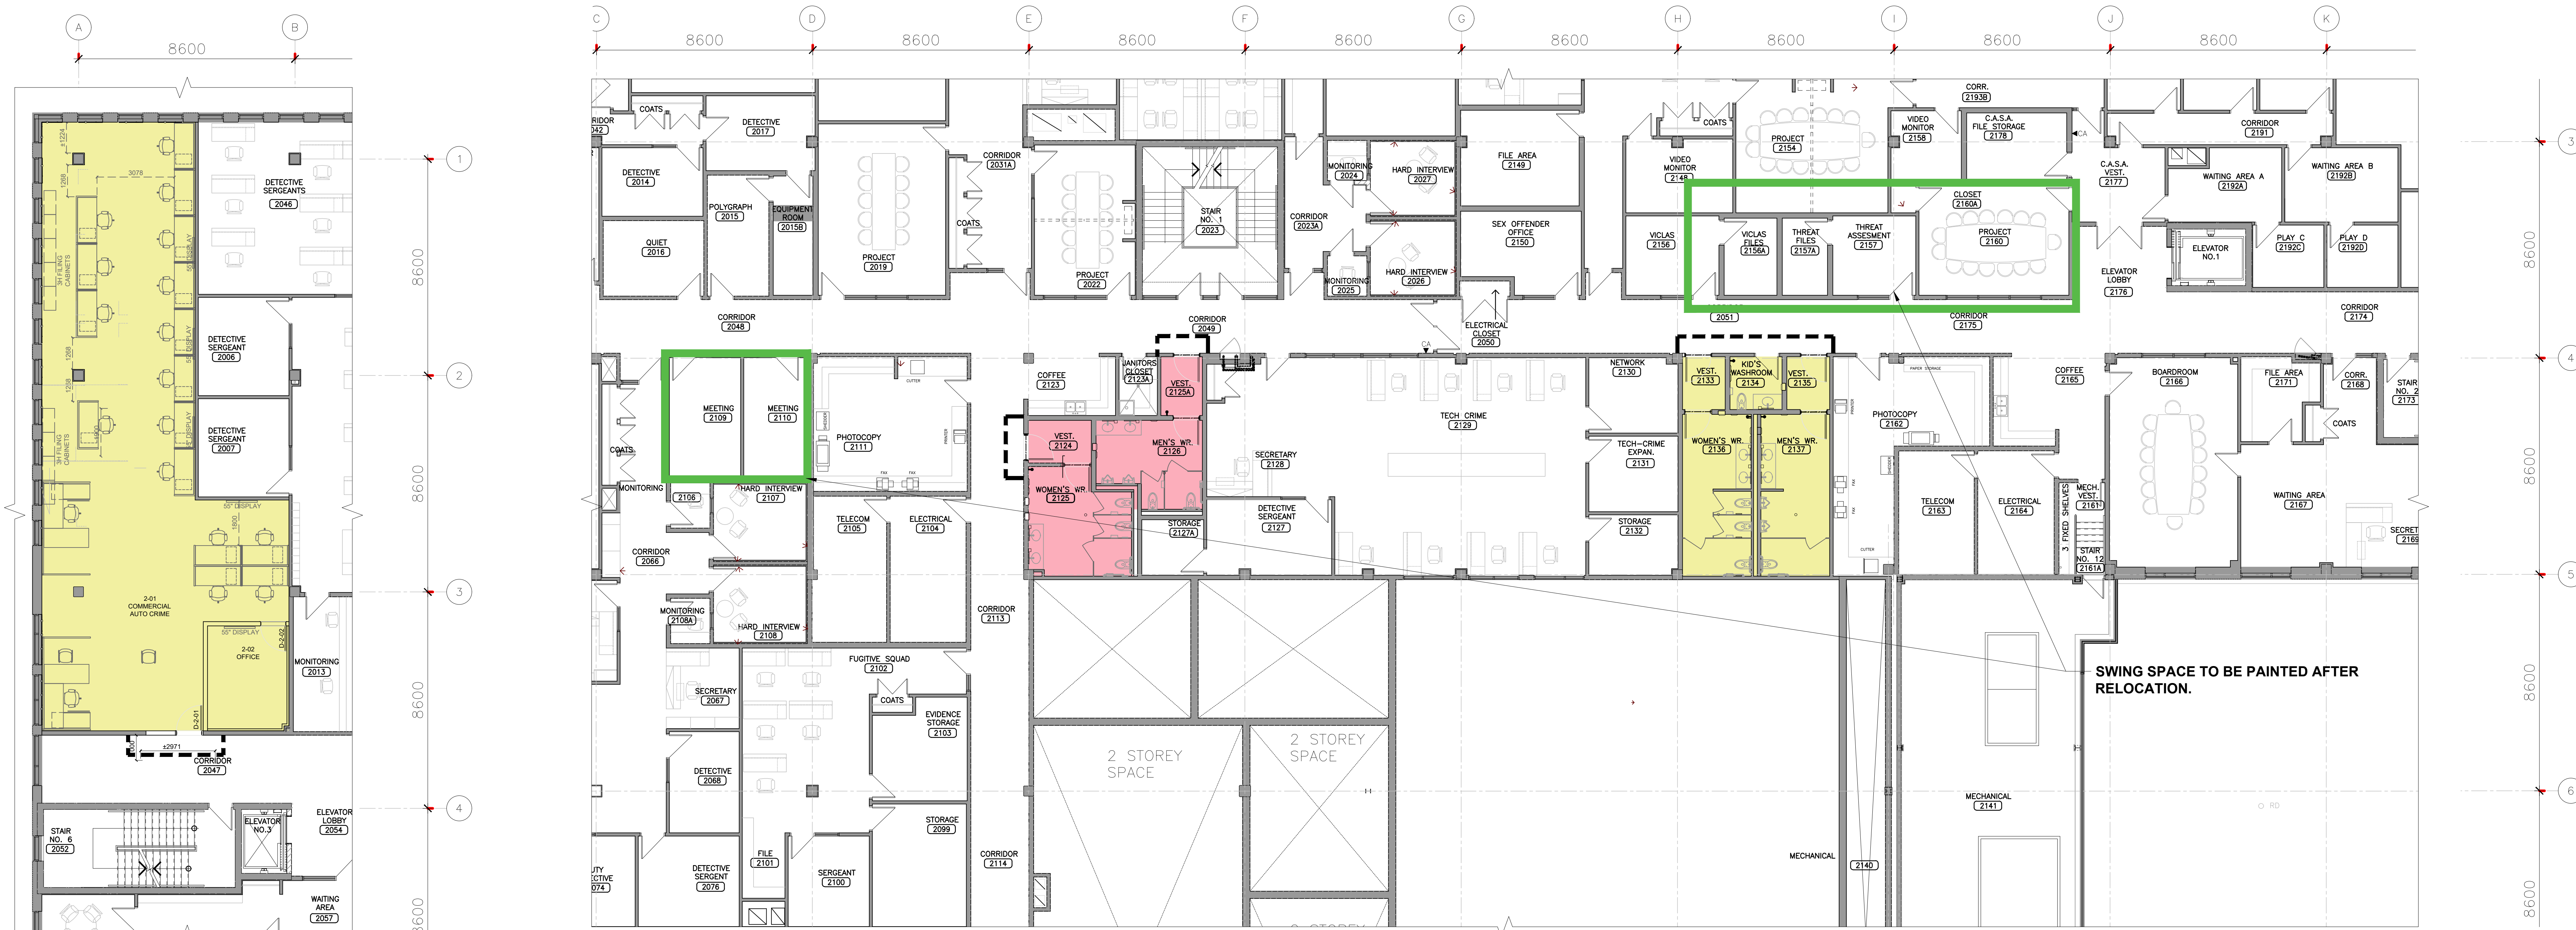

1 PHASING PLAN - NEW SECOND FLOOR
SCALE: 1:100

GC IS RESPONSIBLE TO SUPPLY AND INSTALL TEMPORARY SIGNAGE INDICATING NO ACCESS CONSTRUCTION IS IN PROGRESS, TYP.

2 PHASING PLAN - SECOND FLOOR (WASHROOMS)
SCALE: 1:100

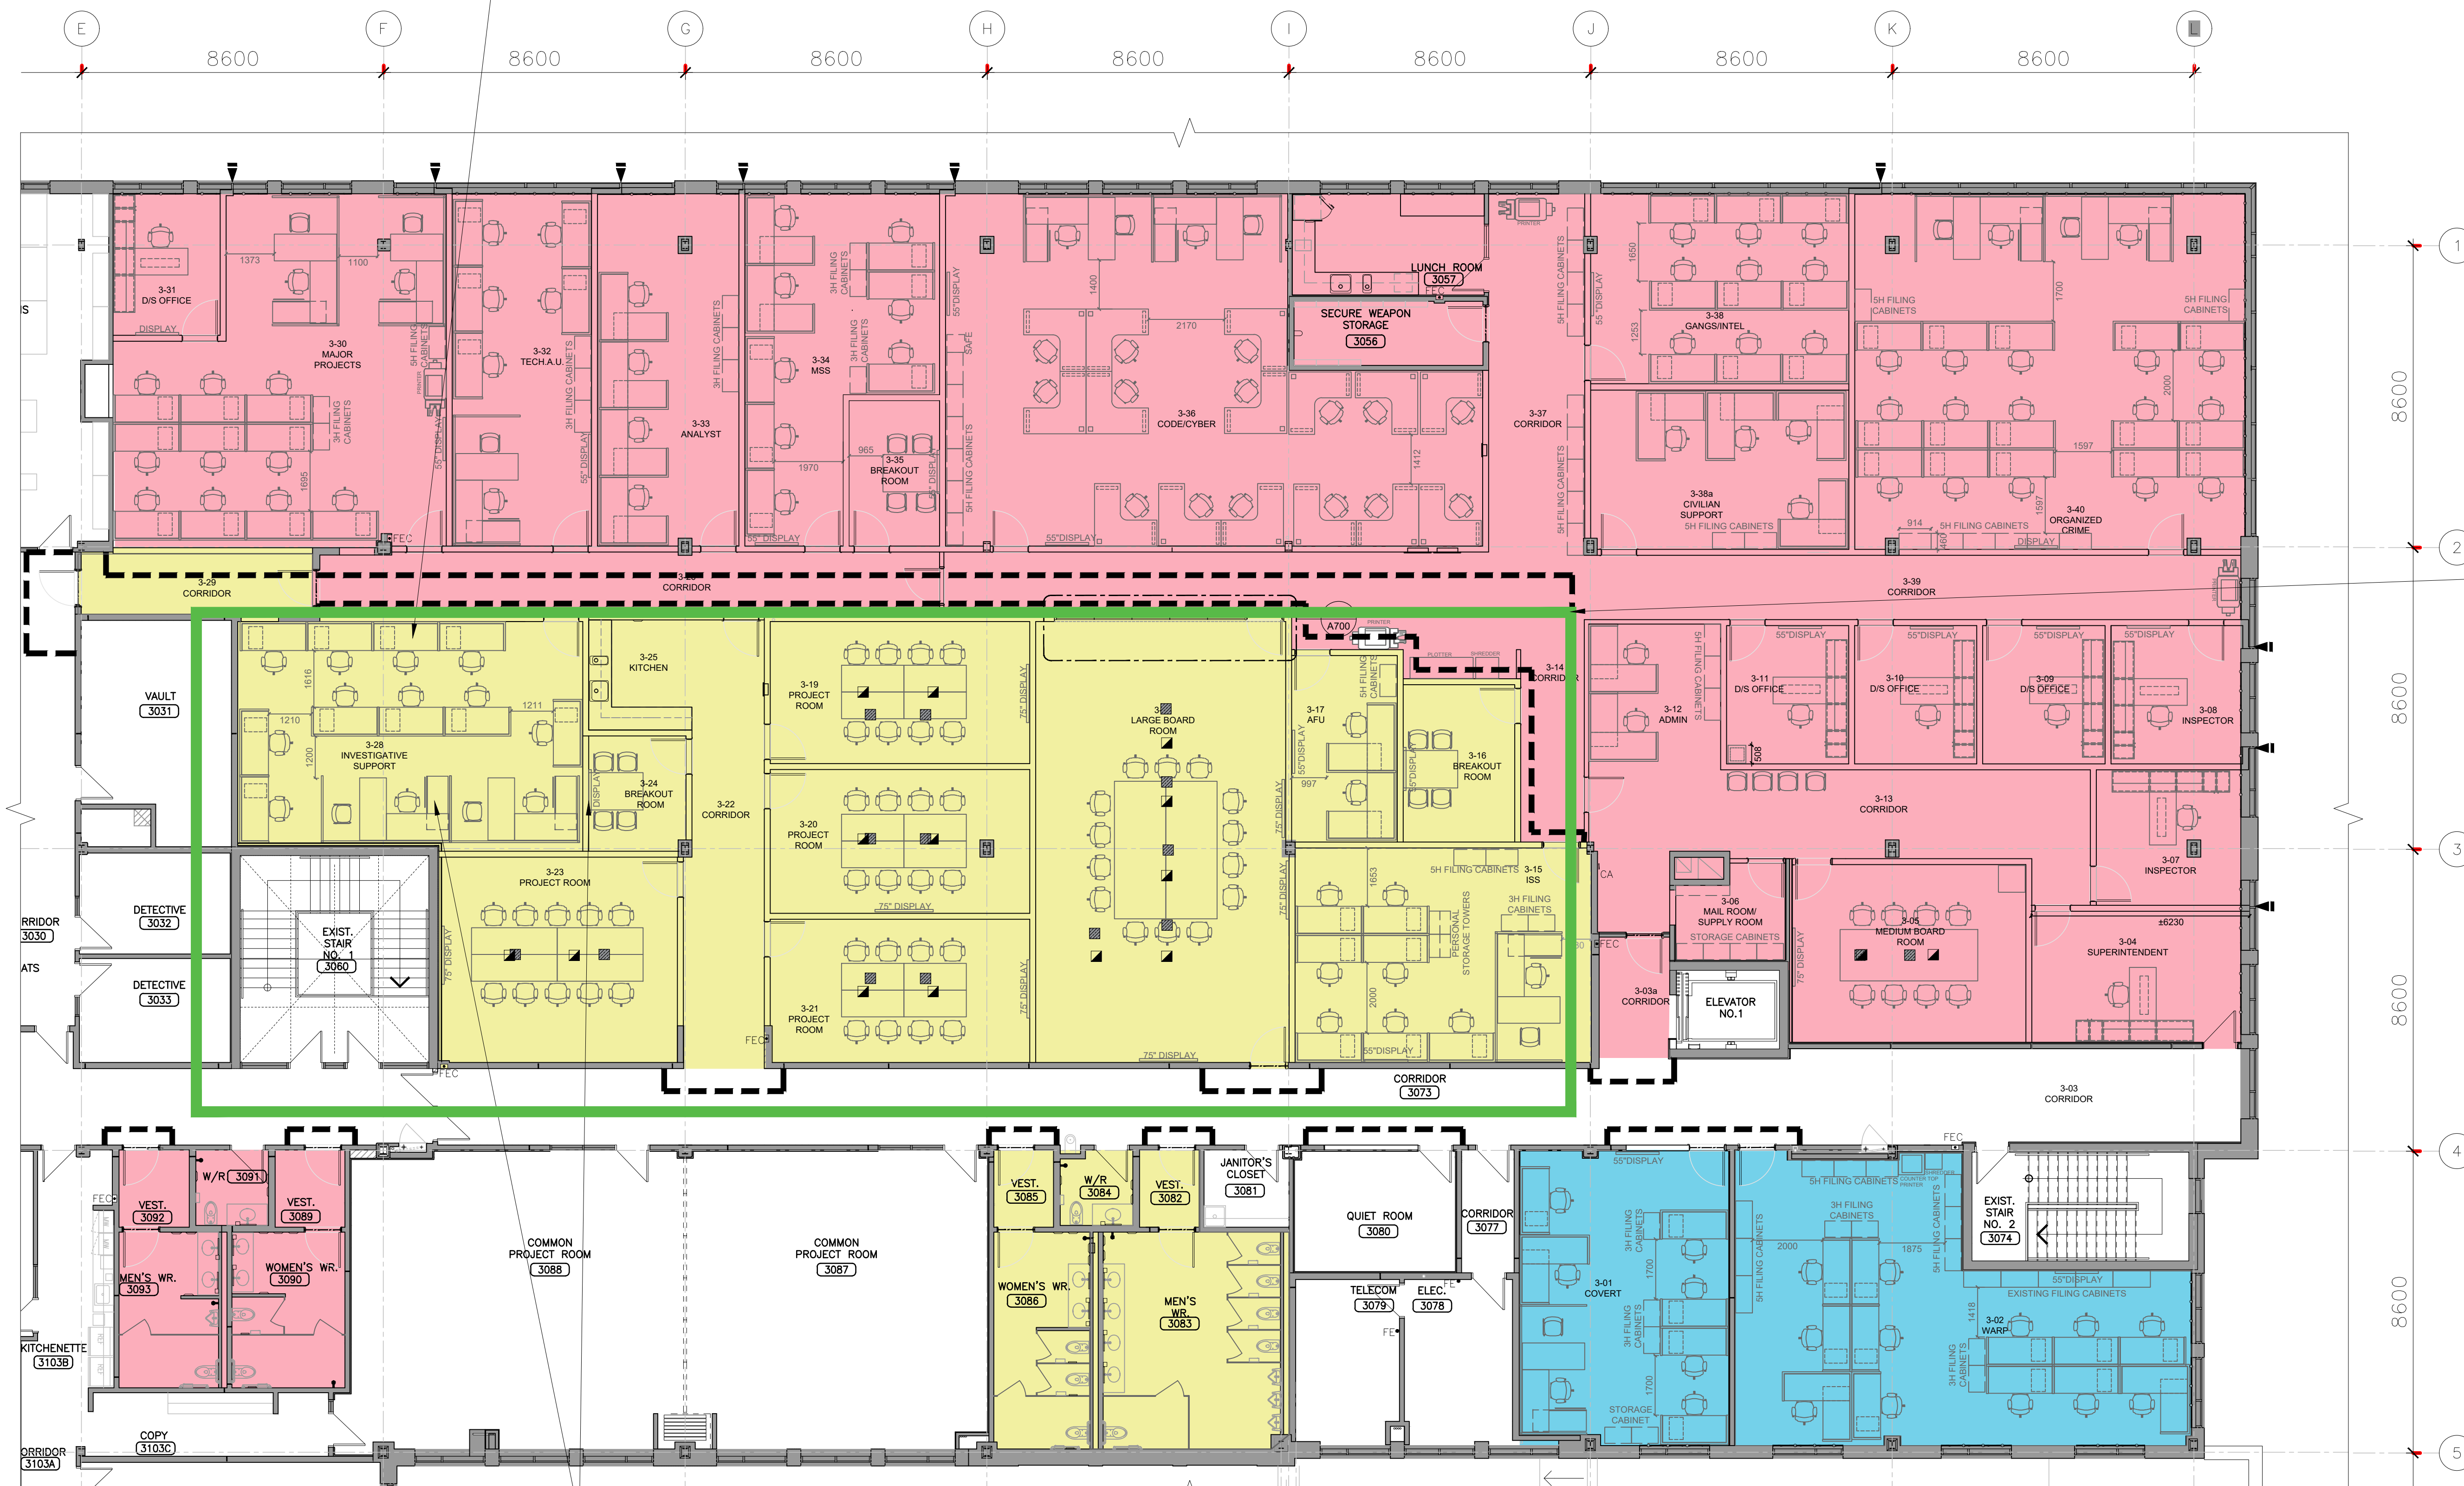

3 PHASING PLAN - THIRD FLOOR
SCALE: 1:100

TO ALLOW STAFF SAFE ACCESS TO CORRIDOR 3-29 WHILE PHASE 02 CONSTRUCTION WORK IS IN PROGRESS, GC IS RESPONSIBLE TO SUPPLY AND INSTALL TEMPORARY DOOR AND AFTER THE COMPLETION OF WORK GC IS RESPONSIBLE TO PATCH AND REPAIR THE EXISTING / NEW WALL WITH SAME EXISTING / NEW WALL STC RATING, TYP.

- PHASE 1 - APPROXIMATELY 24 WEEKS (INCLUDING 14 WEEKS FOR FURNITURE DELIVERY)
- PHASE 2 - APPROXIMATELY 16 WEEKS
- PHASE 3 - APPROXIMATELY 12 WEEKS

SWING SPACE TO BE PAINTED AFTER RELOCATION.

1 HOUR RATED CONSTRUCTION HOARDING PARTITION ULC W407 16 SHEETROCK FIRECODE "C" PANELS TO EACH SIDE OF 92-25 GA. STEEL STUDS. EXTEND TO U/S OF SECOND FLOOR EXISTING CEILING / SLAB. PROVIDE SMOKE AND FIRE SEALS AT JUNCTIONS. ENTIRE HOARDING ENCLOSURE TO BE AIR TIGHT & DUST PROOF (TYP). PROVIDE TEMPORARY CONSTRUCTION DOORS WITH LOCKS. PATCH AND REPAIR EXISTING CEILING IF REQUIRED AFTER DISMANTLING HOARDING. M.G.A.T., TYP.

IMPORTANT NOTE:

- THE SUGGESTED CONSTRUCTION PHASING PLAN AND EXTENT OF HOARDING IS FOR REFERENCE ONLY. A DETAILED PHASING AND HOARDING PLAN SHALL BE ESTABLISHED AND DETERMINED BY THE GENERAL CONTRACTOR AND TO BE SUBMITTED FOR PEEL REGIONAL POLICE APPROVAL BEFORE COMMENCING THE CONSTRUCTION.
- ALL DEMOLITION WORK HAS TO BE CARRIED OUT AFTER HOURS AND OR ON WEEKENDS.

13. ISSUED FOR TENDER	2026.05.01
12. ISSUED FOR BUILDING PERMIT	2026.04.08
11. ISSUED FOR 10% CLIENT REVIEW	2026.03.31
10. ISSUED FOR 5% CLIENT REVIEW	2026.01.09
9. ISSUED FOR DESIGN DEVELOPMENT CLIENT REVIEW	2025.10.24
8. ISSUED FOR PRELIMINARY DESIGN CLIENT REVIEW	2025.10.01
7. ISSUED FOR PRELIMINARY DESIGN CLIENT REVIEW	2025.09.03
6. ISSUED FOR PRELIMINARY DESIGN CLIENT REVIEW	2025.08.18
5. ISSUED FOR PRELIMINARY DESIGN CLIENT REVIEW	2025.08.12
4. ISSUED FOR PRELIMINARY DESIGN CLIENT REVIEW	2025.08.01
3. ISSUED FOR PRELIMINARY DESIGN CLIENT REVIEW	2025.07.30
2. ISSUED FOR PRELIMINARY DESIGN CLIENT REVIEW	2025.07.29
1. ISSUED FOR PRELIMINARY DESIGN CLIENT REVIEW	2025.07.14
NO. DESCRIPTION	DATE

PEEL REGIONAL POLICE

REGION OF PEEL

EMIL V. KOLB CENTRE
PEEL REGIONAL POLICE FACILITY
INTERIOR RENOVATION PROJECT
181 DERRY ROAD EAST, MISSISSAUGA, ON L5T 2Y5

NGA ARCHITECTS

STRUCTURAL CONSULTANT
STEPHENSON ENGINEERING
WESPORE CONSULTING
EXP SERVICES INC.
ELECTRICAL CONSULTANT
EXP SERVICES INC.

SHEET TITLE
PHASING & HOARDING
PLAN - SECOND
& THIRD FLOOR

SHEET NO.
A901

DRAWN BY
AA

CHECKED
RN


SCALE
AS NOTED

REGION OF PEEL
EMIL V. KOLB CENTRE PEEL REGIONAL POLICE FACILITY
INTERIOR RENOVATION PROJECT
10 PEEL CENTRE DRIVE, BRAMPTON ON L6T 4B9

ARCHITECTURAL FINISHES- DIGITAL SAMPLE BOARD



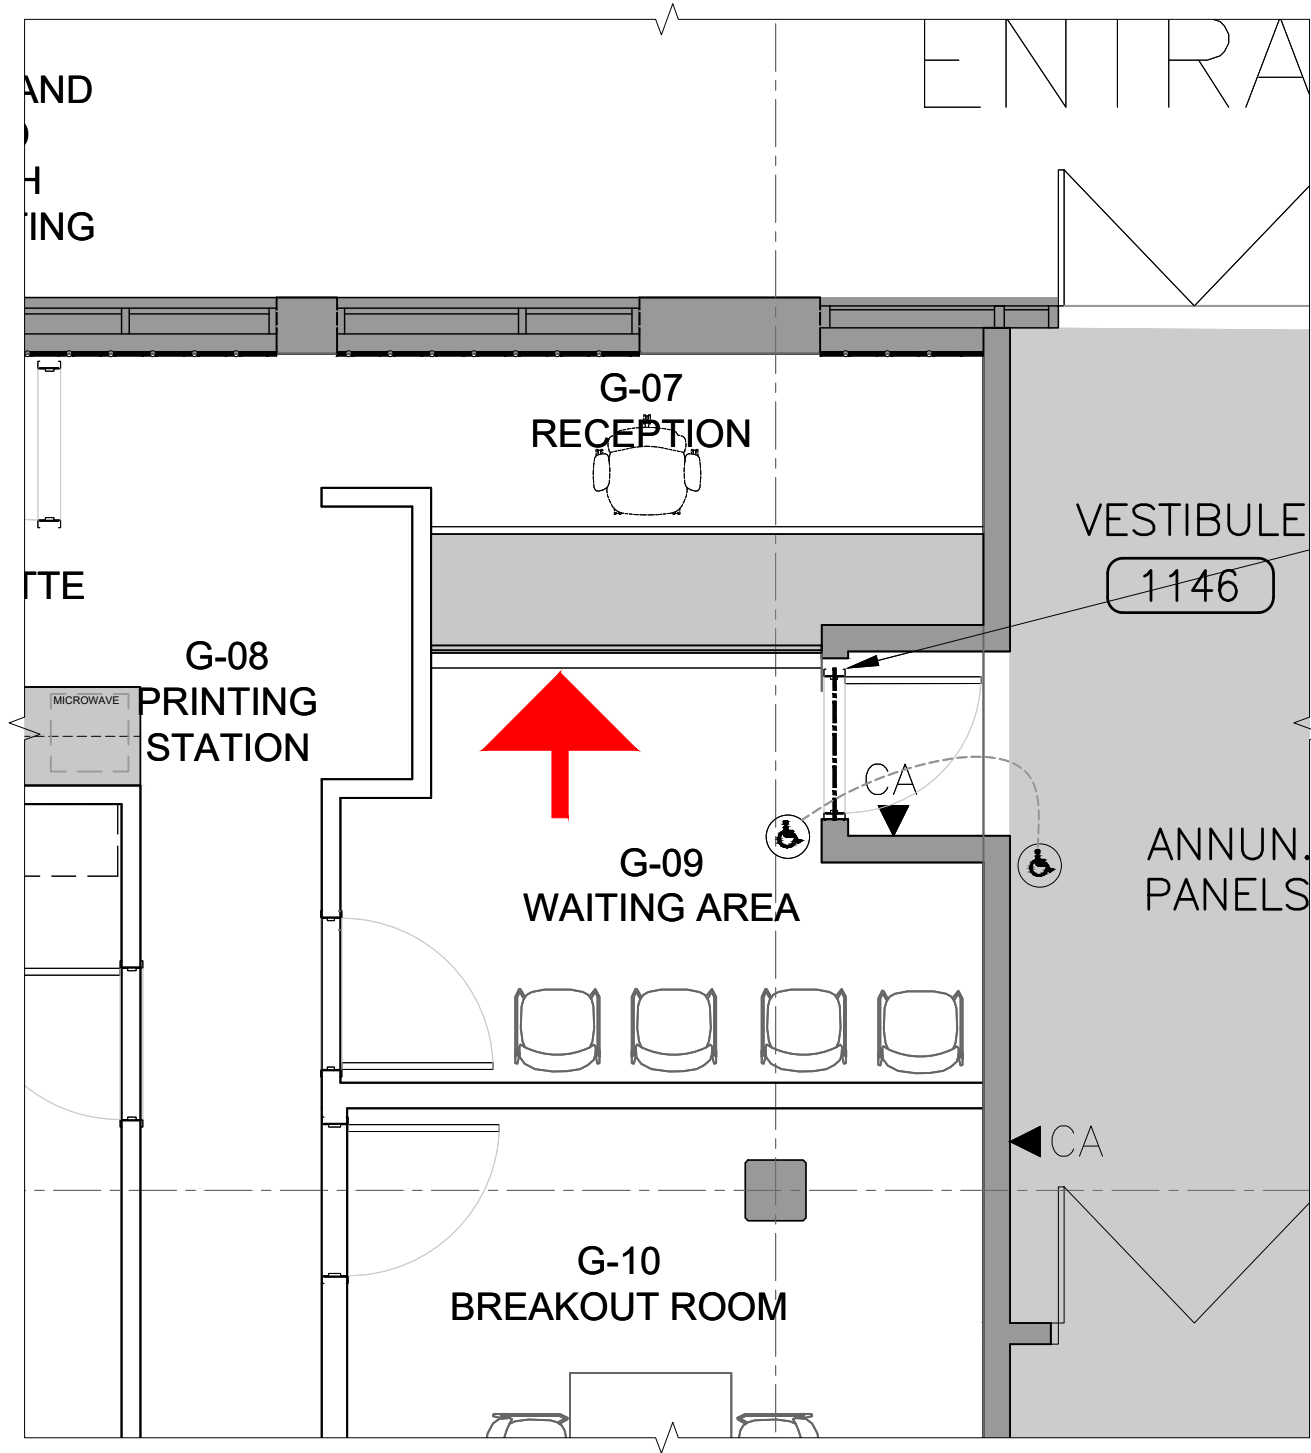

ISSUED FOR TENDER
MAY 1, 2026



1 UNIFORM RECRUITING RECEPTION PLAN
SB-01 SCALE: N.T.S.




Tafisa Lumnia- Sheer Beauty T581 (PM)	Benjamin Moore Silver Dollar 1460	Corian Silver Gray	Corian Glacier White
APPROVED	APPROVED	APPROVED	APPROVED
High Pressure Laminate Countertop- Option 1	Painted Bulkhead- Option 1	Solid Surface Countertop Colour 1- Option 1	Solid Surface Countertop Colour 2- Option 1

SHEET TITLE	SAMPLE BOARD NO.	 
UNIFORM RECRUITING RECEPTION	SB-01	
DATE: MAY 1, 2026	PROJECT NO. 2520797	
PROJECT		
EMIL V. KOLB CENTRE PEEL REGIONAL POLICE FACILITY INTERIOR RENOVATION PROJECT 180 DERRY ROAD EAST, MISSISSAUGA, ON L5T 2Y5		



DOUBLE GLAZED SCREEN
(MAX STC 48)

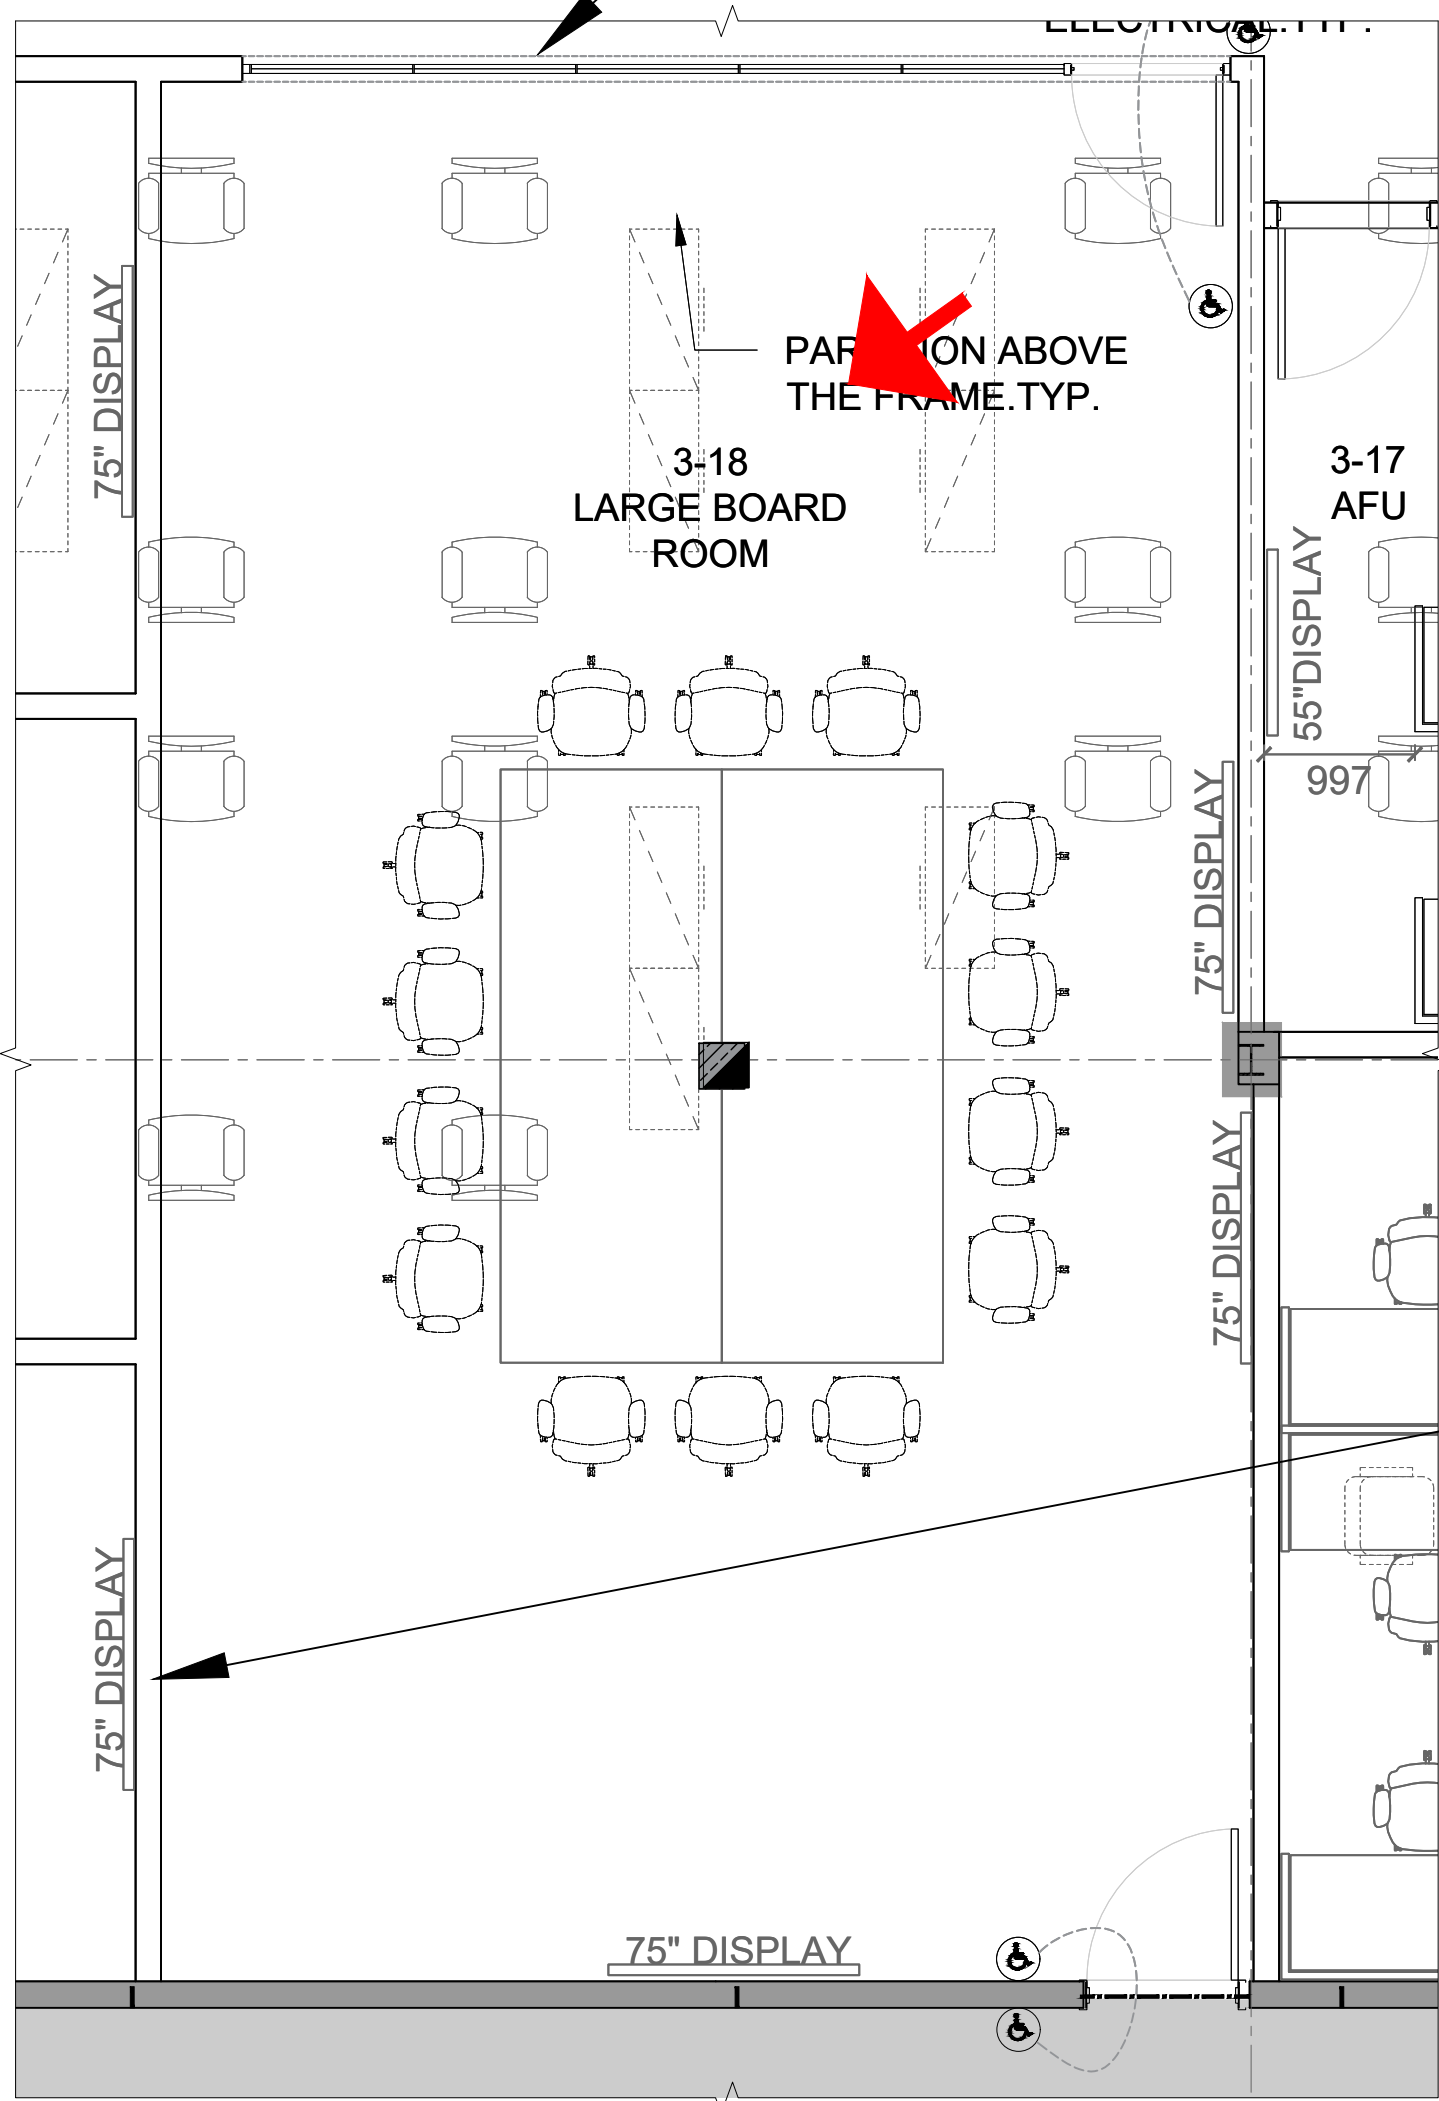




1 TYPICAL BOARD ROOM PLAN
SB-02 SCALE: N.T.S.



FEATURE WALL- OPTION 2

Tafisa Materia- Moonlight T761 (MA)	Tafisa Limmia- Midnight Sun T765(MA)	Guilford of Maine Heritage Anchorage 2335 - White 2664
APPROVED	APPROVED	APPROVED
High Pressure Laminate Wall Panel- Option 2	High Pressure Laminate Wall Panel- Option 2	Acoustic Panel- Option 2

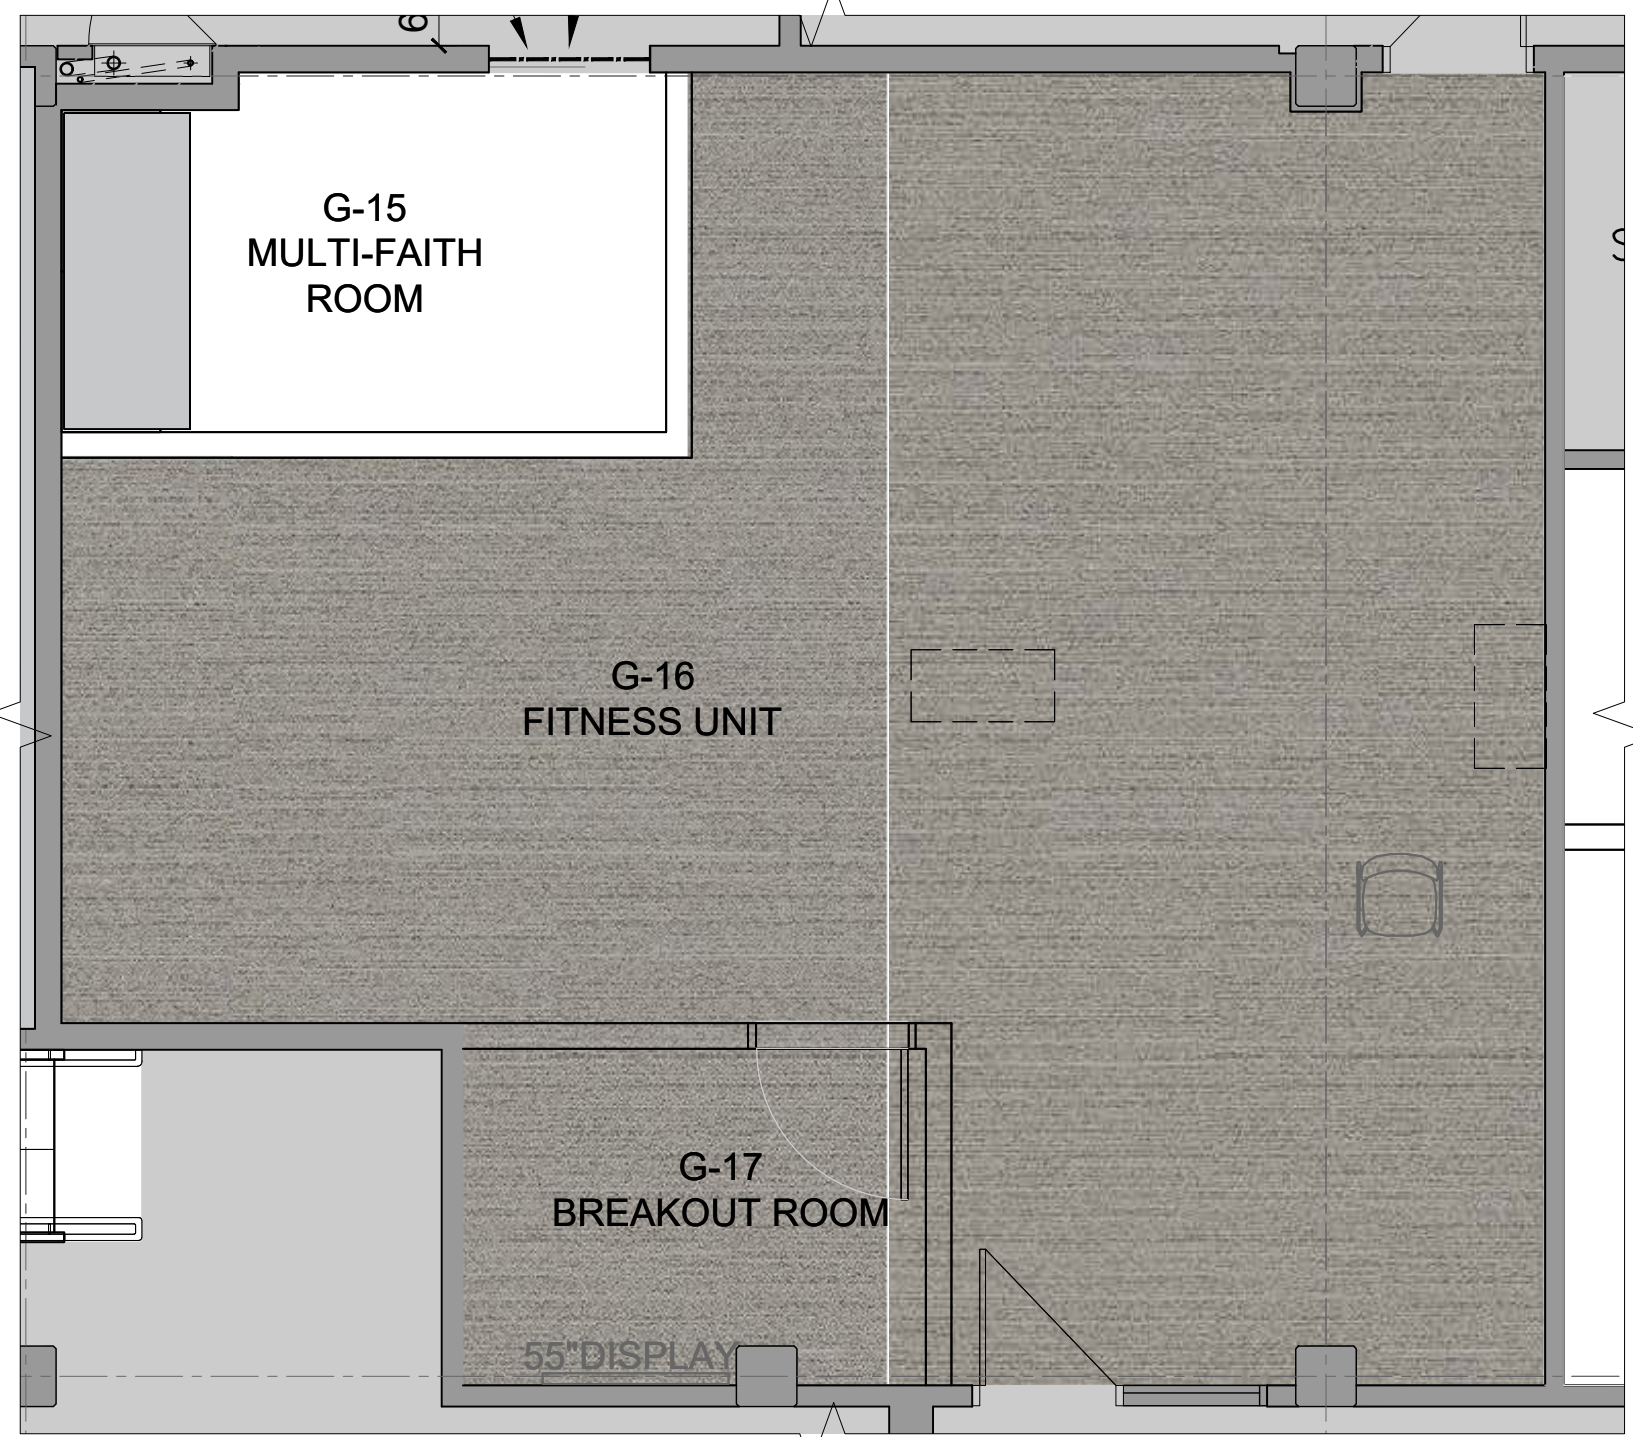

SHEET TITLE TYPICAL BOARD ROOM	SAMPLE BOARD NO. SB-02	 
DATE: MAY 1, 2026	PROJECT NO. 2520797	
PROJECT EMIL V. KOLB CENTRE PEEL REGIONAL POLICE FACILITY INTERIOR RENOVATION PROJECT 180 DERRY ROAD EAST, MISSISSAUGA, ON L5T 2Y5		








1
SB-03

GENERAL OFFICE PLAN
SCALE: N.T.S.



(AS REFERENCE ALSO APPLIES
TO PROJECT & BOARD ROOMS)

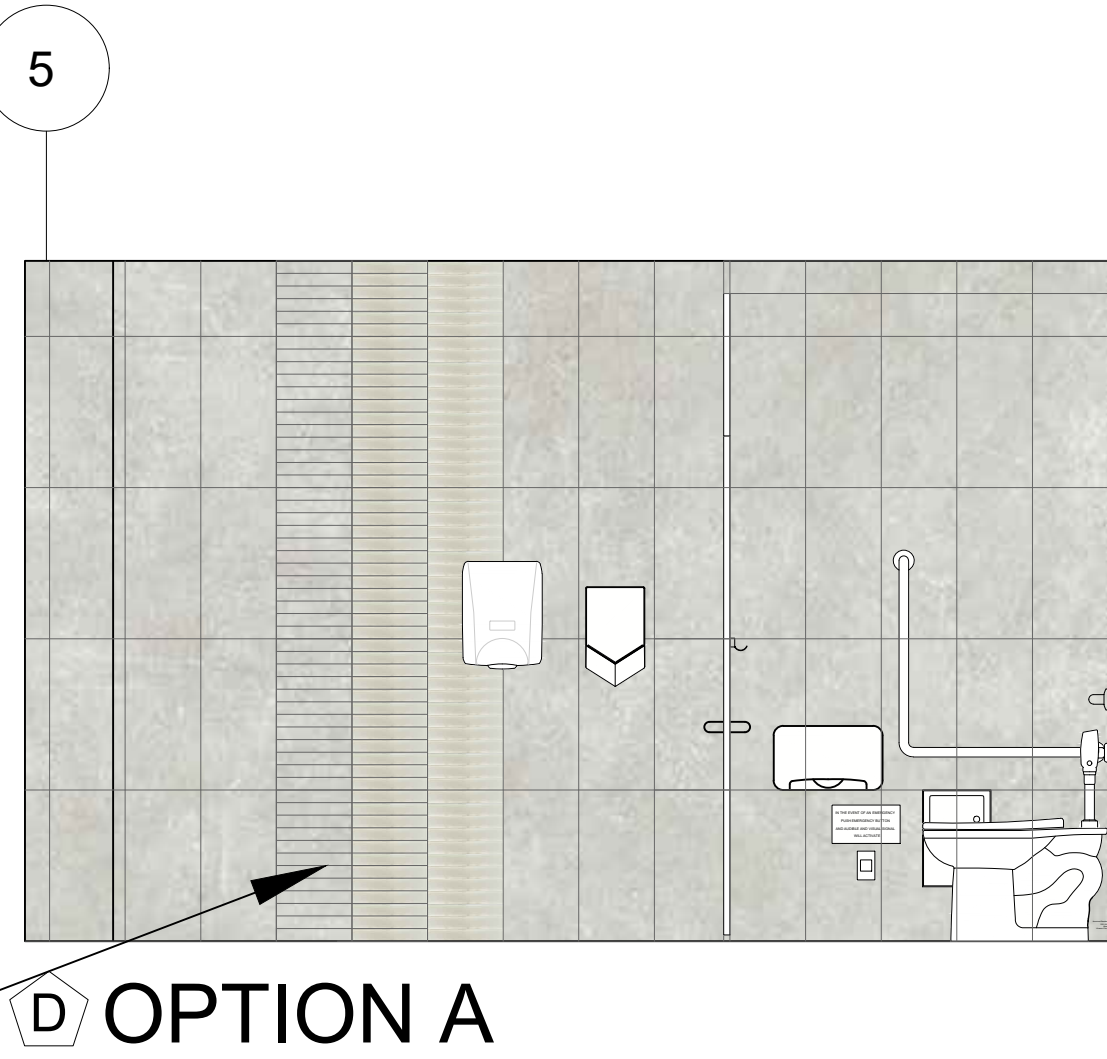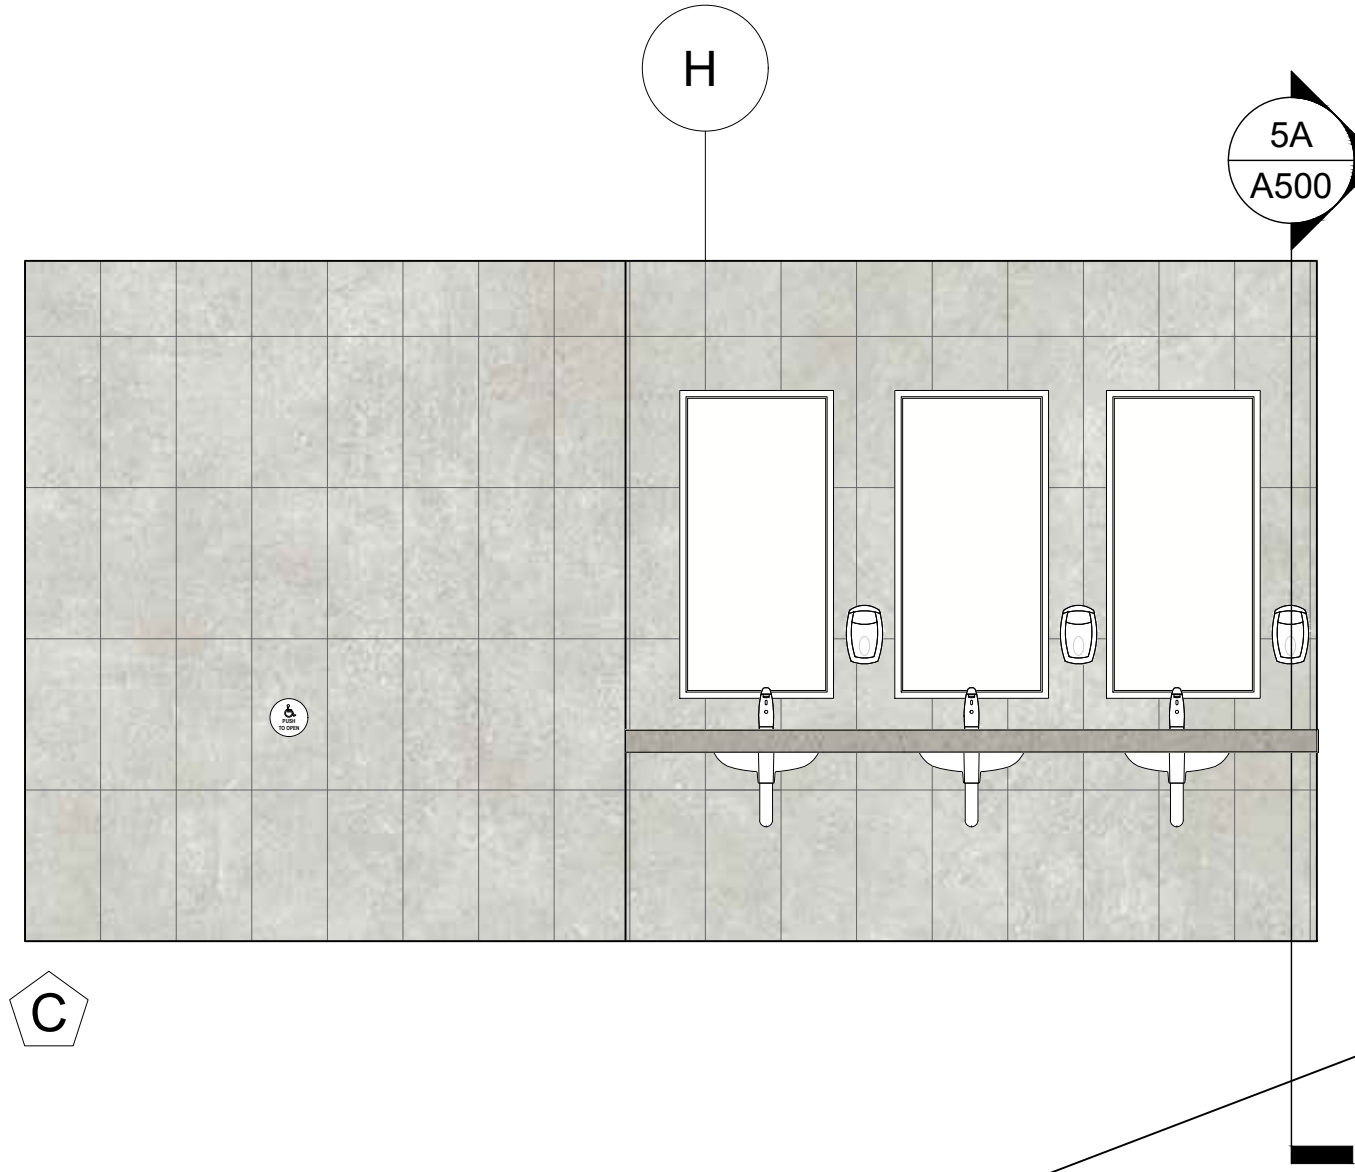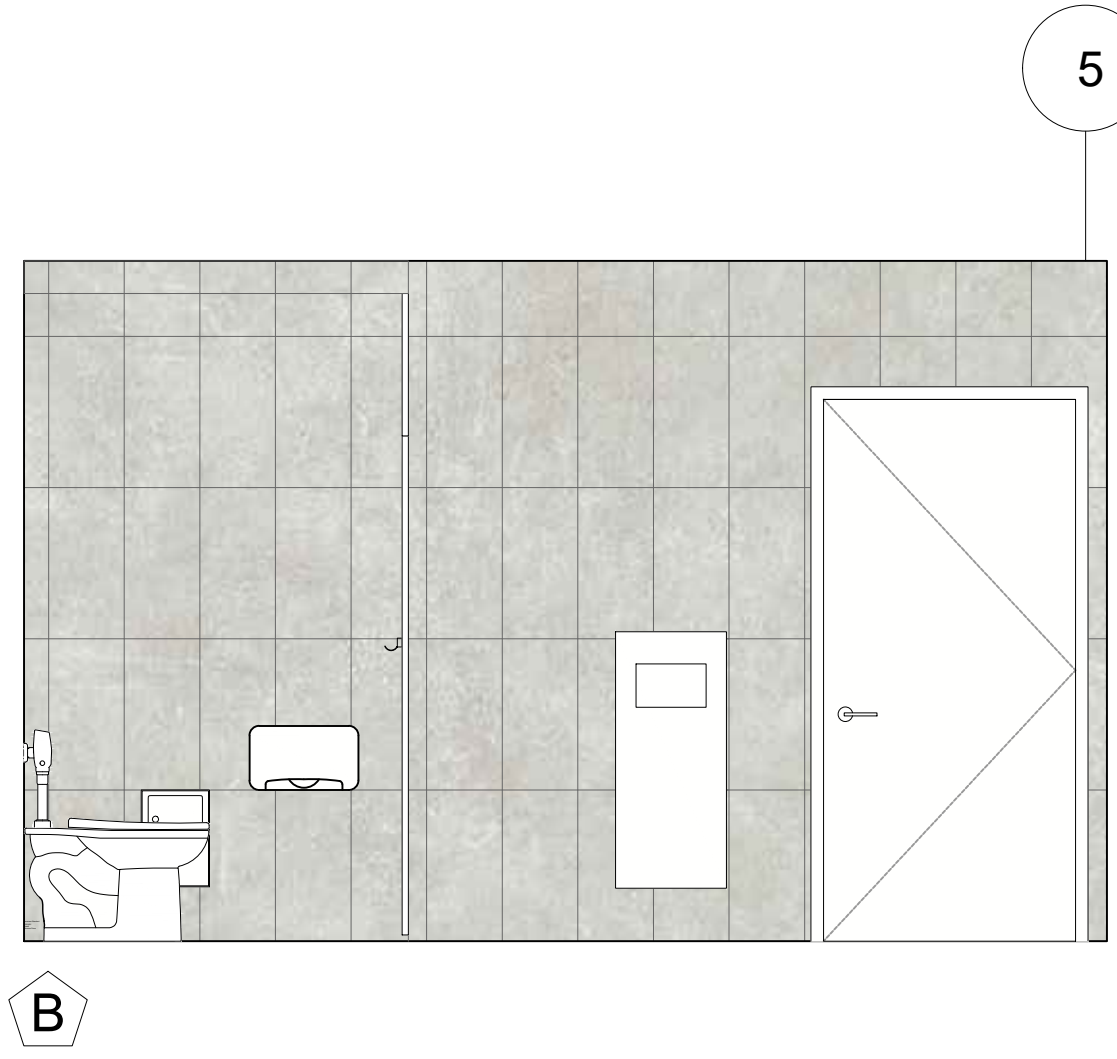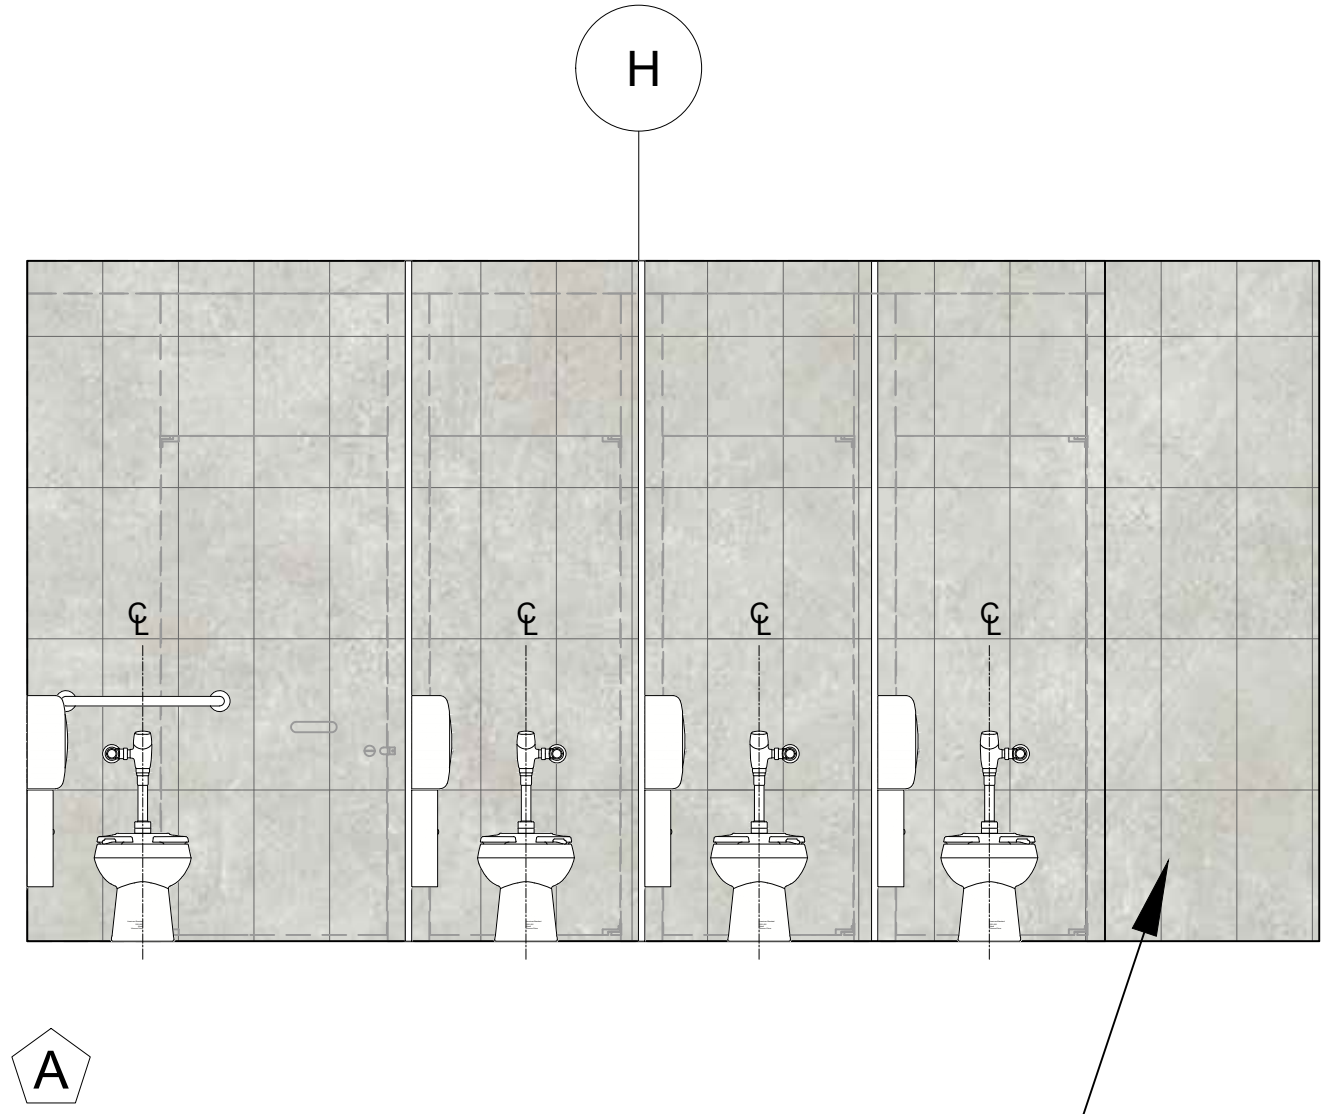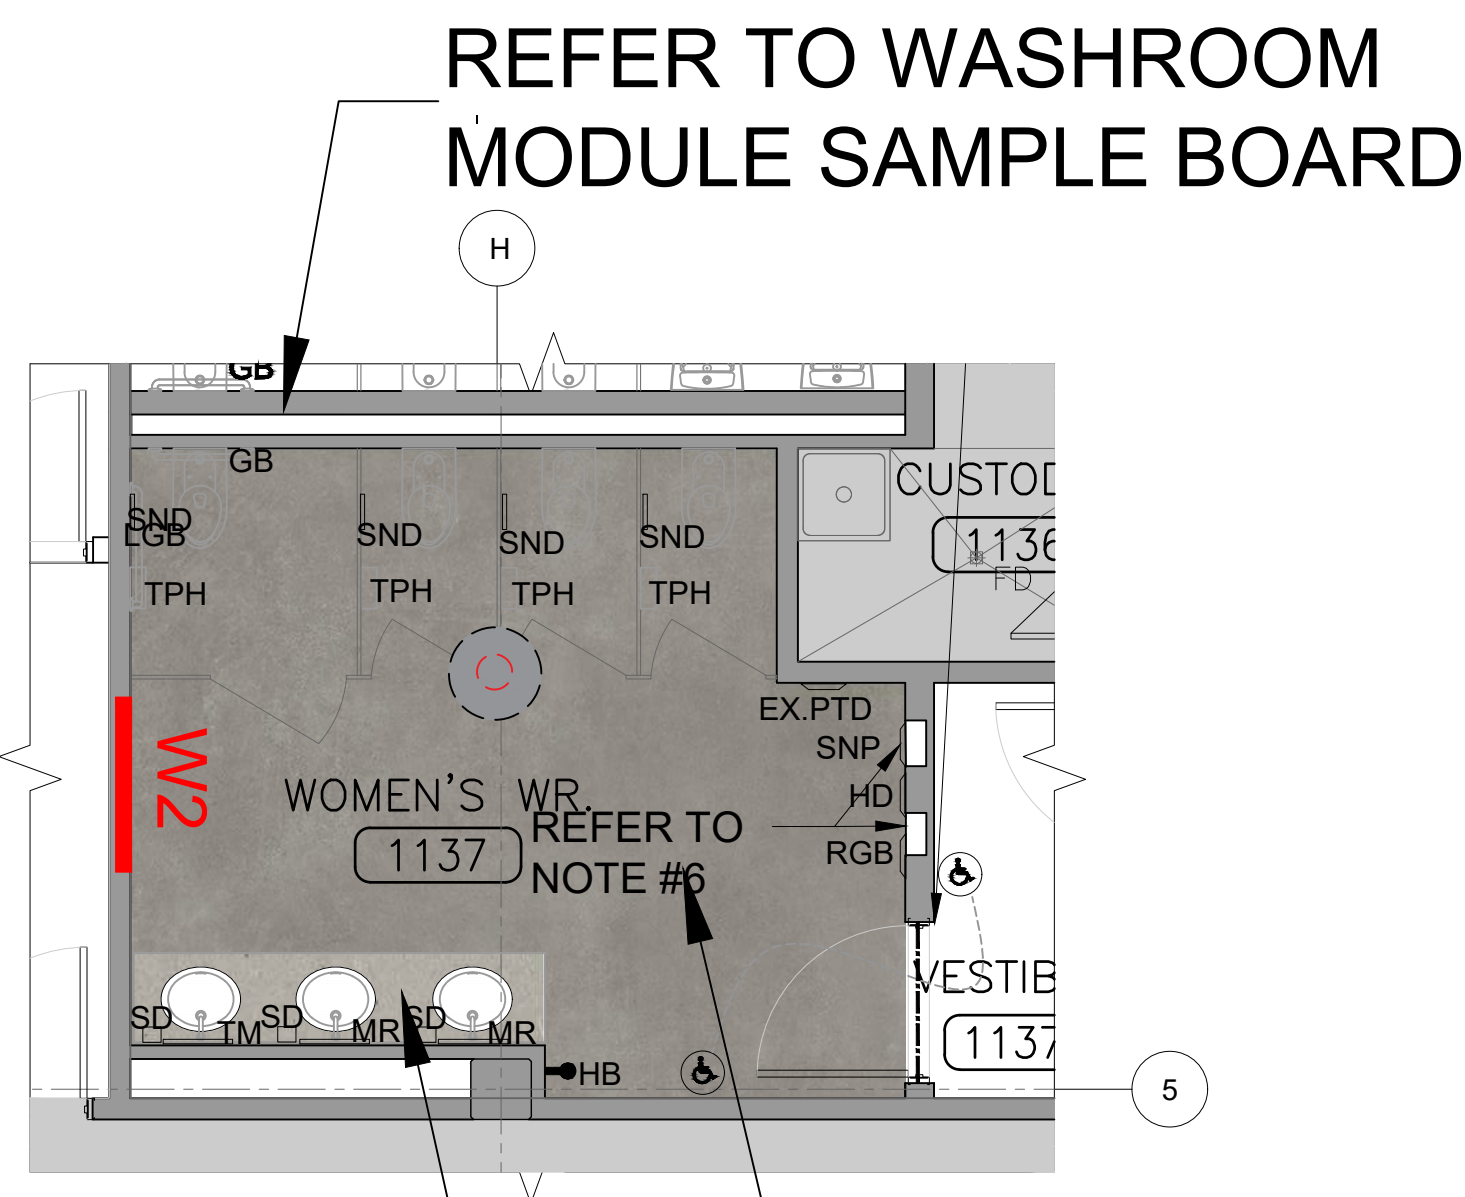

SHEET TITLE	SAMPLE BOARD NO.	 
GENERAL OFFICE / PROJECT AND BOARD ROOM	SB-03	
DATE: MAY 1, 2026	PROJECT NO. 2520797	
PROJECT		
EMIL V. KOLB CENTRE PEEL REGIONAL POLICE FACILITY INTERIOR RENOVATION PROJECT 180 DERRY ROAD EAST, MISSISSAUGA, ON L5T 2Y5		




1
SB-04

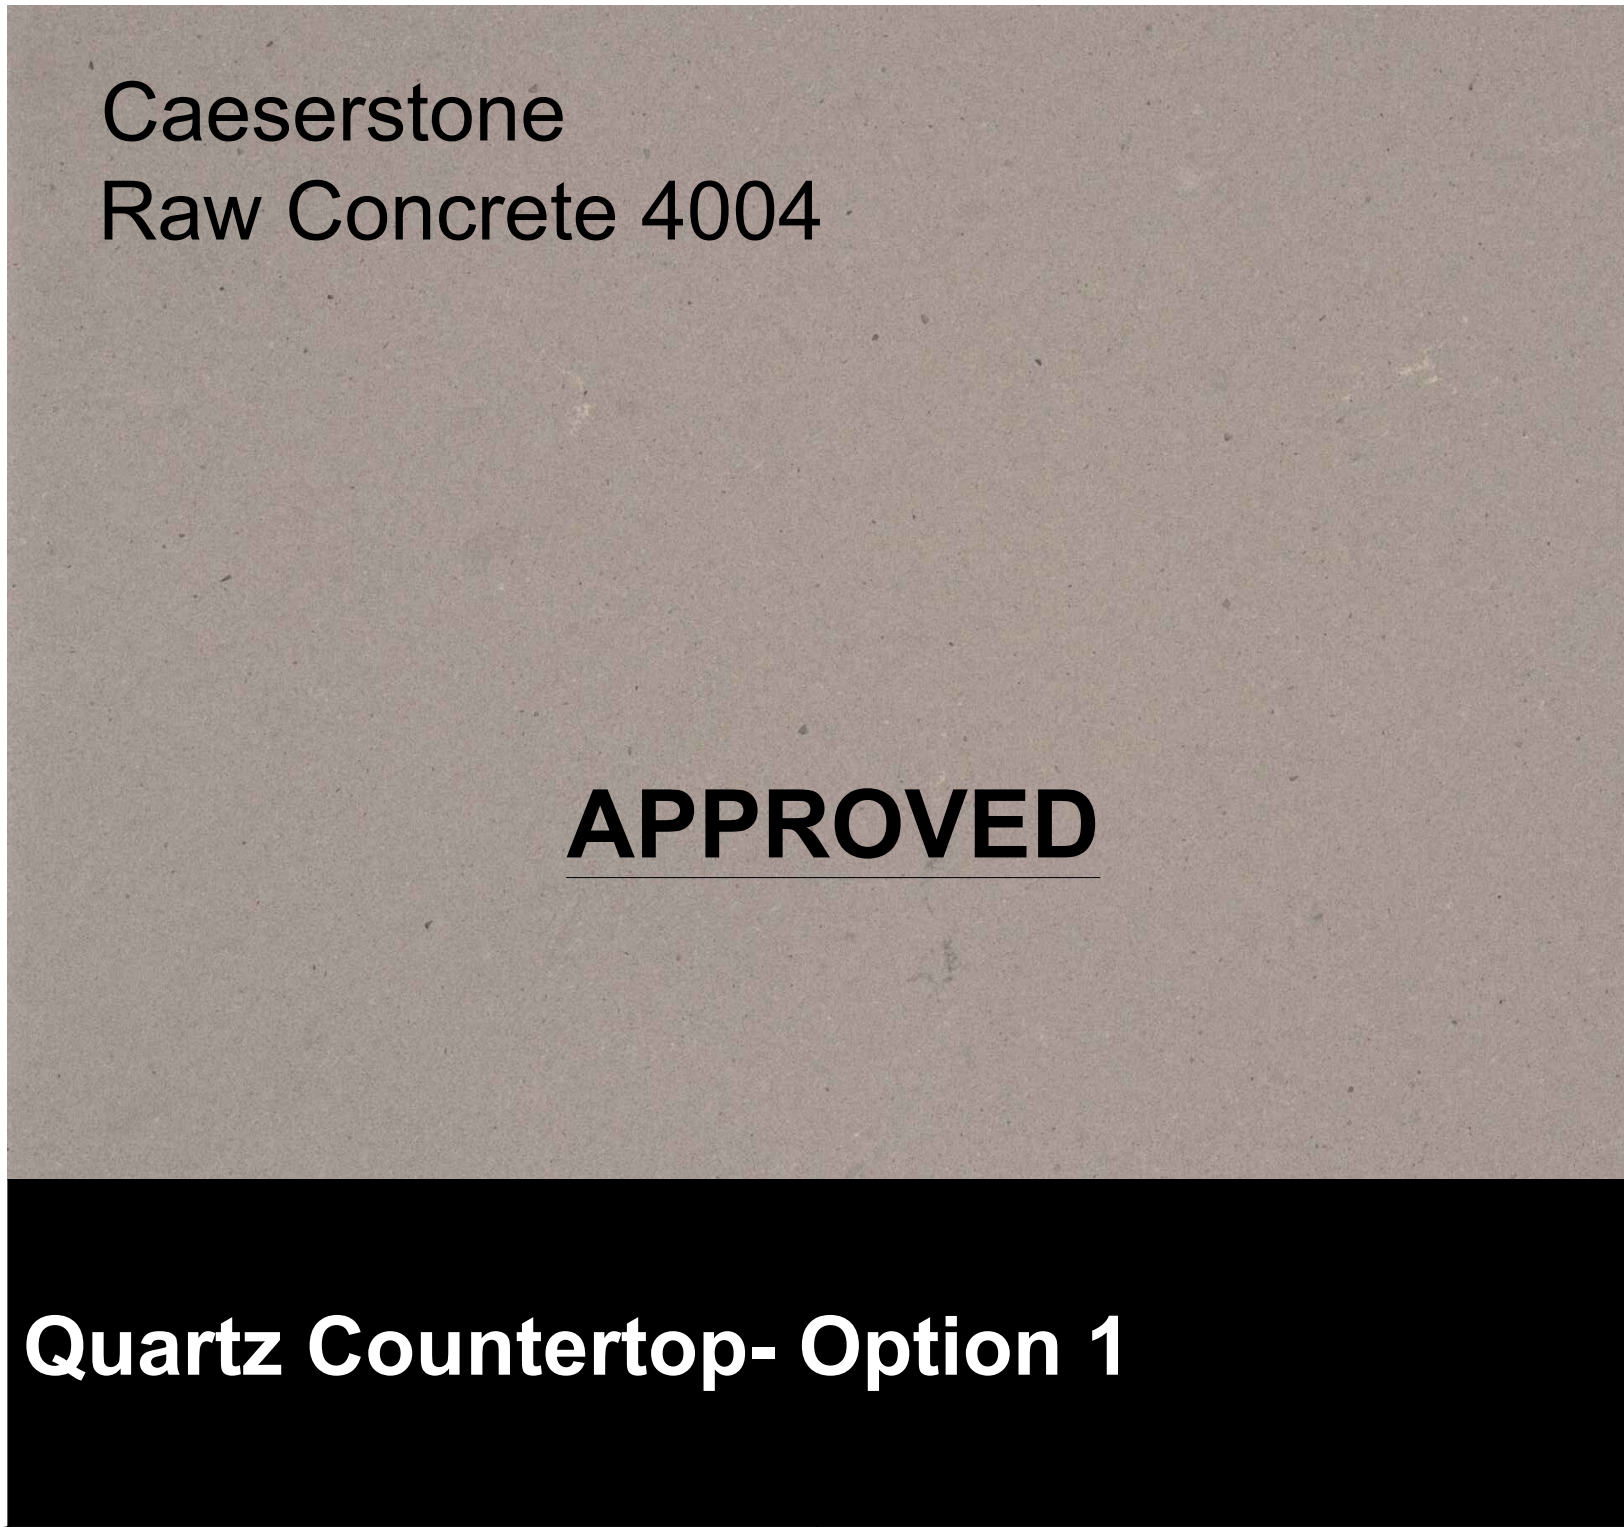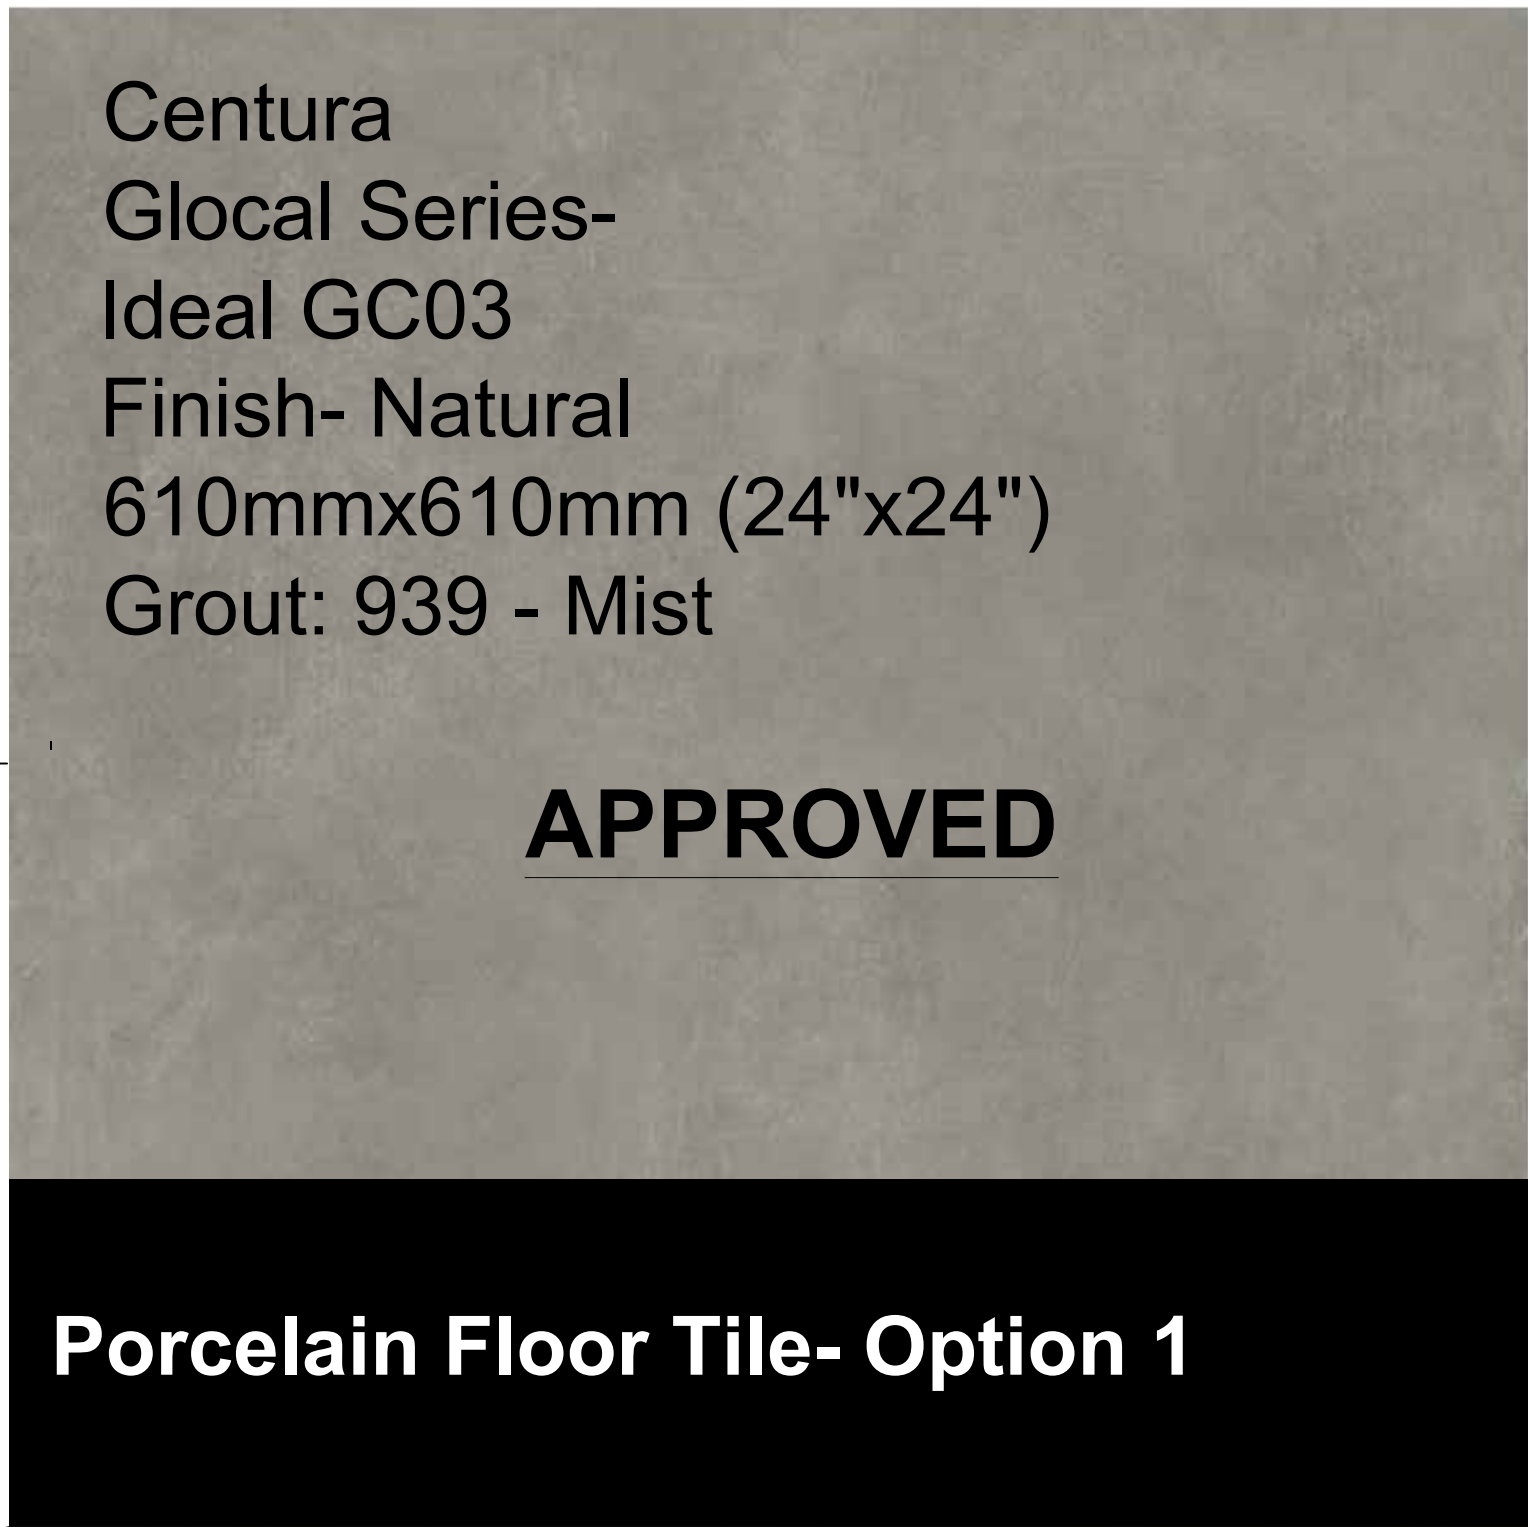TYPICAL WASHROOM ELEVATIONS
SCALE: N.T.S.



SHEET TITLE	SAMPLE BOARD NO.	 
TYPICAL WASHROOM	SB-04	
DATE: MAY 1, 2026	PROJECT NO. 2520797	
PROJECT		
EMIL V. KOLB CENTRE PEEL REGIONAL POLICE FACILITY INTERIOR RENOVATION PROJECT 180 DERRY ROAD EAST, MISSISSAUGA, ON L5T 2Y5		

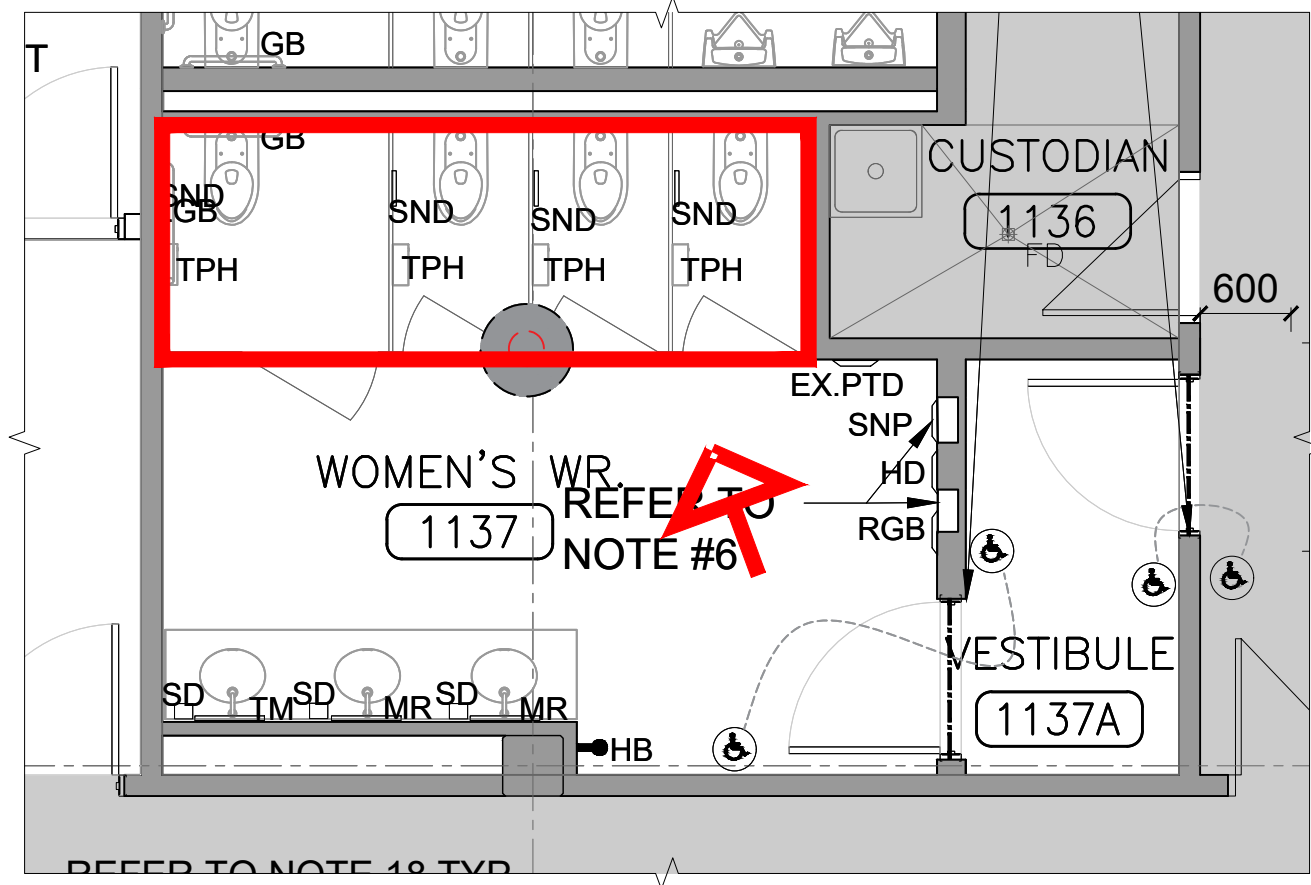




1
SB-05


TYPICAL WASHROOM MODULE PLAN
SCALE: N.T.S.

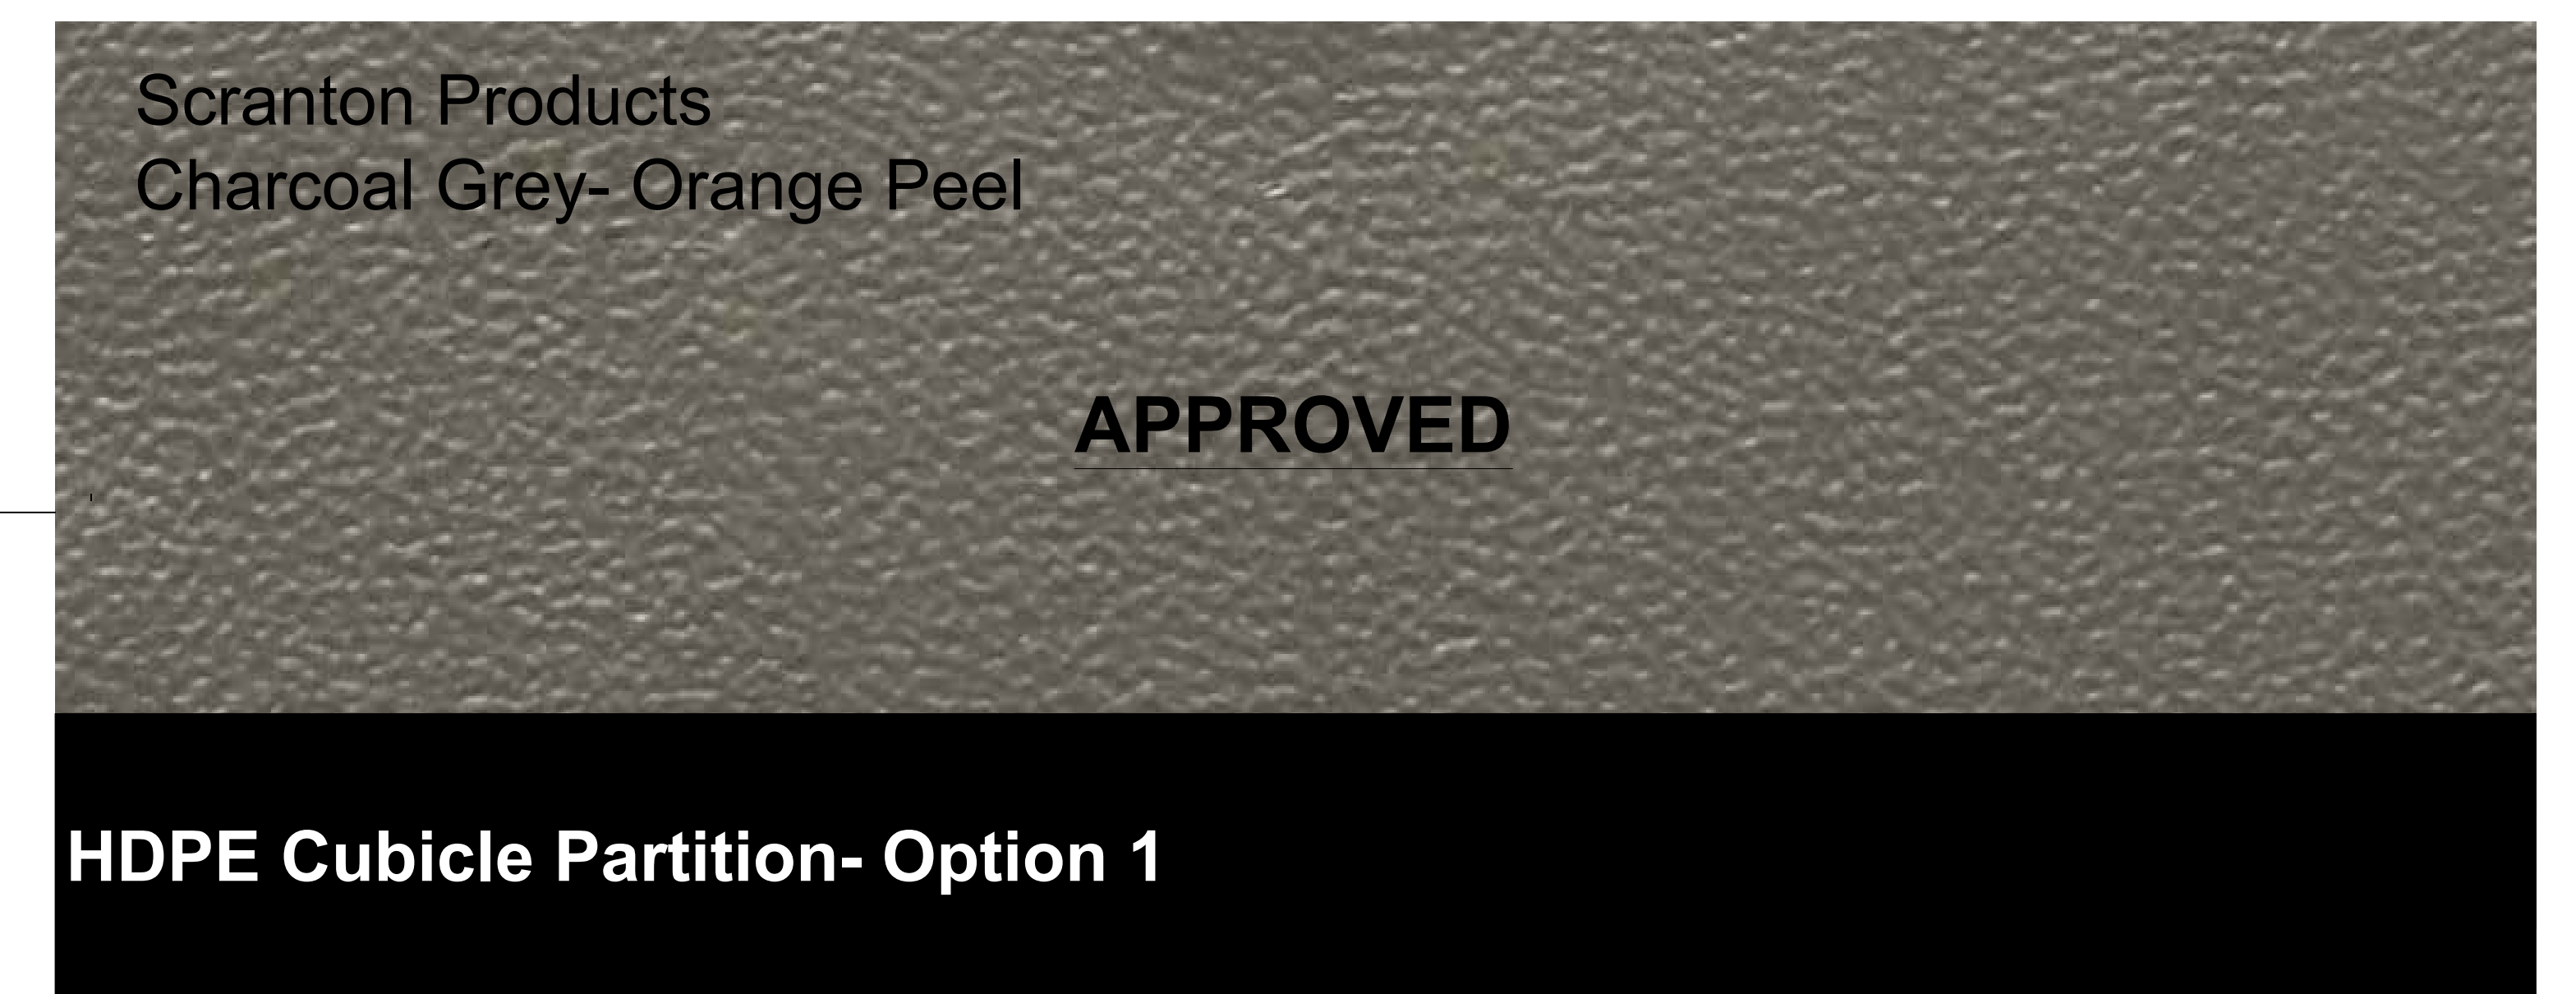

REFER TO SB-04 TYPICAL WASHROOM FOR FLOOR TILE OPTIONS




SHEET TITLE TYPICAL WASHROOM MODULE	SAMPLE BOARD NO. SB-05	 
DATE: MAY 1, 2026	PROJECT NO. 2520797	
PROJECT EMIL V. KOLB CENTRE PEEL REGIONAL POLICE FACILITY INTERIOR RENOVATION PROJECT 180 DERRY ROAD EAST, MISSISSAUGA, ON L5T 2Y5		

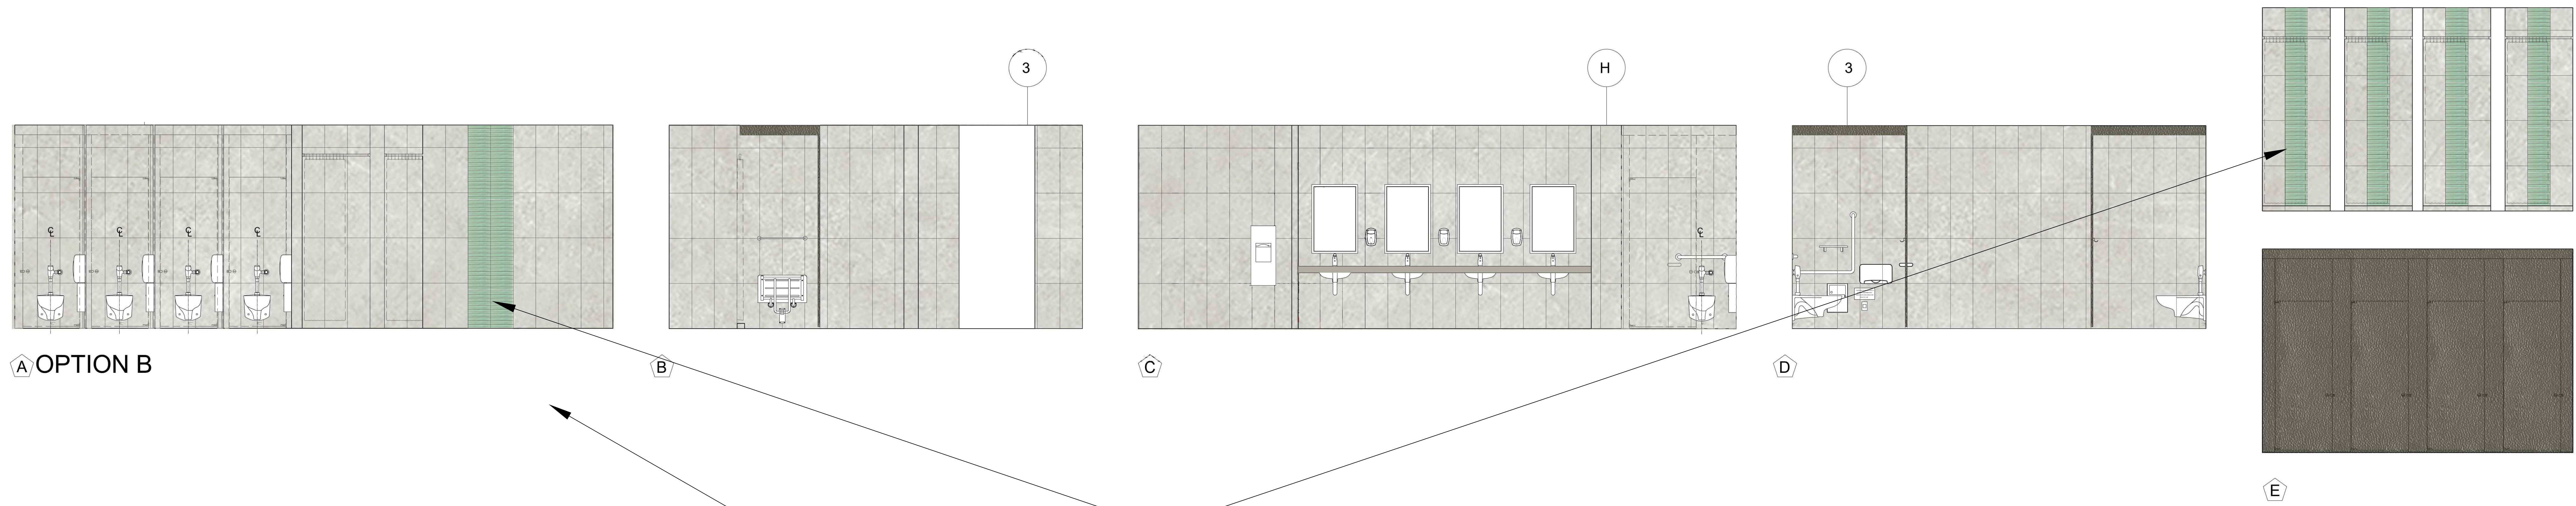

OPTION B

1 TYPICAL SHOWER ELEVATION
SB-06b SCALE: N.T.S.
REFER TO SHOWER
MODULE SAMPLE BOARD

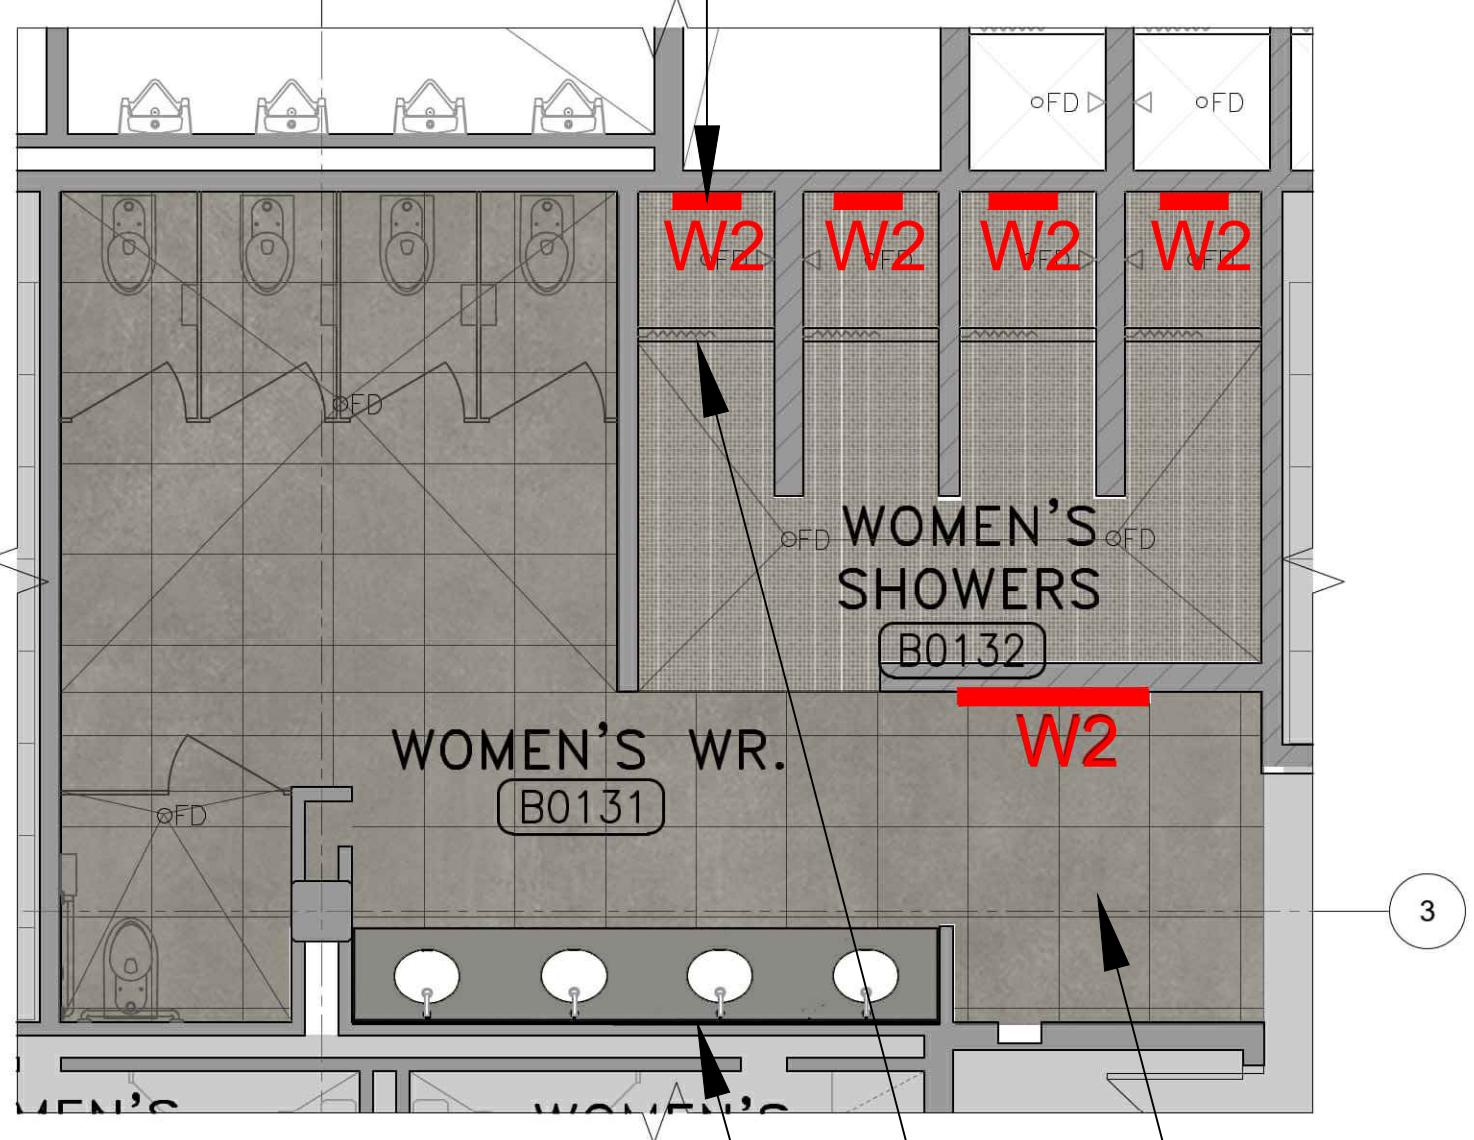

2 TYPICAL SHOWER PLAN
SB-06b SCALE: N.T.S.

Centura
Glocal Series-
Clear GC01
Finish- Natural
305mmx610mm (12"x24")
Grout: 909 - Sterling

APPROVED

General Porcelain Wall Tile- Option 1

Centura
Miki Glass Series-
Atmosphere OPUS662212
Finish- Glossy
50mmx300mm (2"x12")
Grout: 909 - Sterling

APPROVED

Feature Wall 2 Option 1a - Glass Tile

Centura
Glocal Series-
Ideal GC03
Finish- Natural
610mmx610mm (24"x24")
Grout: 939 - Mist

APPROVED

Porcelain Floor Tile- Option 1

Centura
Penta-Normatech-
Dark Taupe
ONI2006177
Finish- Matte
50mmx50mm
(2"x2")
Grout: 939 - Mist

APPROVED


**Shower Porcelain
Floor Tile-
Option 1**

Caeserstone
Raw Concrete
4004

APPROVED

**Quartz
Countertop-
Option 1**

<div>SHEET TITLE</div> <div>TYPICAL SHOWER</div>	<div>SAMPLE BOARD NO.</div> <div>SB-06b</div>	<div><div><div><div><div></div><div></div><div></div></div><div>Region of Peel</div><div>working with you</div></div></div><div><div><div></div><div></div><div></div></div><div>NGA</div><div>ARCHITECTS</div></div></div>
<div>DATE: MAY 1, 2026</div>	<div>PROJECT NO. 2520797</div>	
<div>PROJECT</div> <div>EMIL V. KOLB CENTRE PEEL REGIONAL POLICE FACILITY</div> <div>INTERIOR RENOVATION PROJECT</div> <div>180 DERRY ROAD EAST, MISSISSAUGA, ON L5T 2Y5</div>		

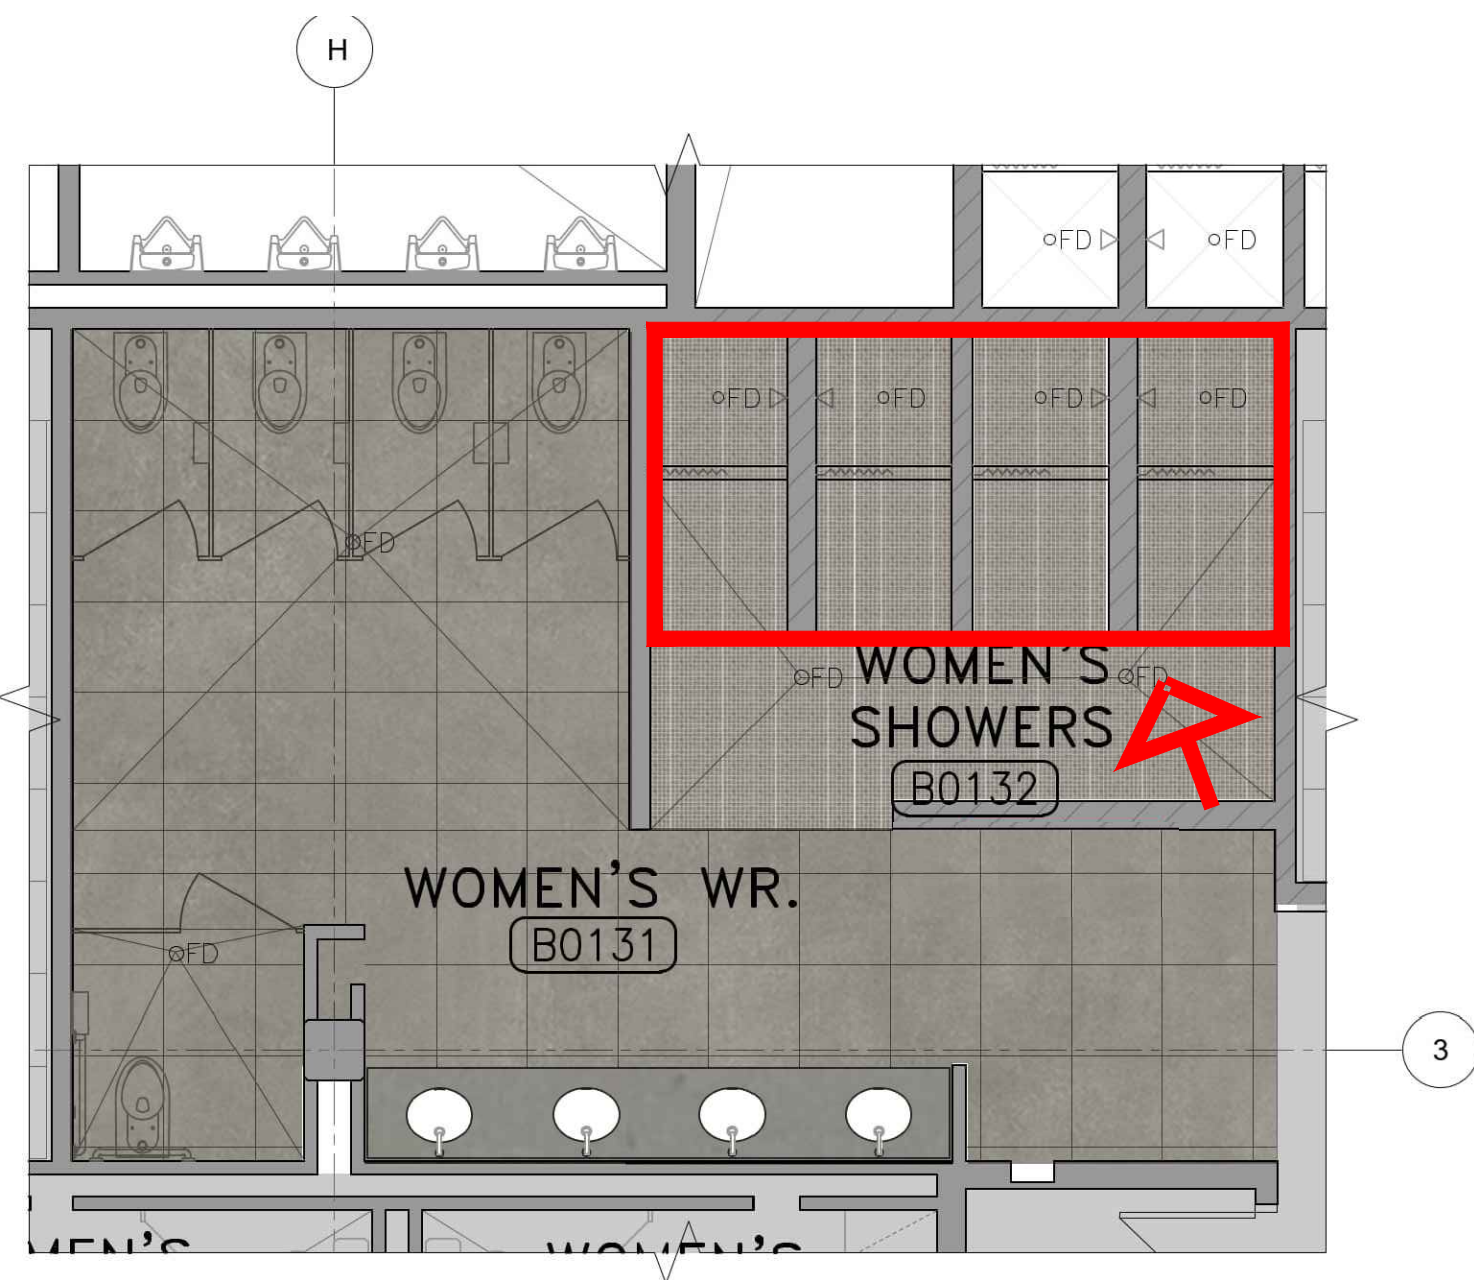




1
SB-07



TYPICAL SHOWER MODULE PLAN
SCALE: N.T.S.

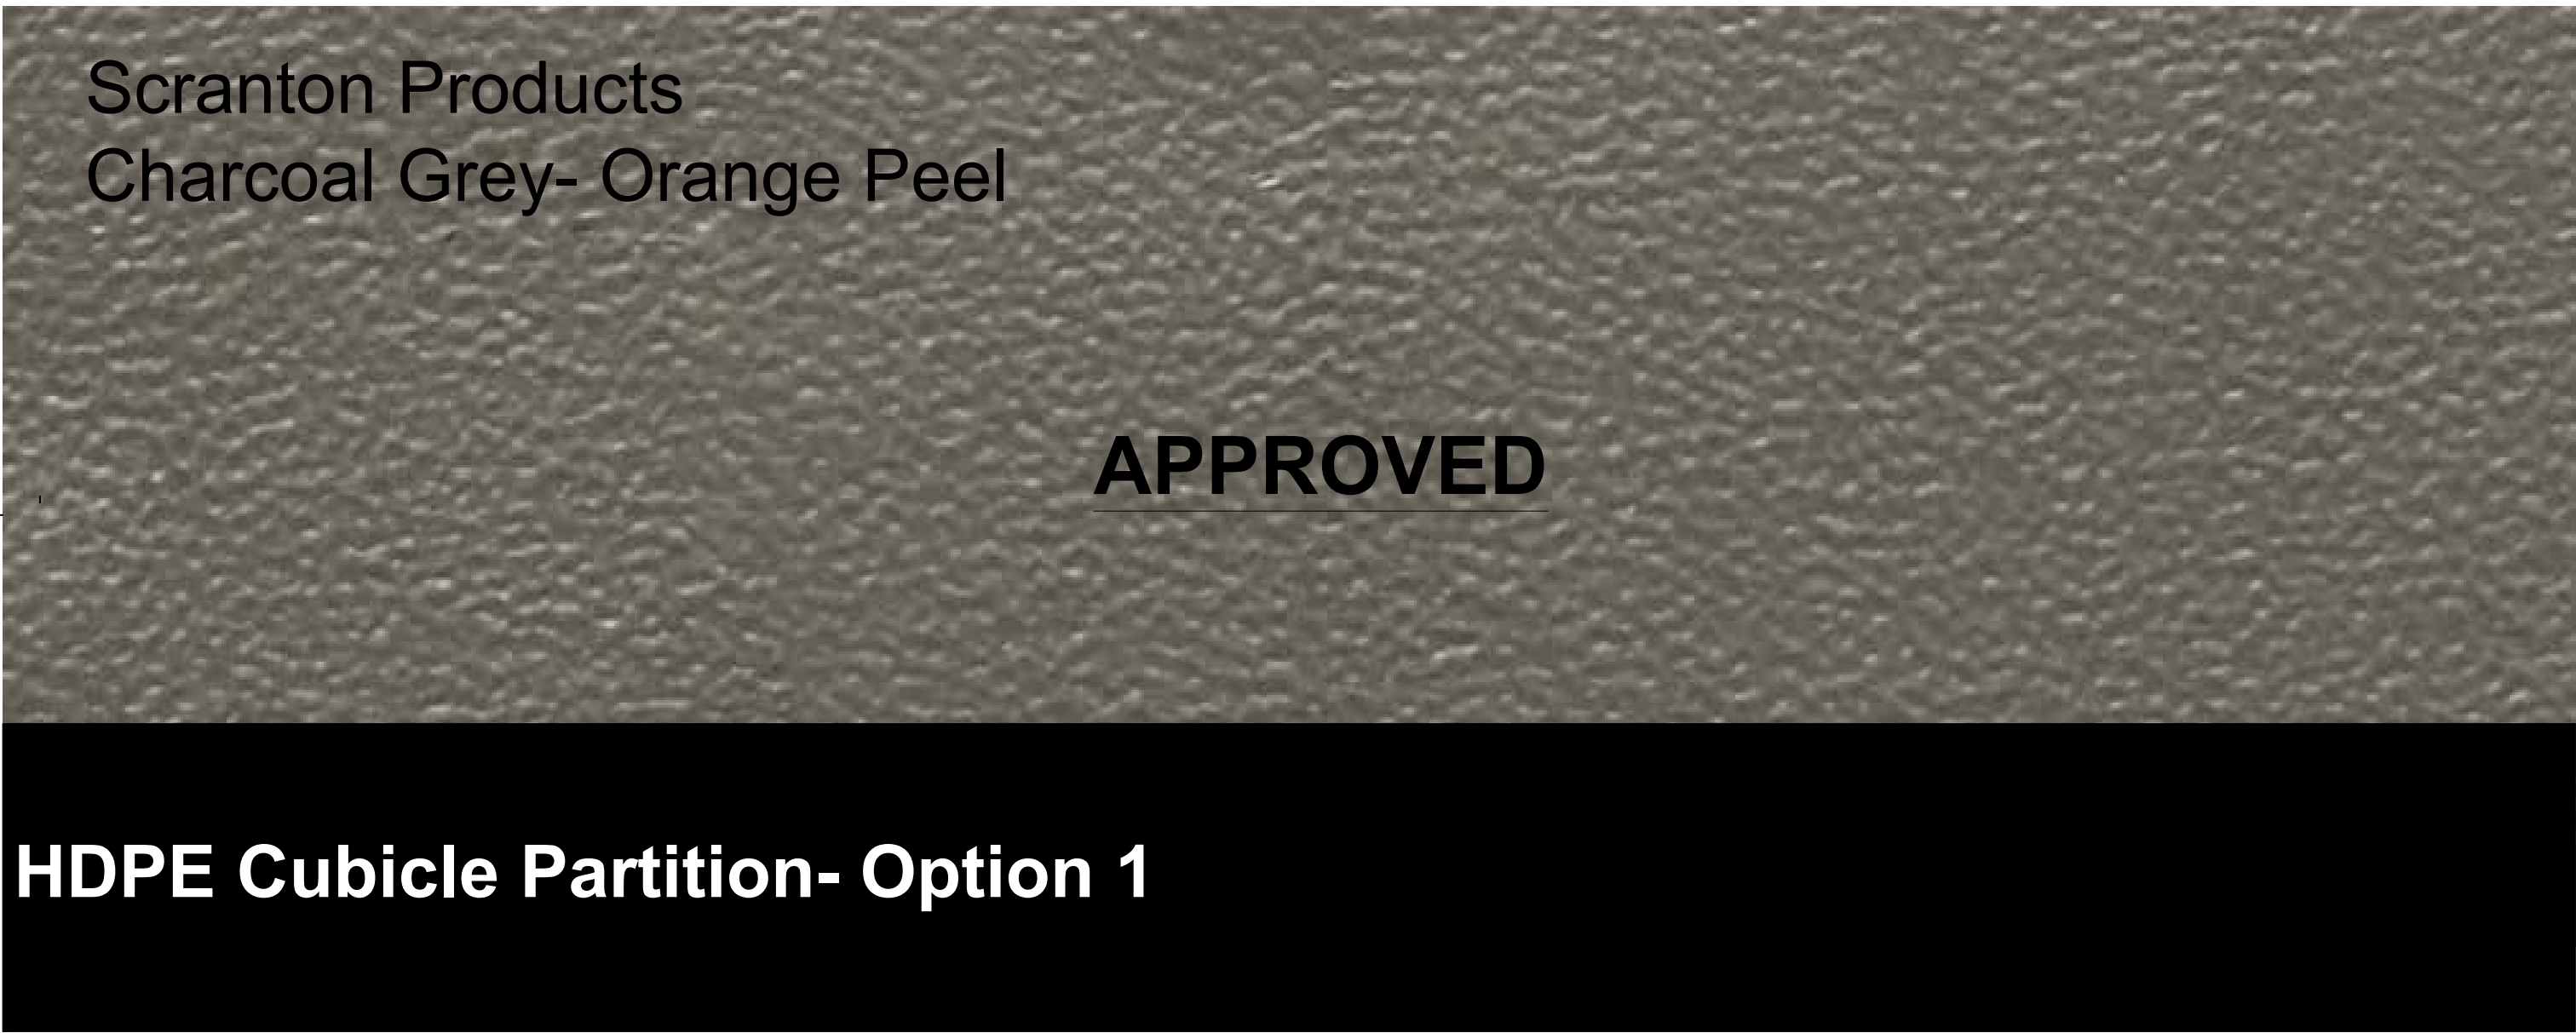





REFER TO SB-06b TYPICAL SHOWER FOR FLOOR
TILE OPTIONS



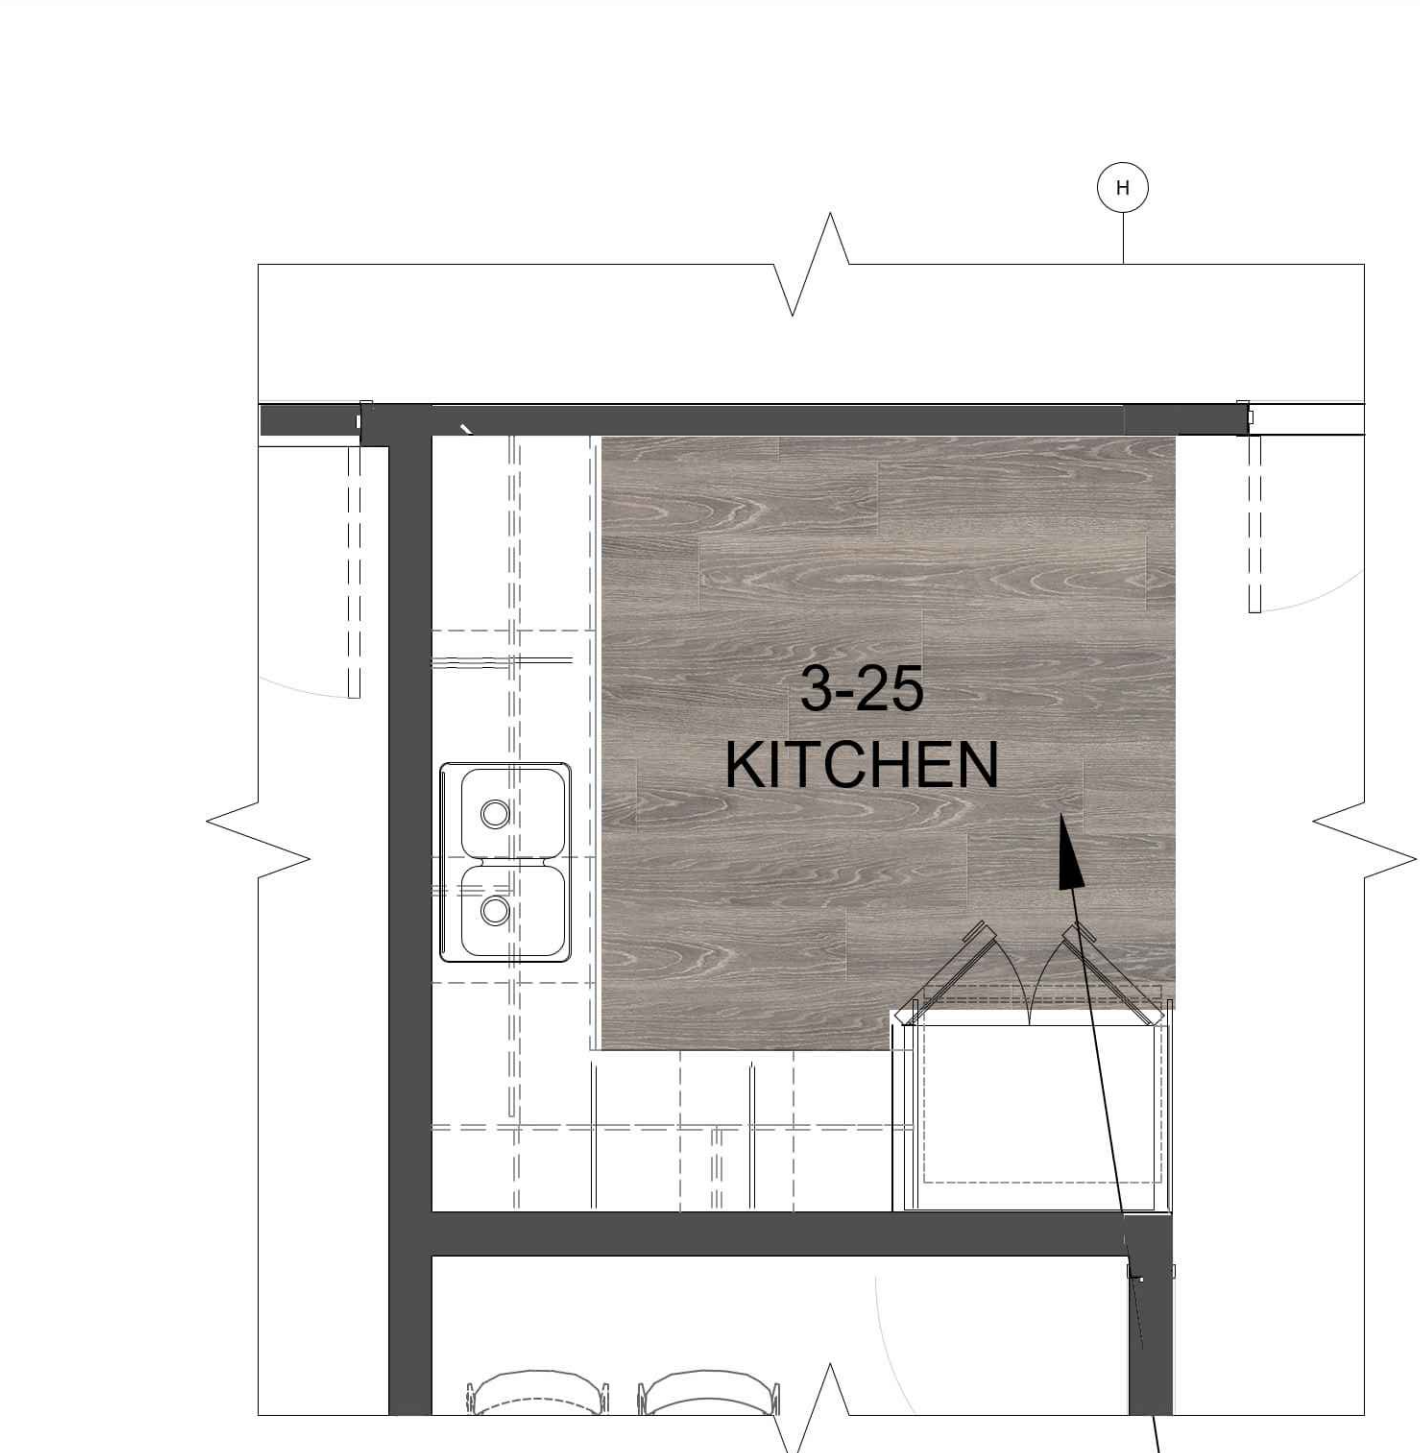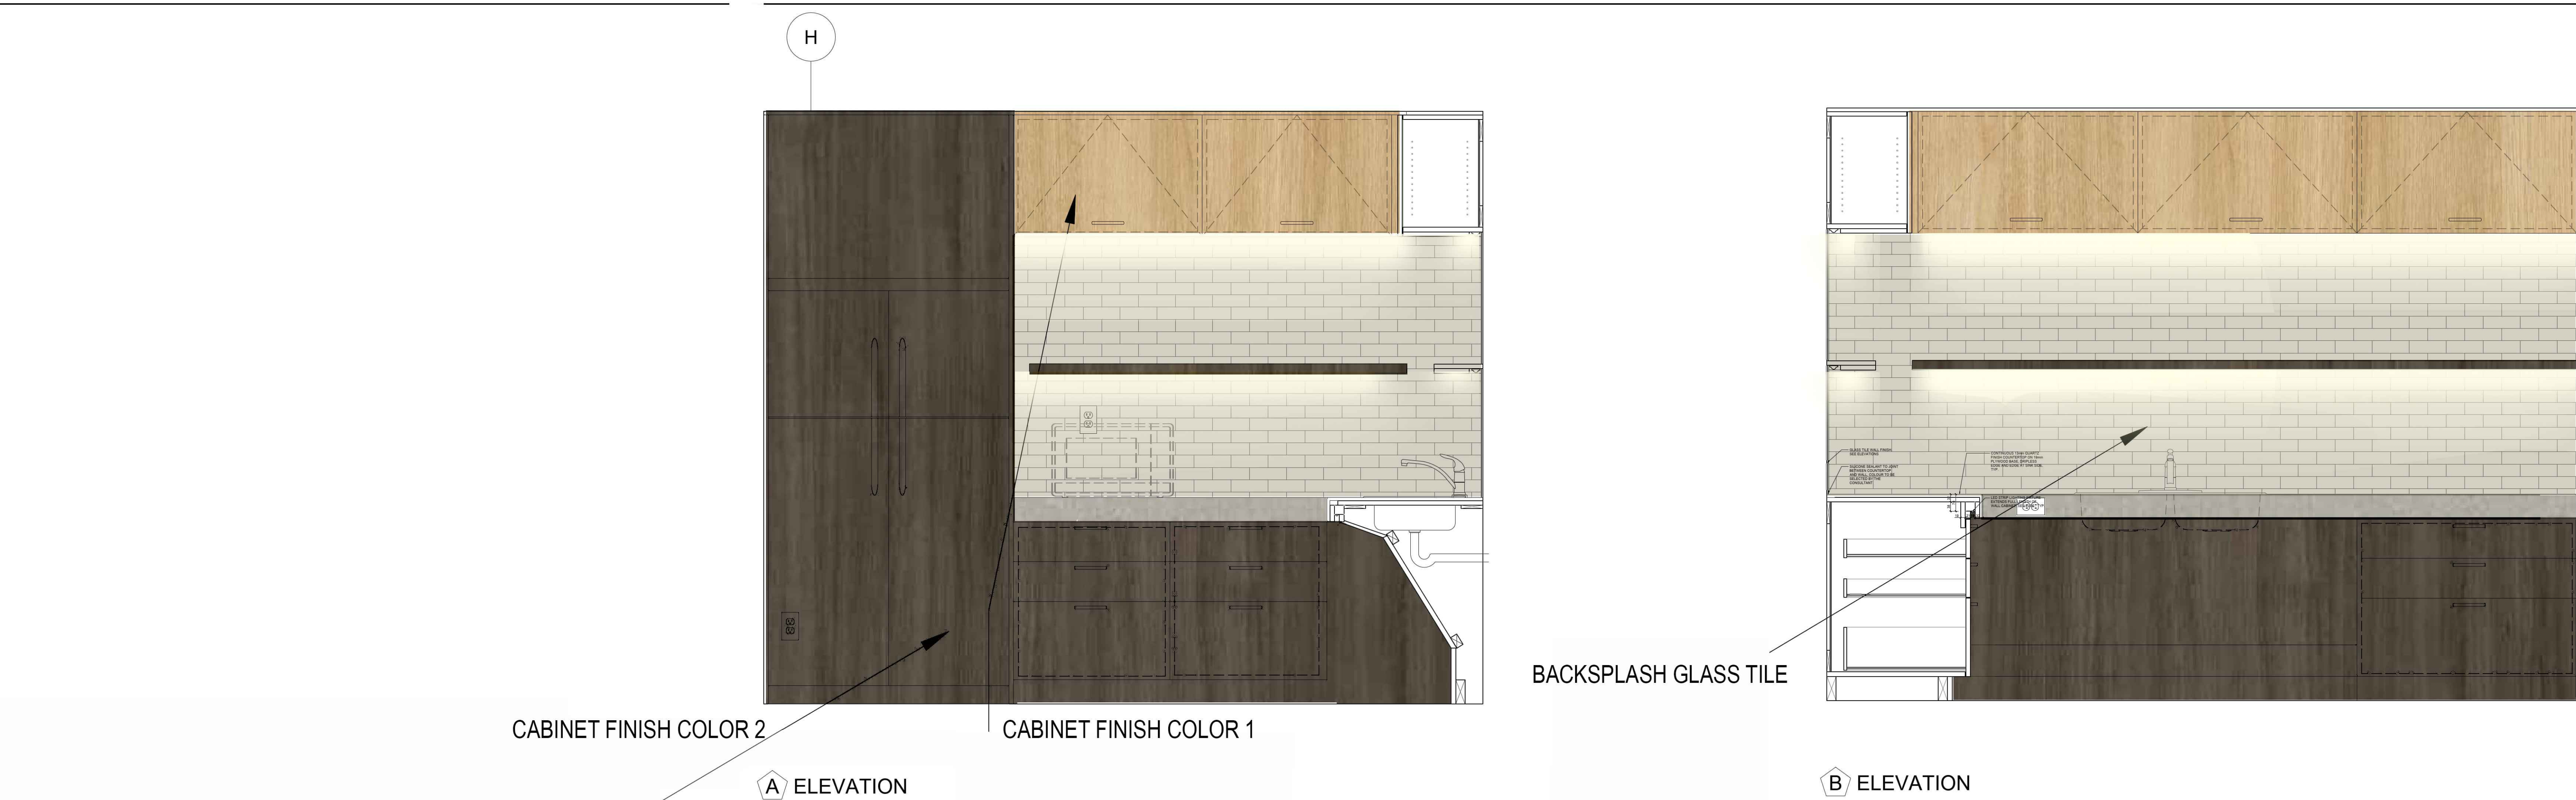

SHEET TITLE TYPICAL SHOWER MODULE		SAMPLE BOARD NO. SB-07	 
DATE: MAY 1, 2026		PROJECT NO. 2520797	
PROJECT EMIL V. KOLB CENTRE PEEL REGIONAL POLICE FACILITY INTERIOR RENOVATION PROJECT 180 DERRY ROAD EAST, MISSISSAUGA, ON L5T 2Y5			

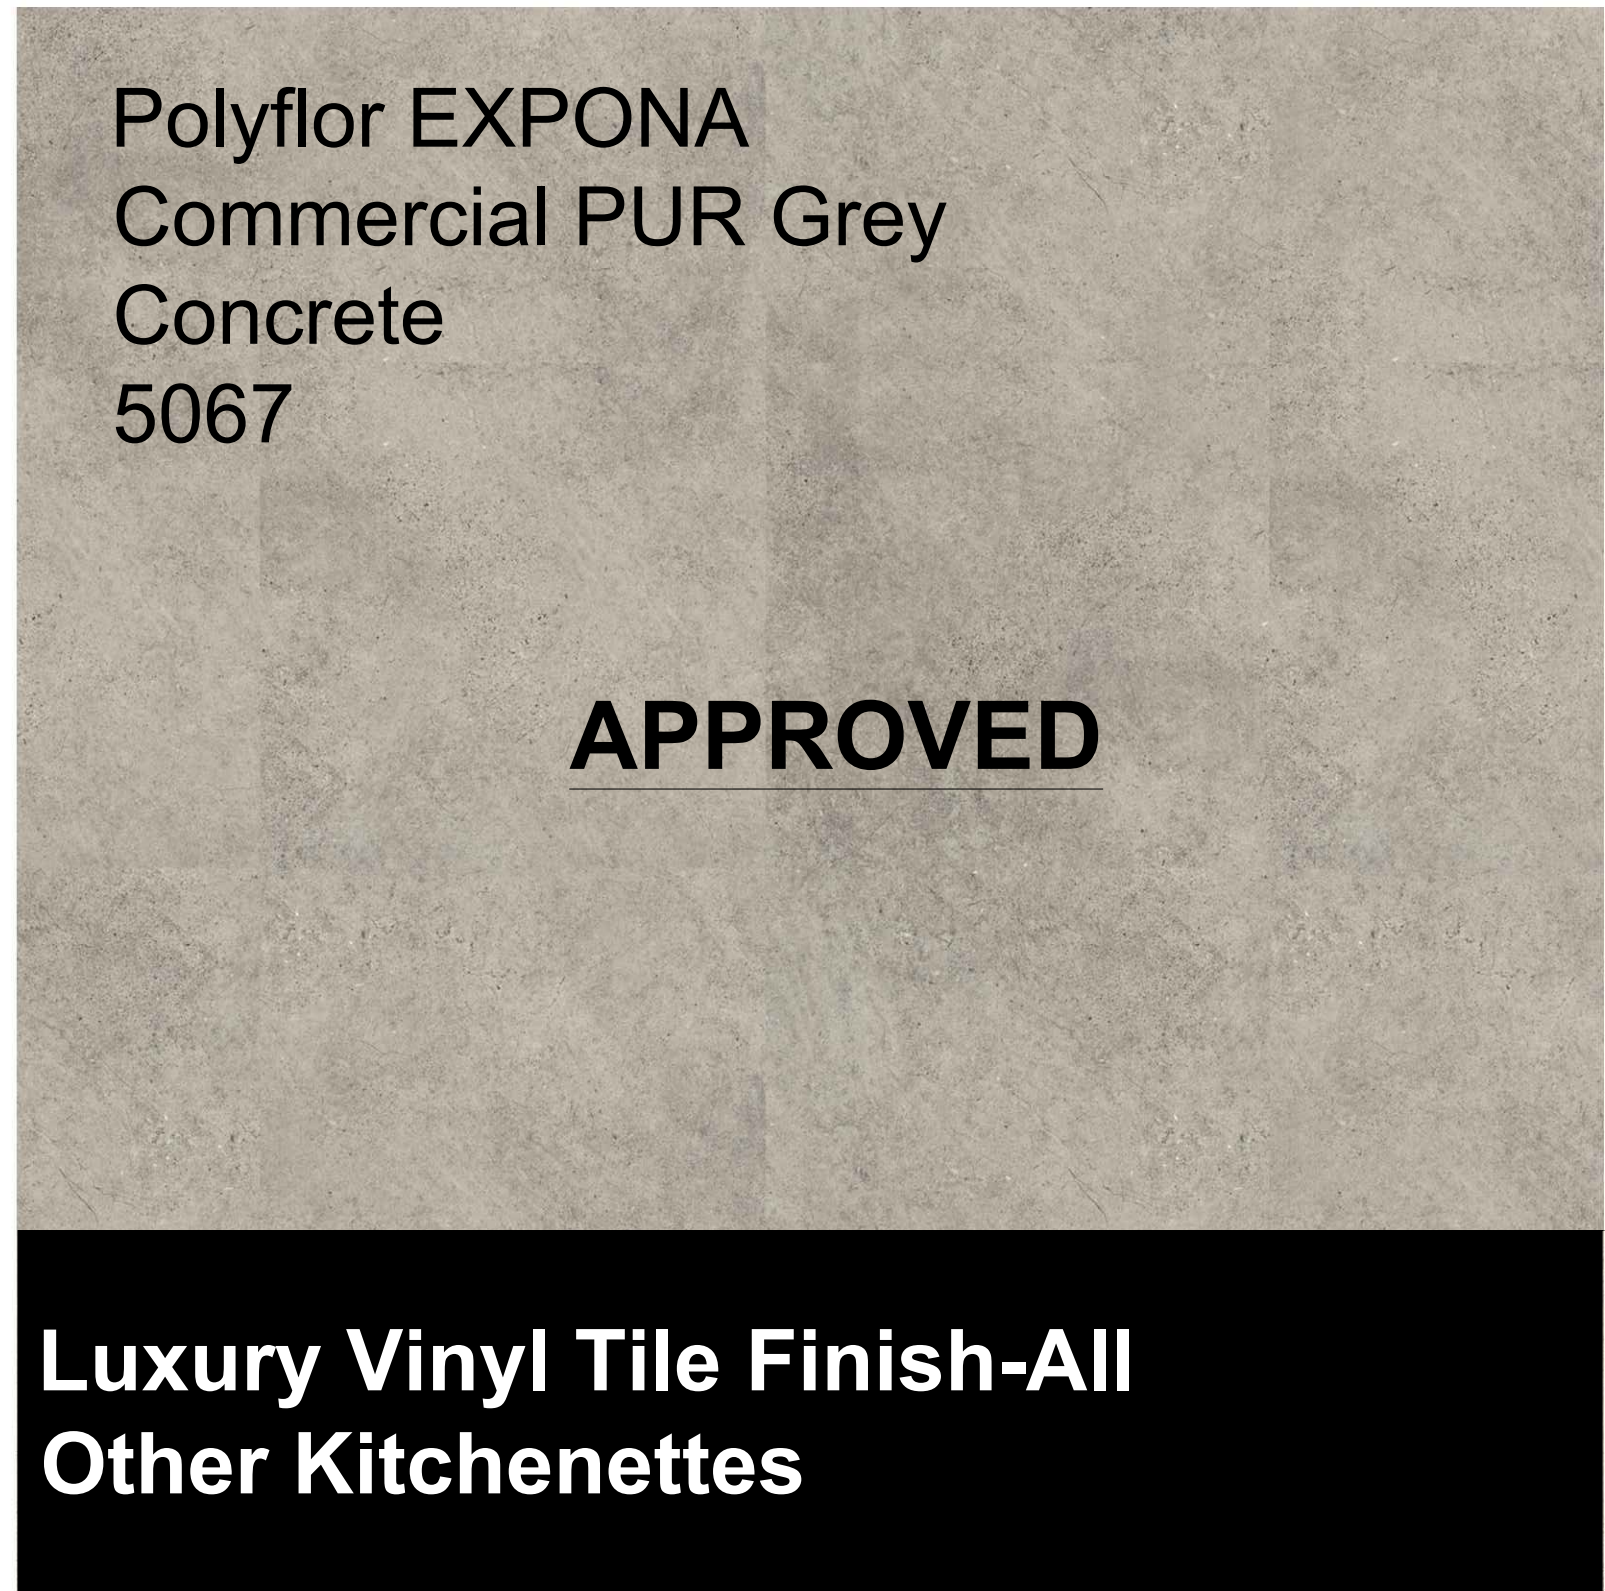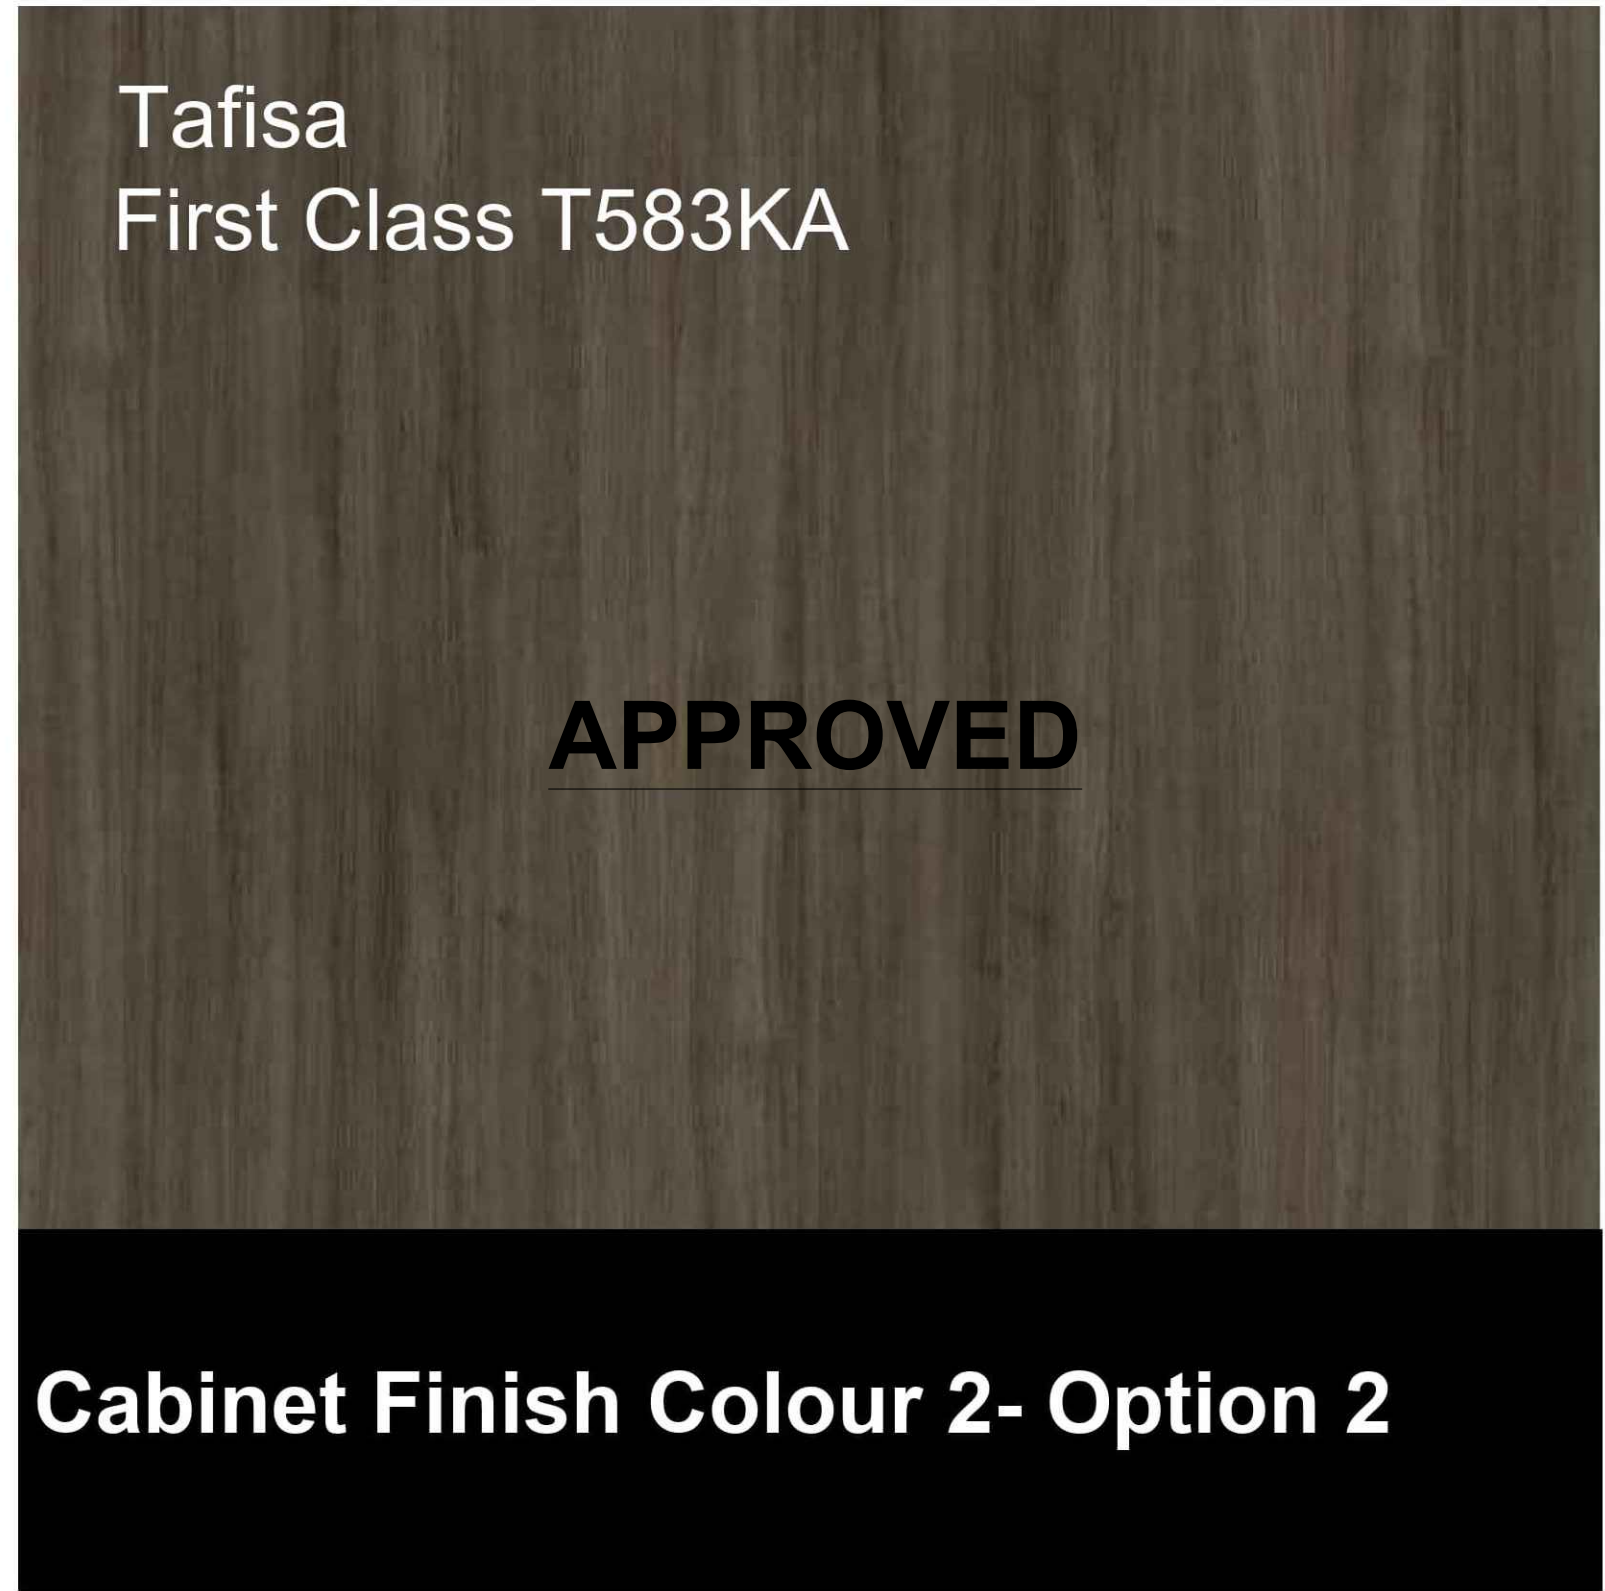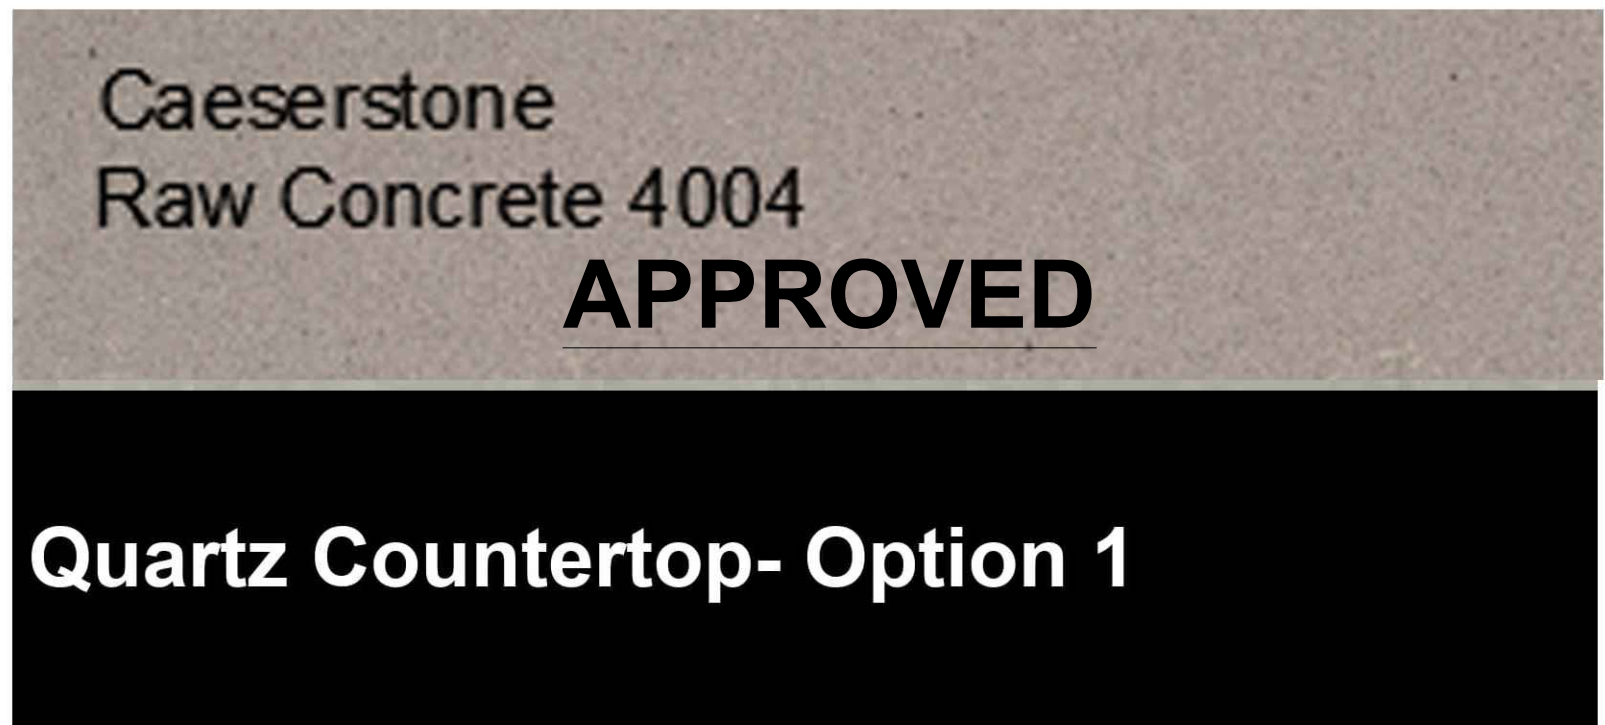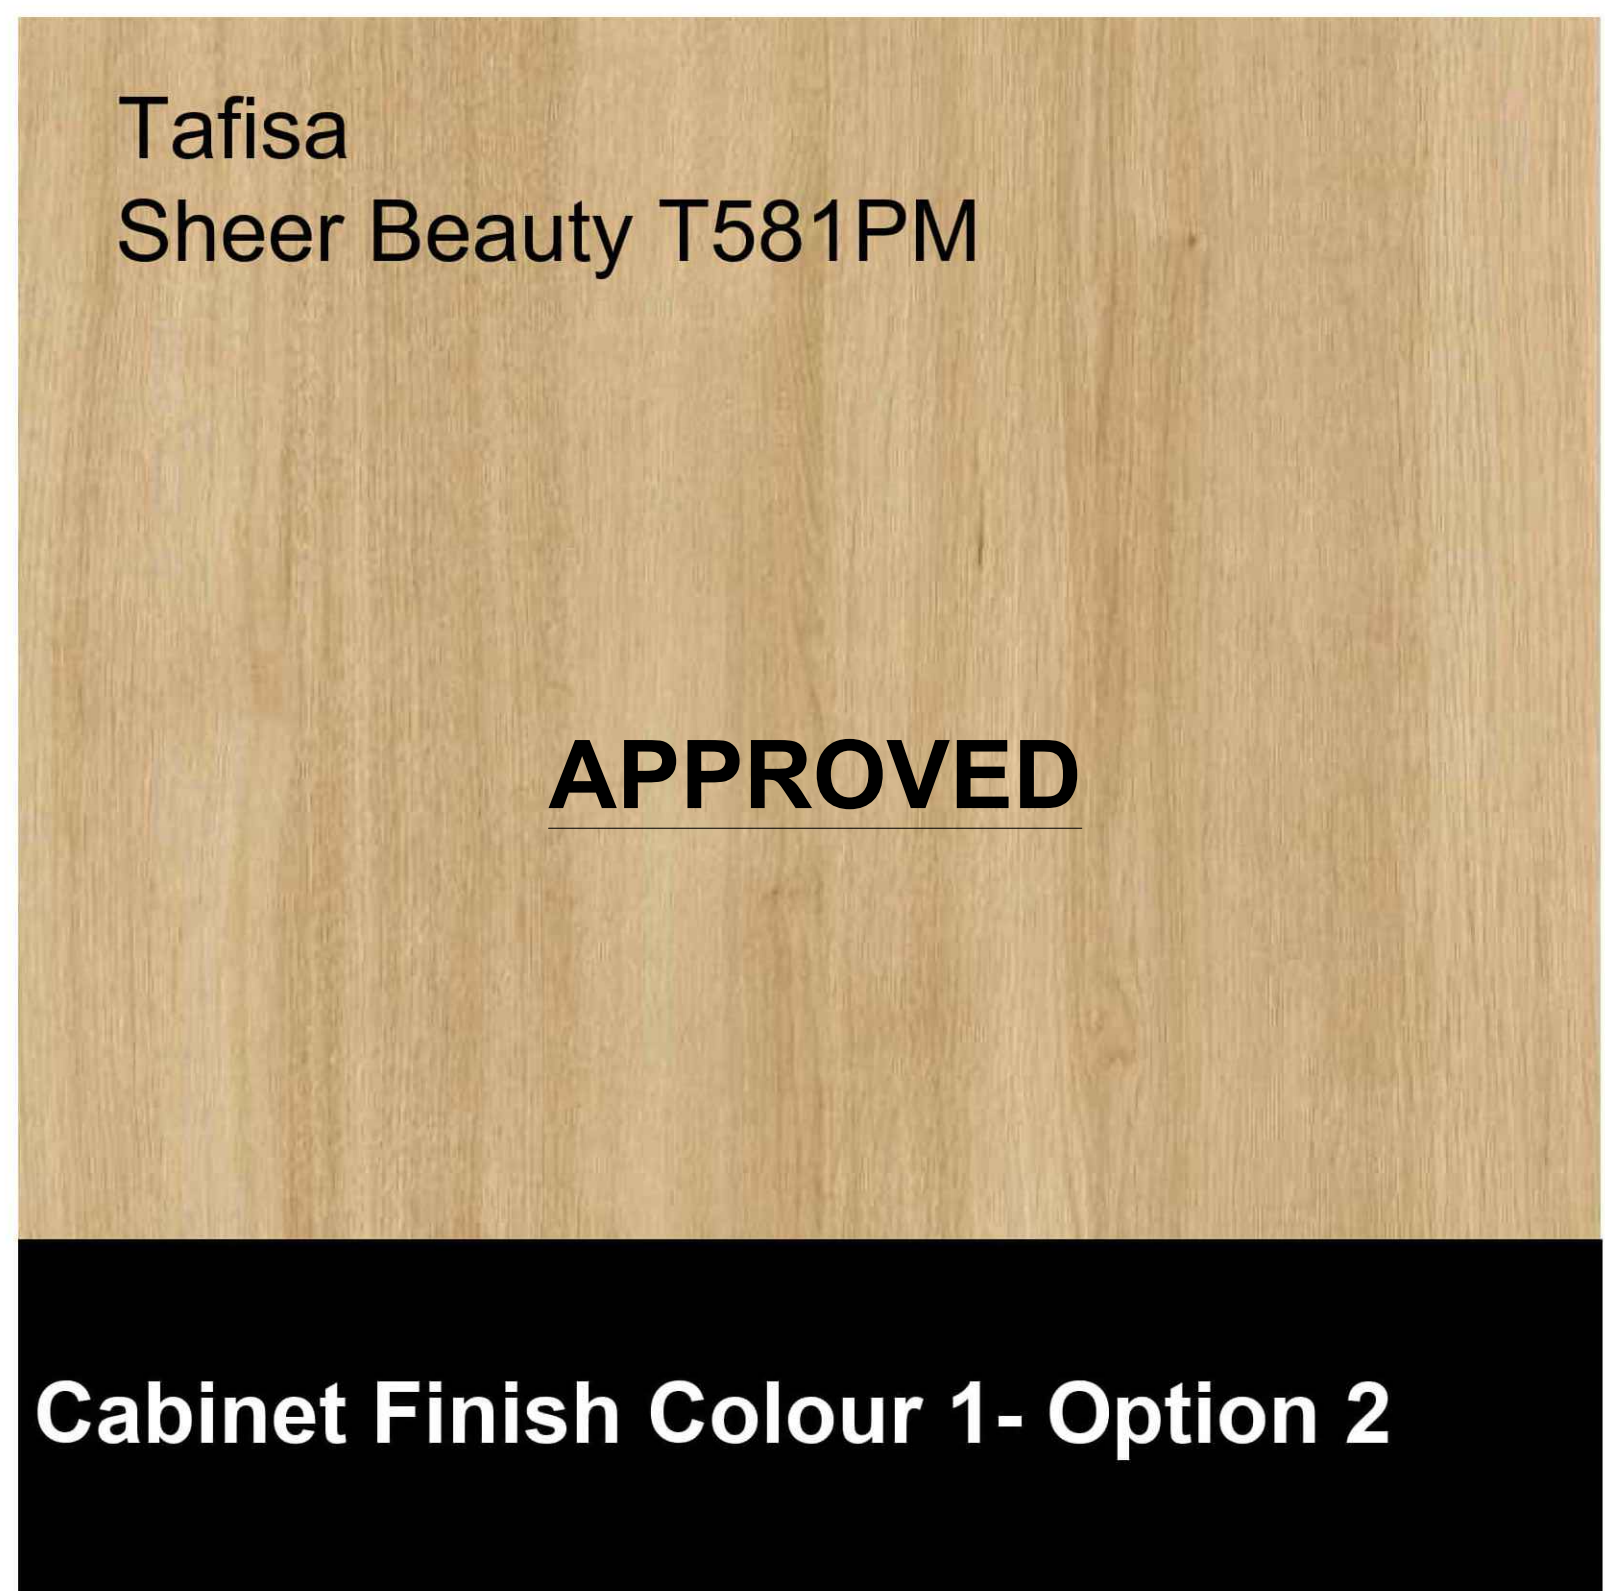


2 TYPICAL KITCHEN PLAN
SB-07 SCALE: N.T.S.




SHEET TITLE	SAMPLE BOARD NO.	 
TYPICAL KITCHEN	SB-08	
DATE: MAY 1, 2026	PROJECT NO. 2520797	
PROJECT EMIL V. KOLB CENTRE PEEL REGIONAL POLICE FACILITY INTERIOR RENOVATION PROJECT 180 DERRY ROAD EAST, MISSISSAUGA, ON L5T 2Y5		

1
S102 TYPICAL SECTION – STC DOOR LATERAL SUPPORT
WHEN INSTALLED WITHIN NEW PARTITION WALLS (CONSTRUCTED WITH CONCRETE BLOCK OR LIGHT GAUGE STEEL) 1:20
SEE ARCHITECTURAL DRAWINGS FOR QUANTITY AND LOCATION.

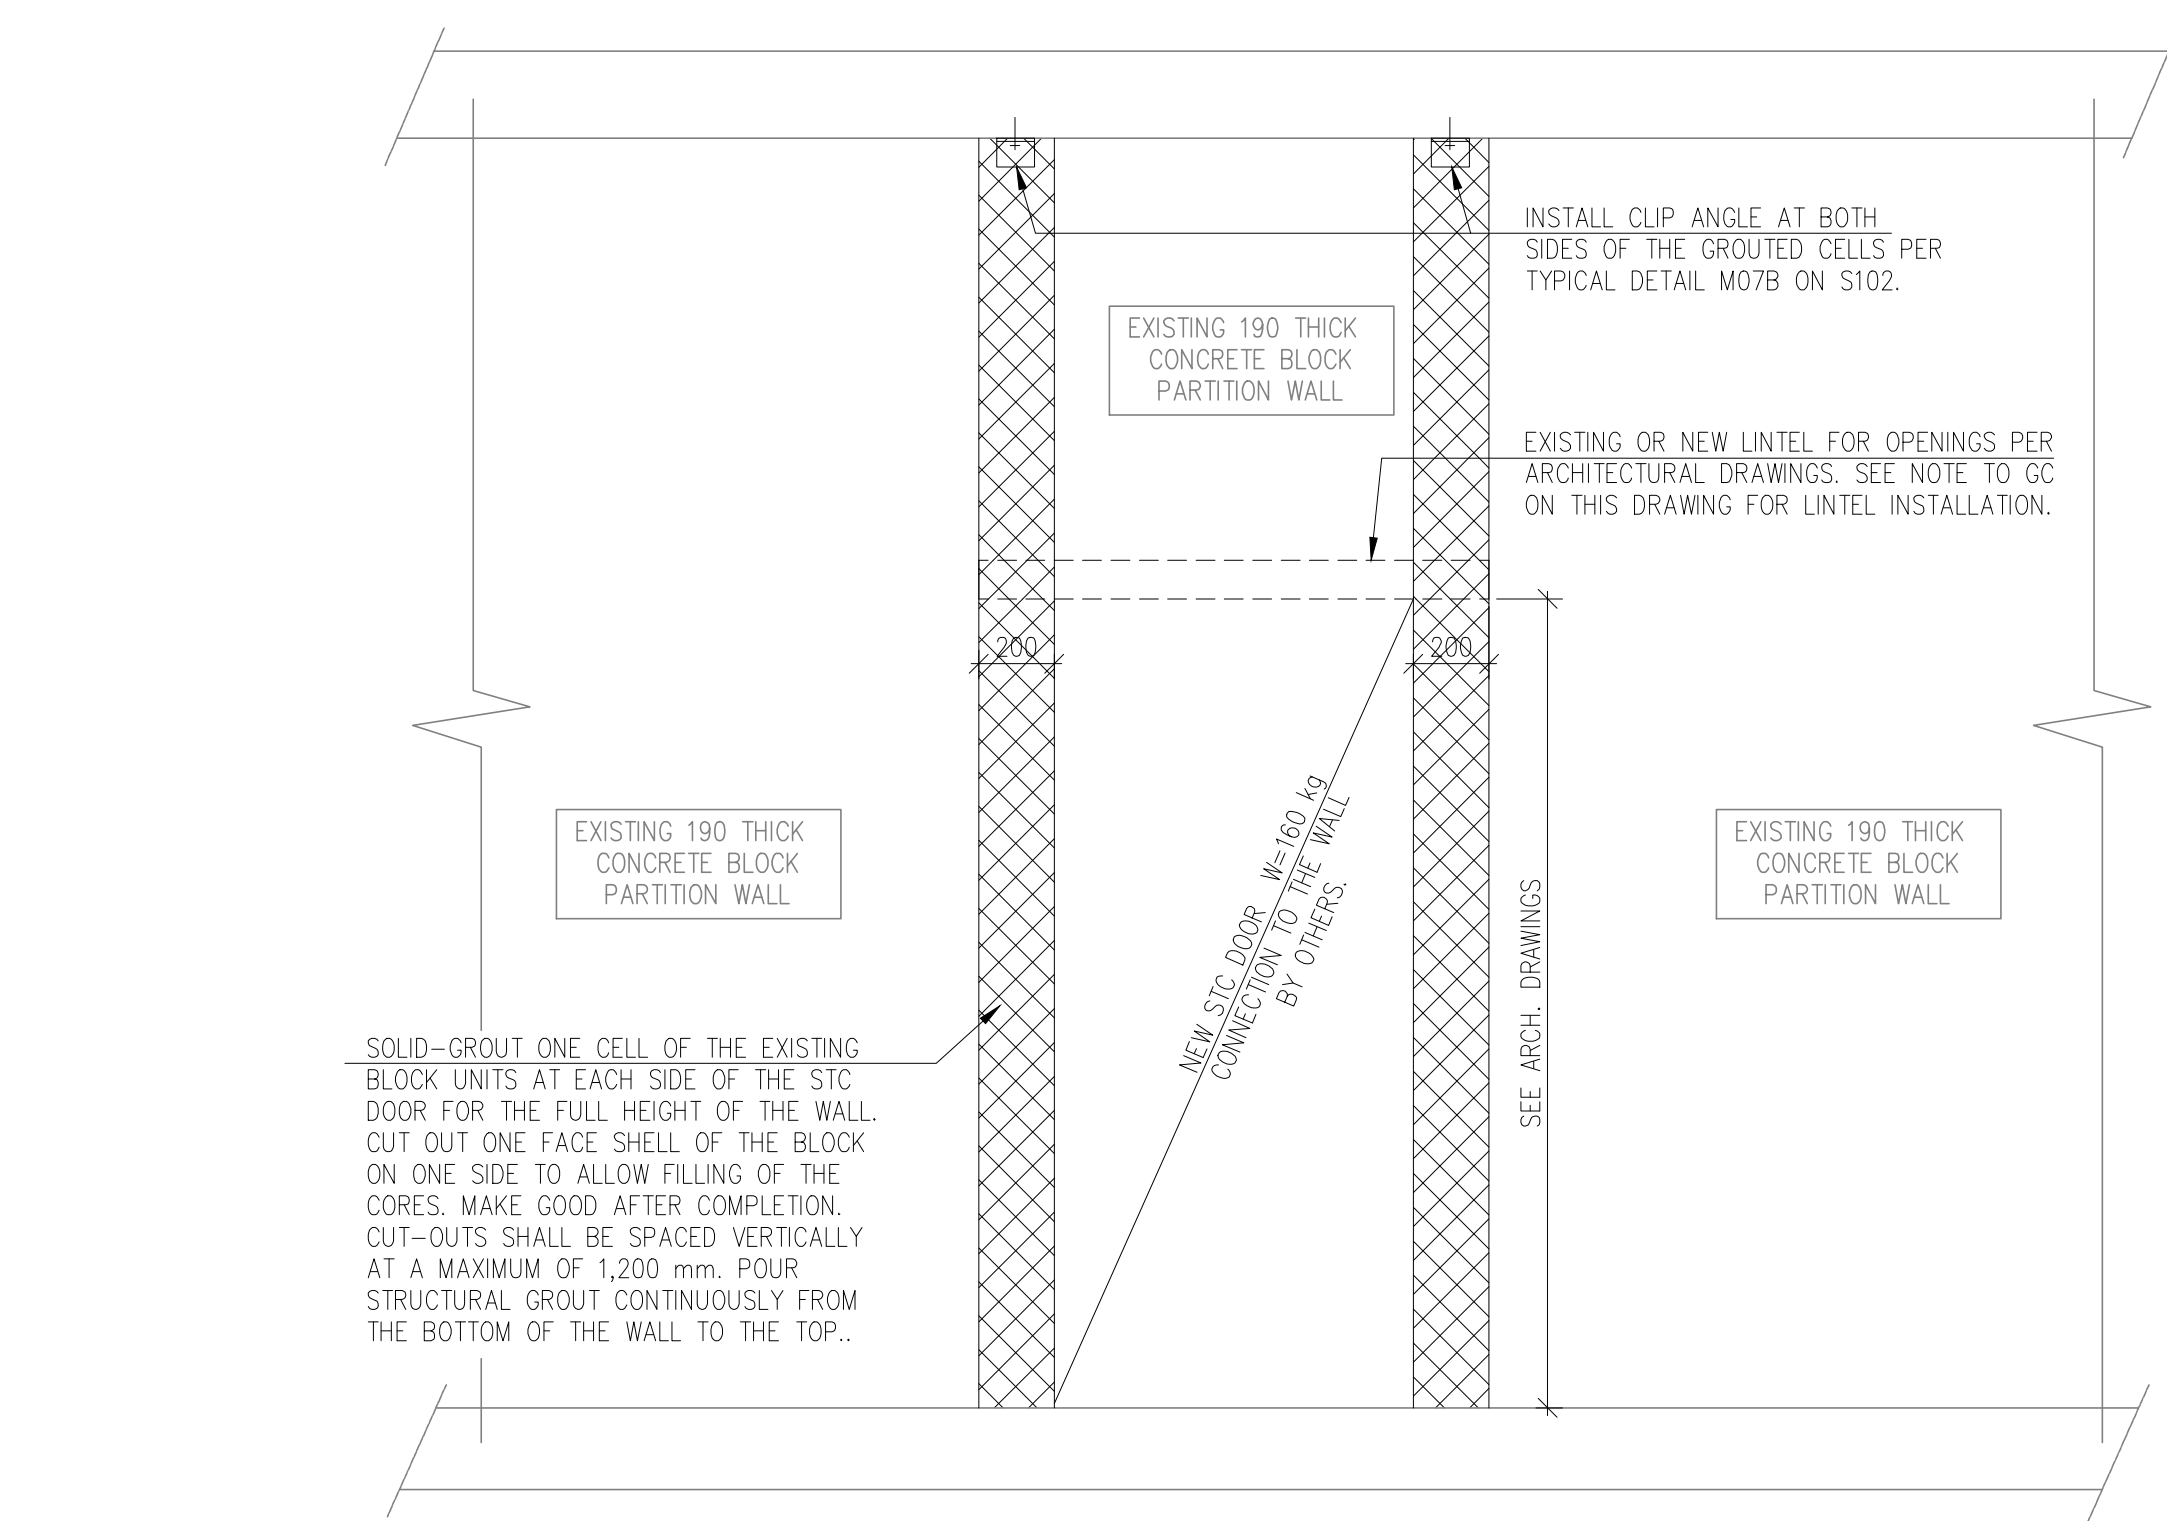


4
S102 STC DOOR LATERAL SUPPORT WHEN INSTALLED
WITHIN EXISTING CONCRETE BLOCK PARTITION WALL 1:20
SEE ARCHITECTURAL DRAWINGS FOR QUANTITY AND LOCATION.


NON-LOAD BEARING BLOCK WALL LINTELS									
M01A									
STRUCTURAL STEEL LINTELS									
MASONRY BLOCK THICKNESS									
WALL OPENING CLEAR SPAN	90 (4")	140 (6")	190 (8")	240 (10")	290 (12")				
300mm to 350mm (12" to 12")	75mm X 8mm PL (75X8) PL	125mm X 8mm PL (125X8) PL	175mm X 8mm PL (175X8) PL	225mm X 8mm PL (225X8) PL	275mm X 8mm PL (275X8) PL				
350mm to 400mm (14" to 16")	118mm X 8mm PL (118X8) PL	168mm X 8mm PL (168X8) PL	218mm X 8mm PL (218X8) PL	268mm X 8mm PL (268X8) PL	318mm X 8mm PL (318X8) PL				
400mm to 450mm (16" to 18")	141mm X 8mm PL (141X8) PL	191mm X 8mm PL (191X8) PL	241mm X 8mm PL (241X8) PL	291mm X 8mm PL (291X8) PL	341mm X 8mm PL (341X8) PL				
450mm to 500mm (18" to 20")	164mm X 8mm PL (164X8) PL	214mm X 8mm PL (214X8) PL	264mm X 8mm PL (264X8) PL	314mm X 8mm PL (314X8) PL	364mm X 8mm PL (364X8) PL				
3300mm to 3350mm (132" to 134")	1475mm X 8mm PL (1475X8) PL	1525mm X 8mm PL (1525X8) PL	1575mm X 8mm PL (1575X8) PL	1625mm X 8mm PL (1625X8) PL	1675mm X 8mm PL (1675X8) PL				
3350mm to 3400mm (134" to 136									

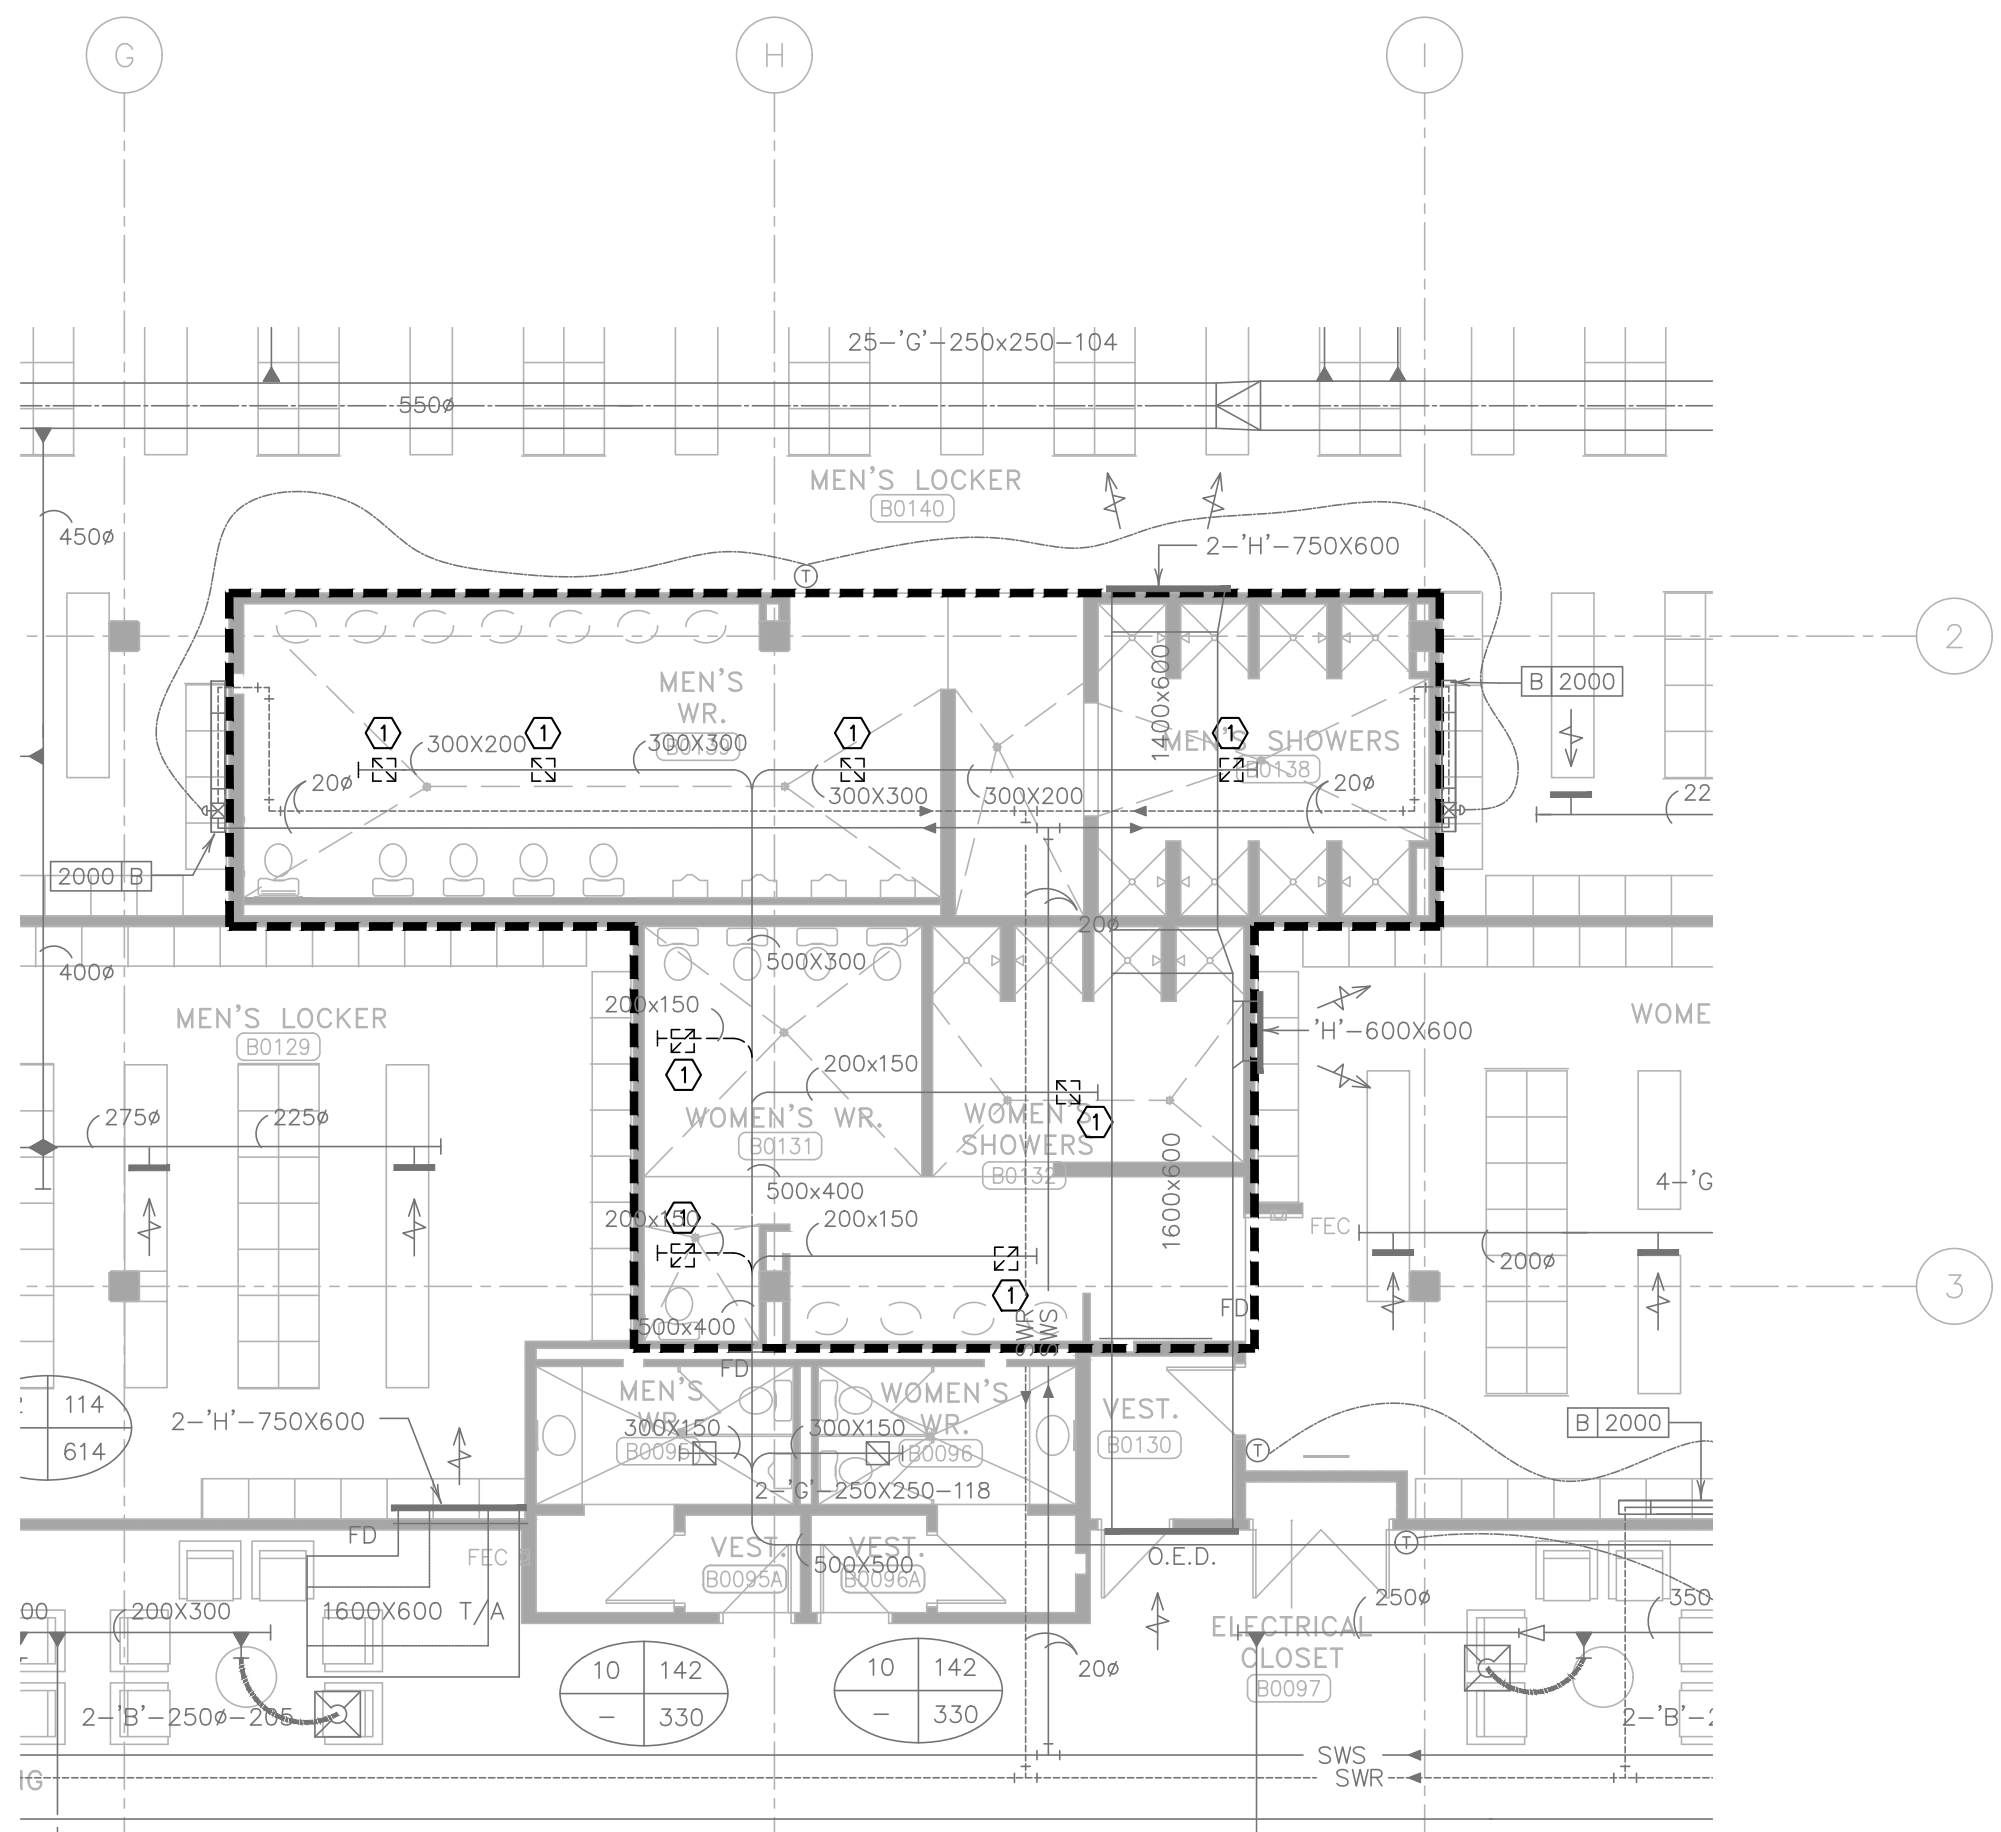


1 PARTIAL BASEMENT HVAC PLAN - DEMO
SCALE 1:100

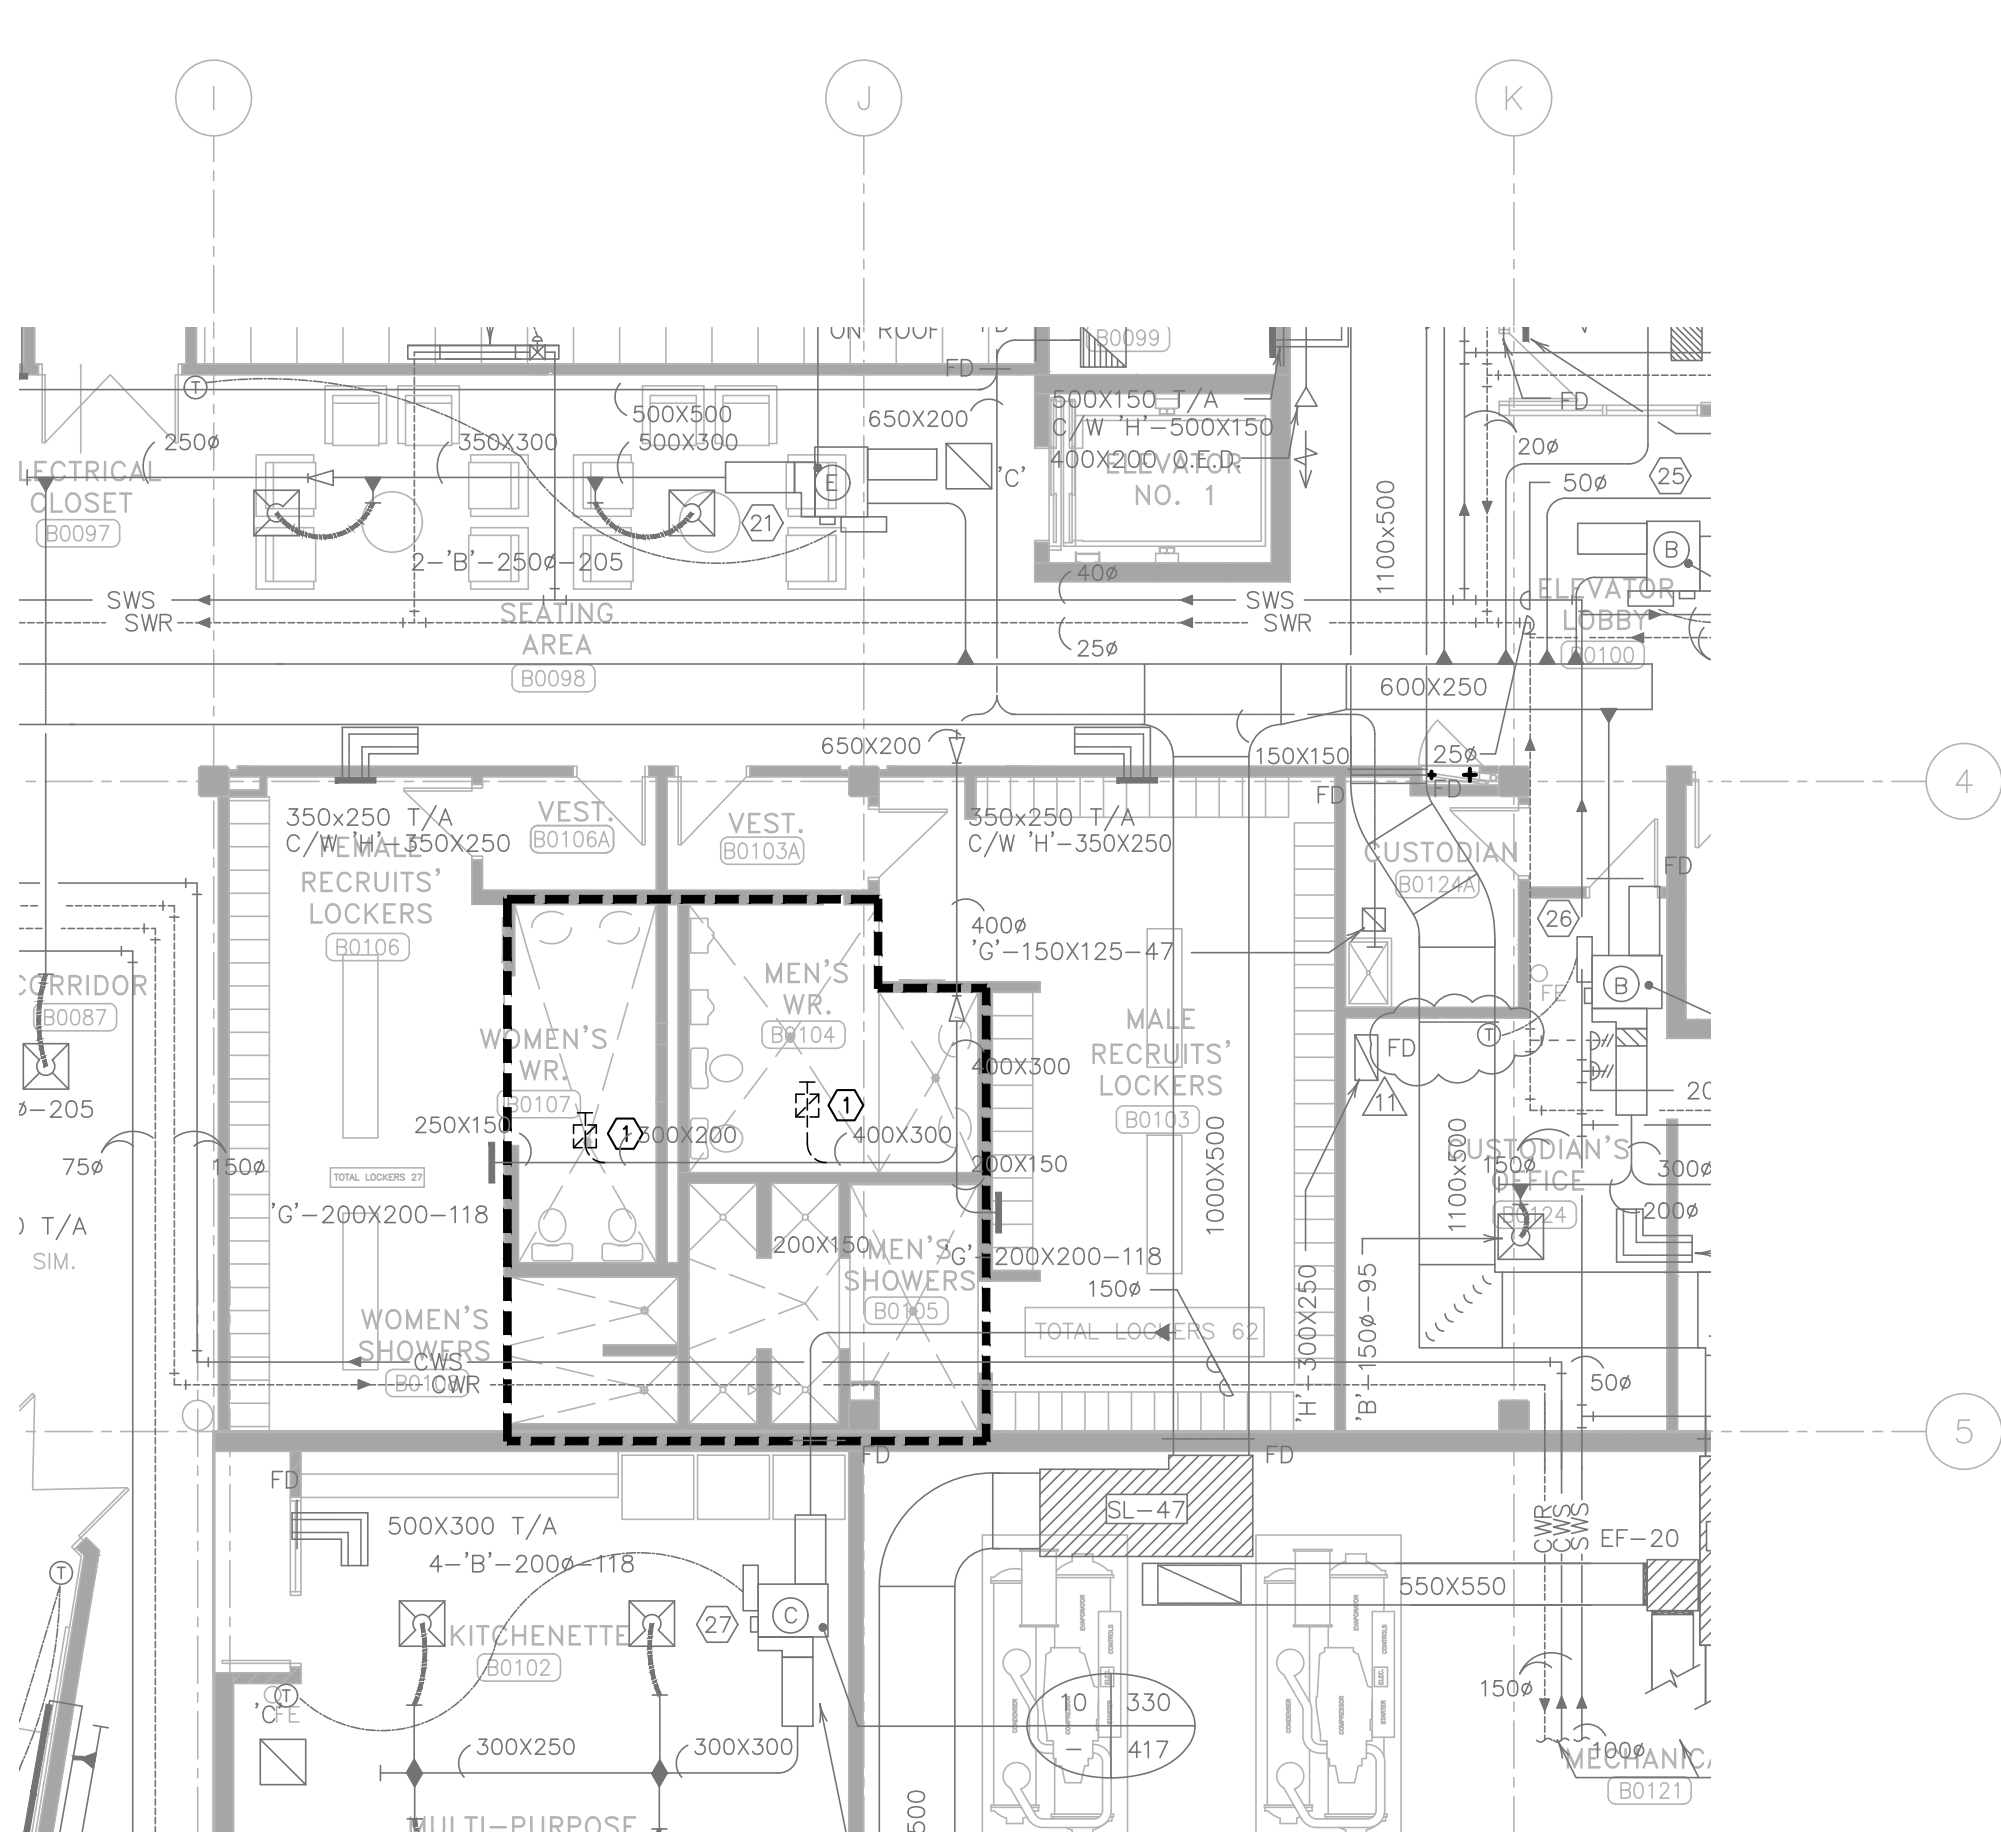

2 PARTIAL BASEMENT HVAC PLAN - DEMO
SCALE 1:100

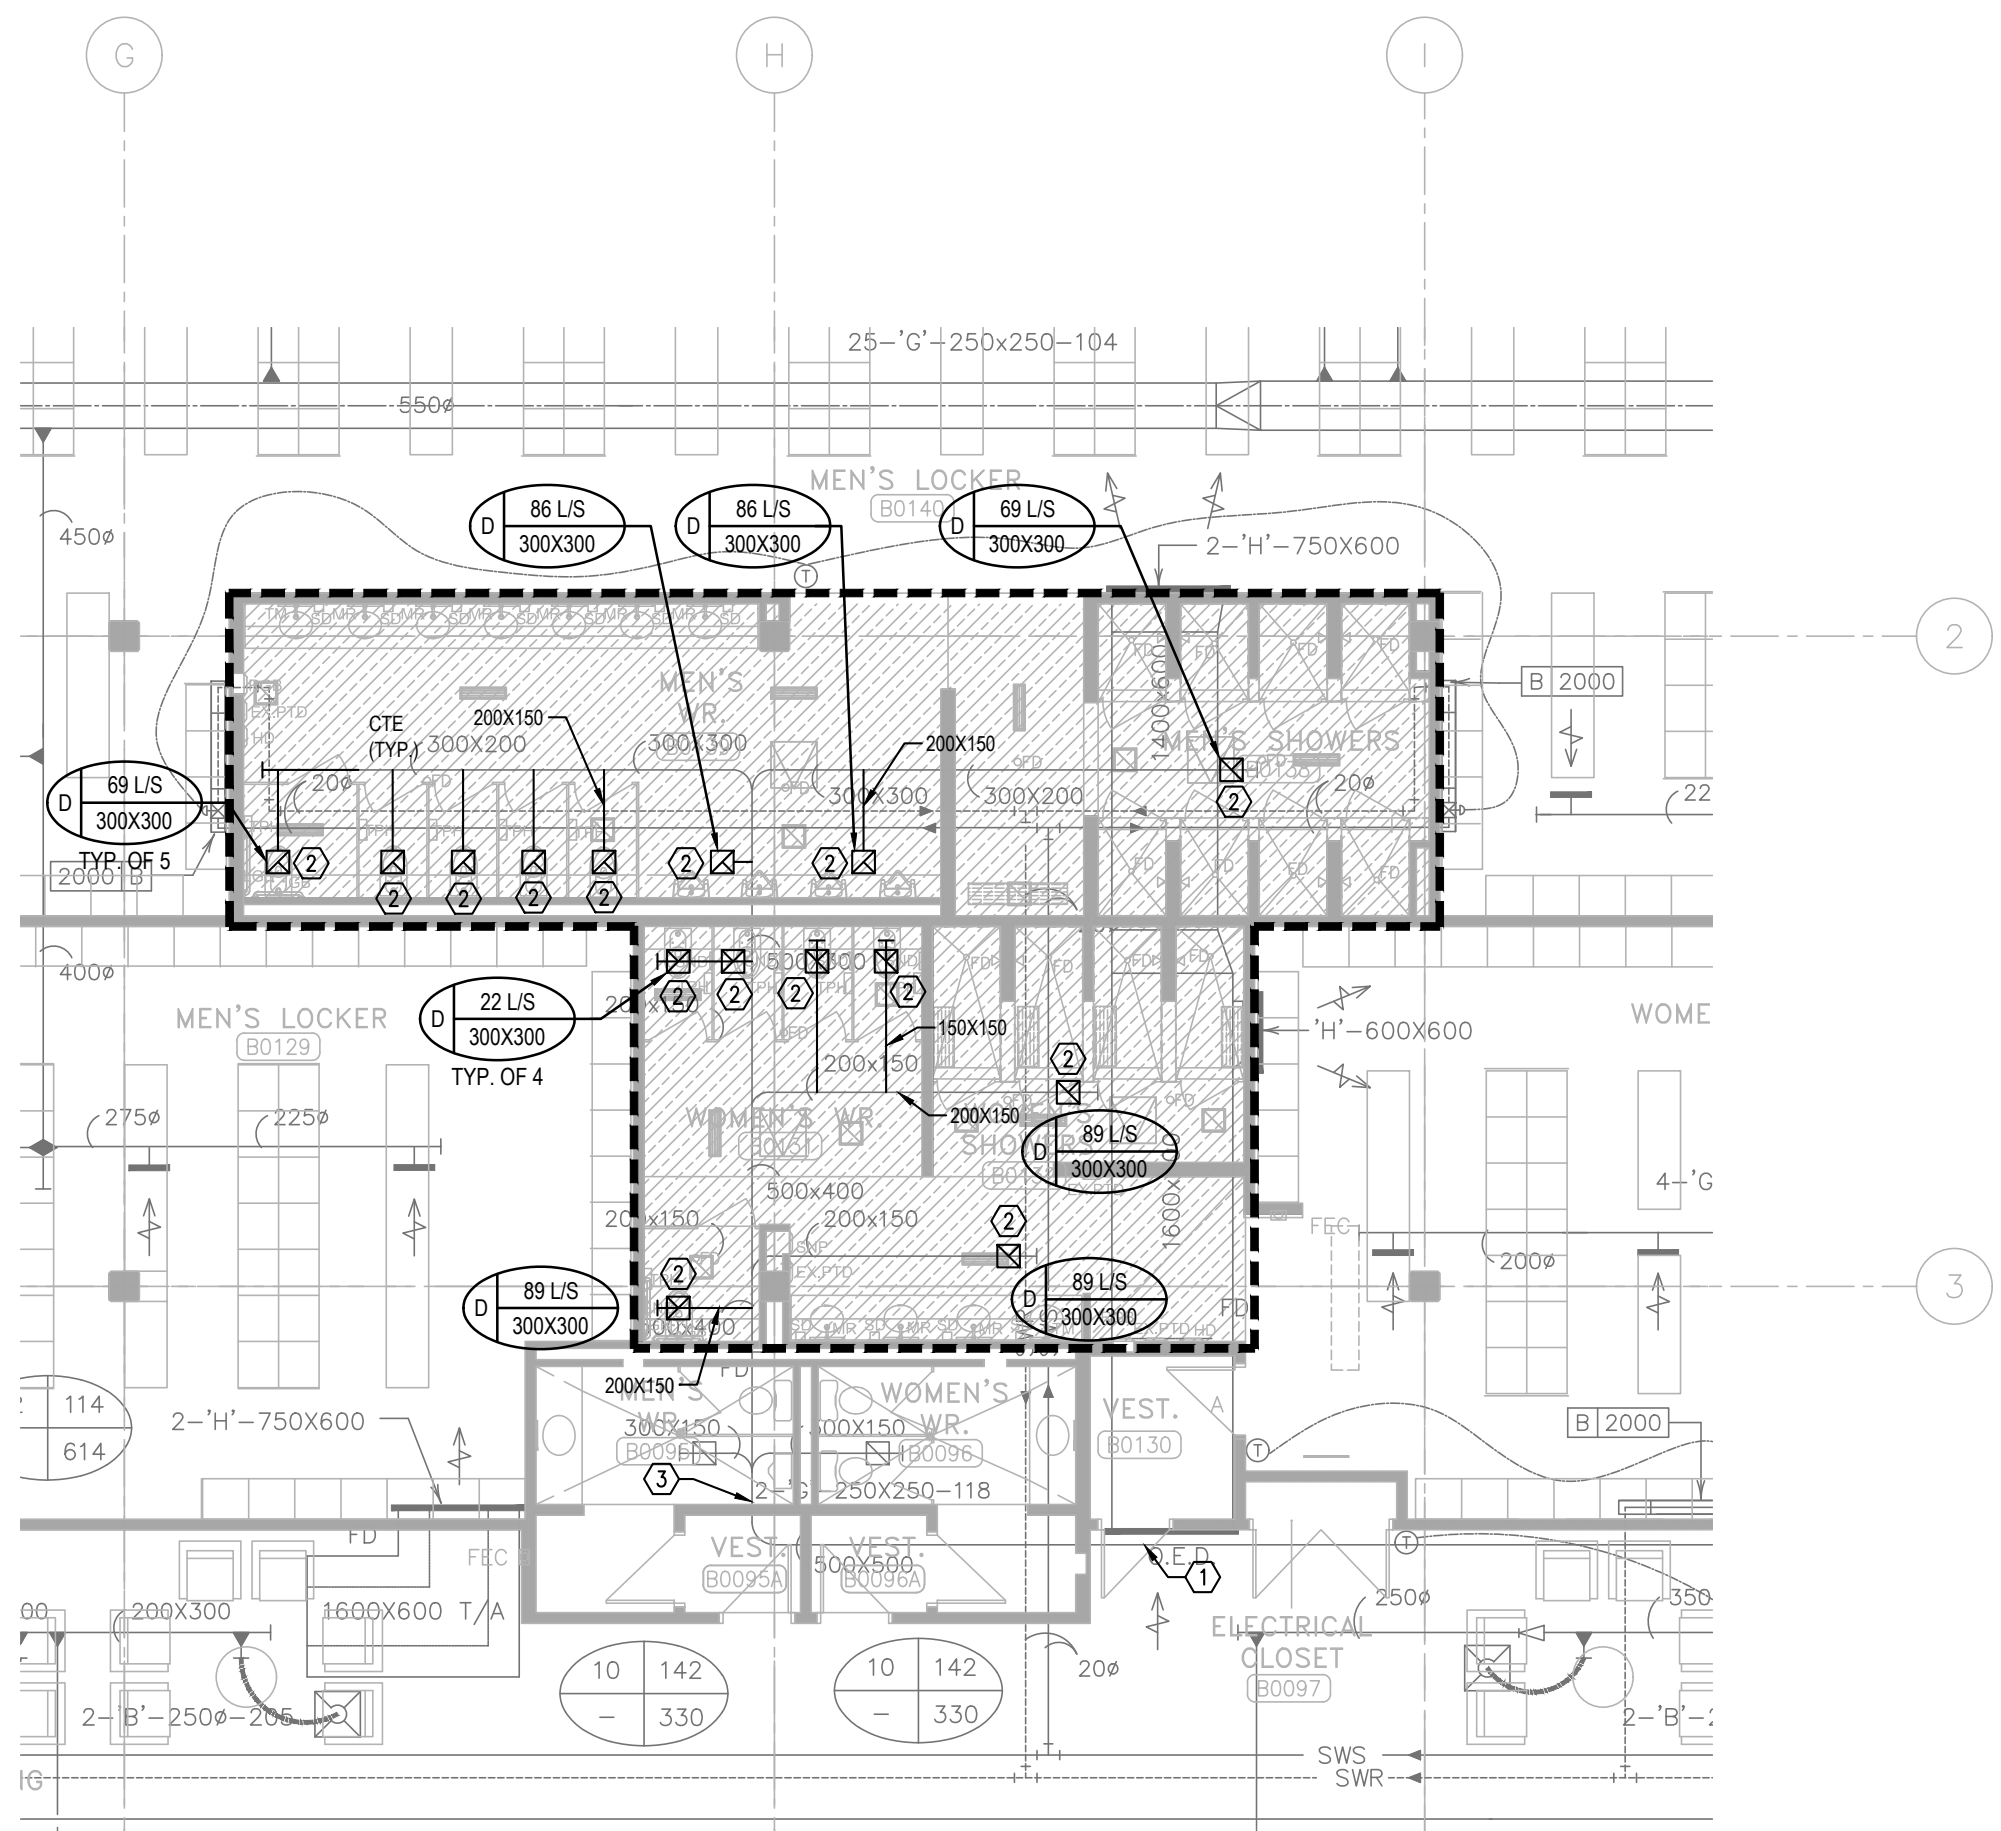

3 PARTIAL BASEMENT HVAC PLAN - NEW
SCALE 1:100

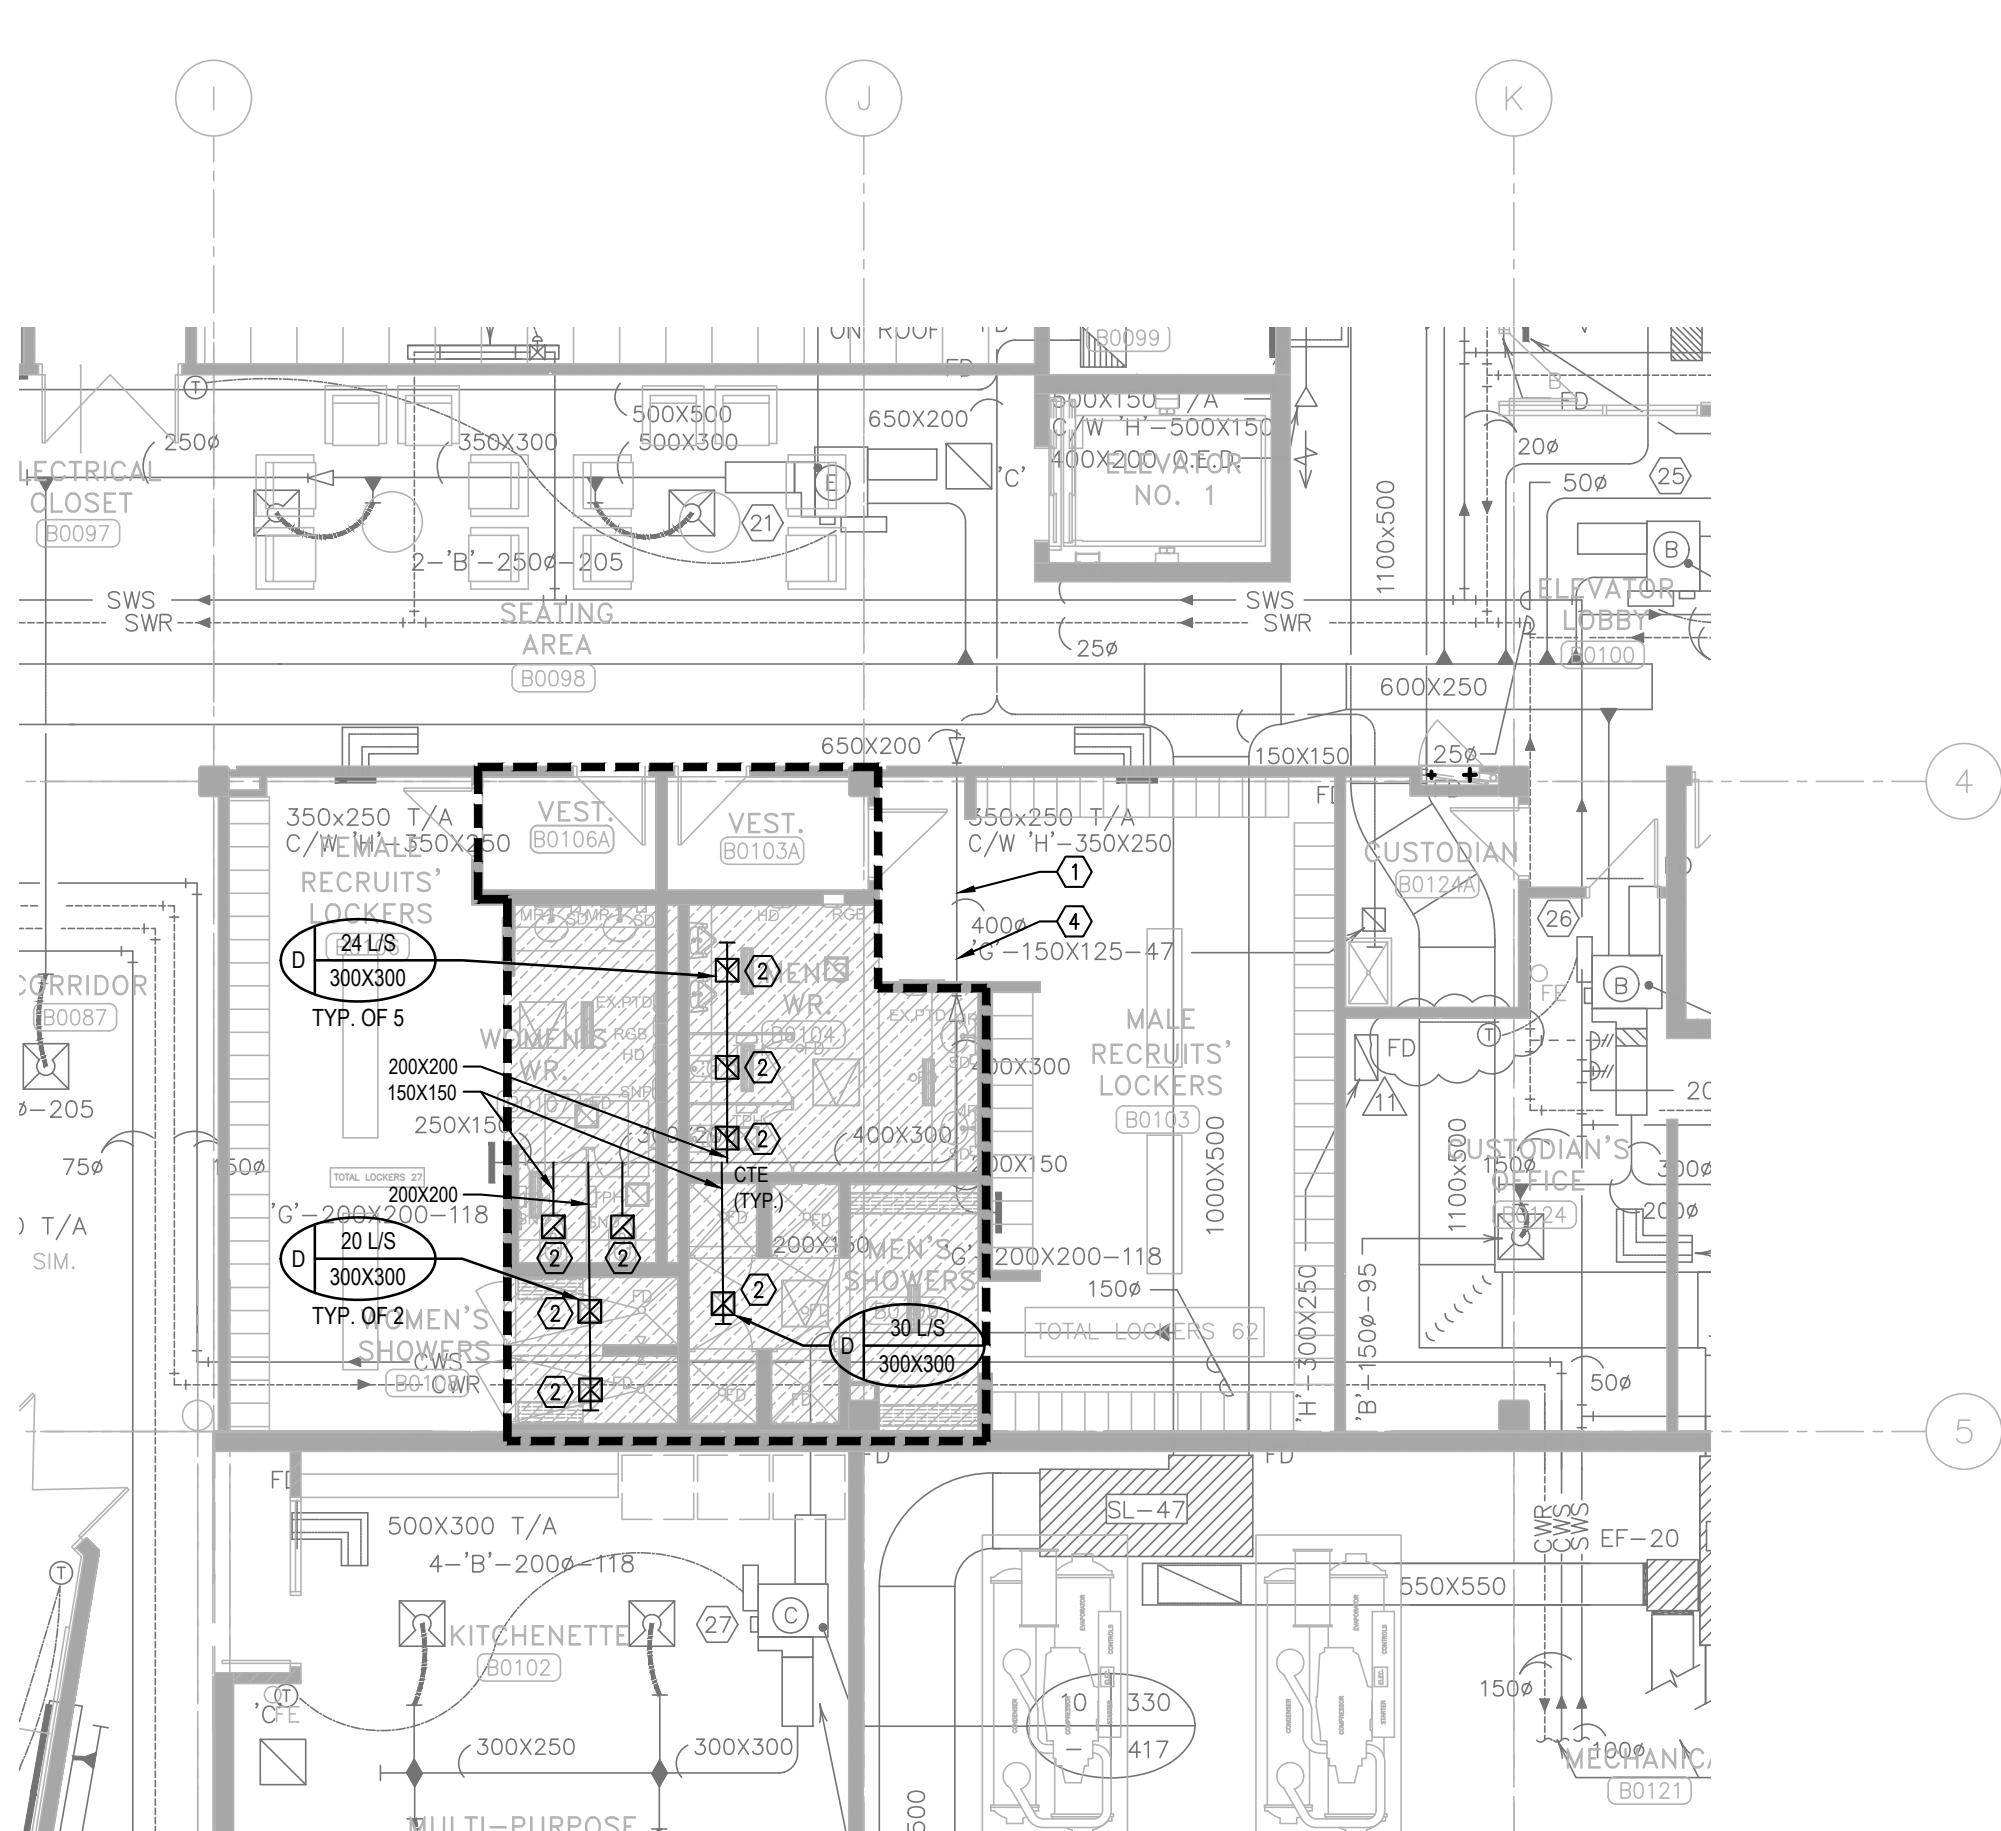

4 PARTIAL BASEMENT HVAC PLAN - NEW
SCALE 1:100

- HVAC GENERAL DEMO NOTES:**
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 - ALL NEW SERVICES SHOWN ARE DIAGRAMMATIC ONLY. THE ARRANGEMENTS OF EQUIPMENT SHOWN ARE APPROXIMATE AND MAY BE ALTERED ON SITE TO MEET THE ON-SITE CONDITIONS OF THE PROJECT. CONTRACTOR TO REVIEW ALL THE EXISTING SERVICES AND COORDINATE WITH THE NEW INSTALLATION.
 - CONTRACTOR TO COORDINATE WITH THE BUILDING MANAGEMENT FOR APPROVAL OF ANY SHUT DOWN OF EXISTING SYSTEMS SERVICES. THE CONTRACTOR SHALL DETERMINE THE BEST METHOD TO MINIMIZE SERVICE INTERRUPTION AND IMPACT ON FACILITY OPERATION, INCLUDING USE OF HOT TAP/TEMPORARY FREEZING AND AFTER-HOUR WORK AS REQUIRED. PROVIDE MIN. ONE WEEK NOTICE FOR BUILDING MANAGEMENT TO PLAN THE SHUT DOWN. CONTRACTOR TO ENSURE MIN. SHUTDOWNS.
 - CONTRACTOR TO REROUTE ANY EXISTING SERVICES IF REQUIRED TO INSTALL NEW SERVICES. ALL SERVICES SHALL BE INSTALLED USING EXISTING BEAM OPENINGS AS MUCH AS POSSIBLE. IN THE EVENT OF NO SPACE THROUGH BEAM OPENING, SERVICES SHALL BE INSTALLED AS HIGH AS POSSIBLE TO THE UNDERSIDE OF THE BEAM. COORDINATE ALL SERVICES PRIOR TO INSTALLATION. THE LOWER SERVICES INSTALLED WILL BE ASKED TO RELOCATE IF SPACE AVAILABLE AT HIGH LEVEL.
 - COORDINATE WITH ALL CONSULTANT DRAWINGS BEFORE ORDERING ANY NEW EQUIPMENT, GRILLES & DIFFUSERS, SPRINKLER HEADS ETC.
 - CONTRACTOR TO INCLUDE FOR ALL OFFSETS REQUIRED FOR COORDINATION WITHIN MECHANICAL AND ELECTRICAL SERVICES. THE OFFSETTING INCLUDES ALL HVAC, HYDRONICS, PLUMBING AND FIRE PROTECTION SERVICES.
 - THE DRAWINGS AND SPECIFICATIONS ARE PROVIDING THE MINIMUM PERFORMANCE REQUIREMENTS. THE FIRE PROTECTION SYSTEM SHALL BE PREPARED, COMPLETE, STAMPED, SIGNED, AND APPROVED BY A LICENSED SPRINKLER CONTRACTOR. IT IS THE CONTRACTOR'S RESPONSIBILITY FOR THE FLOW TEST INFORMATION PRIOR TO PREPARATION OF DRAWINGS AND HYDRAULIC CALCULATIONS.
 - CONTRACTOR TO PROVIDE FIRE WATCH AS REQUIRED TO MAINTAIN FIRE SAFETY OF THE CONSTRUCTION SITE SCOPE AREA.
 - THE CONTRACTOR SHALL PROVIDE FIRE STOPPING ON ALL NEW PIPING AND CONDUIT PENETRATIONS THROUGH A FIRE-RATED WALL OR FLOOR AND ANY HOLES THAT RESULT FROM REMOVAL OF EXISTING SERVICES THROUGH A FIRE-RATED WALL OR FLOOR.
 - READ ALL THE DRAWINGS FOR COMPLETE INFORMATION.
 - INCLUDE FOR FREEZING OF ALL SERVICES WITH THE ASSUMPTION THAT NO VALVES WILL HOLD AND REPLACE ALL WITH NEW LEVER BALL VALVES (OR SCREW TYPE ONLY WHERE APPROPRIATE)
 - THE EXISTING SERVICES SHOWN ON THIS DRAWING HAVE BEEN TAKEN FROM THE ORIGINAL CONSTRUCTION DRAWINGS AND SITE SURVEYS. THE MECHANICAL SHALL CARRY OUT A FULL SURVEY OF ALL EXISTING SERVICES TO CONFIRM THE SIZE AND LOCATION OF THESE SERVICES BEFORE THE COMMENCEMENT OF ANY WORK.
 - ALL EXISTING SERVICES ARE TO REMAIN AS IS UNLESS NOTED ON THE LAYOUT TO BE REMOVED, RELOCATED AND OR MODIFIED.
 - ALL EXISTING NEW HVAC DUCTWORK PENETRATION THROUGH ETC RATED WALL ASSEMBLIES SHALL FOLLOW INSTALLATION DETAIL IDENTIFIED IN BMS01. REFER TO ARCHITECTURAL DRAWINGS FOR RATED WALL ASSEMBLIES WITH ETC REQUIREMENTS. (TYP)

- HVAC DEMO DRAWING NOTES:**
- ① DIFFUSER/GRILLE TO BE DEMOLISHED. CAP DUCTWORK BACK TO MAIN, AS SHOWN.
 - ② RESERVED

- HVAC GENERAL NEW NOTES:**
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 - CONTRACTOR TO REROUTE ANY EXISTING SERVICES IF REQUIRED TO INSTALL NEW SERVICES. ALL SERVICES SHALL BE INSTALLED USING EXISTING BEAM OPENINGS AS MUCH AS POSSIBLE. IN THE EVENT OF NO SPACE THROUGH BEAM OPENING, SERVICES SHALL BE INSTALLED AS HIGH AS POSSIBLE TO THE UNDERSIDE OF THE BEAM. COORDINATE ALL SERVICES PRIOR TO INSTALLATION. THE LOWER SERVICES INSTALLED WILL BE ASKED TO RELOCATE IF SPACE AVAILABLE AT HIGH LEVEL.
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 - CONTRACTOR TO PROVIDE FIRE WATCH AS REQUIRED TO MAINTAIN FIRE SAFETY OF THE CONSTRUCTION SITE SCOPE AREA. COORDINATE WITH GC AS REQUIRED.
 - THE CONTRACTOR SHALL PROVIDE FIRE STOPPING ON ALL NEW PIPING AND CONDUIT PENETRATIONS THROUGH A FIRE-RATED WALL OR FLOOR AND ANY HOLES THAT RESULT FROM REMOVAL OF EXISTING SERVICES THROUGH A FIRE-RATED WALL OR FLOOR. REFER TO ARCHITECTURAL PLANS FOR FIRE SEPARATION DRAWINGS.
 - READ ALL THE DRAWINGS FOR COMPLETE INFORMATION.
 - INCLUDE FOR FREEZING OF ALL SERVICES WITH THE ASSUMPTION THAT NO VALVES WILL HOLD AND REPLACE ALL WITH NEW LEVER BALL VALVES (OR SCREW TYPE ONLY WHERE APPROPRIATE)
 - THE EXISTING SERVICES SHOWN ON THIS DRAWING HAVE BEEN TAKEN FROM THE ORIGINAL CONSTRUCTION DRAWINGS AND SITE SURVEYS. THE MECHANICAL CONTRACTOR SHALL CARRY OUT A FULL SURVEY OF ALL EXISTING SERVICES TO CONFIRM THE SIZE AND LOCATION OF THESE SERVICES BEFORE THE COMMENCEMENT OF ANY WORK.
 - ALL EXISTING SERVICES ARE TO REMAIN AS IS UNLESS NOTED ON THE LAYOUT TO BE REMOVED, RELOCATED AND OR MODIFIED.

- HVAC NEW DRAWING NOTES:**
- ① EXISTING EA DUCT TO EF-1 ON THE ROOF
 - ② PROVIDE NEW DIFFUSER/GRILLE. CONNECT TO EXISTING MAIN DUCTWORK AS SHOWN. PROVIDE BALANCING DAMPER AT EACH BRANCH DUCT SERVING NEW DIFFUSER/GRILLE. BALANCE AIRFLOW TO EACH DIFFUSER/GRILLE IN US AS INDICATED ON PLAN. REFER TO DIFFUSERS & GRILLES SCHEDULE ON MECHANICAL SCHEDULE DRAWING.
 - ③ EXISTING 600X600 EA DUCT TO REMAIN
 - ④ EXISTING 400X300 EA DUCT TO REMAIN

REVISIONS	
NO.	DESCRIPTION
6	ISSUED FOR TENDER
4	ISSUED FOR BUILDING PERMIT
3	ISSUED FOR 100% CLIENT REVIEW
2	ISSUED FOR 60% CLIENT REVIEW
1	ISSUED FOR COSTING REVIEW

NO.	DESCRIPTION	DATE
6	ISSUED FOR TENDER	2026.05.01
4	ISSUED FOR BUILDING PERMIT	2026.04.08
3	ISSUED FOR 100% CLIENT REVIEW	2026.03.31
2	ISSUED FOR 60% CLIENT REVIEW	2026.01.09
1	ISSUED FOR COSTING REVIEW	2025.11.24

PROJECT

PEEL REGIONAL POLICE

REGION OF PEEL

EMIL V. KOLB CENTRE
PEEL REGIONAL POLICE FACILITY
INTERIOR RENOVATION PROJECT
180 RORY ROAD EAST, MISSISSAUGA, ON L5T 2Y5

STRUCTURAL CONSULTANT
Stephenson Engineering


MECHANICAL CONSULTANT
EXP Services Inc.

ELECTRICAL CONSULTANT
EXP Services Inc.


SHEET TITLE
PARTIAL BASEMENT FLOOR
- HVAC DEMO & NEW

SHEET NO.	DRAWN BY	CHECKED BY
M201	MBL	ME

PROJECT NO.	SCALE
MRK-25008951-A0	

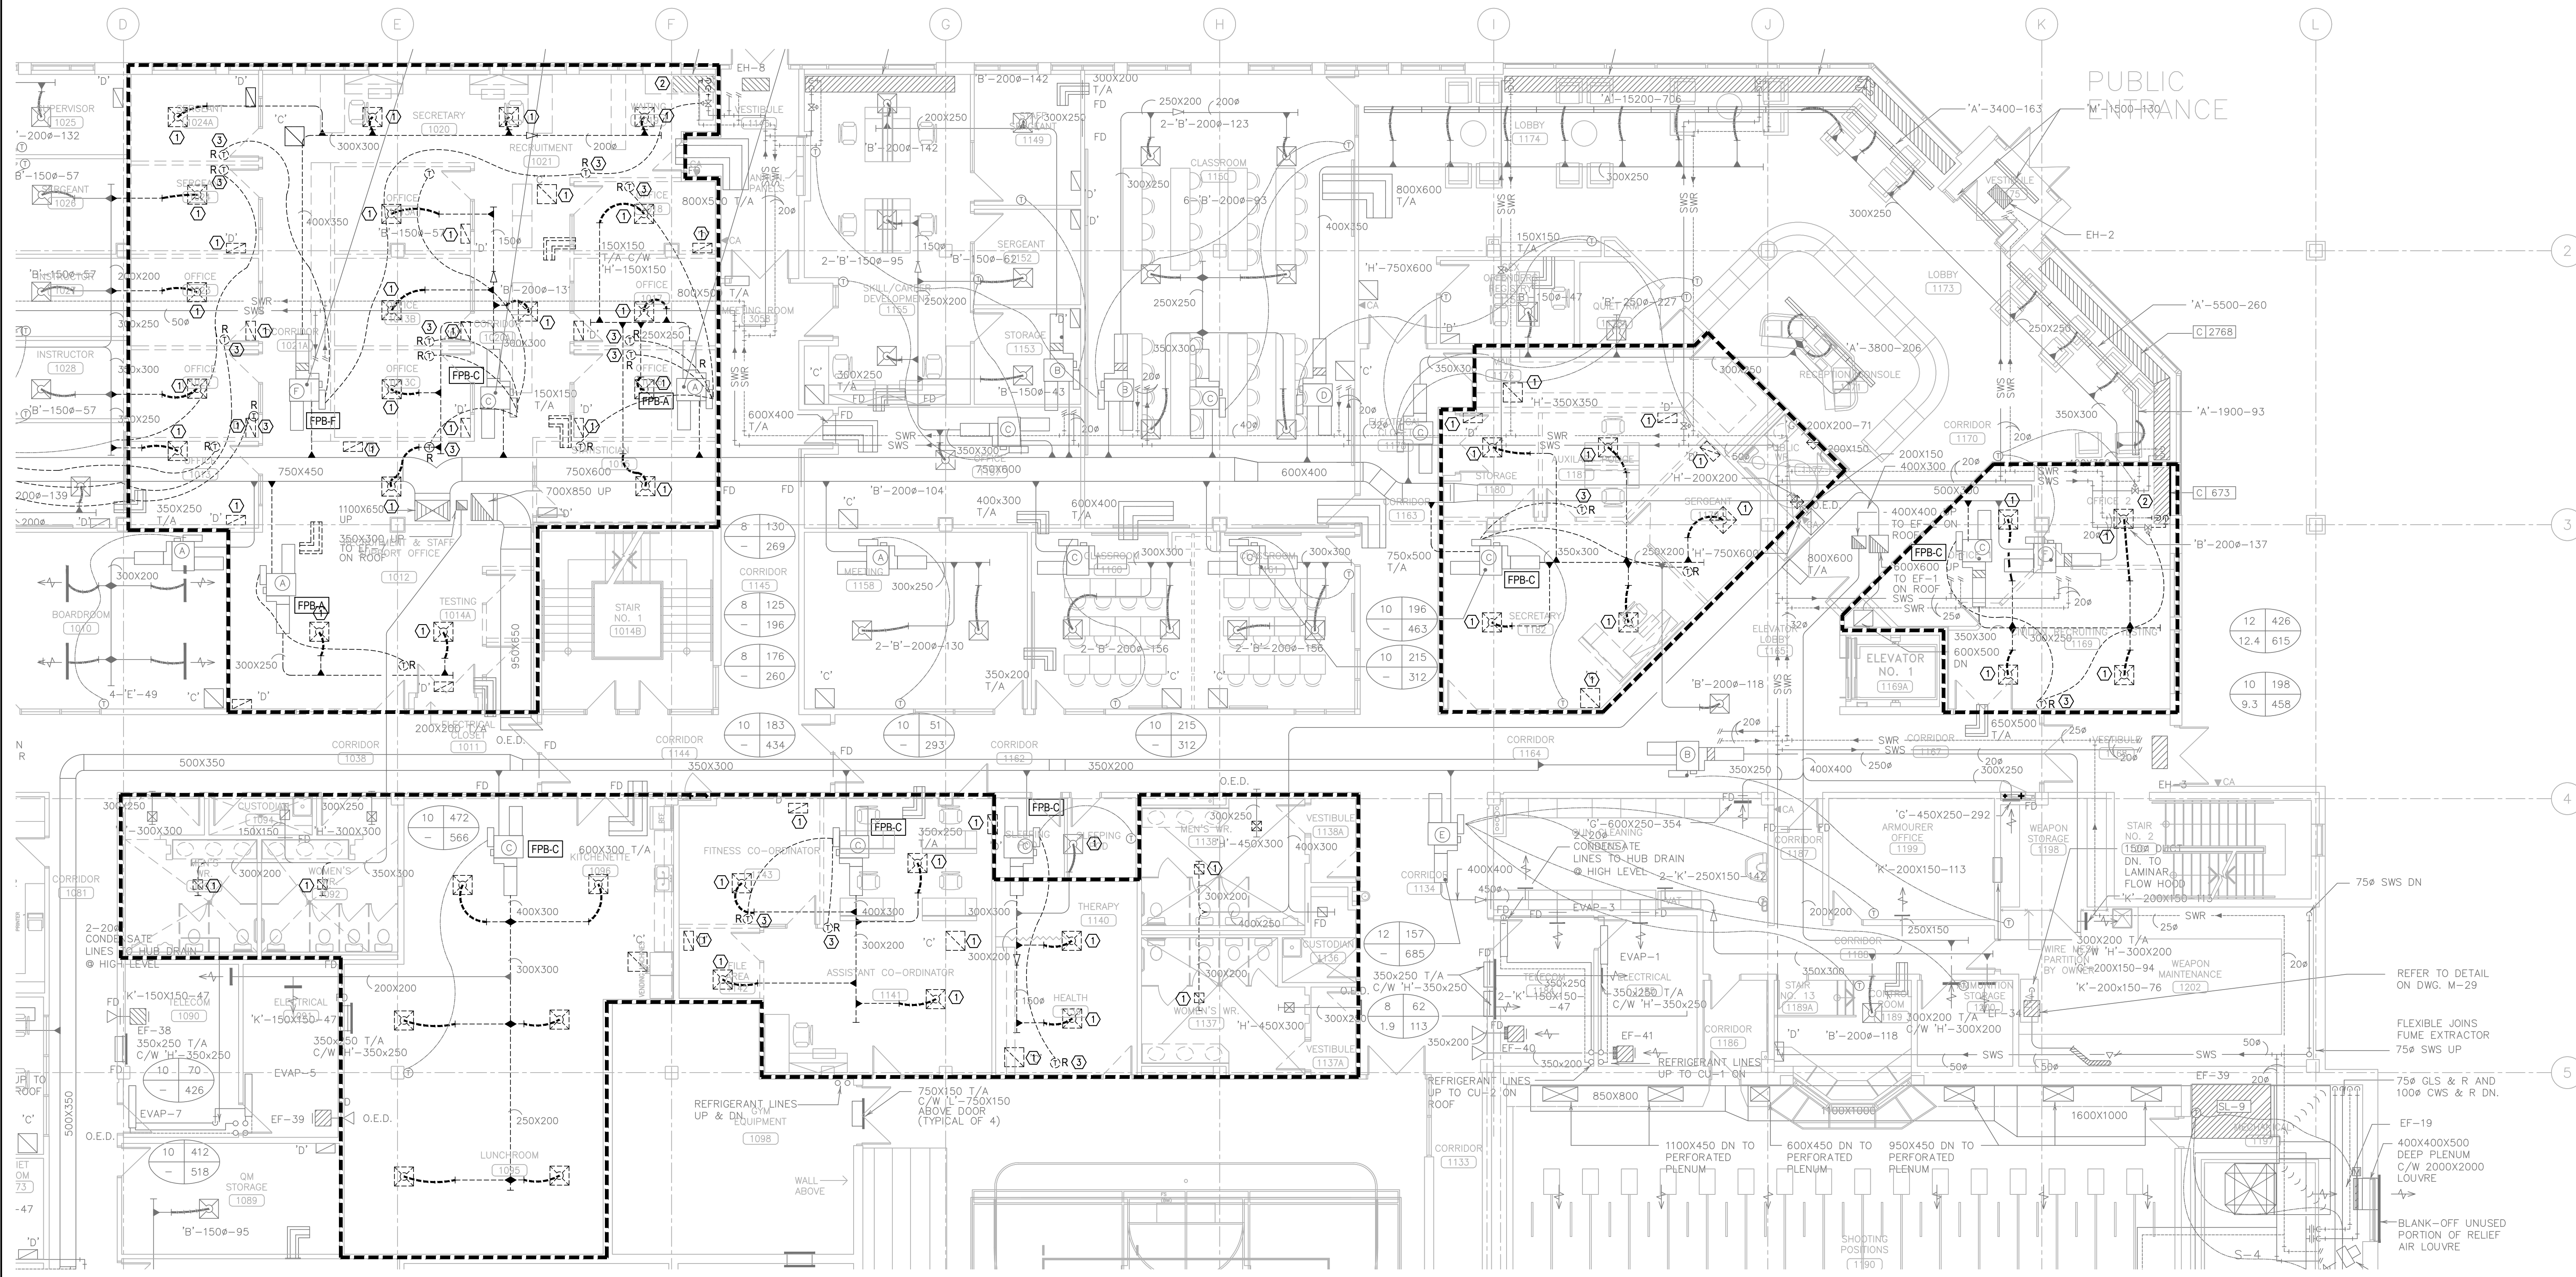

1 PARTIAL GROUND FLOOR HVAC PLAN - DEMO
SCALE: 1/8" = 1'-0"

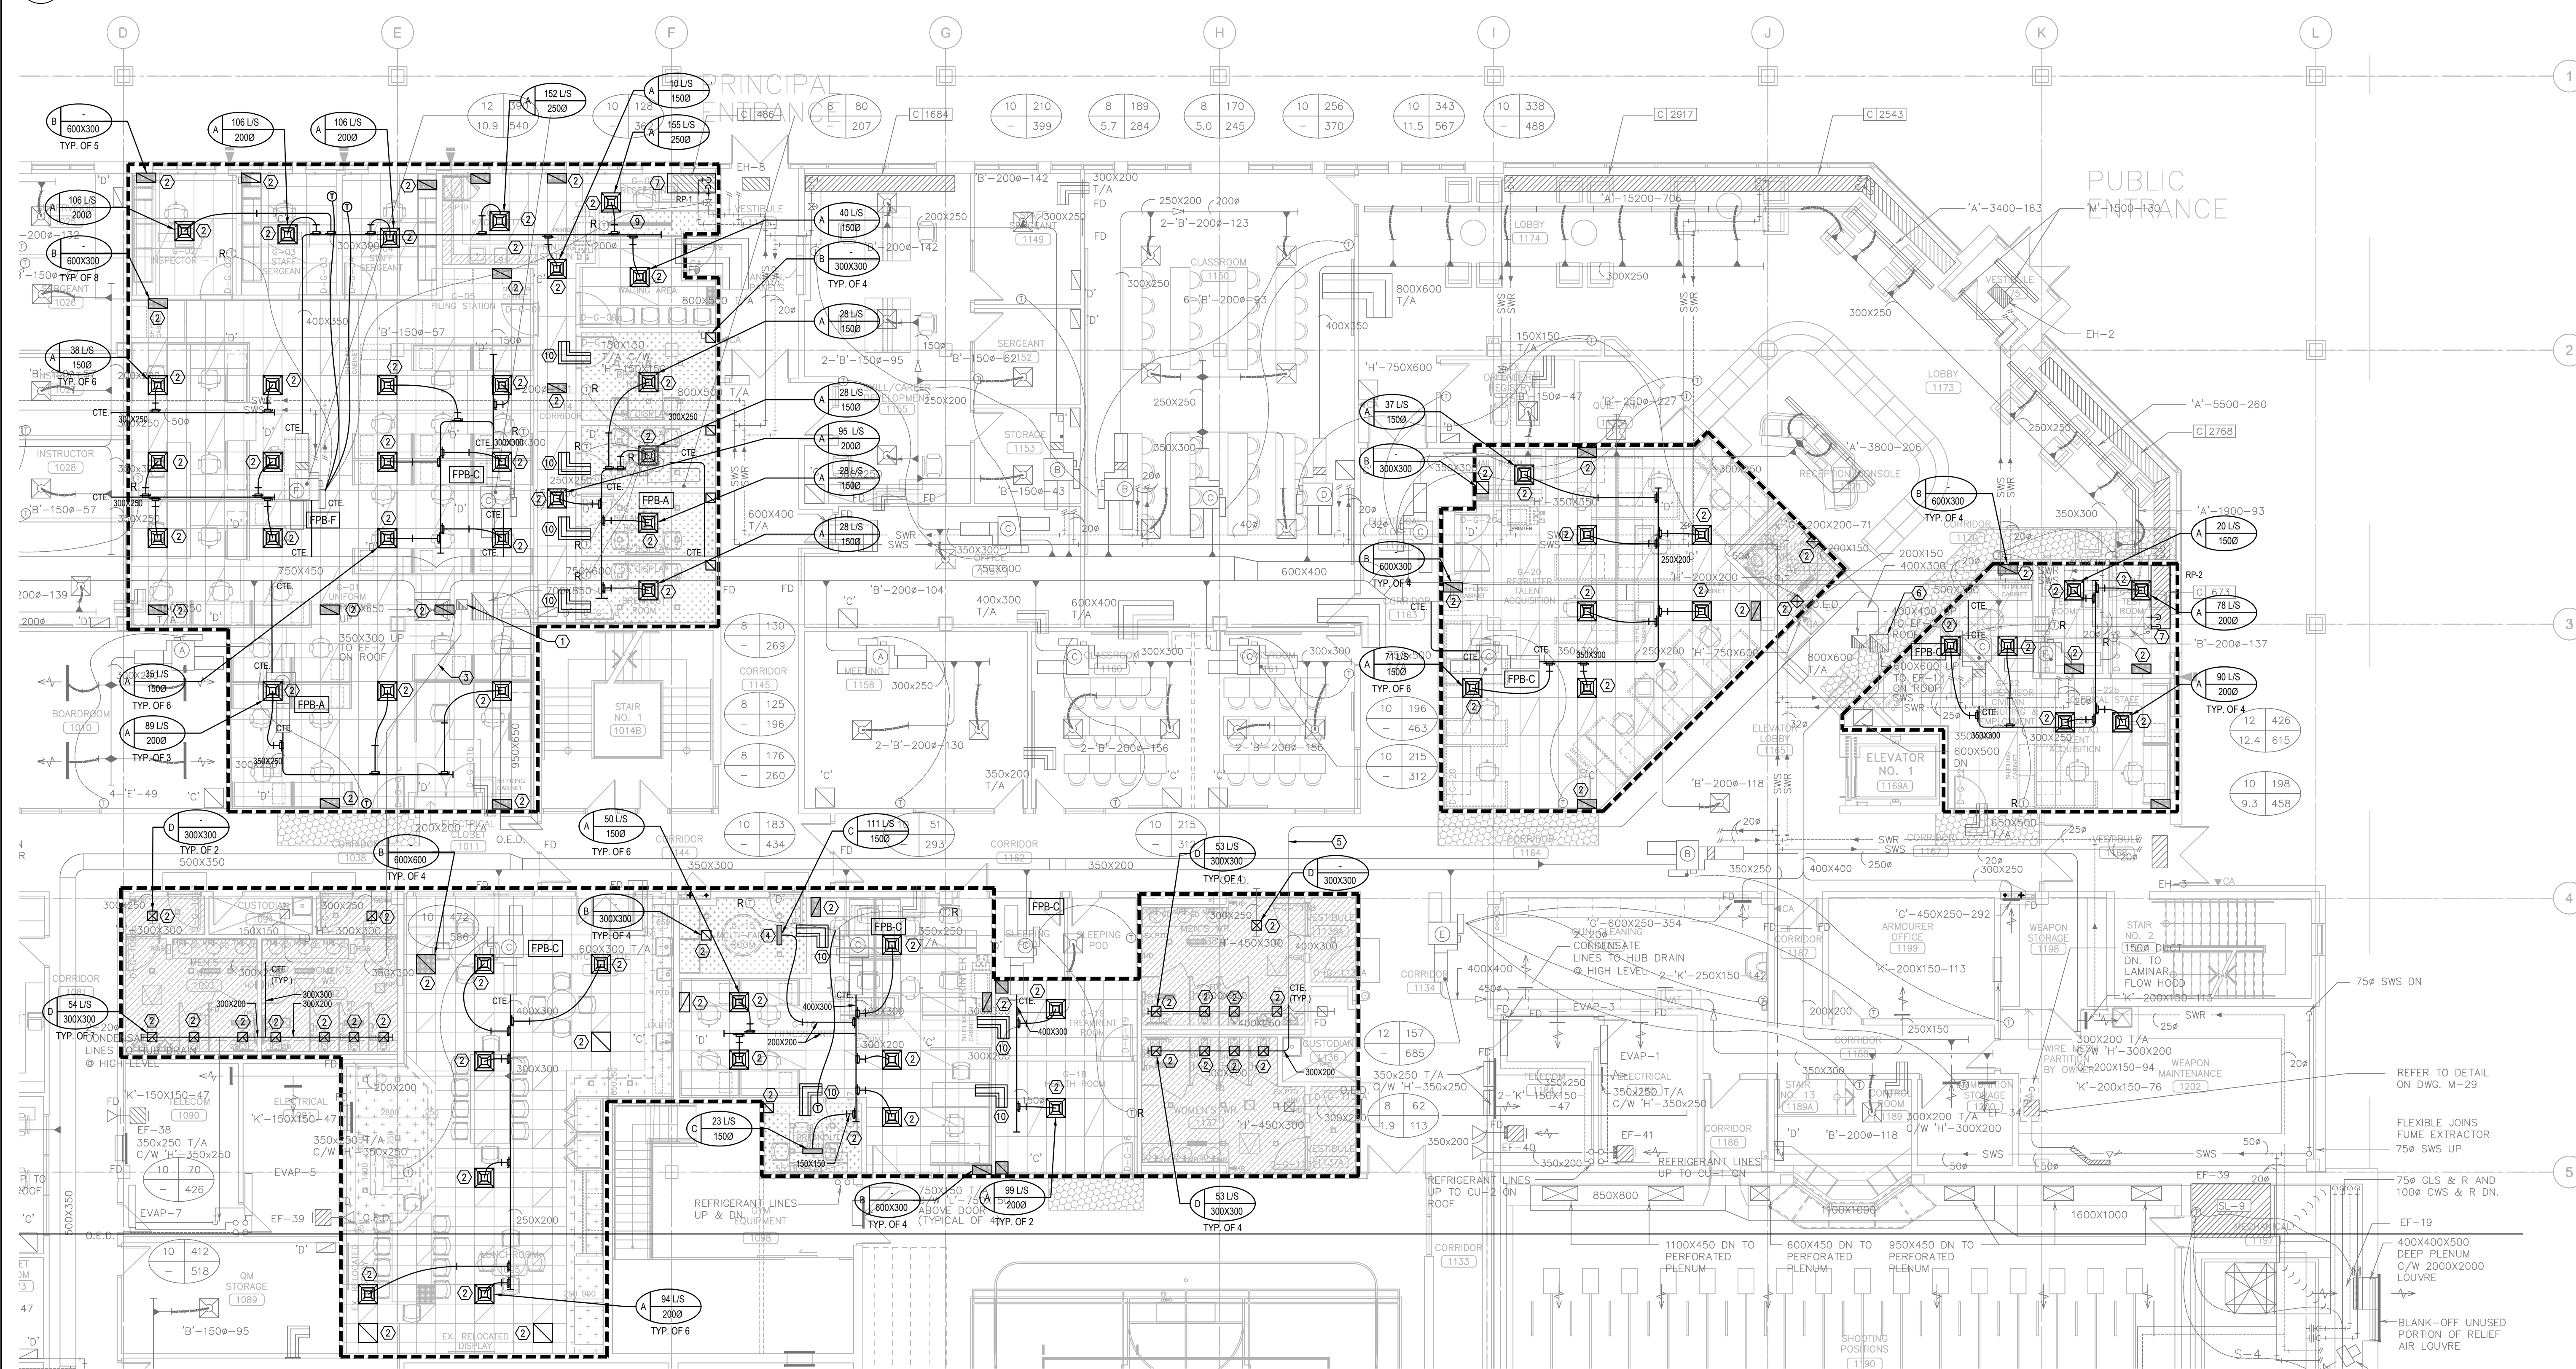

2 PARTIAL GROUND FLOOR HVAC PLAN - NEW
SCALE: 1/8" = 1'-0"

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- HVAC DEMO DRAWING NOTES:**
- DIFFUSER/GRILLE TO BE DEMOLISHED. CAP DUCTWORK BACK TO MAIN, AS SHOWN.
 - RADIANT PANEL TO BE DEMOLISHED. CAP HVAC BRANCH PIPING AS SHOWN.
 - EXISTING THERMOSTAT TO BE REMOVED IN ITS ENTIRETY INCLUDING ALL CONTROL WIRING. THERMOSTAT TO BE RETAINED AND PROPERLY STORED FOR FUTURE USE IN THE RELOCATED AREA AS SHOWN ON THE NEW WORK PLAN.

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 - CONTRACTOR TO INCLUDE FOR ALL OFFSETS REQUIRED FOR COORDINATION WITHIN MECHANICAL AND ELECTRICAL SERVICES. THE OFFSETTING INCLUDES ALL HVAC, HYDRONICS, PLUMBING AND FIRE PROTECTION SERVICES.
 - THE DRAWINGS AND SPECIFICATIONS ARE PROVIDING THE MINIMUM PERFORMANCE REQUIREMENTS. THE FIRE PROTECTION SYSTEM SHALL BE PREPARED, COMPLETE, STAMPED, SIGNED, AND APPROVED BY A LICENSED SPRINKLER CONTRACTOR. IT IS THE CONTRACTORS RESPONSIBILITY FOR THE FLOW TEST INFORMATION PRIOR TO PREPARATION OF DRAWINGS AND HYDRAULIC CALCULATIONS.
 - CONTRACTOR TO PROVIDE FIRE WATCH AS REQUIRED TO MAINTAIN FIRE SAFETY OF THE CONSTRUCTION SITE SCOPE AREA.
 - THE CONTRACTOR SHALL PROVIDE FIRE STOPPING ON ALL NEW PIPING AND CONDUIT PENETRATIONS THROUGH A FIRE-RATED WALL OR FLOOR AND ANY HOLES THAT RESULT FROM REMOVAL OF EXISTING SERVICES THROUGH A FIRE-RATED WALL OR FLOOR.
 - READ ALL THE DRAWINGS FOR COMPLETE INFORMATION.
 - INCLUDE FOR FREEZING OF ALL SERVICES WITH THE ASSUMPTION THAT NO VALVES WILL HOLD AND REPLACE ALL WITH NEW LEVER BALL VALVES (OR SCREW TYPE ONLY WHERE APPROPRIATE).
 - THE EXISTING SERVICES SHOWN ON THIS DRAWING HAVE BEEN TAKEN FROM THE ORIGINAL CONSTRUCTION DRAWINGS AND SITE SURVEYS. THE MECHANICAL CONTRACTOR SHALL CARRY OUT A FULL SURVEY OF ALL EXISTING SERVICES TO CONFIRM THE SIZE AND LOCATION OF THESE SERVICES BEFORE THE COMMENCEMENT OF ANY WORK.
 - ALL EXISTING SERVICES ARE TO REMAIN AS IS UNLESS NOTED ON THE LAYOUT TO BE REMOVED, RELOCATED AND OR MODIFIED.
 - ALL EXISTING & NEW HVAC DUCTWORK PENETRATION THROUGH STC RATED WALL ASSEMBLIES SHALL FOLLOW INSTALLATION DETAIL IDENTIFIED IN 3MS01. REFER TO ARCHITECTURAL DRAWINGS FOR RATED WALL ASSEMBLIES WITH STC REQUIREMENTS. (TYP.)

- HVAC NEW DRAWING NOTES:**
- EXISTING EA DUCT TO EF-7 ON THE ROOF TO REMAIN.
 - PROVIDE NEW DIFFUSER/GRILLE. CONNECT TO EXISTING MAIN DUCTWORK AS SHOWN. PROVIDE BALANCING DAMPER AT EACH BRANCH DUCT SERVING NEW DIFFUSER/GRILLE. BALANCE AIRFLOW TO EACH DIFFUSER/GRILLE IN L/S AS INDICATED ON PLAN. REFER TO DIFFUSERS & GRILLES SCHEDULE ON MECHANICAL SCHEDULE DRAWING.
 - EXISTING 360X300 EA DUCT TO REMAIN.
 - PROVIDE NEW LINEAR SLOT DIFFUSER. CONNECT TO EXISTING MAIN DUCTWORK AS SHOWN. PROVIDE BALANCING DAMPER AT EACH BRANCH DUCT SERVING NEW DIFFUSER. BALANCE AIRFLOW TO EACH DIFFUSER IN L/S AS INDICATED ON PLAN. REFER TO DIFFUSERS & GRILLES SCHEDULE ON MECHANICAL SCHEDULE.
 - EXISTING 400X300 EA DUCT TO REMAIN.
 - EA DUCT UP TO EF-1 ON ROOF TO REMAIN.
 - PROVIDE NEW RADIANT PANEL. CONNECT TO EXISTING 20MM HVAC PIPING AS SHOWN.
 - RETURN AIR GRILLE (TYP.)
 - EXISTING HYDRONIC HEATING WATER SUPPLY AND RETURN PIPING TO BE MODIFIED/ROUTED TO RUN ADJACENT OF THE PROPOSED STEEL POST AND BEAM. REFER TO STRUCTURAL DRAWINGS FOR DETAILS.
 - TRANSFER AIR DUCT AT WALL ABOVE CEILING C/W FIRE DAMPER (WHERE SHOWN). ALL TRANSFER AIR DUCT SHALL BE 350MM X 200MM LINED WITH 25MM ACOUSTIC INSULATION (TYP.).

6 ISSUED FOR TENDER 2026.05.01
4 ISSUED FOR BUILDING PERMIT 2026.04.08
3 ISSUED FOR 100% CLIENT REVIEW 2026.03.31
2 ISSUED FOR 66% CLIENT REVIEW 2026.01.09
1 ISSUED FOR COSTING REVIEW 2025.11.24

NO. DESCRIPTION DATE

REVISIONS

PROJECT

PEEL POLICE

REGION OF PEEL

EMIL V. KOLB CENTRE
PEEL REGIONAL POLICE FACILITY
INTERIOR RENOVATION PROJECT
180 DERRY ROAD EAST, MISSISSAUGA, ON L5T 2Y5

NCA
ARCHITECTS

STEPHENSON ENGINEERING
MECHANICAL CONSULTANT
EXP Services Inc.
ELECTRICAL CONSULTANT
EXP Services Inc.

SHEET TITLE
**PARTIAL GROUND FLOOR -
HVAC DEMO & NEW**



SHEET NO.
M202

DRAWN BY
H.BELL

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ME

PROJECT NO.
MRK-25008951-A0

SCALE

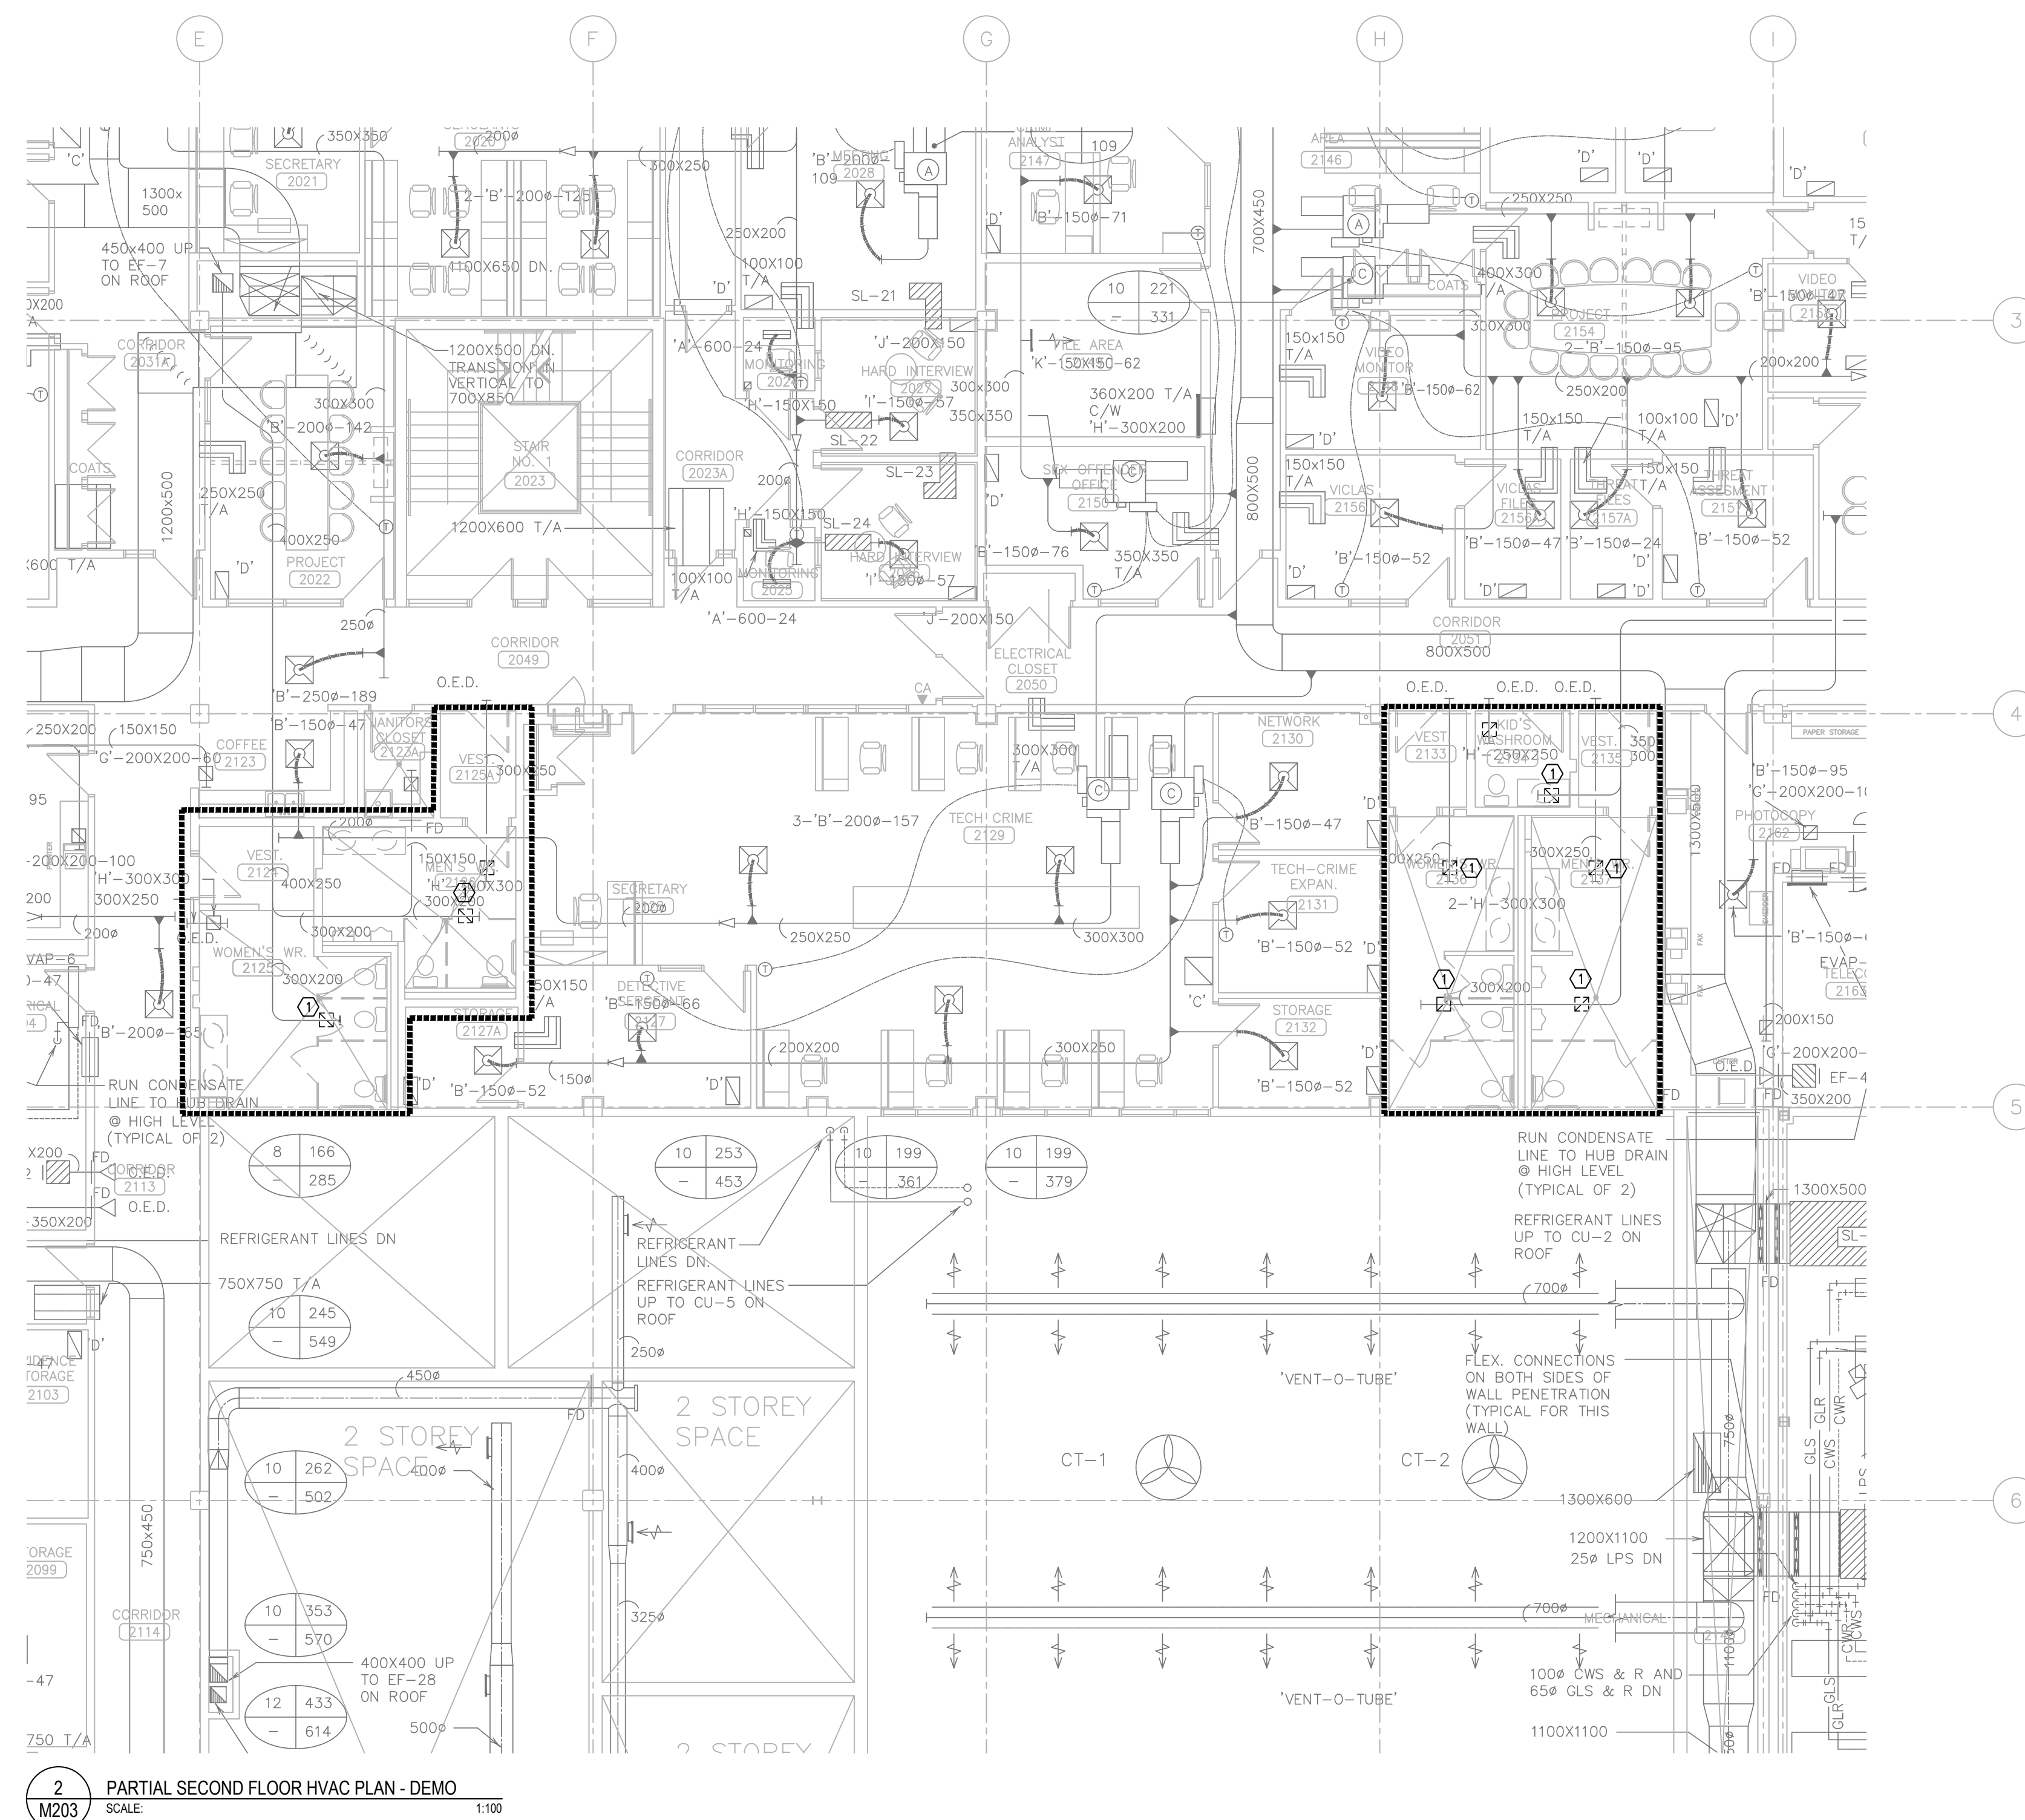
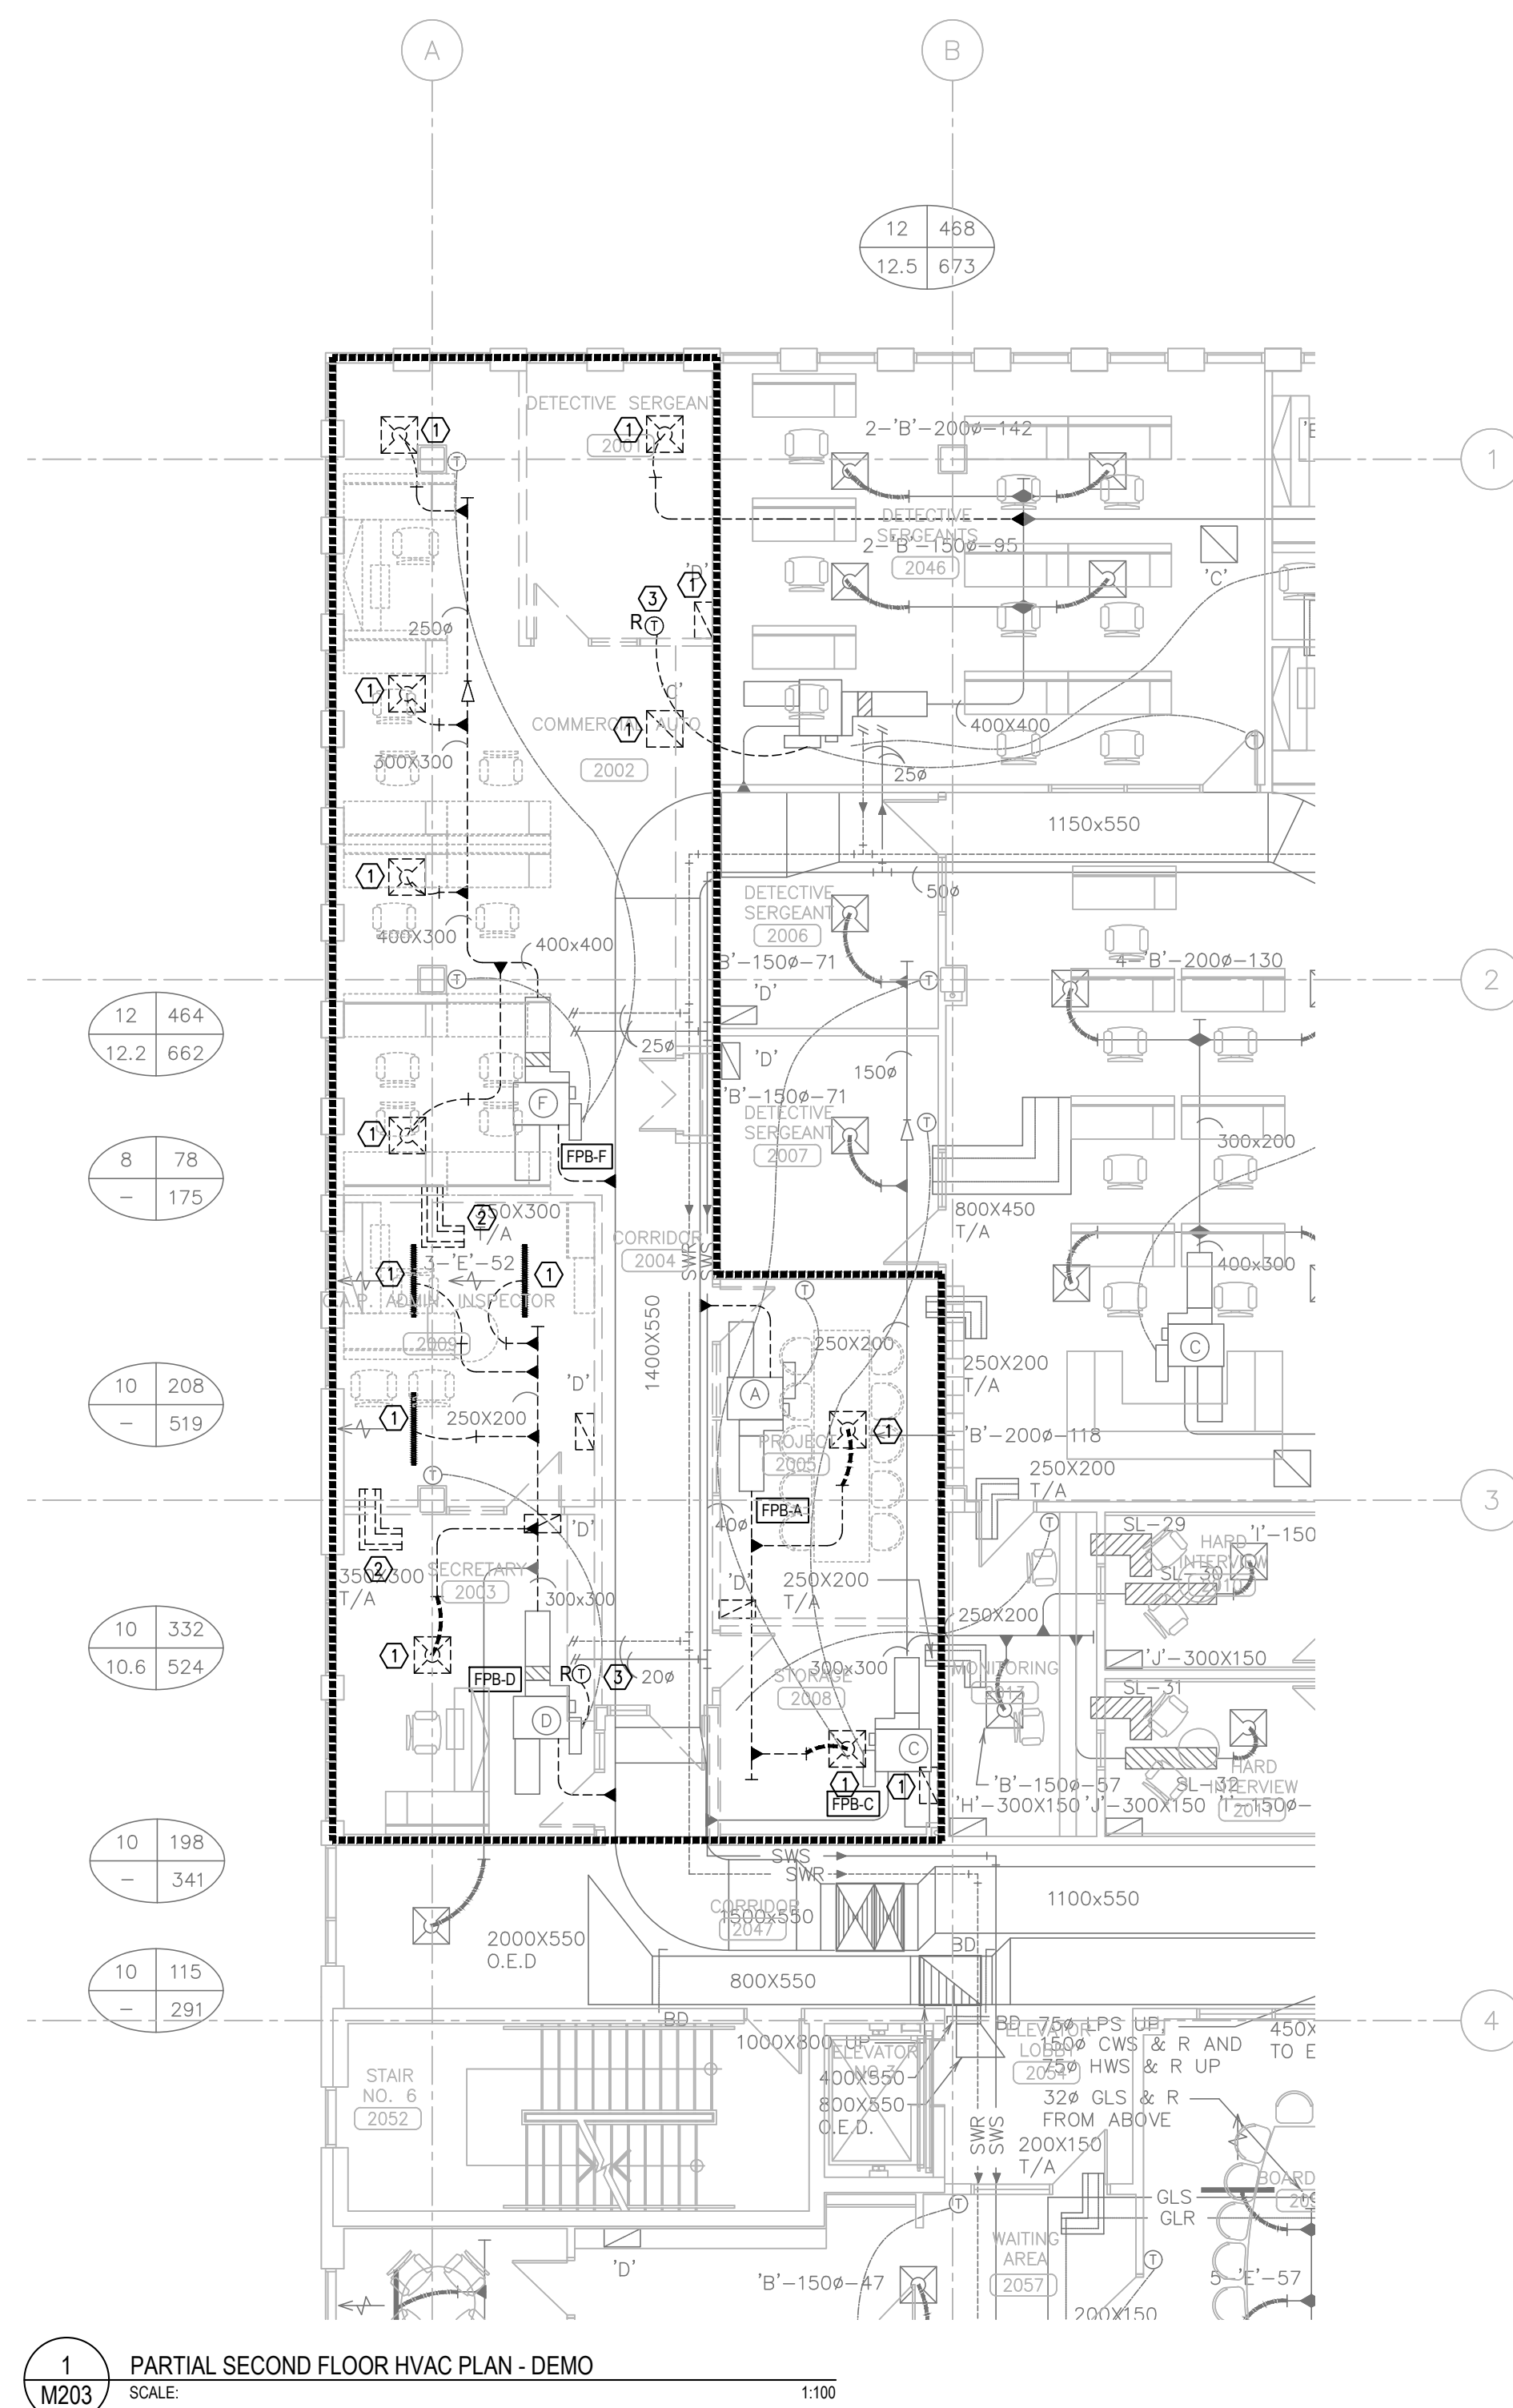


HVAC GENERAL DEMO NOTES:

1. ALL WORK SHALL BE DONE IN ACCORDANCE WITH THE REQUIREMENTS OF THE ONTARIO BUILDING CODE, MINISTRY OF THE ENVIRONMENT, MINISTRY OF LABOUR, NFPA, BUILDING MANAGEMENT'S GUIDELINES (REFER TO ARCH. SPEC).
2. ALL NEW SERVICES SHOWN ARE DIAGNOSTIC ONLY. THE ARRANGEMENTS OF EQUIPMENT SHOWN ARE APPROXIMATE AND MAY BE ALTERED ON SITE TO MEET THE ON-SITE CONDITIONS OF THE PROJECT. CONTRACTOR TO REVIEW ALL THE EXISTING SERVICES AND COORDINATE WITH THE NEW INSTALLATION.
3. CONTRACTOR TO COORDINATE WITH THE BUILDING MANAGEMENT FOR APPROVAL OF ANY SHUT DOWN OF EXISTING SYSTEMS/SERVICES. THE CONTRACTOR SHALL DETERMINE THE BEST METHOD TO MINIMIZE SERVICE INTERRUPTION AND IMPACT ON FACILITY OPERATION, INCLUDING USE OF HOT TAP/TEMPORARY FREEZING AND AFTER-HOUR WORK AS REQUIRED. PROVIDE MIN. ONE WEEK NOTICE FOR BUILDING MANAGEMENT TO PLAN THE SHUT DOWN. CONTRACTOR TO ENSURE MIN. SHUTDOWNS.
4. CONTRACTOR TO REROUTE ANY EXISTING SERVICES IF REQUIRED TO INSTALL NEW SERVICES. ALL SERVICES SHALL BE INSTALLED USING EXISTING BEAM OPENINGS AS MUCH AS POSSIBLE. IN THE EVENT OF NO SPACE THROUGH BEAM OPENING, SERVICES SHALL BE INSTALLED AS HIGH AS POSSIBLE TO THE UNDERSIDE OF THE BEAM. COORDINATE ALL SERVICES PRIOR TO INSTALLATION. THE LOWER SERVICES INSTALLED WILL BE ASKED TO RELOCATE IF SPACE AVAILABLE AT HIGH LEVEL.
5. COORDINATE WITH ALL CONSULTANT DRAWINGS BEFORE ORDERING ANY NEW EQUIPMENT, GRILLES & DIFFUSERS, SPRINKLER HEADS ETC.
6. CONTRACTOR TO INCLUDE FOR ALL OFFSETS REQUIRED FOR COORDINATION WITH MECHANICAL AND ELECTRICAL SERVICES. THE OFFSETTING INCLUDES ALL HVAC, HYDRONICS, PLUMBING AND FIRE PROTECTION SERVICES.
7. THE DRAWINGS AND SPECIFICATIONS ARE PROVIDING THE MINIMUM PERFORMANCE REQUIREMENTS. THE FIRE PROTECTION SYSTEM SHALL BE PREPARED, COMPLETE, STAMPED, SIGNED, AND APPROVED BY A LICENSED SPRINKLER CONTRACTOR. IT IS THE CONTRACTOR'S RESPONSIBILITY FOR THE FLOW TEST INFORMATION PRIOR TO PREPARATION OF DRAWINGS AND HYDRAULIC CALCULATIONS.
8. CONTRACTOR TO PROVIDE FIRE WATCH AS REQUIRED TO MAINTAIN FIRE SAFETY OF THE CONSTRUCTION SITE SCOPE AREA.
9. THE CONTRACTOR SHALL PROVIDE FIRE STOPPING ON ALL NEW PIPING AND CONDUIT PENETRATIONS THROUGH A FIRE-RATED WALL OR FLOOR AND ANY HOLES THAT RESULT FROM REMOVAL OF EXISTING SERVICES THROUGH A FIRE-RATED WALL OR FLOOR.
10. READ ALL THE DRAWINGS FOR COMPLETE INFORMATION.
11. INCLUDE FOR FREEZING OF ALL SERVICES WITH THE ASSUMPTION THAT NO VALVES WILL HOLD AND REPLACE ALL WITH NEW LEVER BALL VALVES (OR SCREW TYPE ONLY WHERE APPROPRIATE).
12. THE EXISTING SERVICES SHOWN ON THIS DRAWING HAVE BEEN TAKEN FROM THE ORIGINAL CONSTRUCTION DRAWINGS AND SITE SURVEYS. THE MECHANICAL CONTRACTOR SHALL CARRY OUT A FULL SURVEY OF ALL EXISTING SERVICES TO CONFIRM THE SIZE AND LOCATION OF THESE SERVICES BEFORE THE COMMENCEMENT OF ANY WORK.
13. ALL EXISTING SERVICES ARE TO REMAIN AS IS UNLESS NOTED ON THE LAYOUT TO BE REMOVED, RELOCATED AND OR MODIFIED.

HVAC DEMO DRAWING NOTES:

- ① DIFFUSER/GRILLE TO BE DEMOLISHED. CAP DUCTWORK BACK TO MAIN, AS SHOWN.
- ② TRANSFER AIR DUCT TO BE DEMOLISHED.
- ③ EXISTING THERMOSTAT TO BE REMOVED IN ITS ENTIRETY INCLUDING ALL CONTROL WIRING. THERMOSTAT TO BE RETAINED AND PROPERLY STORED FOR RE-USE IN THE RELOCATED AREA AS SHOWN ON THE NEW PLAN PLAN.

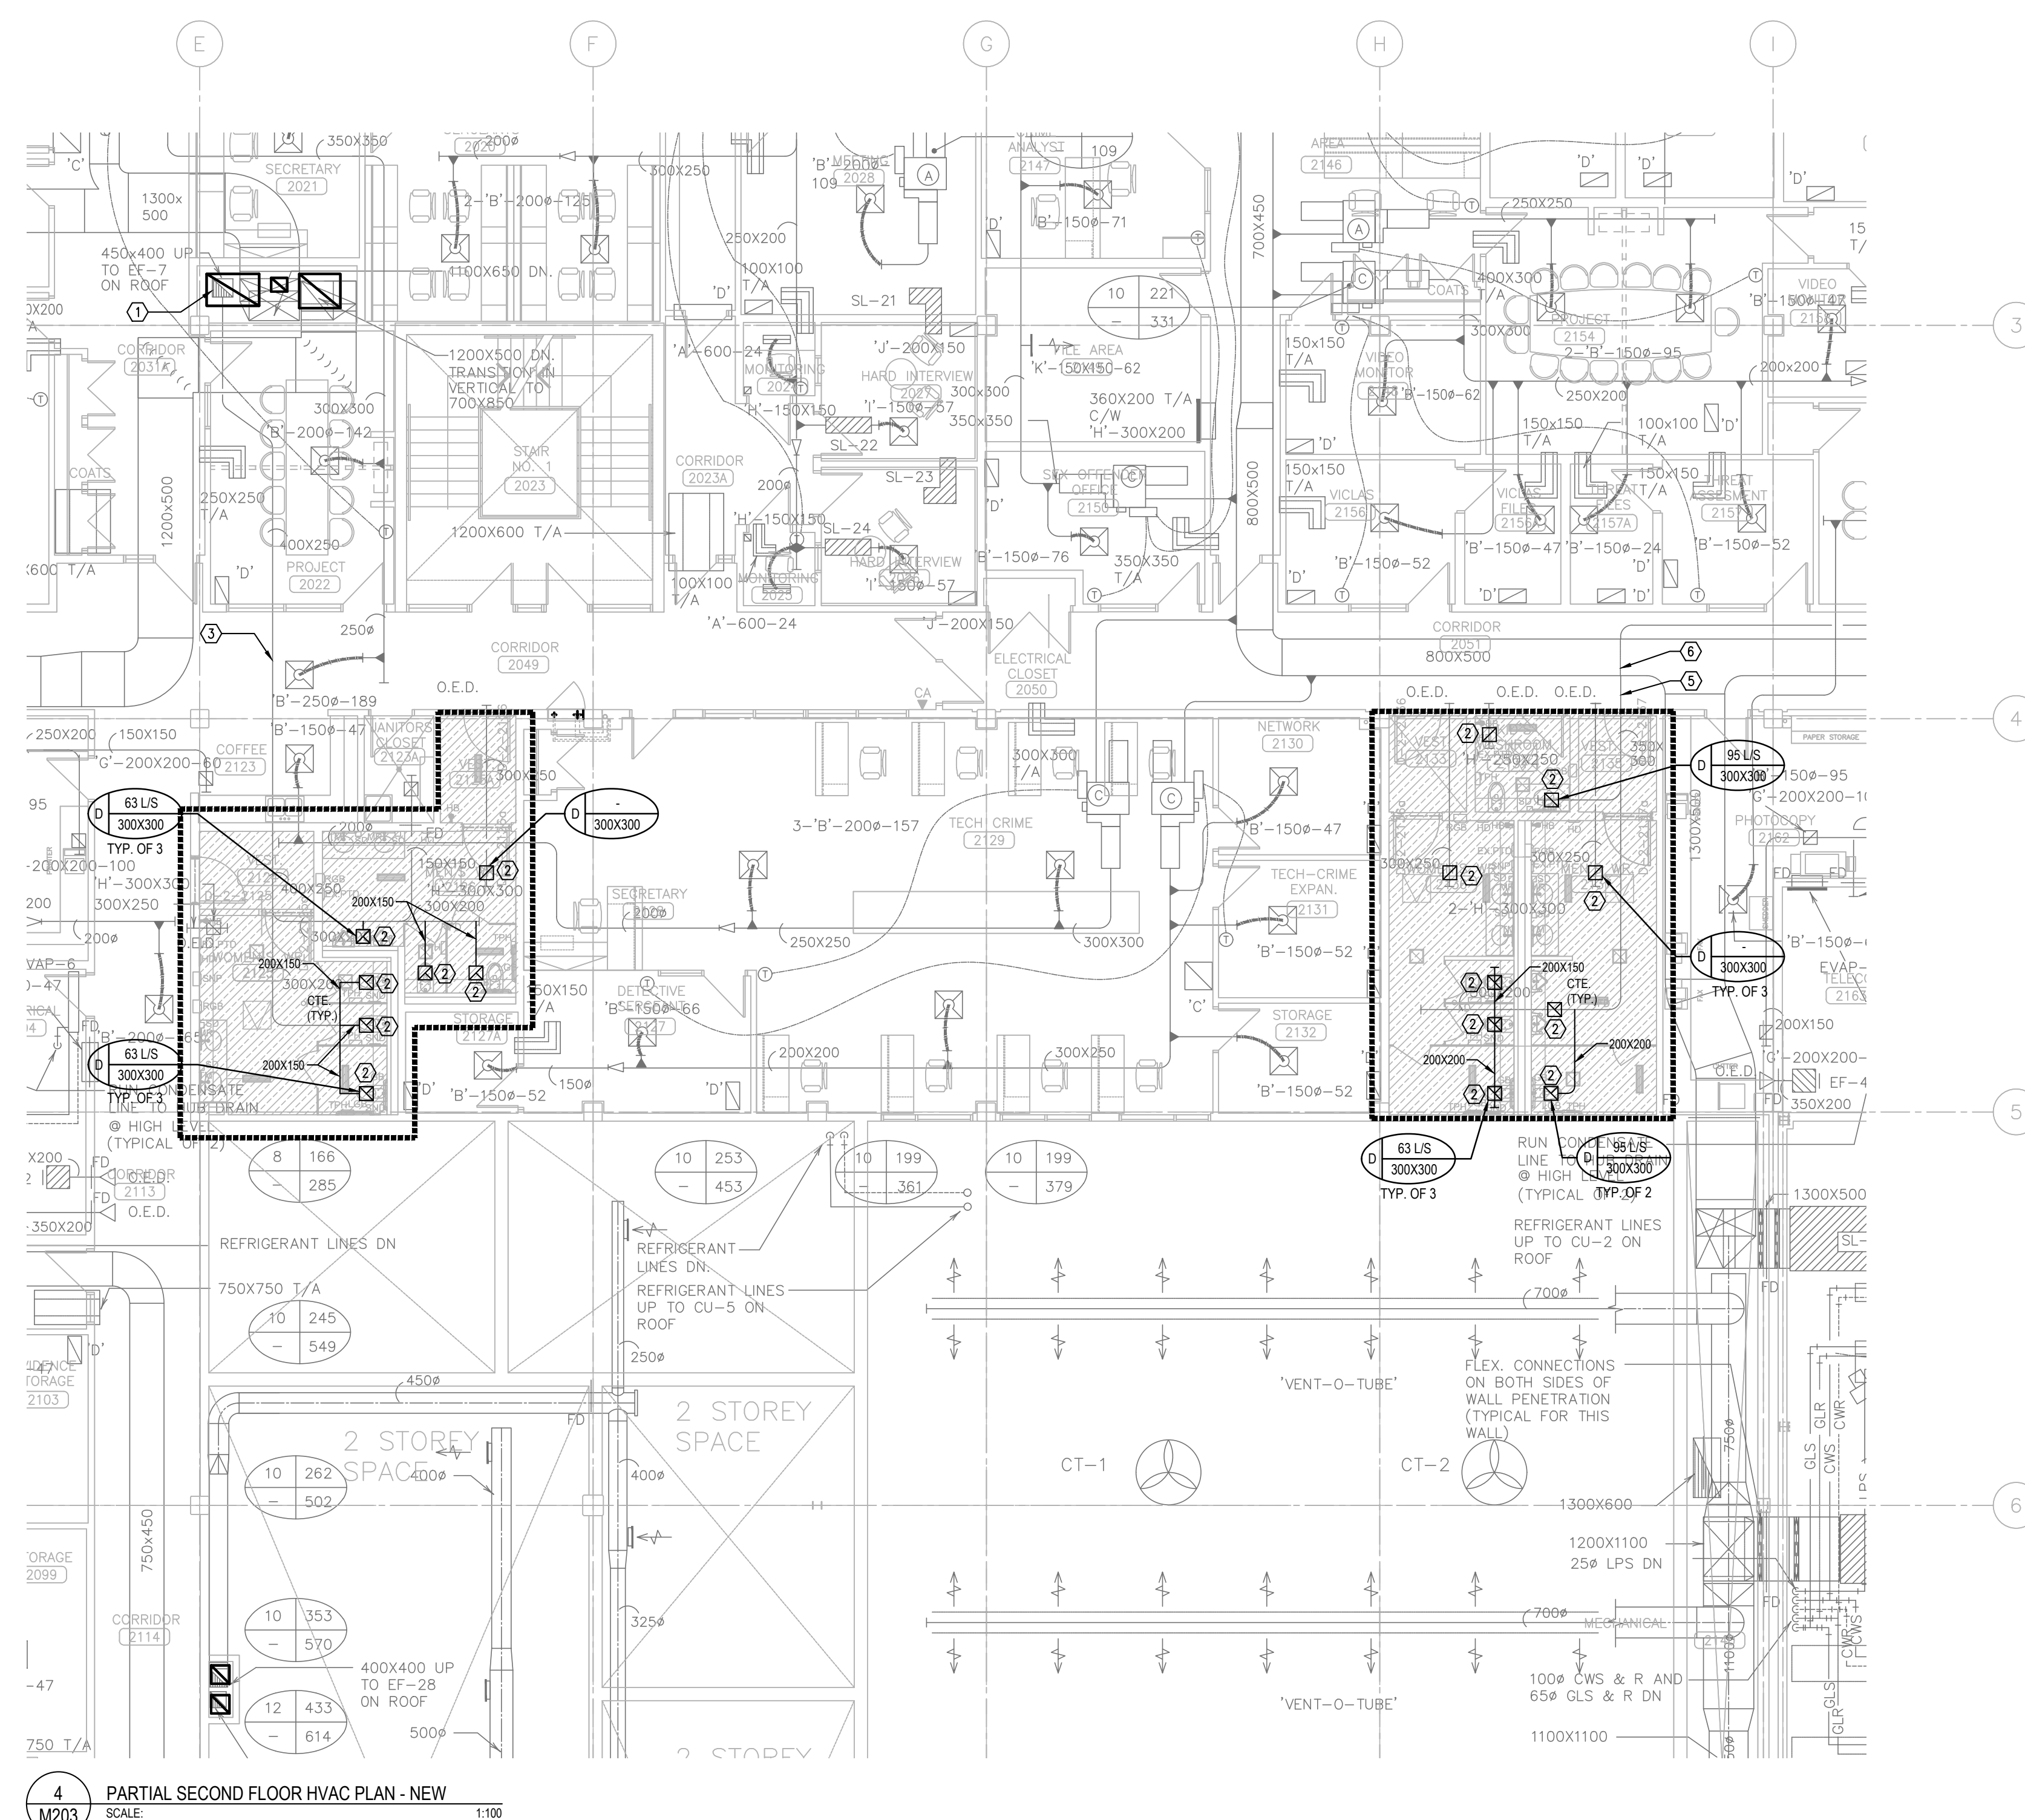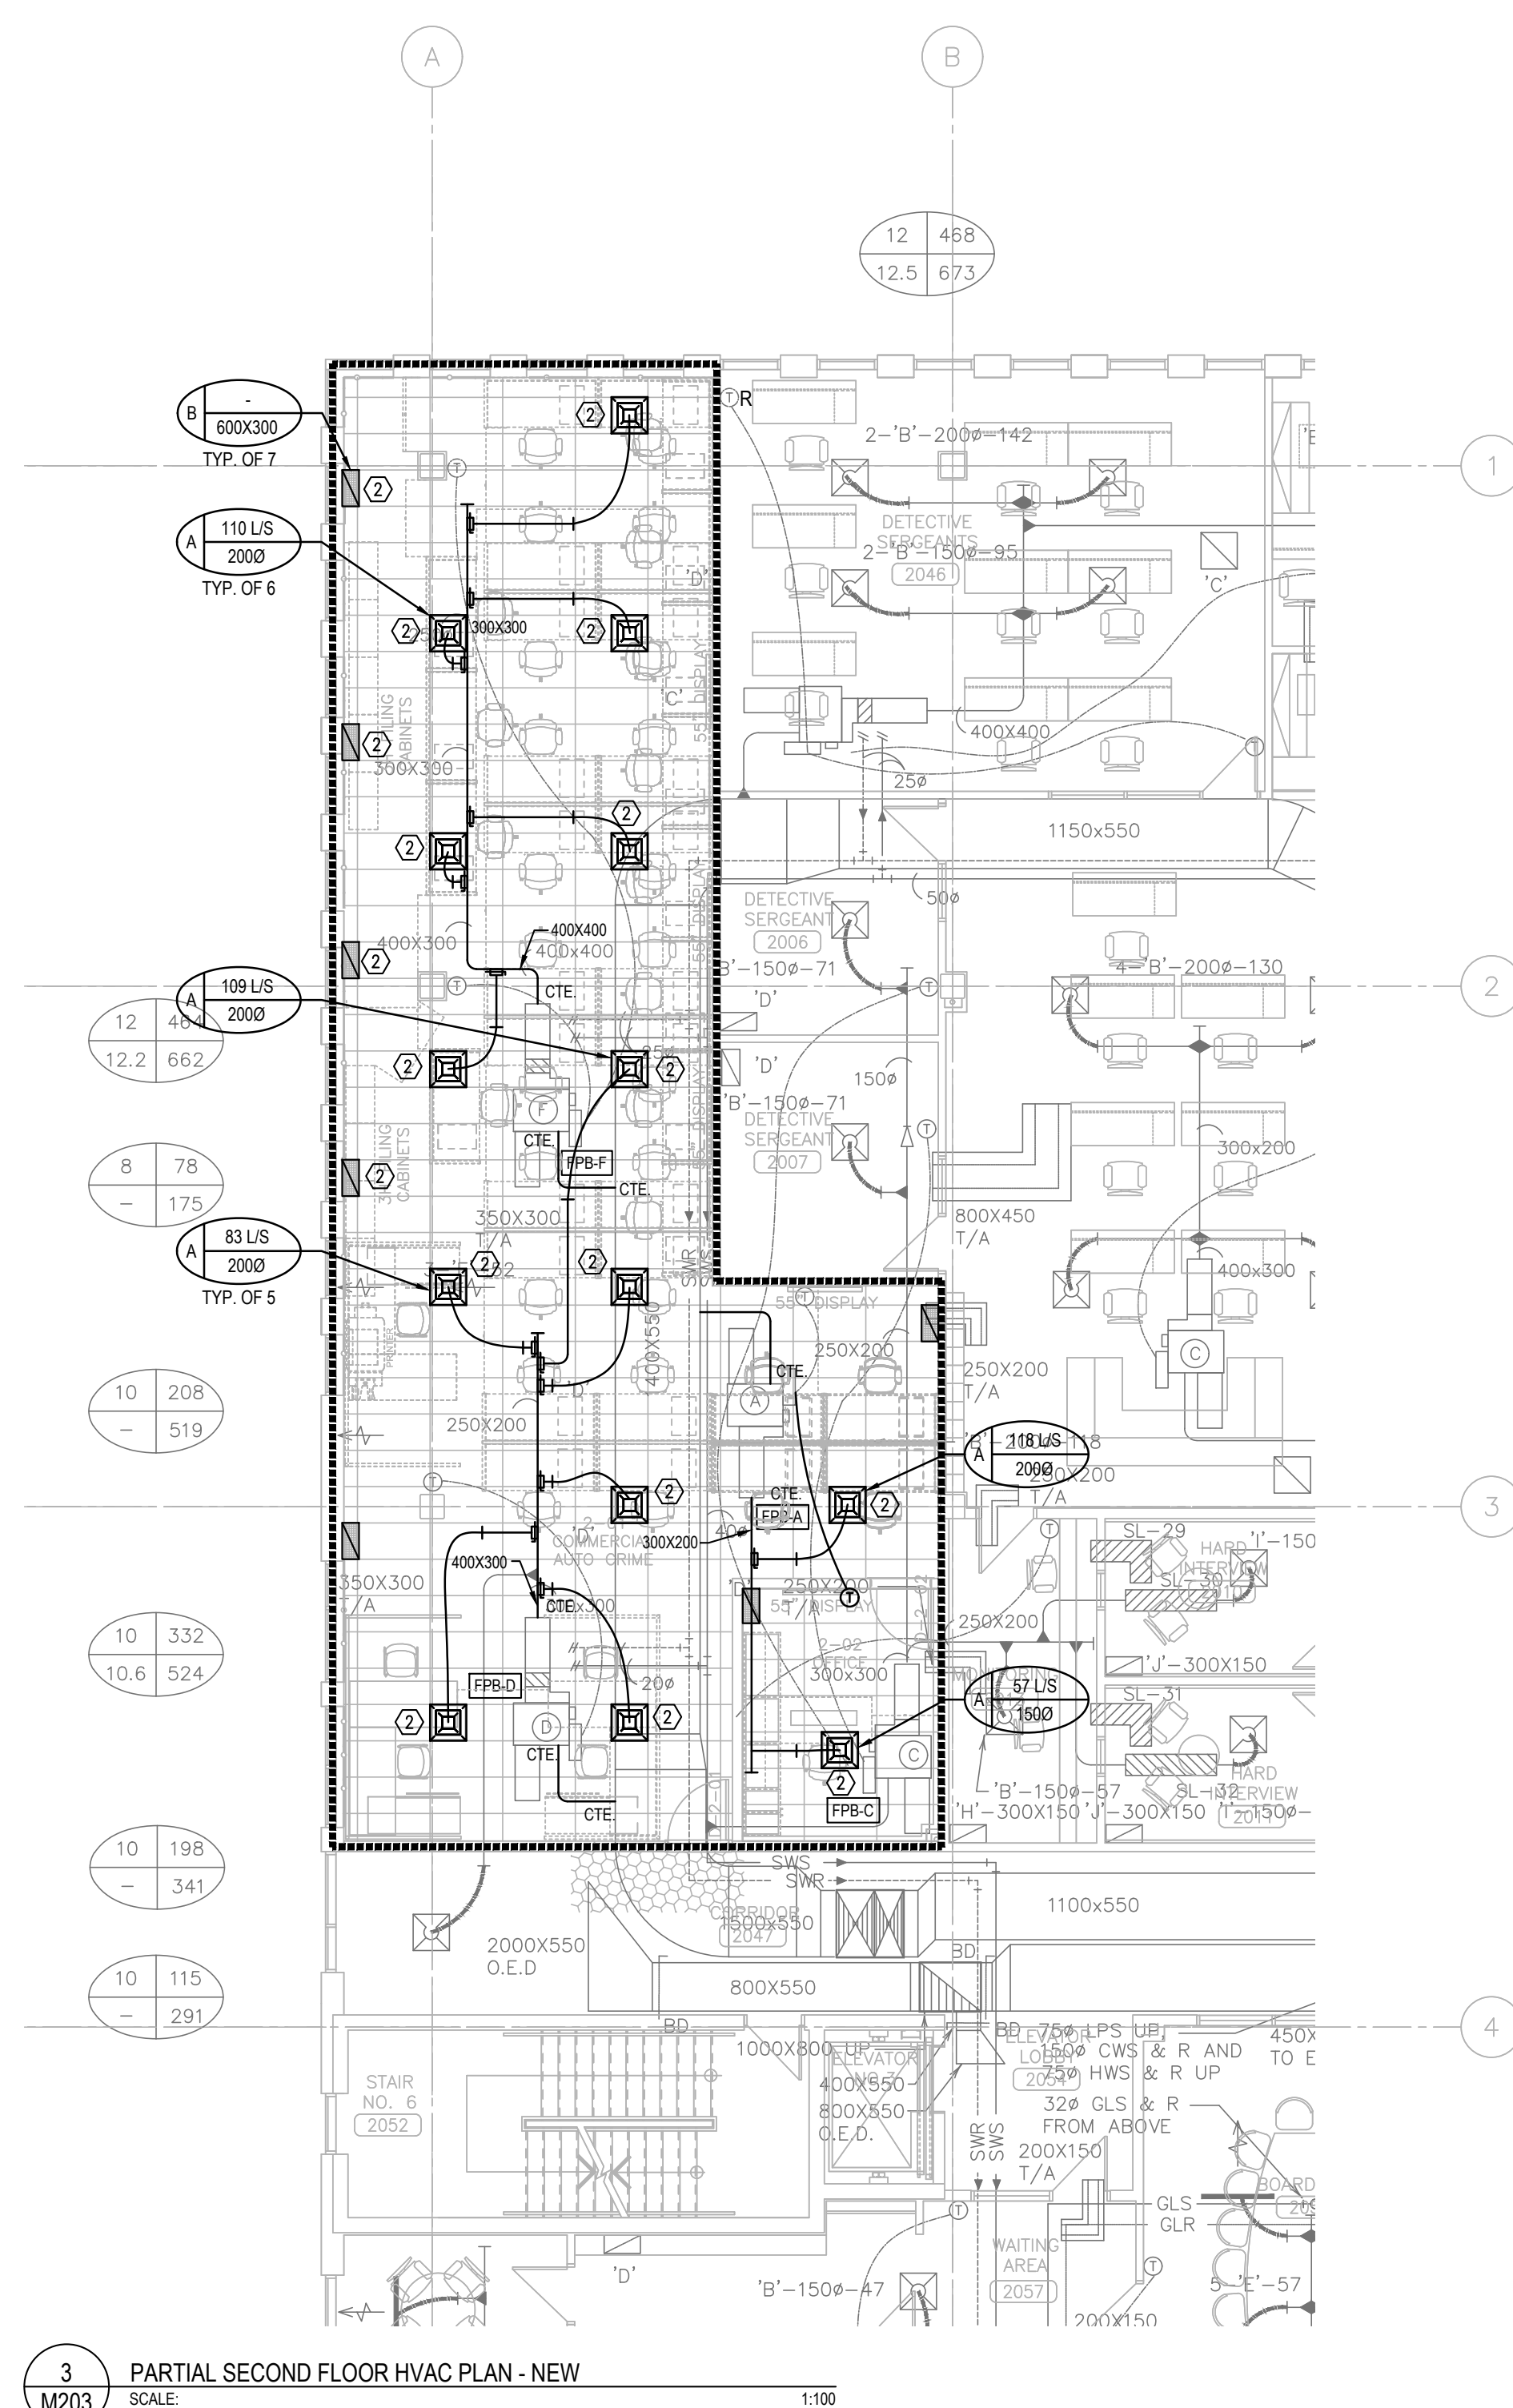

HVAC GENERAL NEW NOTES:

1. ALL WORK SHALL BE DONE IN ACCORDANCE WITH THE REQUIREMENTS OF THE ONTARIO BUILDING CODE, MINISTRY OF THE ENVIRONMENT, MINISTRY OF LABOUR, NFPA, BUILDING MANAGEMENT'S GUIDELINES (REFER TO ARCH. SPEC).
2. ALL NEW SERVICES SHOWN ARE DIAGNOSTIC ONLY. THE ARRANGEMENTS OF EQUIPMENT SHOWN ARE APPROXIMATE AND MAY BE ALTERED ON SITE TO MEET THE ON-SITE CONDITIONS OF THE PROJECT. CONTRACTOR TO REVIEW ALL THE EXISTING SERVICES AND COORDINATE WITH THE NEW INSTALLATION.
3. CONTRACTOR TO COORDINATE WITH THE BUILDING MANAGEMENT FOR APPROVAL OF ANY SHUT DOWN OF EXISTING SYSTEMS/SERVICES. THE CONTRACTOR SHALL DETERMINE THE BEST METHOD TO MINIMIZE SERVICE INTERRUPTION AND IMPACT ON FACILITY OPERATION, INCLUDING USE OF HOT TAP/TEMPORARY FREEZING AND AFTER-HOUR WORK AS REQUIRED. PROVIDE MIN. ONE WEEK NOTICE FOR BUILDING MANAGEMENT TO PLAN THE SHUT DOWN. CONTRACTOR TO ENSURE MIN. SHUTDOWNS.
4. CONTRACTOR TO REROUTE ANY EXISTING SERVICES IF REQUIRED TO INSTALL NEW SERVICES. ALL SERVICES SHALL BE INSTALLED USING EXISTING BEAM OPENINGS AS MUCH AS POSSIBLE. IN THE EVENT OF NO SPACE THROUGH BEAM OPENING, SERVICES SHALL BE INSTALLED AS HIGH AS POSSIBLE TO THE UNDERSIDE OF THE BEAM. COORDINATE ALL SERVICES PRIOR TO INSTALLATION. THE LOWER SERVICES INSTALLED WILL BE ASKED TO RELOCATE IF SPACE AVAILABLE AT HIGH LEVEL.
5. COORDINATE WITH ALL CONSULTANT DRAWINGS BEFORE ORDERING ANY NEW EQUIPMENT, GRILLES & DIFFUSERS, SPRINKLER HEADS ETC.
6. CONTRACTOR TO INCLUDE FOR ALL OFFSETS REQUIRED FOR COORDINATION WITH MECHANICAL AND ELECTRICAL SERVICES. THE OFFSETTING INCLUDES ALL HVAC, HYDRONICS, PLUMBING AND FIRE PROTECTION SERVICES.
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8. CONTRACTOR TO PROVIDE FIRE WATCH AS REQUIRED TO MAINTAIN FIRE SAFETY OF THE CONSTRUCTION SITE SCOPE AREA.
9. THE CONTRACTOR SHALL PROVIDE FIRE STOPPING ON ALL NEW PIPING AND CONDUIT PENETRATIONS THROUGH A FIRE-RATED WALL OR FLOOR AND ANY HOLES THAT RESULT FROM REMOVAL OF EXISTING SERVICES THROUGH A FIRE-RATED WALL OR FLOOR.
10. READ ALL THE DRAWINGS FOR COMPLETE INFORMATION.
11. INCLUDE FOR FREEZING OF ALL SERVICES WITH THE ASSUMPTION THAT NO VALVES WILL HOLD AND REPLACE ALL WITH NEW LEVER BALL VALVES (OR SCREW TYPE ONLY WHERE APPROPRIATE).
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13. ALL EXISTING SERVICES ARE TO REMAIN AS IS UNLESS NOTED ON THE LAYOUT TO BE REMOVED, RELOCATED AND OR MODIFIED.

HVAC NEW DRAWING NOTES:

- ① EXISTING EA DUCT TO EF-7 ON THE ROOF TO REMAIN.
- ② PROVIDE NEW DIFFUSER/GRILLE. CONNECT TO EXISTING MAIN DUCTWORK AS SHOWN. PROVIDE BALANCING DAMPER AT EACH BRANCH DUCT SERVING NEW DIFFUSER/GRILLE. BALANCE AIR FLOW TO EACH DIFFUSER/GRILLE IN L/S AS INDICATED ON PLAN. REFER TO DIFFUSERS & GRILLES SCHEDULE ON MECHANICAL SCHEDULE DRAWING.
- ③ EXISTING 400X250 EA DUCT TO REMAIN.
- ④ RESERVED.
- ⑤ EXISTING 300X300 EA DUCT TO REMAIN.
- ⑥ EA DUCT UP TO EF-1 ON ROOF TO REMAIN.
- ⑦ RESERVED.

NO.	DESCRIPTION	DATE
1	ISSUED FOR COSTING REVIEW	2025.11.24
2	ISSUED FOR 65% CLIENT REVIEW	2026.01.09
3	ISSUED FOR 100% CLIENT REVIEW	2026.03.31
4	ISSUED FOR BUILDING PERMIT	2026.04.08
5	ISSUED FOR TENDER	2026.05.01

REVISIONS

PROJECT



REGION OF PEEL


EMIL V. KOLB CENTRE
PEEL REGIONAL POLICE FACILITY
INTERIOR RENOVATION PROJECT
180 RRD EAST, MISSISSAUGA, ON L2Y 2Y5




STEPHENSON CONSULTING
STEPHENSON ENGINEERING
MECHANICAL CONSULTANT
EXP SERVICES INC.
ELECTRICAL CONSULTANT
EXP SERVICES INC.

SHEET TITLE
PARTIAL SECOND FLOOR -
HVAC DEMO & NEW

SHEET NO.	DRAWN BY	CHECKED BY
M203	MRK-25008951-A0	ME
SCALE		

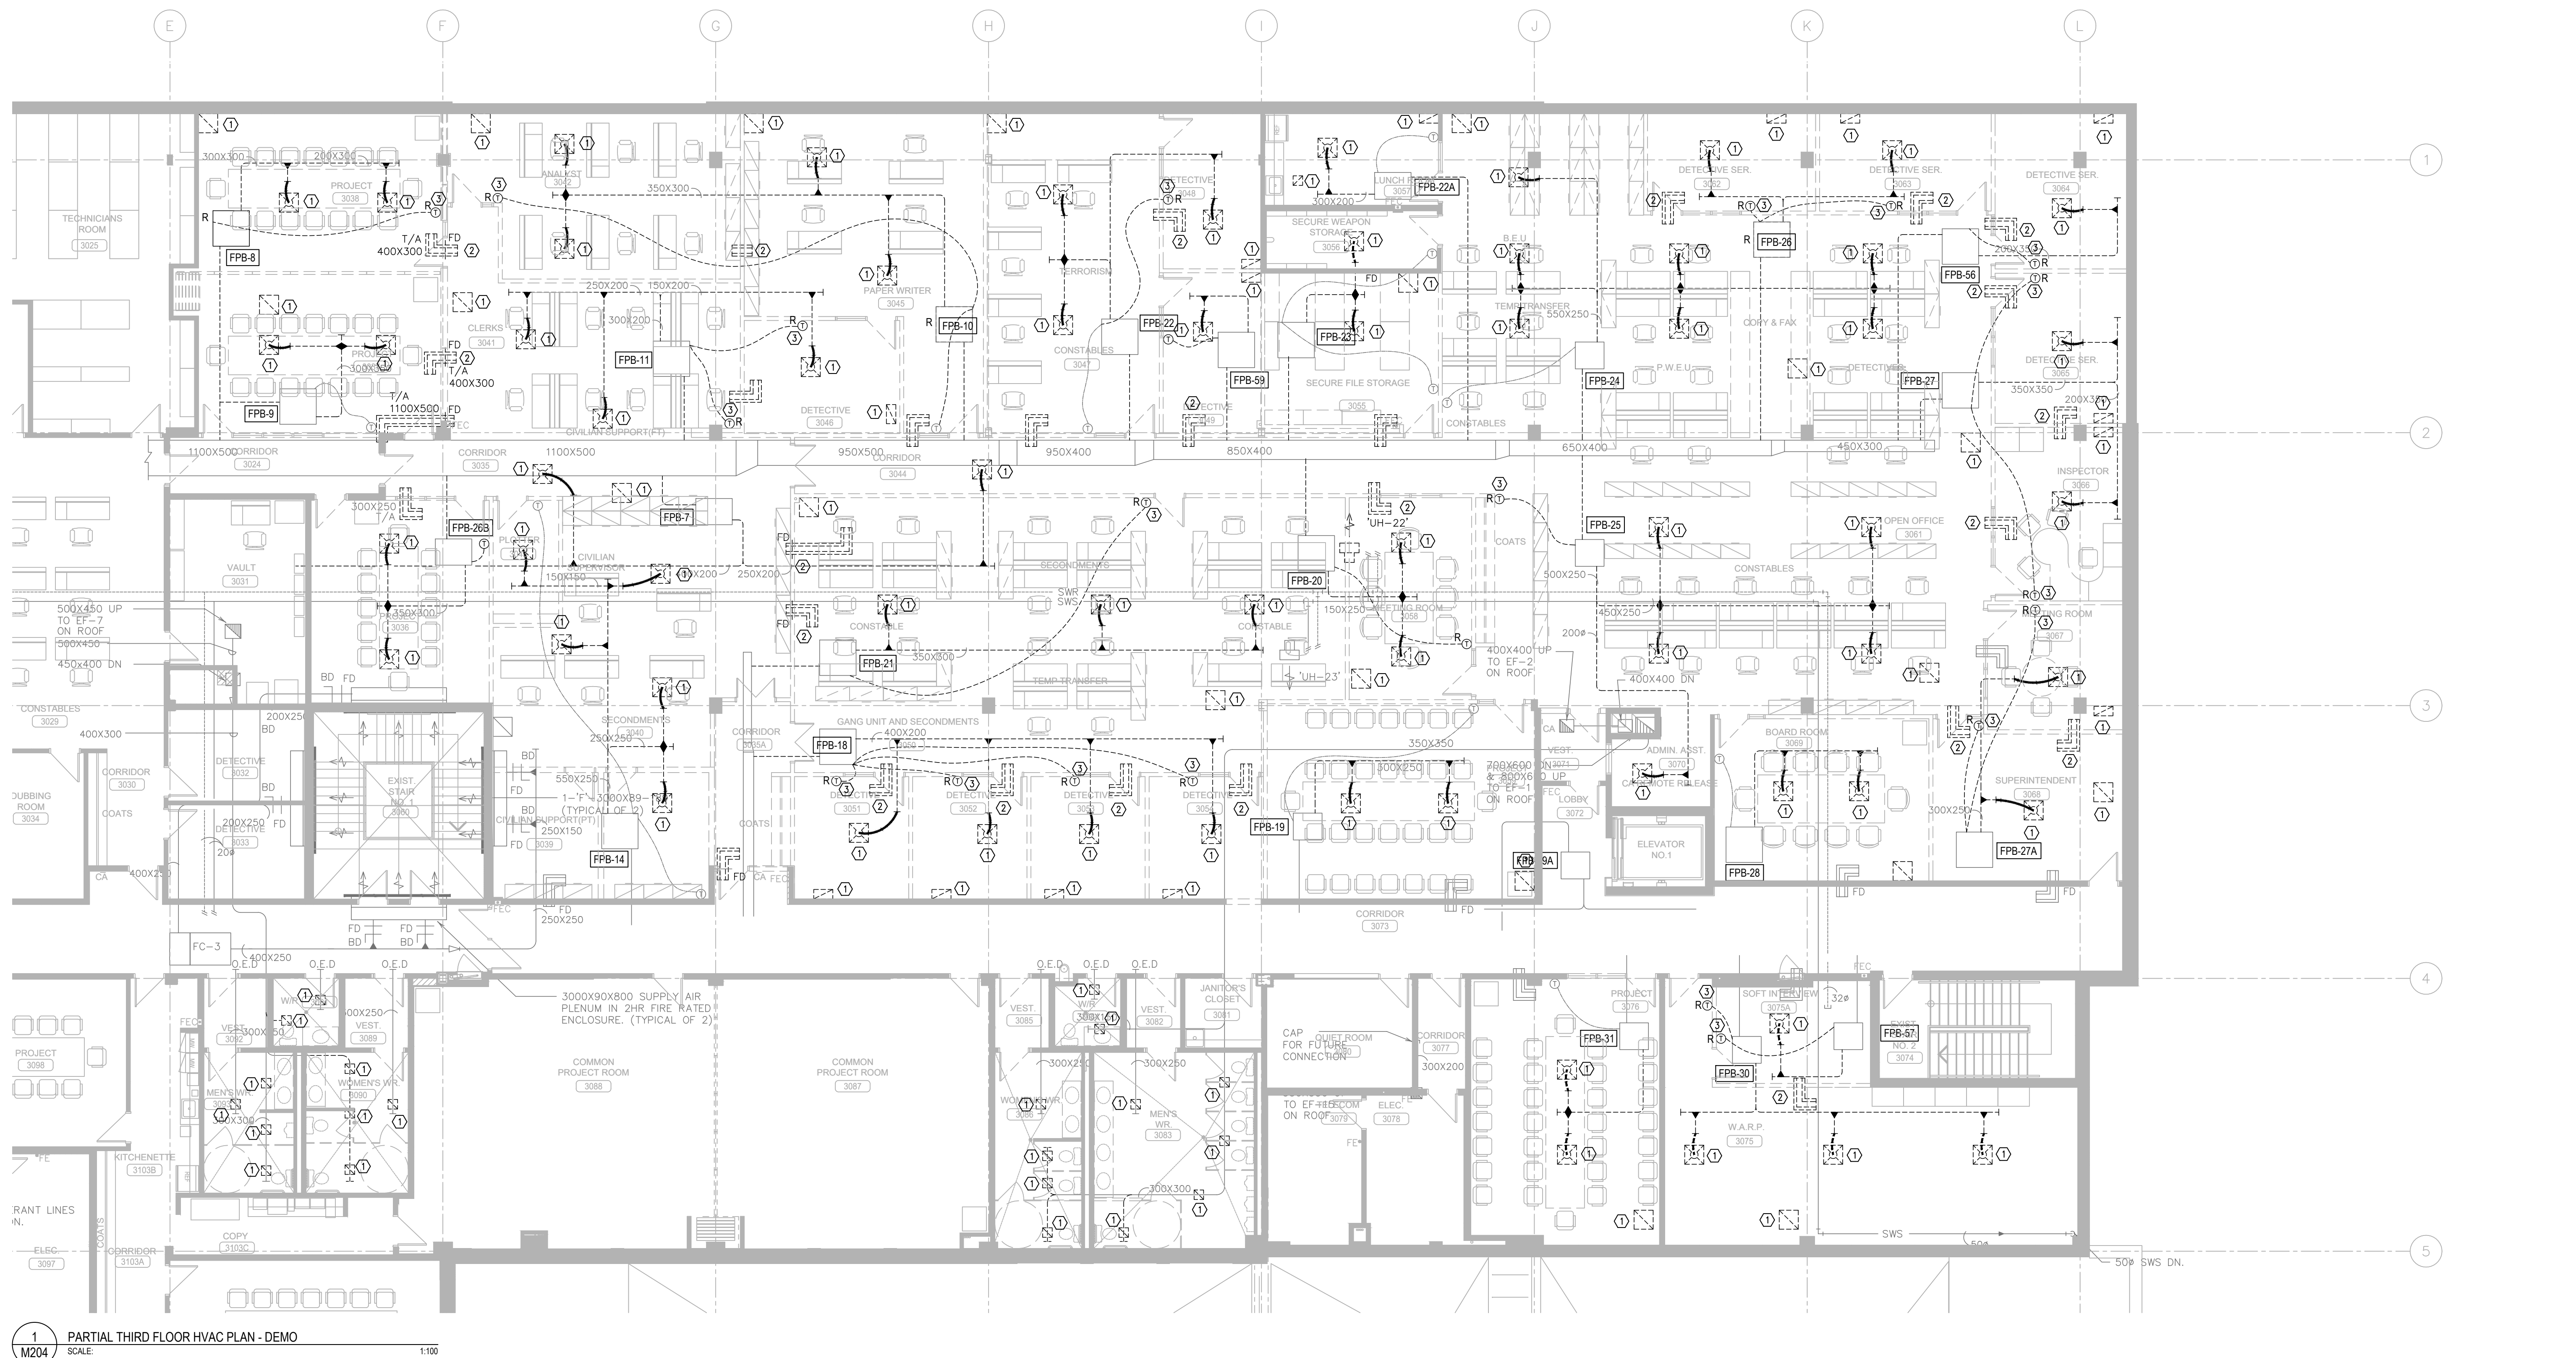

1
M204
PARTIAL THIRD FLOOR HVAC PLAN - DEMO
SCALE 1/8\"/>

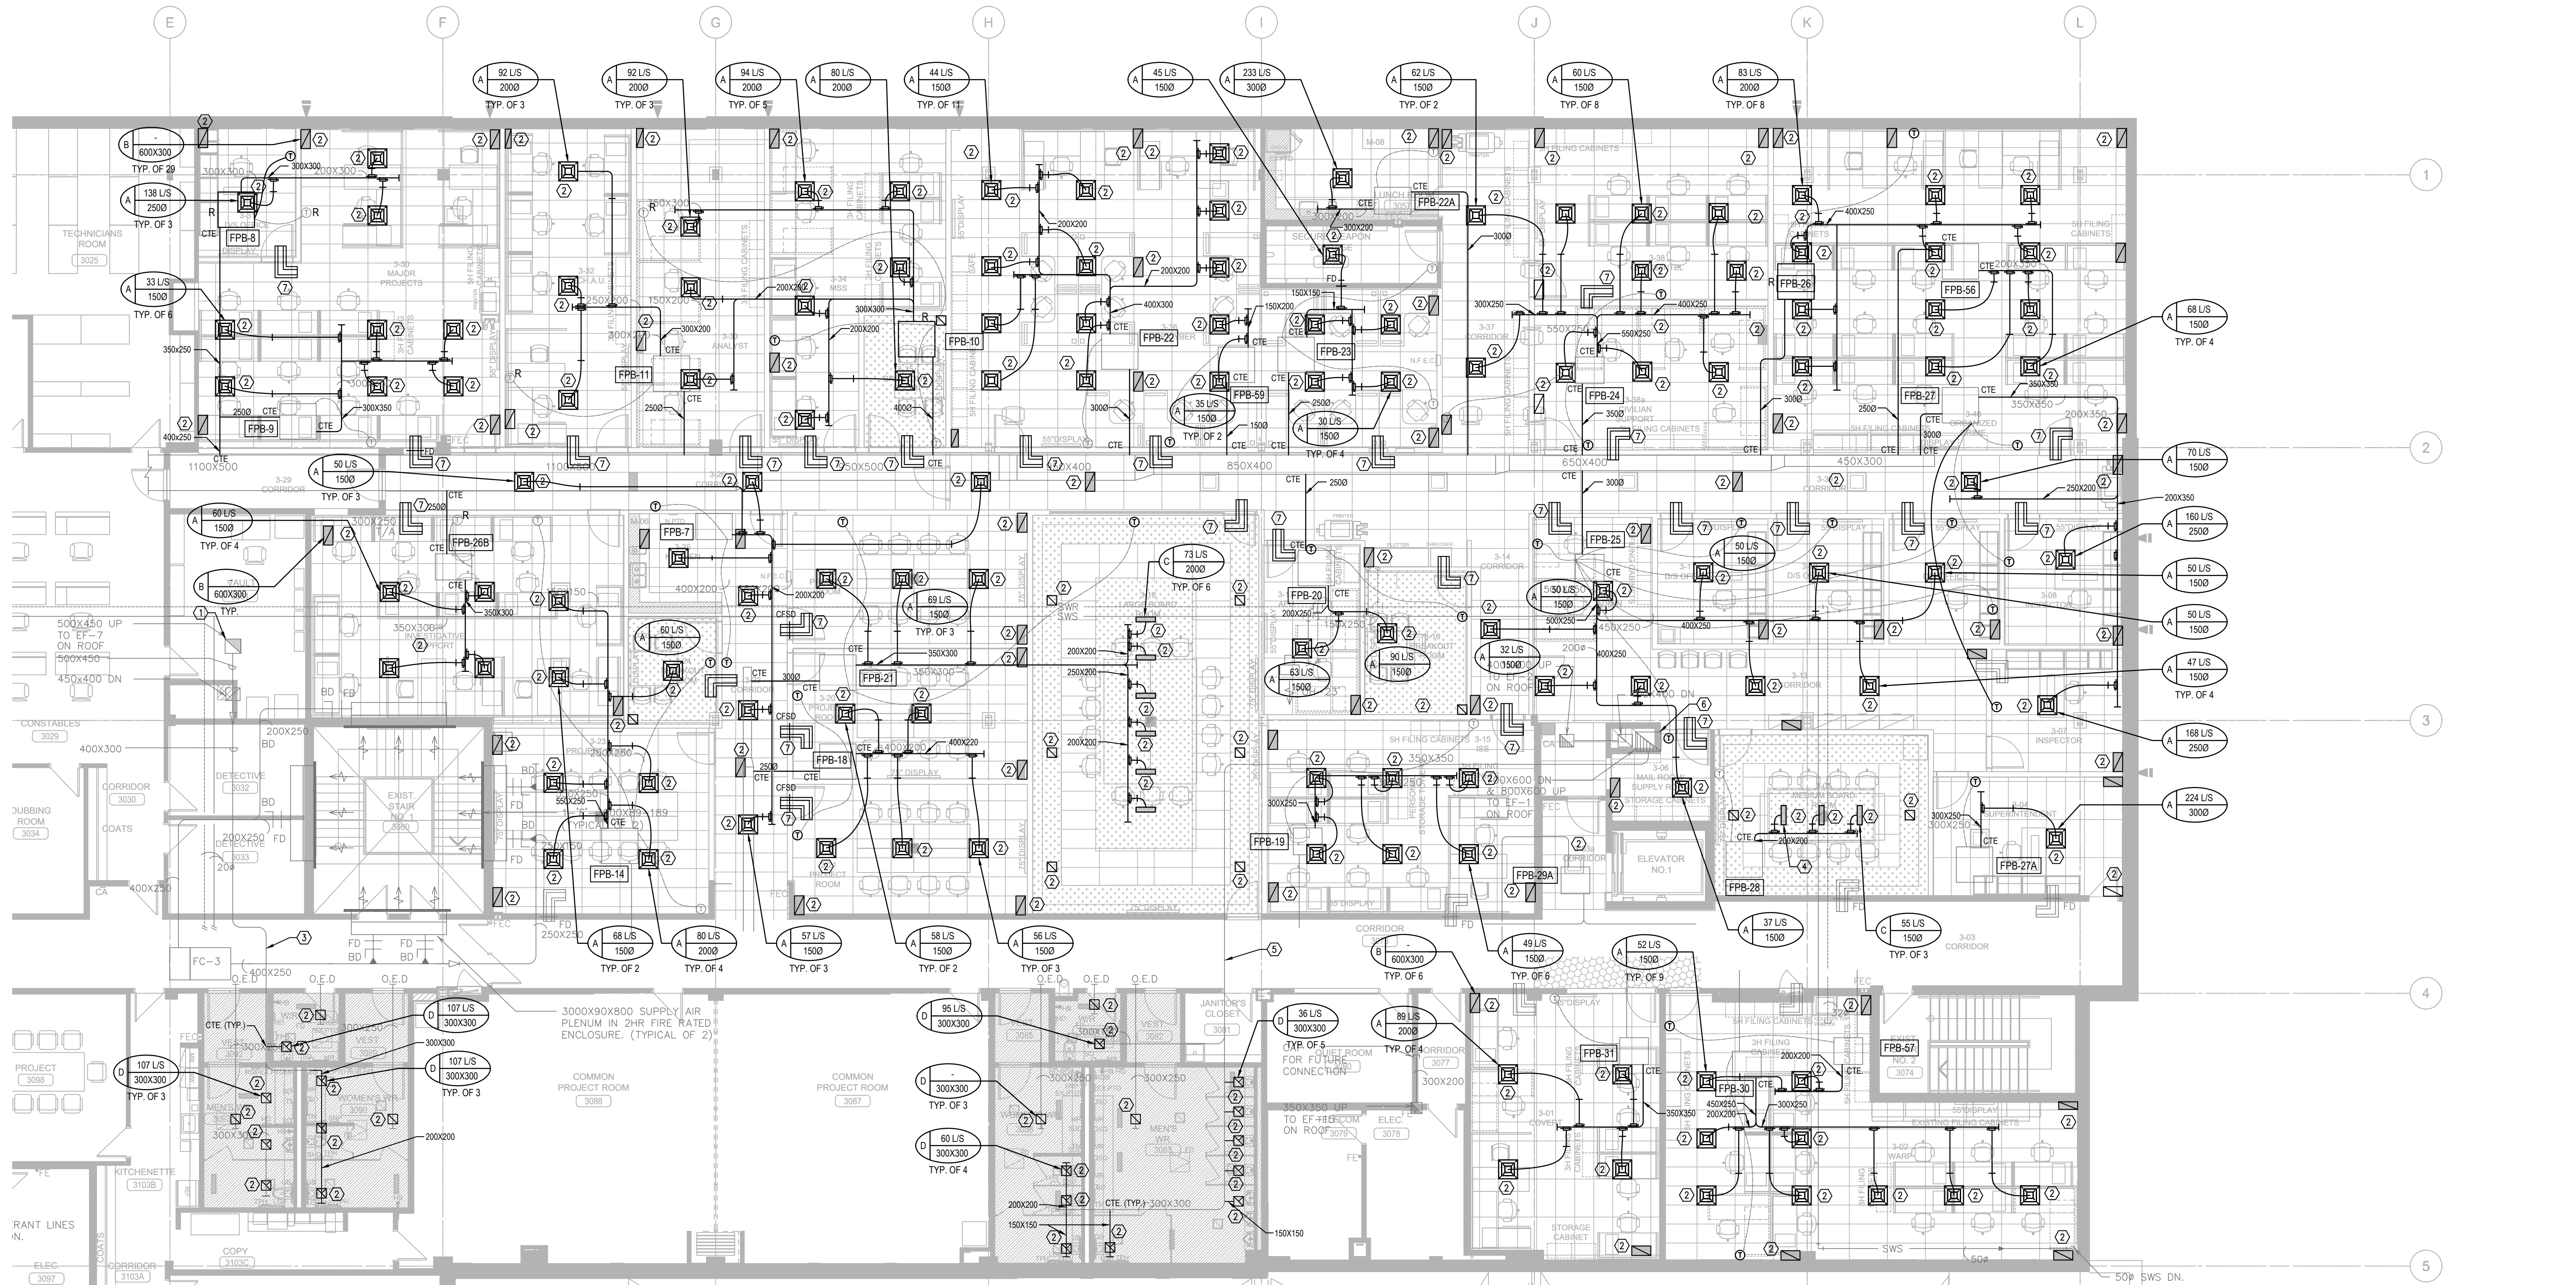

2
M204
PARTIAL THIRD FLOOR HVAC PLAN - NEW
SCALE 1/8\"/>

- HVAC GENERAL DEMO NOTES:**
- ALL WORK SHALL BE DONE IN ACCORDANCE WITH THE REQUIREMENTS OF THE ONTARIO BUILDING CODE, MINISTRY OF THE ENVIRONMENT, MINISTRY OF LABOUR, NFPA, BUILDING MANAGEMENT'S GUIDELINES (REFER TO ARCH SPEC).
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 - ALL EXISTING SERVICES ARE TO REMAIN AS IS UNLESS NOTED ON THE LAYOUT TO BE REMOVED, RELOCATED AND OR MODIFIED.

- HVAC DEMO. DRAWING NOTES:**
- DIFFUSER/GRILLE TO BE DEMOLISHED. CAP DUCTWORK BACK TO MAIN, AS SHOWN.
 - TRANSFER AIR DUCT TO BE DEMOLISHED.
 - EXISTING THERMOSTAT TO BE REMOVED IN ITS ENTIRETY INCLUDING ALL CONTROL WIRING. THERMOSTAT TO BE RETAINED AND PROPERLY STORED FOR RE-USE IN THE RELOCATED AREA AS SHOWN ON THE NEW WORK PLAN.

- HVAC GENERAL NEW NOTES:**
- ALL WORK SHALL BE DONE IN ACCORDANCE WITH THE REQUIREMENTS OF THE ONTARIO BUILDING CODE, MINISTRY OF THE ENVIRONMENT, MINISTRY OF LABOUR, NFPA, BUILDING MANAGEMENT'S GUIDELINES (REFER TO ARCH SPEC).
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 - CONTRACTOR TO REROUTE ANY EXISTING SERVICES IF REQUIRED TO INSTALL NEW SERVICES. ALL SERVICES SHALL BE INSTALLED USING EXISTING BEAM OPENINGS AS MUCH AS POSSIBLE. IN THE EVENT OF NO SPACE THROUGH BEAM OPENING, SERVICES SHALL BE INSTALLED AS HIGH AS POSSIBLE TO THE UNDERSIDE OF THE BEAM. COORDINATE ALL SERVICES PRIOR TO INSTALLATION. THE LOWER SERVICES INSTALLED WILL BE ASKED TO RELOCATE IF SPACE AVAILABLE AT HIGH LEVEL.
 - COORDINATE WITH ALL CONSULTANT DRAWINGS BEFORE ORDERING ANY NEW EQUIPMENT, GRILLES & DIFFUSERS, SPRINKLER HEADS ETC.
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 - CONTRACTOR TO PROVIDE FIRE WATCH AS REQUIRED TO MAINTAIN FIRE SAFETY OF THE CONSTRUCTION SITE SCOPE AREA.
 - THE CONTRACTOR SHALL PROVIDE FIRE STOPPING ON ALL NEW PIPING AND CONDUIT PENETRATIONS THROUGH A FIRE-RATED WALL OR FLOOR AND ANY HOLES THAT RESULT FROM REMOVAL OF EXISTING SERVICES THROUGH A FIRE-RATED WALL OR FLOOR.
 - READ ALL THE DRAWINGS FOR COMPLETE INFORMATION.
 - INCLUDE FOR FREEZING OF ALL SERVICES WITH THE ASSUMPTION THAT NO VALVES WILL HOLD AND REPLACE ALL WITH NEW LEVER BALL VALVES (OR SCREW TYPE ONLY WHERE APPROPRIATE).
 - THE EXISTING SERVICES SHOWN ON THIS DRAWING HAVE BEEN TAKEN FROM THE ORIGINAL CONSTRUCTION DRAWINGS AND SITE SURVEYS. THE MECHANICAL CONTRACTOR SHALL CARRY OUT A FULL SURVEY OF ALL EXISTING SERVICES TO CONFIRM THE SIZE AND LOCATION OF THESE SERVICES BEFORE THE COMMENCEMENT OF ANY WORK.
 - ALL EXISTING SERVICES ARE TO REMAIN AS IS UNLESS NOTED ON THE LAYOUT TO BE REMOVED, RELOCATED AND OR MODIFIED.

- HVAC NEW DRAWING NOTES:**
- EXISTING EA DUCT TO EF-7 ON THE ROOF.
 - PROVIDE AND INSTALL NEW DIFFUSER/GRILLE. CONNECT TO EXISTING MAIN DUCTWORK AS SHOWN. PROVIDE BALANCING DAMPER AT EACH BRANCH DUCT SERVING NEW DIFFUSER/GRILLE. BALANCE AIRFLOW TO EACH DIFFUSER/GRILLE IN L/S AS INDICATED ON PLAN. REFER TO DIFFUSERS & GRILLES SCHEDULE ON MECHANICAL SCHEDULE DRAWINGS.
 - EXISTING 400X360 EA DUCT
 - SDS LINEAR SLOT DIFFUSER WITH SDA PLENUM BOX (TYP.)
 - EXISTING 750X750 EA DUCT TO REMAIN
 - EA DUCT UP TO EF-1 ON ROOF
 - TRANSFER AIR DUCT AT WALL ABOVE CEILING ON FIRE DAMPER (WHERE SHOWN). ALL TRANSFER AIR DUCT SHALL BE 300MM X 200MM LINED WITH 25MM ACOUSTIC INSULATION (TYP.)
 - 250X250 EA DUCT UP TO EF-81 ON ROOF. REPLACE GRILLE.

NO.	DESCRIPTION	DATE
1	ISSUED FOR TENDER	2026.05.01
2	ISSUED FOR BUILDING PERMIT	2026.04.08
3	ISSUED FOR 100% CLIENT REVIEW	2026.03.31
4	ISSUED FOR 66% CLIENT REVIEW	2026.01.09
5	ISSUED FOR COSTING REVIEW	2026.11.24

PROJECT

PEEL REGIONAL POLICE

REGION OF PEEL

EMIL V. KOLB CENTRE
PEEL REGIONAL POLICE FACILITY
INTERIOR RENOVATION PROJECT
180 RORY ROAD EAST, MISSISSAUGA, ON L2Y 2Y5

NCA
ARCHITECTS

STRUCTURAL CONSULTANT
STEPHENSON ENGINEERING
MECHANICAL CONSULTANT
EXP SERVICES INC.
ELECTRICAL CONSULTANT
EXP SERVICES INC.

SHEET TITLE
PARTIAL THIRD FLOOR - HVAC DEMO & NEW


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M204

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H.BELL


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ME

PROJECT NO.
MRK-25008951-A0

SCALE

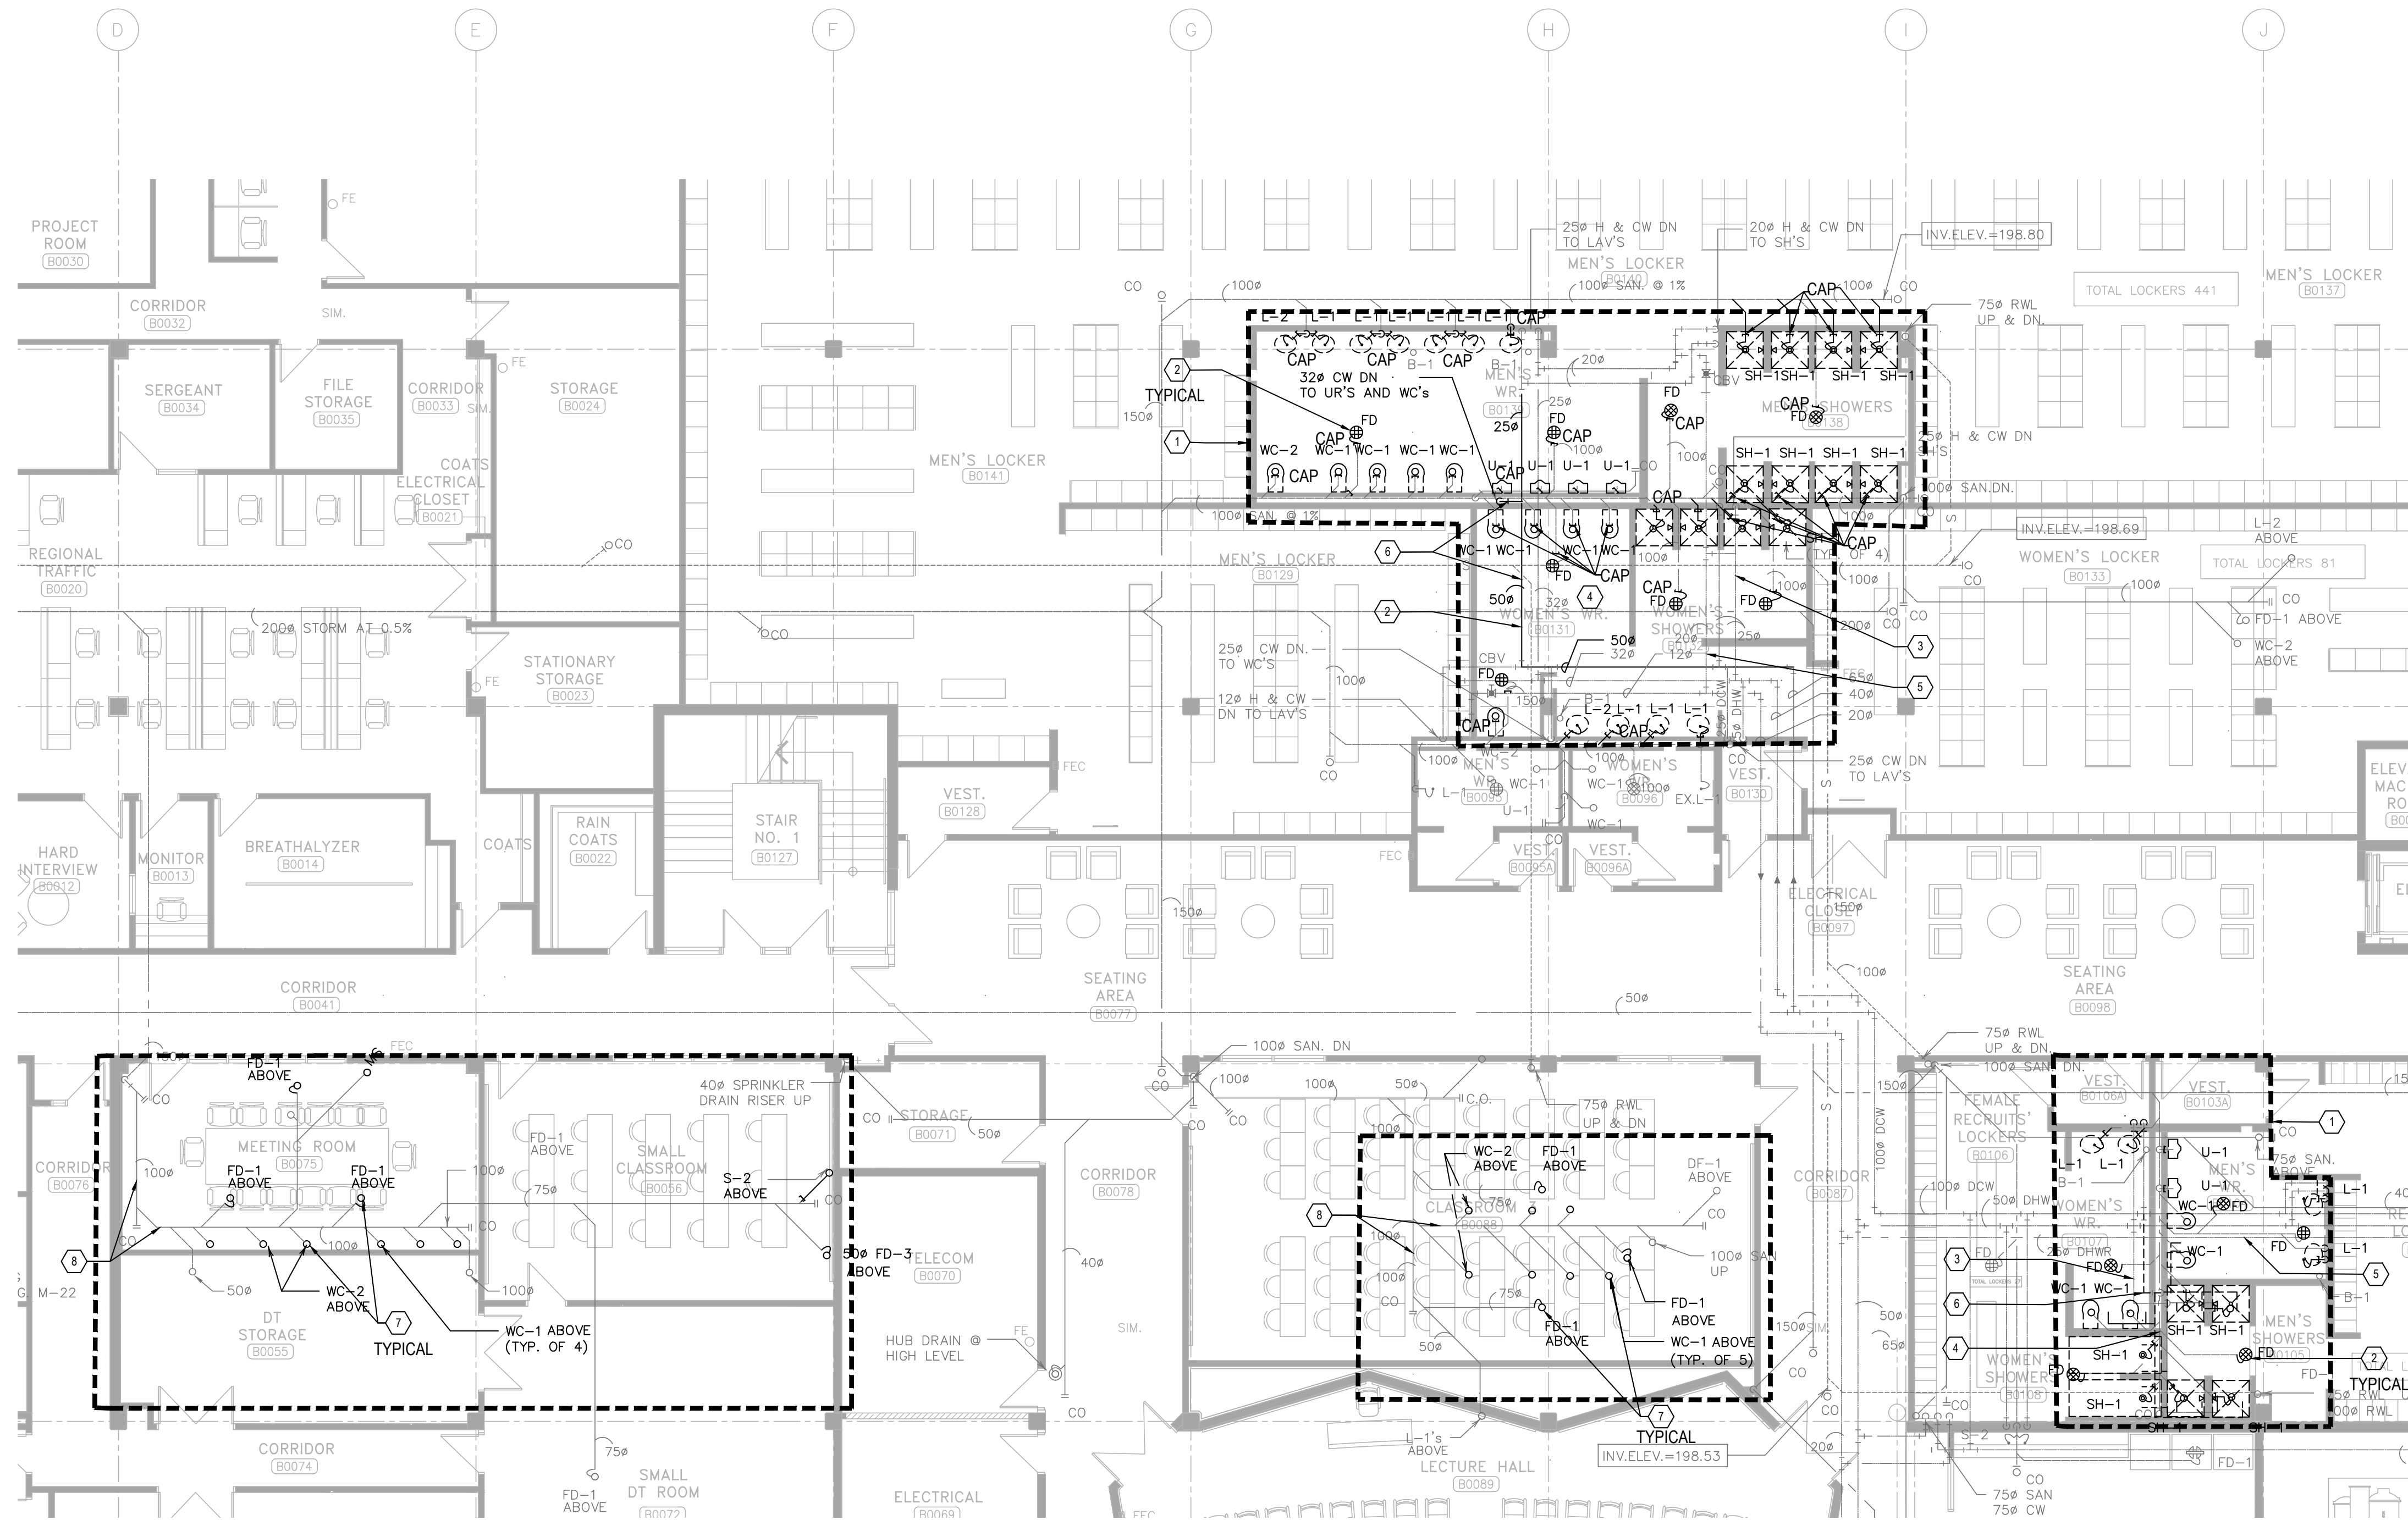

1
M301
SCALE: 1/32" = 1'-0"

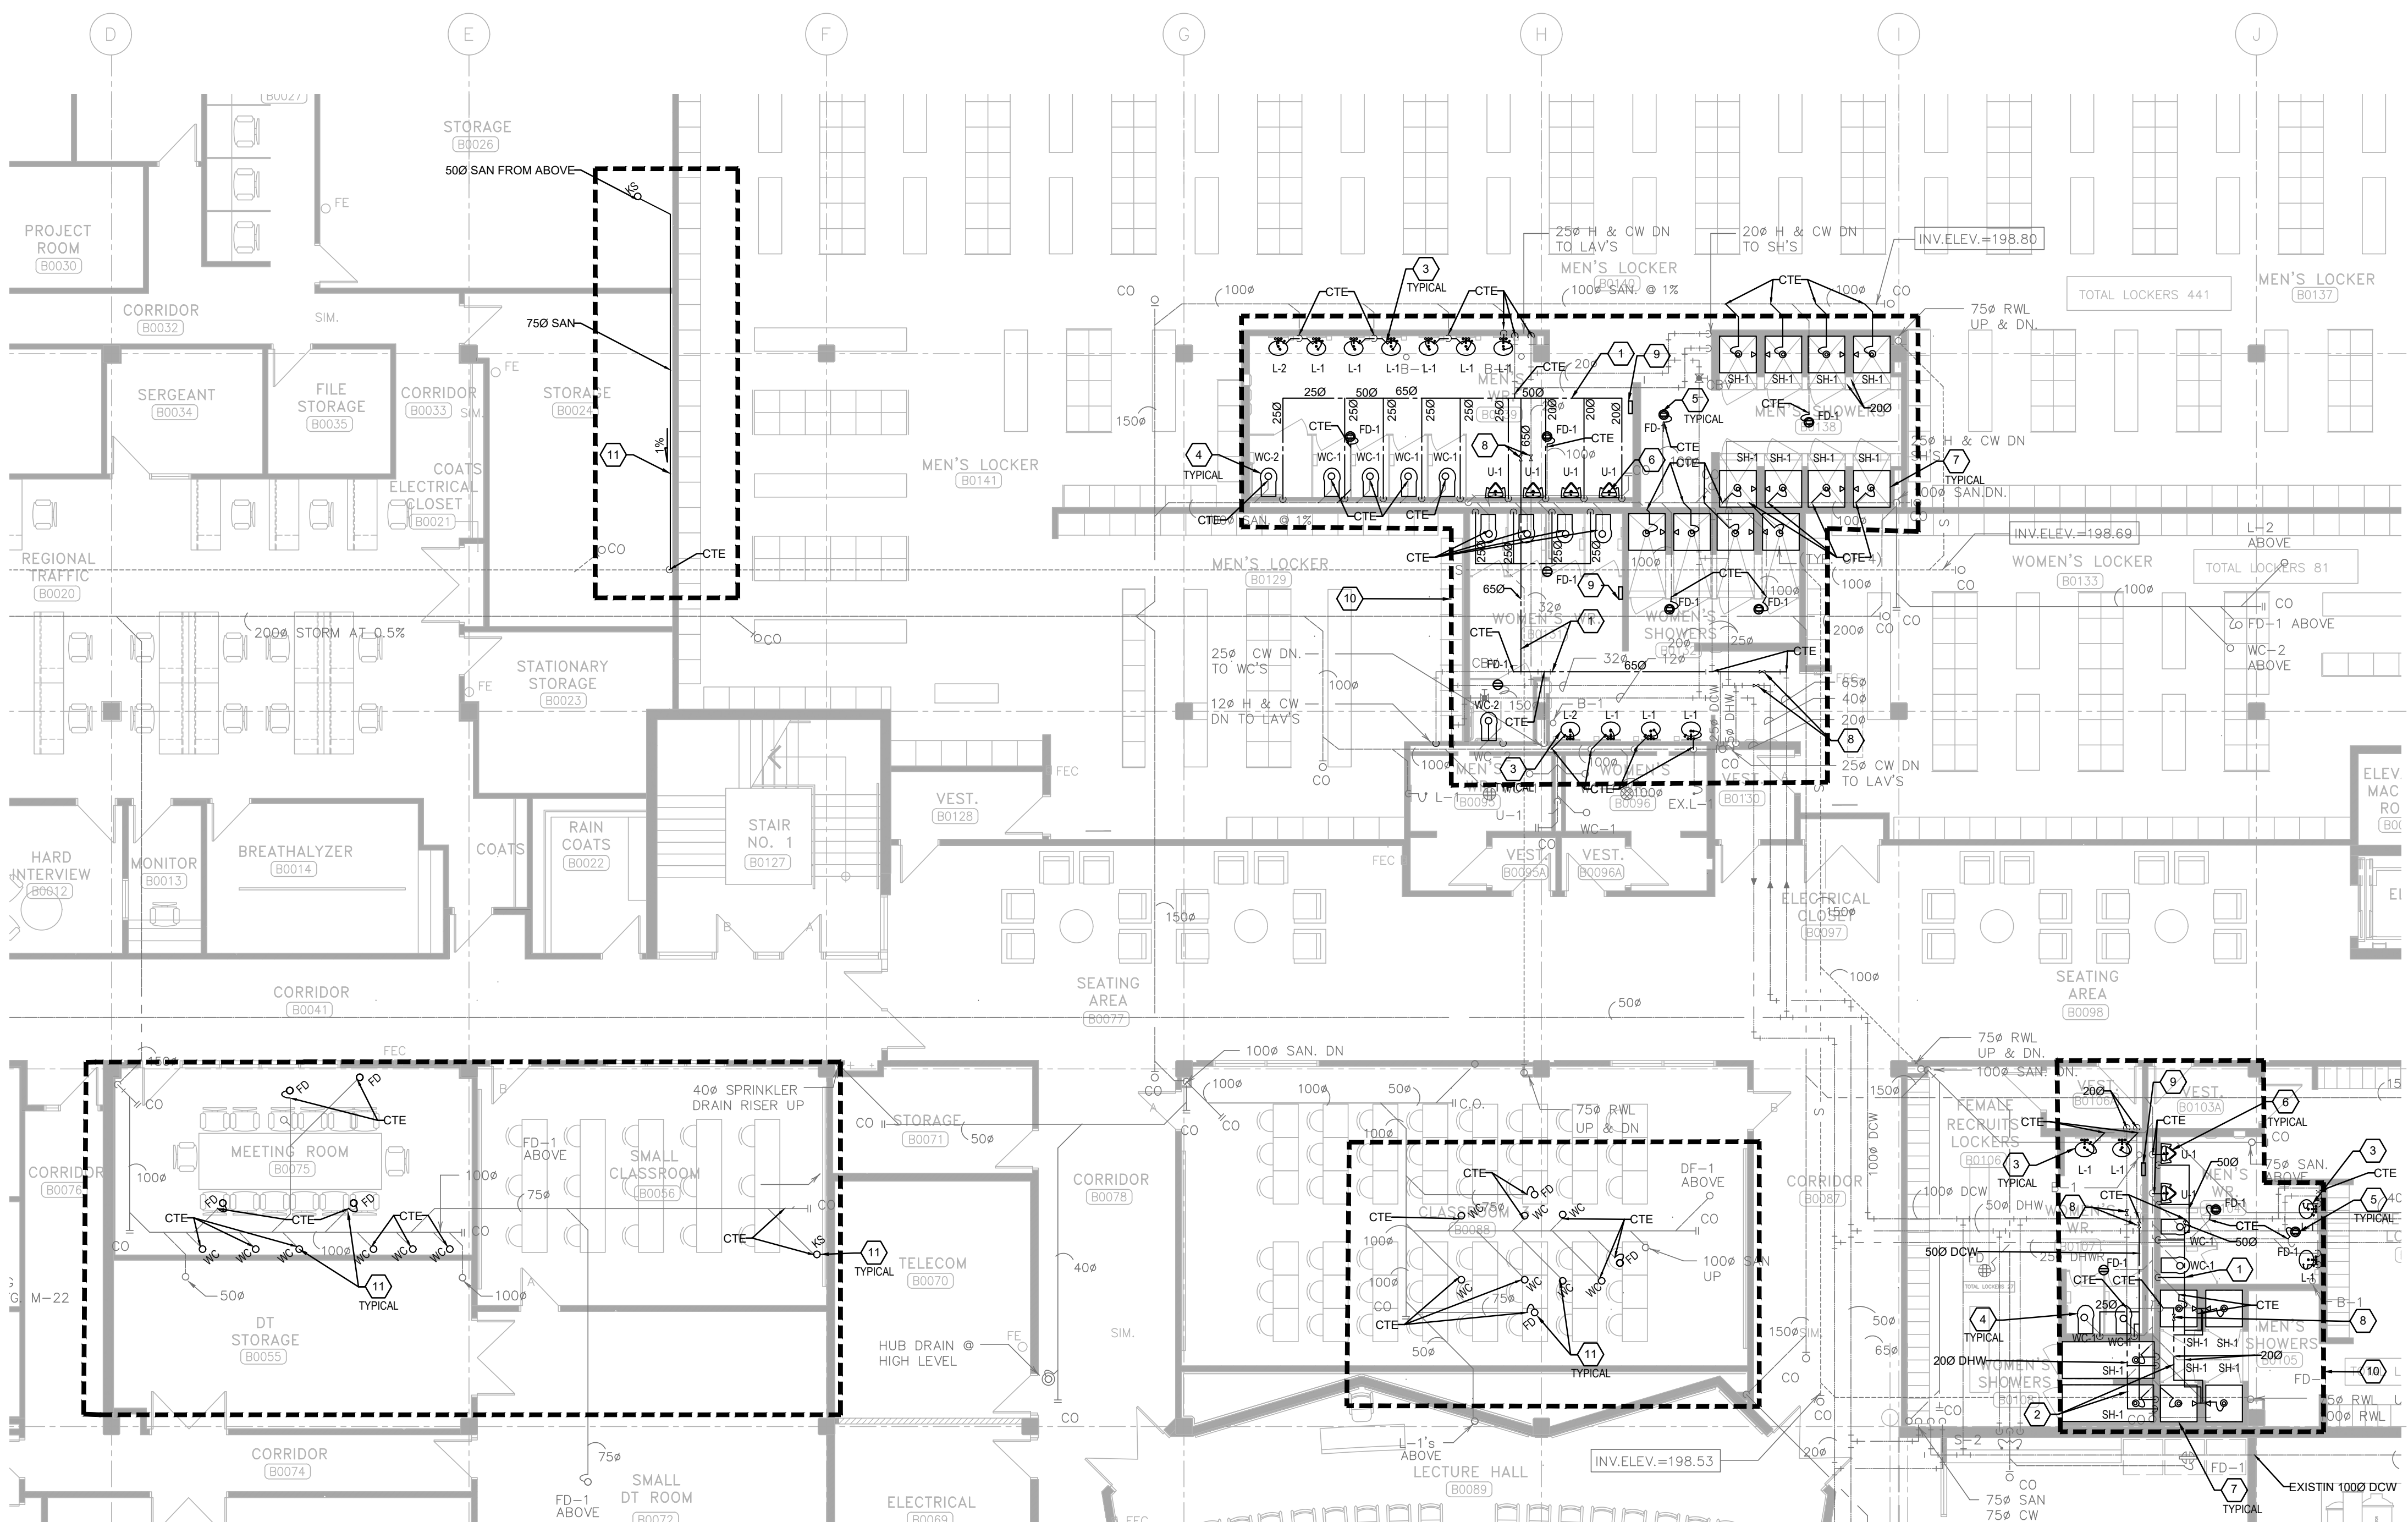

2
M301
SCALE: 1/32" = 1'-0"

PLUMBING GENERAL DEMO NOTES:

1. ALL EXISTING AND NEW PLUMBING PIPE SIZES SHOWN AS METRIC (MM).
2. PRIOR TO COMMENCEMENT OF THE WORK, ORDERING OF EQUIPMENT AND/OR FABRICATING MATERIALS, THE MECHANICAL CONTRACTOR SHALL VISIT THE SITE TO VERIFY EXISTING CONDITIONS. THIS SHALL BE DONE IN ORDER TO CONFIRM THAT EQUIPMENT AND SERVICES CAN BE INSTALLED AS SHOWN ON THE DRAWINGS. IT IS THE CONTRACTOR'S RESPONSIBILITY TO NOTIFY THE ENGINEER OF ANY DISCREPANCIES, OMISSIONS AND/OR INTERFERENCES PRIOR TO COMMENCEMENT OF THE WORK.
3. DEMOLITION DRAWINGS HAVE BEEN PREPARED AS A GENERAL GUIDE TO THE CONTRACTOR. NOT ALL SERVICES HAVE BEEN SHOWN. THE CONTRACTOR SHALL REMOVE ALL REDUNDANT SERVICES TO THE NEAREST ACTIVE REMAINING SOURCE, WHETHER THEY HAVE OR HAVE NOT BEEN SHOWN. NO EXTRAS WILL BE ENTERTAINED FOR DEMOLITION.
4. SOME DEMOLITION HAS BEEN SHOWN BASED ON EXISTING 'AS BUILT' DWG FROM ORIGINAL CONSTRUCTION AND VARIOUS KNOWN RETROFITS AND ALTERATIONS. NOT ALL SERVICES HAVE BEEN SHOWN. IT SHALL BE THE RESPONSIBILITY OF THE CONTRACTOR TO SURVEY THE SPACE AND VERIFY THE EXTENT OF DEMOLITION WORK INVOLVED.
5. UNLESS SPECIFICALLY SHOWN TO REMAIN ON THE DRAWINGS, REMOVE ALL EXISTING (SAN, V, ST, CW, HW, HWR, ETC.) PIPING, FITTINGS & FITTINGS, EQUIPMENT, SUPPORTS ETC. FROM AREA OF RENOVATION. ALLOW FOR CUTTING AND PATCHING OF CEILINGS AND WALLS NECESSARY TO REMOVE SERVICES IN THE EVENT THAT THE EXISTING CEILINGS OR WALLS ARE NOT BEING REMOVED BY THE GENERAL CONTRACTOR.
6. REMOVE PLUMBING FIXTURES AS SHOWN, CUT BACK DRAIN, VENT, WATER PIPING ETC. BACK TO RISER OR NEAREST ACTIVE SOURCE. COORDINATE WITH MAINTENANCE DEPARTMENT WHICH FIXTURES THEY WISH TO KEEP. TRANSPORT THOSE FIXTURE TO STORAGE. REMOVE AND DISPOSE ALL UNWANTED FIXTURES.
7. PRIOR TO DEMOLITION, COORDINATE SHUT DOWN WITH BUILDING OPERATION TEAM AND ISOLATE SERVICES. PHASING REQUIREMENTS OF PROJECT MAY REQUIRE SOME EXISTING SERVICE BE LEFT IN OPERATION UNTIL NEW SERVICES ARE INSTALLED. CAREFULLY REVIEW PHASING SET OUT BY ARCHITECT.
8. WHERE MECHANICAL EQUIPMENT (E.A.C. UNIT, ELECTRIC WATER HEATER, FAN, DISHWASHER/S) REMOVED, COORDINATE PROMPTLY WITH GENERAL CONTRACTOR AND ELEC. DIV. TO DISCONNECT AND MAKE SAFE THE ASSOCIATED POWER SUPPLY. MECH. DIV. 15 SHALL ENSURE THAT NO ABANDONED LIVE POWER CORD IS LEFT UNPROTECTED AT ANY TIME.
9. WHERE PIPE IS REMOVED THROUGH FIRE-RATED WALL OR FLOOR ASSEMBLIES, PROVIDE UL-C CLASSIFIED FIRE STOPPING SYSTEMS THAT ARE TESTED IN ACCORDANCE WITH CAN-515 AND INSTALL ALL FIRE STOPPING SYSTEM IN STRICT ACCORDANCE WITH THE MANUFACTURER'S INSTALLATION INSTRUCTION. STANDARD OF ACCEPTANCE: 3M, HILT.
10. DURING DEMOLITION, CONTRACTOR SHOULD INCLUDE VIDEO SCOPING FOR THE PLUMBING WORK. BEFORE AND AFTER CONSTRUCTION AND REPORT BACK TO ENGINEER FOR ANY DAMAGE, BROKEN, LEAKAGE AND ANY DISCREPANCIES. WHERE EXISTING PIPE INSULATIONS/DAMAGES FOUND TO REQUIRE REPAIR, RECORD THE EXTENT OF THE REPAIRS ON PLANS AND REPORT TO THE CLIENT/CONSULTANT.

PLUMBING DEMO DRAWING NOTES:

- ① DEMO SHALL EXISTING PLUMBING FIXTURES IN THIS SCOPE COMPLETE WITH ALL ASSOCIATED PLUMBING AND TRIMS, INCLUDING BUT NOT LIMITED TO DOMESTIC COLD/HOT WATER, VENT AND SANITARY. ALL PIPING SHALL BE CAPPED BACK TO MAIN AS INDICATED. FUTURE SANITARY DRAIN TO BE CUT BACK TO WALL FOR FUTURE CONNECTION. ISOLATION, HANGERS AND SUPPORT NOT BEING REUSED AS PART OF THIS CONTRACT. SEAL AND PATCH ALL WALL/FLOOR OPENING TO MATCH EXISTING OR FOLLOW THE ARCHITECT REQUIREMENT (TYPICAL).
- ② DEMOLISH EXISTING FLOOR DRAIN AND CAP BACK SANITARY DRAIN BACK TO MAIN AT SLAB. SEAL AND PATCH ALL WALL/FLOOR OPENING TO MATCH EXISTING OR FOLLOW THE ARCHITECT REQUIREMENT (TYPICAL).
- ③ EXISTING DOMESTIC HOT WATER (DHW) SUPPLY MAIN TO REMAIN.
- ④ EXISTING BURIED SANITARY DRAIN TO REMAIN.
- ⑤ EXISTING DHWR PIPING TO REMAIN.
- ⑥ EXISTING DOW PIPE TO BE REMOVED AND REPLACED WITH LARGER SIZE PIPE. REFER TO DRAWING ON NEW WORK PLAN.
- ⑦ EXISTING SANITARY DRAIN BRANCH SERVING ABOVE FLOOR TOILET, FLOOR DRAIN AND PENETRATING THE SLAB DOWN TO THIS FLOOR CEILING SPACE TO BE REMOVED AND CAPPED BACK TO MAIN (TYPICAL).
- ⑧ EXISTING SANITARY MAIN TO SERVING FUTURE FLOOR ABOVE TO REMAIN.

PLUMBING GENERAL NEW WORK NOTES:

1. ALL WORK SHALL BE DONE IN ACCORDANCE WITH THE REQUIREMENTS OF THE ONTARIO BUILDING CODE, MINISTRY OF THE ENVIRONMENT, MINISTRY OF LABOUR, NPLA BUILDING MANAGEMENTS GUIDELINES (REFER TO ARCH. SPEC).
2. ALL NEW SERVICES SHOWN ARE DIAGRAMMATIC ONLY. THE ARRANGEMENTS OF EQUIPMENT SHOWN ARE APPROXIMATE AND MAY BE ALTERED ON SITE TO MEET THE ON-SITE CONDITIONS OF THE PROJECT. CONTRACTOR TO REVIEW ALL THE EXISTING SERVICES AND COORDINATE WITH THE NEW INSTALLATION.
3. CONTRACTOR TO COORDINATE WITH THE BUILDING MANAGEMENT FOR APPROVAL OF ANY SHUT DOWN OF EXISTING SYSTEMS/SERVICES. THE CONTRACTOR SHALL DETERMINE THE BEST METHOD TO MINIMIZE SERVICE INTERRUPTION AND IMPACT ON FACILITY OPERATION, INCLUDING USE OF HOT TAP/TEMPORARY FREEZING AND AFTER-HOUR WORK AS REQUIRED. PROVIDE MIN. ONE WEEK NOTICE FOR BUILDING MANAGEMENT TO PLAN THE SHUT DOWN. CONTRACTOR TO ENSURE MIN. SHUTDOWNS.
4. CONTRACTOR TO ROUTE ANY EXISTING SERVICES IF REQUIRED TO INSTALL NEW SERVICES. ALL SERVICES SHALL BE INSTALLED USING EXISTING BEAM OPENINGS AS MUCH AS POSSIBLE. IN THE EVENT OF NO SPACE THROUGH BEAM OPENING, SERVICES SHALL BE INSTALLED AS HIGH AS POSSIBLE TO THE UNDERSIDE OF THE BEAM. COORDINATE ALL SERVICES PRIOR TO INSTALLATION. THE LOWER SERVICES INSTALLED WILL BE ASKED TO RELOCATE IF SPACE AVAILABLE AT HIGH LEVEL.
5. COORDINATE WITH ALL CONSULTANT DRAWINGS BEFORE ORDERING ANY NEW EQUIPMENT. GRILLES & DIFFUSERS, SPRINKLER HEADS ETC.
6. CONTRACTOR TO INCLUDE FOR ALL OFFSETS REQUIRED FOR COORDINATION WITHIN MECHANICAL AND ELECTRICAL SERVICES. THE OFFSET INCLUDES ALL HVAC, HYDRONICS, PLUMBING AND FIRE PROTECTION SERVICES.
7. THE DRAWINGS AND SPECIFICATIONS, PROVIDE THE MINIMUM PERFORMANCE REQUIREMENTS. THE FIRE PROTECTION SYSTEM SHALL BE PREPARED, COMPLETE, STAMPED, SIGNED, AND APPROVED BY A LICENSED SPRINKLER CONTRACTOR. IT IS THE CONTRACTOR'S RESPONSIBILITY TO PROVIDE THE FLOW TEST INFORMATION PRIOR TO PREPARATION OF DRAWINGS AND HYDRAULIC CALCULATIONS.
8. CONTRACTOR TO PROVIDE FIRE WATCH AS REQUIRED TO MAINTAIN FIRE SAFETY OF THE CONSTRUCTION SITE SCOPE AREA.
9. THE CONTRACTOR SHALL PROVIDE FIRE STOPPING ON ALL NEW PIPING AND CONDUIT PENETRATIONS THROUGH A FIRE-RATED WALL OR FLOOR AND ANY HOLES THAT RESULT FROM REMOVAL OF EXISTING SERVICES THROUGH A FIRE-RATED WALL OR FLOOR.
10. READ ALL THE DRAWINGS FOR COMPLETE INFORMATION.
11. INCLUDE FOR FREEZING OF ALL SERVICES WITH THE ASSUMPTION THAT NO VALVES WILL HOLD AND REPLACE ALL WITH NEW LEVER BALL VALVES (OR SCREW TYPE ONLY WHERE APPROPRIATE).
12. THE EXISTING SERVICES SHOWN ON THIS DRAWING HAVE BEEN TAKEN FROM THE ORIGINAL CONSTRUCTION DRAWINGS AND SITE SURVEYS. THE MECHANICAL CONTRACTOR SHALL CARRY OUT A FULL SURVEY OF ALL EXISTING SERVICES TO CONFIRM THE SIZE AND LOCATION OF THESE SERVICES BEFORE THE COMMENCEMENT OF ANY WORK.
13. THE CONTRACTOR SHALL VERIFY ALL EXISTING CONDITIONS PRIOR TO CUTTING EXISTING WALLS AND FLOOR SLAB. IF EXISTING SERVICES ARE OUTDAMAGED IT IS THE CONTRACTOR'S RESPONSIBILITY TO PATCH AND REPAIR THE SERVICE.
14. THE CONTRACTOR SHALL MAINTAIN CONTINUOUS OPERATION OF PLUMBING STACKS AND WATER SUPPLY MAINS THAT REQUIRE OFFSETTING AND MAKE ANY NEW CONNECTIONS RESPECTIVELY DURING CONSTRUCTION PERIOD.
15. THE CONTRACTOR SHALL COORDINATE WITH OTHER TRADES FOR FINAL SERVICE ROUTING ON SITE.
16. CONTRACTOR TO ALLOW ADDITIONAL 20 PIPE HANGERS/FLOOR AND SUPPORTS ON EXISTING PIPING IF NECESSARY. THE CREDIT FOR THE HANGERS SHALL BE GIVEN BACK TO THE BUILDING MANAGEMENT IF NOT USED.
17. CONTRACTOR TO ALLOW FOR INSULATION ON EXISTING PIPING IF IT IS DAMAGED OR MISSED.
18. CAP ALL OBSOLETE WASTE PIPING BELOW THE SLAB. WATER PIPING BACK AT MAINS AND VENT PIPING ABOVE FINISHED CEILINGS. PATCH ALL FLOORS, WALL AND CEILINGS AS REQUIRED TO MEET FIRE RATINGS.
19. FOR DUST CONTROL, CAP EXISTING DUCTS IN THE CONSTRUCTION AREA. CONNECTION TO EXISTING AIR DUCTS TO BE DONE AFTER COMPLETION OF ALL DUST PROOFING TASKS.
20. REMOVE ALL REDUNDANT PIPES, CONDUITS, INCLUDING LOOSE WIRES AND DUCTWORK. CAP AT MAIN.
21. COORDINATE WITH BUILDING OPERATION TEAM FOR SHUT DOWN AND DRAINING FIRE LINE PRIOR TO COMMENCING NEW WORK. PROVIDE FIRE WATCH AS REQUIRED TO ENSURE BUILDING SAFETY DURING SPRINKLER MAIN PIPE REMOVAL.
22. CONTRACTOR TO PROVIDE TRAP SEAL PRIMER AND PIPING SYSTEM PER OBC PART 7.
23. CONTRACTOR TO PROVIDE SANITARY VENT PIPE PER OBC PART 7 REQUIREMENT WITHIN WET WALL AND UP TO CEILING TO CONNECT TO EXISTING BUILDING VENT MAIN. CONTRACTOR TO VERIFY THE EXISTING AVAILABLE VENT PIPE LOCATION AND THE EXACT CONNECT POINT ON SITE.
24. ALL SERVICES WITHIN THE CEILING SPACE SHALL BE OUTSIDE THE SHAFT AND ALL SERVICES BELOW CEILING SHALL BE CAPPED WITHIN THE SHAFT ENCLOSURE CONTRACTOR TO COORDINATE THE SHAFT OPENING SIZE.

PLUMBING NEW WORK DRAWING NOTES:

- ① PROVIDE NEW DOMESTIC COLD WATER PIPE (DCW) C/W INSULATION AND ALL ACCESSORIES FROM DOW SUPPLY RISER WITHIN CEILING SPACE TO SERVE NEW PLUMBING FIXTURES AS SHOWN.
- ② PROVIDE NEW DOMESTIC HOT WATER PIPE (DHW) C/W INSULATION AND ALL ACCESSORIES FROM EXISTING DHWR SUPPLY MAIN WITHIN CEILING SPACE TO SERVE PLUMBING FIXTURE AS SHOWN.
- ③ NEW LAVATORY: PROVIDE NEW 150 HOT AND COLD WATER LINES, 328 VENT LINE AND 408 SANITARY LINE FROM 1'-11 1/2" TO THE BACK TO EXISTING DOW, DHW AND SANITARY DRAIN BRANCH BACK TO THE WALL. ALLOW FOR CUTTING AND PATCHING WALL, FLOOR, CEILING ON FLOOR ABOVE AS NEEDED. (TYPICAL). CONTRACTOR TO VERIFY THE EXACT CONNECTION POINT AND COORDINATE ON SITE. (TYPICAL).
- ④ NEW FLOOR MOUNTED TOILET TO REPLACE EXISTING AT SAME LOCATION. PROVIDE 208 COLD WATER LINE DOWN TO NEW WC-11 WC-2, 500 VENT LINE UP FROM WC-11 WC-2 AND 750 SANITARY LINE DOWN FROM WC-11 WC-2 TO EXISTING DRAIN BRANCH. ALLOW FOR CUTTING AND PATCHING WALL, FLOOR AND CEILING ON FLOOR BELOW AS NEEDED. ALLOW FOR X-RAY/SCANNING, TRENCHING, AND BACKFILL OF EXISTING FLOOR SLAB CONTRACTOR TO VERIFY THE EXACT CONNECTION POINT AND COORDINATE ON SITE. (TYPICAL).
- ⑤ NEW FLOOR DRAIN 'FD-1', PROVIDE NEW DRAIN TRAP AND 1000 DRAIN BRANCH TIE BACK TO EXISTING BURIED SANITARY DRAIN. CONTRACTOR TO VERIFY THE EXACT CONNECTION POINT AND COORDINATE ON SITE. (TYPICAL).
- ⑥ NEW WALL MOUNTED URINAL AT SAME LOCATION TO REPLACE EXISTING. PROVIDE 308 COLD WATER LINE DOWN TO NEW U-1, 408 VENT LINE UP FROM U-1 AND 500 SANITARY LINE DOWN FROM U-1 AND TIE BACK TO EXISTING SANITARY DRAIN IN WALL. ALLOW FOR CUTTING AND PATCHING WALL, FLOOR AND CEILING ON FLOOR BELOW AS NEEDED. ALLOW FOR X-RAY/SCANNING, TRENCHING, AND BACKFILL OF EXISTING FLOOR SLAB. CONTRACTOR TO VERIFY THE EXACT CONNECTION POINT AND COORDINATE ON SITE. (TYPICAL).
- ⑦ NEW SHOWER BOTH AND SHOWER HEAD. PROVIDE 120 HOT AND COLD WATER LINES DOWN TO NEW 'SH-1' SH-2, 1-1/4" VENT LINE UP FROM 'SH-1' SH-2 AND 750 SANITARY LINE DOWN FROM 'SH-1' SH-2 AND TIE BACK TO EXISTING BURIED SANITARY DRAIN. ALLOW FOR CUTTING AND PATCHING WALL, FLOOR AND CEILING ON FLOOR BELOW AS NEEDED. ALLOW FOR X-RAY/SCANNING, TRENCHING, AND BACKFILL OF EXISTING FLOOR SLAB. CONTRACTOR TO VERIFY THE EXACT CONNECTION POINT AND COORDINATE ON SITE. (TYPICAL).
- ⑧ PROVIDE NEW SHUTOFF VALVE IN NEW OR EXISTING DOW/DHW LINE AS INDICATED ON THE PLAN. (TYPICAL).
- ⑨ PROVIDE ELECTRONIC TYPE TRAP SEAL PRIMER AS PER OBC PART 7 REQUIREMENT. FINAL LOCATION TO BE COORDINATE ON SITE (TYPICAL).
- ⑩ PROVIDE SANITARY VENT PIPE PER OBC PART 7 REQUIREMENT WITHIN WET WALL AND UP TO CEILING TO CONNECT TO EXISTING BUILDING VENT MAIN. CONTRACTOR TO VERIFY THE EXISTING AVAILABLE VENT PIPE LOCATION AND THE EXACT CONNECT POINT ON SITE (TYPICAL).
- ⑪ INSTALL NEW SANITARY DRAIN FROM FLOOR ABOVE BY PENETRATING THE SLAB AND CONNECTING IT TO THE EXISTING SANITARY MAIN BRANCH IN THE CEILING SPACE. THE CONTRACTOR MUST COORDINATE AND ADJUST THE PENETRATION POINTS AS NECESSARY TO ACCOMMODATE THE NEW FIXTURES. ALL FLOOR AND SLAB OPENINGS MUST BE PATCHED AND SEALED TO MATCH THE EXISTING FINISH OR MEET THE ARCHITECT'S SPECIFICATIONS. THIS REQUIREMENT APPLIES TO ALL SUCH INSTALLATIONS.

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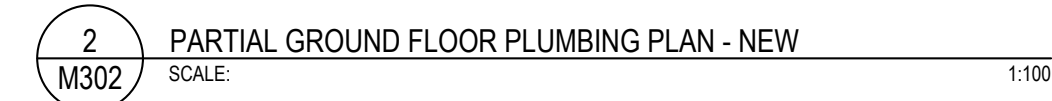
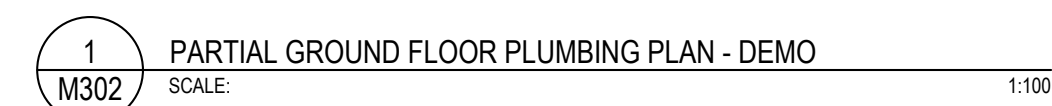
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	PEEL REGIONAL POLICE
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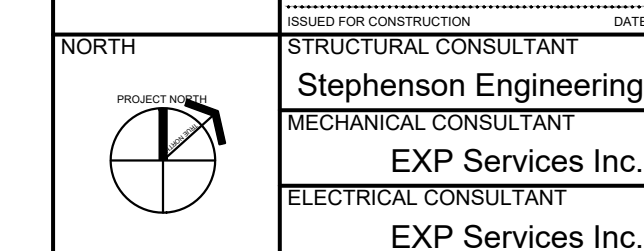
1. ALL EXISTING AND NEW PLUMBING PIPE SIZES SHOWN AS METRIC (MM).
2. PRIOR TO COMMENCEMENT OF THE WORK, ORDERING OF EQUIPMENT AND/OR FABRICATING MATERIALS, THE MECHANICAL CONTRACTOR SHALL VISIT THE SITE TO VERIFY EXISTING CONDITIONS. THIS SHALL BE DONE IN ORDER TO CONFIRM THAT EQUIPMENT AND SERVICES CAN BE INSTALLED AS SHOWN ON THE DRAWINGS. IT IS THE CONTRACTOR'S RESPONSIBILITY TO NOTIFY THE ENGINEER OF ANY DISCREPANCIES, OMISSIONS AND/OR INTERFERENCE PRIOR TO COMMENCEMENT OF THE WORK.
3. DEMOLITION DRAWINGS HAVE BEEN PREPARED AS A GENERAL GUIDE TO THE CONTRACTOR. NOT ALL SERVICES HAVE BEEN SHOWN. THE CONTRACTOR SHALL REMOVE ALL REDUNDANT SERVICES TO THE NEAREST ACTIVE REMAINING SOURCE. WHETHER THEY HAVE OR HAVE NOT BEEN SHOWN. NO EXTRAS WILL BE ENTERTAINED FOR DEMOLITION.
4. SOME DEMOLITION HAS BEEN SHOWN BASED ON EXISTING AS-BUILT DATA FROM ORIGINAL CONSTRUCTION AND VARIOUS KNOWN RETROFITS AND ALTERATIONS. NOT ALL SERVICES HAVE BEEN SHOWN. IT SHALL BE THE RESPONSIBILITY OF THE CONTRACTOR TO SURVEY THE SPACE AND VERIFY EXTENT OF DEMOLITION WORK INVOLVED.
5. UNLESS SPECIFICALLY SHOWN TO REMAIN ON THE DRAWINGS, REMOVE ALL EXISTING GAS (N, V, ST, CW, HW, HWR, ETC), PIPING FIXTURES & FITTINGS, EQUIPMENT, SUPPORTS ETC. FROM AREA OF GENERAL ALLOW FOR CUTTING AND PATCHING OF CEILINGS AND WALLS NECESSARY TO REMOVE SERVICES. IT IS THE EXISTING CEILINGS OR WALLS ARE NOT BEING REMOVED BY THE GENERAL CONTRACTOR.
6. REMOVE PLUMBING FIXTURES AS SHOWN. CUT BACK DRAIN, VENT, WATER PIPING ETC. BACK TO RISER OR NEAREST ACTIVE SOURCE. COORDINATE WITH MAINTENANCE DEPARTMENT WHICH FIXTURES THEY WISH TO KEEP. TRANSPORT THOSE FIXTURE TO STORAGE. REMOVE AND DISPOSE ALL UNWANTED FIXTURES.
7. PRIOR TO DEMOLITION, COORDINATE SHUT DOWN WITH BUILDING OPERATION TEAM AND ISOLATE SERVICES. PHASING REQUIREMENTS OF PROJECT MAY REQUIRE SOME EXISTING SERVICE BE LEFT IN OPERATION UNTIL NEW SERVICES ARE INSTALLED. CAREFULLY REVIEW PHASING SET OUT BY ARCHITECT.
8. WHERE MECHANICAL EQUIPMENT IS: A/C UNIT, ELECTRIC WATER HEATER, FAN, DISHWASHERS REMOVED; COORDINATE PROMPTLY WITH GENERAL CONTRACTOR AND ELEC. DIV. TO DISCONNECT AND MAKE SAFE TIED ASSOCIATED POWER SUPPLY. MECH. DIV. IS, SHALL ENSURE THAT NO ABANDONED LIVE POWER CORE IS LEFT UNPROTECTED AT ANY TIME.
9. WHERE PIPE IS REMOVED THROUGH FIRE-RATED WALL OR FLOOR ASSEMBLIES, PROVIDE UL-Classified FIRE STOPPING SYSTEMS THAT ARE TESTED IN ACCORDANCE WITH CAN4-S115 AND INSTALL ALL FIRE STOPPING SYSTEM IN STRICT ACCORDANCE WITH THE MANUFACTURER'S INSTALLATION INSTRUCTION. STANDARD OF ACCEPTANCE: 30, MILTI.
10. DURING DEMOLITION, CONTRACTOR SHOULD INCLUDE VIDEO SCOPING FOR THE PLUMBING WORK. BEFORE AND AFTER CONSTRUCTION AND REPORT BACK TO ENGINEER FOR ANY DAMAGE, LEAKAGE AND/OR DISCREPANCIES. WHERE EXISTING PIPE INSULATIONS/ DAMAGES FOUND TO REQUIRE REPAIR, RECORD THE EXTENT OF THE REQUIRES REPAIR ON PLANS AND REPORT TO THE CLIENT/CONSULTANT.

- ① DEMOLISH ALL EXISTING PLUMBING FIXTURES IN THE SCOPE COMPLETE WITH ALL ASSOCIATED PLUMBING AND TRIM, INCLUDING BUT NOT LIMITED TO DOMESTIC COLD HOT WATER, VENT AND SANITARY. ALL DOWN DRAIN BRANCH PIPING SHALL BE CAPPED BACK TO THE CEILING AND BRANCH SANITARY DRAIN SHALL BE CUT BACK TO WALL FOR FUTURE CONNECTION. TOILET SANITARY DRAIN CAP BACK TO THE FLOOR BELOW AT MAIN. FOR FUTURE CONNECTION. INSULATION, HANGERS AND SUPPORT NOT BE REUSED AS PART OF THIS CONTRACT. SEAL AND PATCH ALL WALLS LOOSE DROPPING TO MATCH EXISTING OR FOLLOW THE APPLICABLE REQUIREMENT. TYPICAL.
- ② EXISTING EYE WASH STATION AND ALL ACCESSORIES TO REMAIN.
- ③ DEMOLISH EXISTING DOW SUPPLY MAIN BRANCH AS INDICATED ON THE PLAN. PROVIDE NEW SIZE DOW PIPE AND RISER AS INDICATED ON NEW WORK PLAN.
- ④ EXISTING DRAIN, DRAIN DISTRIBUTION MAIN BRANCH TO REMAIN.
- ⑤ EXISTING SANITARY DRAIN BRANCH SERVING ABOVE FLOOR TOILET, FLOOR DRAIN, MOP DRAIN TO BE REMOVED AND CAPPED BACK TO MAIN AS SHOWN(TYPICAL).
- ⑥ EXISTING MOP SINK REMAIN.
- ⑦ EXISTING DRINK FOUNTAIN TO REMAIN.
- ⑧ EXISTING SANITARY, DRAIN, DRAIN RISER IN PIPE CHASE TO REMAIN.
- ⑨ REMOVE EXISTING FLOOR DRAIN, CAP SANITARY DRAIN BACK TO MAIN ON CEILING SPACE AT FLOOR BELOW FOR FUTURE CONNECTION. TYPICAL.
- ⑩ DEMOLISH EXISTING DOW, DRAIN, DRAIN SUPPLY MAIN BRANCH AS INDICATED ON THE PLAN.
- ⑪ DEMOLISH EXISTING KITCHEN SINK WITH ALL ASSOCIATED PLUMBING AND TRIM, INCLUDING BUT NOT LIMITED TO DOMESTIC COLD HOT WATER, VENT AND SANITARY. ALL DOW DRAIN, DRAIN BRANCH PIPING SHALL BE CAPPED BACK TO WALL. SANITARY DRAIN TO BE CUT BACK TO WALL, CHASE FOR FUTURE CONNECTION.

1. ALL WORK SHALL BE DONE IN ACCORDANCE WITH THE REQUIREMENTS OF THE ONTARIO BUILDING CODE, MINISTRY OF THE ENVIRONMENT, MINISTRY OF LABOUR, NPFA, BUILDING MANAGEMENT'S GUIDELINES (REFER TO ARCH. SPEC).
2. ALL NEW SERVICES SHOWN ARE DIAGRAMMATIC ONLY. THE ARRANGEMENTS OF EQUIPMENT SHOWN ARE APPROXIMATE AND MAY BE ALTERED ON SITE TO MEET THE ON-SITE CONDITIONS OF THE PROJECT. CONTRACTOR TO REVIEW ALL THE EXISTING SERVICES AND COORDINATE WITH THE NEW INSTALLATION.
3. CONTRACTOR TO COORDINATE WITH THE BUILDING MANAGEMENT FOR APPROVAL OF ANY SHUT DOWN OF EXISTING SYSTEMS/SERVICES. THE CONTRACTOR SHALL DETERMINE THE BEST METHOD TO MINIMIZE SERVICE INTERRUPTION AND IMPACT ON FACILITY OPERATION, INCLUDING USE OF HOT TAP/TEMPERATURE FREEZING AND AFTER-HOUR WORK AS REQUIRED. PROVIDE MIN. ONE WEEK NOTICE FOR BUILDING MANAGEMENT TO PLAN THE SHUT DOWN. CONTRACTOR TO ENSURE MIN. SHUTDOWNS.
4. CONTRACTOR TO REROUTE ANY EXISTING SERVICES IF REQUIRED TO INSTALL NEW SERVICES. ALL SERVICES SHALL BE INSTALLED USING EXISTING BEAM OPENINGS AS MUCH AS POSSIBLE. IN THE EVENT OF NO SPACE THROUGH BEAM OPENING, SERVICES SHALL BE INSTALLED AS HIGH AS POSSIBLE TO THE UNDERSIDE OF THE BEAM. COORDINATE ALL SERVICES PRIOR TO INSTALLATION. THE LOWER SERVICES INSTALLED WILL BE ASKED TO RELOCATE IF SPACE AVAILABLE AT HIGH LEVEL.
5. COORDINATE WITH ALL CONSULTANT DRAWINGS BEFORE ORDERING ANY NEW EQUIPMENT. GRILLES & DIFFUSERS, SPRINKLER HEADS ETC.
6. CONTRACTOR TO INCLUDE FOR ALL OFFSETS REQUIRED FOR COORDINATION WITH MECHANICAL AND ELECTRICAL SERVICES. THE OFFSETTING INCLUDES ALL HVAC, HYDRAONICS, PLUMBING AND FIRE PROTECTION SERVICES.
7. THE DRAWINGS AND SPECIFICATIONS ARE PROVIDING THE MINIMUM PERFORMANCE REQUIREMENTS. THE FIRE PROTECTION SYSTEM SHALL BE PREPARED: COMPLETE, STAMPED, SIGNED AND APPROVED BY A LICENSED SPRINKLER CONTRACTOR. IT IS THE CONTRACTOR'S RESPONSIBILITY FOR THE FLOW TEST INFORMATION PRIOR TO PREPARATION OF DRAWINGS AND HYDRAULIC CALCULATIONS.
8. CONTRACTOR TO PROVIDE FIRE WATCH AS REQUIRED TO MAINTAIN FIRE SAFETY OF THE CONSTRUCTION SITE SCOPE AREA.
9. THE CONTRACTOR SHALL PROVIDE FIRE PROTECTION ON ALL NEW PIPING AND COLD PENETRATIONS THROUGH A FIRE-RATED WALL OR FLOOR AND ANY HOLES THAT RESULT FROM REMOVAL OF EXISTING SERVICES THROUGH A FIRE-RATED WALL OR FLOOR.
10. READ ALL THE DRAWINGS FOR COMPLETE INFORMATION.
11. INCLUDE FOR FREEZING OF ALL SERVICES WITH THE ASSUMPTION THAT NO VALVES WILL HOLD AND REPLACE ALL WITH NEW LEVER BALL VALVES (OR SCREW TYPE ONLY WHERE APPROPRIATE).
12. THE EXISTING SERVICES SHOWN ON THIS DRAWING HAVE BEEN TAKEN FROM THE ORIGINAL CONSTRUCTION DRAWINGS AND SITE SURVEYS. THE MECHANICAL SHALL CARRY OUT A FULL SURVEY OF EXISTING SERVICES TO CONFIRM THE SIZE AND LOCATION OF THESE SERVICES BEFORE THE COMMENCEMENT OF ANY WORK.
13. THE CONTRACTOR SHALL VERIFY ALL EXISTING CONDITIONS PRIOR TO CUTTING EXISTING WALLS AND FLOOR SLAB. IF EXISTING SERVICES ARE CUT/DAMAGED IT IS THE CONTRACTOR'S RESPONSIBILITY TO PATCH AND REPAIR THE SERVICE.
14. THE CONTRACTOR SHALL MAINTAIN CONTINUOUS OPERATION OF PLUMBING STACKS AND WATER SUPPLY MAINS THAT REQUIRE OFFSETTING AND MAKE ANY NEW CONNECTIONS RESPECTIVELY DURING CONSTRUCTION PERIOD.
15. THE CONTRACTOR SHALL COORDINATE WITH OTHER TRADES FOR FINAL SERVICE ROUTING ON SITE.
16. CONTRACTOR TO ALLOW ADDITIONAL 20 PIPE HANGERS/FOUR INCH SUPPORTS ON EXISTING PIPING IF NECESSARY. THE CREDIT FOR THE HANGERS SHALL BE GIVEN BACK TO THE BUILDING MANAGEMENT IF NOT USED.
17. CONTRACTOR TO ALLOW FOR INSULATION ON EXISTING PIPING IF IT IS DAMAGED OR MISSED.
18. CAP ALL OBSOLETE WASTE PIPING BELOW THE SLAB. WATER PIPING BACK AT MANS AND VENT PIPING ABOVE FINISHED CEILINGS. PATCH ALL FLOORS, WALL AND CEILINGS AS REQUIRED TO MEET FIRE RATINGS.
19. FOR DUST CONTROL, CAP EXISTING DUCTS IN THE CONSTRUCTION AREA. CONNECTION TO EXISTING AIR DUCTS TO BE DONE AFTER COMPLETION OF ALL DUST PRODUCING TASKS.
20. REMOVE ALL REDUNDANT PIPES, CONDUITS, INCLUDING LOOSE WIRES AND DUCTWORK, CAP AT MAN.
21. COORDINATE WITH BUILDING OPERATION TEAM FOR SHUT DOWNS AND DRAINING FIRE LINE PRIOR TO COMMENCING NEW WORK. PROVIDE FIRE WATCH AS REQUIRED TO ENSURE BUILDING SAFETY DURING SPRINKLER MAIN PIPE REMOVAL.
22. CONTRACTOR TO PROVIDE TRAP SEAL PRIMER AND PIPING SYSTEM PER OBC PART 7.
23. CONTRACTOR TO PROVIDE SANITARY VENT PIPE PER OBC PART 7 REQUIREMENT WITHIN WET WALL AND UP TO CEILING TO CONNECT TO EXISTING BUILDING VENT MAIN. CONTRACTOR TO VERIFY THE EXISTING AVAILABLE VENT PIPE LOCATION AND THE EXACT CONNECT POINT ON SITE.
24. ALL SERVICES WITHIN THE CEILING SPACE SHALL BE OUTSIDE THE SHIELD AND ALL SERVICES BELOW CEILING SHALL BE CAPED WITHIN THE SHIELD ENCLOSURE. CONTRACTOR TO COORDINATE THE SHIELD OPENING SIZE.

- 1 PROVIDE NEW DOMESTIC COLD WATER PIPE (DOW) CW INSULATION AND ALL ACCESSORIES FROM DOW SUPPLY RISER WITHIN CEILING SPACE TO SERVE NEW PLUMBING FIXTURES AS SHOWN.
- 2 PROVIDE NEW DOMESTIC HOT WATER PIPE (DHW) HW INSULATION AND ALL ACCESSORIES FROM EXISTING DHW SUPPLY MAIN WITHIN CEILING SPACE TO SERVE PLUMBING FIXTURE AS SHOWN.
- 3 NEW LAVATORY, PROVIDE NEW 150 HOT AND COLD WATER LINES, 320 VENT LINE AND 400 SANITARY LINE DOWN FROM 1'-17L-2 TO THE BACK TO EXISTING DOW, DHW AND SANITARY DRAIN BRANCH BACK TO THE WALL, ALLOW FOR CUTTING AND PATCHING WALL, FLOOR, CEILING ON FLOOR ABOVE AS NEEDED. (TYPICAL). CONTRACTOR TO VERIFY THE EXACT CONNECTION POINT AND COORDINATE ON SITE. (TYPICAL).
- 4 NEW FLOOR MOUNTED TOILET TO REPLACE EXISTING AT SAME LOCATION. PROVIDE 250 COLD WATER LINE DOWN TO NEW WC-11 WC-2, 500 VENT LINE UP FROM WC-11 WC-2 AND 750 SANITARY LINE DOWN FROM WC-11 WC-2 TO EXISTING DRAIN. ALLOW FOR CUTTING AND PATCHING WALL, FLOOR AND CEILING ON FLOOR ABOVE AS NEEDED. ALLOW FOR X-RAY/SCANNING OF EXISTING FLOOR SLAB. CONTRACTOR TO VERIFY THE EXACT CONNECTION POINT AND COORDINATE ON SITE. (TYPICAL).
- 5 NEW FLOOR DRAIN 75-1. PROVIDE NEW DRAIN TRAP AND 1000 DRAIN BRANCH THE BACK TO EXISTING SANITARY DRAIN AT FLOOR LEVEL. CONTRACTOR TO VERIFY THE EXACT CONNECTION POINT AND COORDINATE ON SITE. ALLOW FOR X-RAY/SCANNING OF EXISTING FLOOR SLAB. ALLOW FOR CUTTING AND PATCHING WALL, FLOOR AND CEILING ON FLOOR ABOVE AS NEEDED. (TYPICAL).
- 6 NEW WALL MOUNTED URINAL AT SAME LOCATION TO REPLACE EXISTING. PROVIDE 200 COLD WATER LINE DOWN TO NEW U-1, 400 VENT LINE UP FROM U-1 AND 500 SANITARY LINE DOWN FROM U-1 TO THE BACK TO EXISTING SANITARY DRAIN IN WALL. ALLOW FOR CUTTING AND PATCHING WALL, FLOOR AND CEILING ON FLOOR ABOVE AS NEEDED. ALLOW FOR X-RAY/SCANNING OF EXISTING FLOOR SLAB. CONTRACTOR TO VERIFY THE EXACT CONNECTION POINT AND COORDINATE ON SITE. (TYPICAL).
- 7 PROVIDE NEW SHUTOFF VALVE IN NEW OR EXISTING DOW/DHW LINE AS INDICATED ON THE PLAN. (TYPICAL).
- 8 PROVIDE ELECTRONIC TYPE TRAP SEAL PRIMER AS PER CBC PART 7 REQUIREMENT. FINAL LOCATION TO BE COORDINATE ON SITE (TYPICAL).
- 9 PROVIDE SANITARY VENT PIPE PER CBC PART 7 REQUIREMENT WITHIN VENT WALL AND UP TO CEILING TO CONNECT TO EXISTING BUILDING VENT MAIN. CONTRACTOR TO VERIFY THE EXISTING AVAILABLE VENT PIPE LOCATION AND THE EXACT CONNECTION POINT ON SITE. (TYPICAL).
- 10 PROVIDE SHUT-OFF VALVE FOR ALL THE NEW PLUMBING FIXTURES DOW/DHW SUPPLY BRANCH. (TYPICAL).
- 11 PROVIDE WALL MOUNTED 150 HOSE BIB AND ASSOCIATE DOW PIPE SUPPLY. (TYP. OF 4).
- 12 INSTALL NEW SANITARY DRAIN FROM FLOOR ABOVE BY PENETRATING THE SLAB AND CONNECTING IT TO THE EXISTING SANITARY MAIN BRANCH IN THE CEILING SPACE. THE CONTRACTOR MUST CONSIDER AND ADJUST THE PENETRATION POINTS AS NECESSARY TO ACCOMMODATE THE NEW FIXTURES. ALL FLOOR AND SLAB OPENINGS MUST BE PATCHED AND SEALED TO MATCH THE EXISTING FINISH OR MEET THE ARCHITECT'S SPECIFICATIONS. THIS REQUIREMENT APPLIES TO ALL SUCH INSTALLATIONS.
- 13 PROVIDE NEW KITCHEN SINK (KS-1-2) FAUCET AND ALL NECESSARY WATER SUPPLIES, SHUT-OFF VALVES, P-TAP, CLEAN OUT AND PLUMBING ACCESSORIES FOR COMPLETE OPERATIONAL INSTALLATION. INSTALL NEW 1/2" COLD AND COLD WATER LINE DOWN TO NEW KS-1-2, 320 VENT LINE UP FROM KS-1-2 AND 400 SANITARY LINE DOWN FROM KS-1-2. ALLOW FOR CUTTING AND PATCHING OF CEILING WALL AS NEEDED. EXTENDED DOW/DHW LINE FOR COFFEE MAKER, WATER COOLER, HOT WATER DISPENSER, AND ETC CONNECTION. REFER TO DRAWING KS-01 FOR DETAILS. (TYPICAL).
- 14 PROVIDE NEW DOMESTIC HOT WATER RETICULATING PIPE (DHW) CW INSULATION AND ACCESSORIES FROM THE EXISTING DHW MAIN WITHIN CEILING SPACE TO SERVE NEW PLUMBING FIXTURE AS SHOWN.

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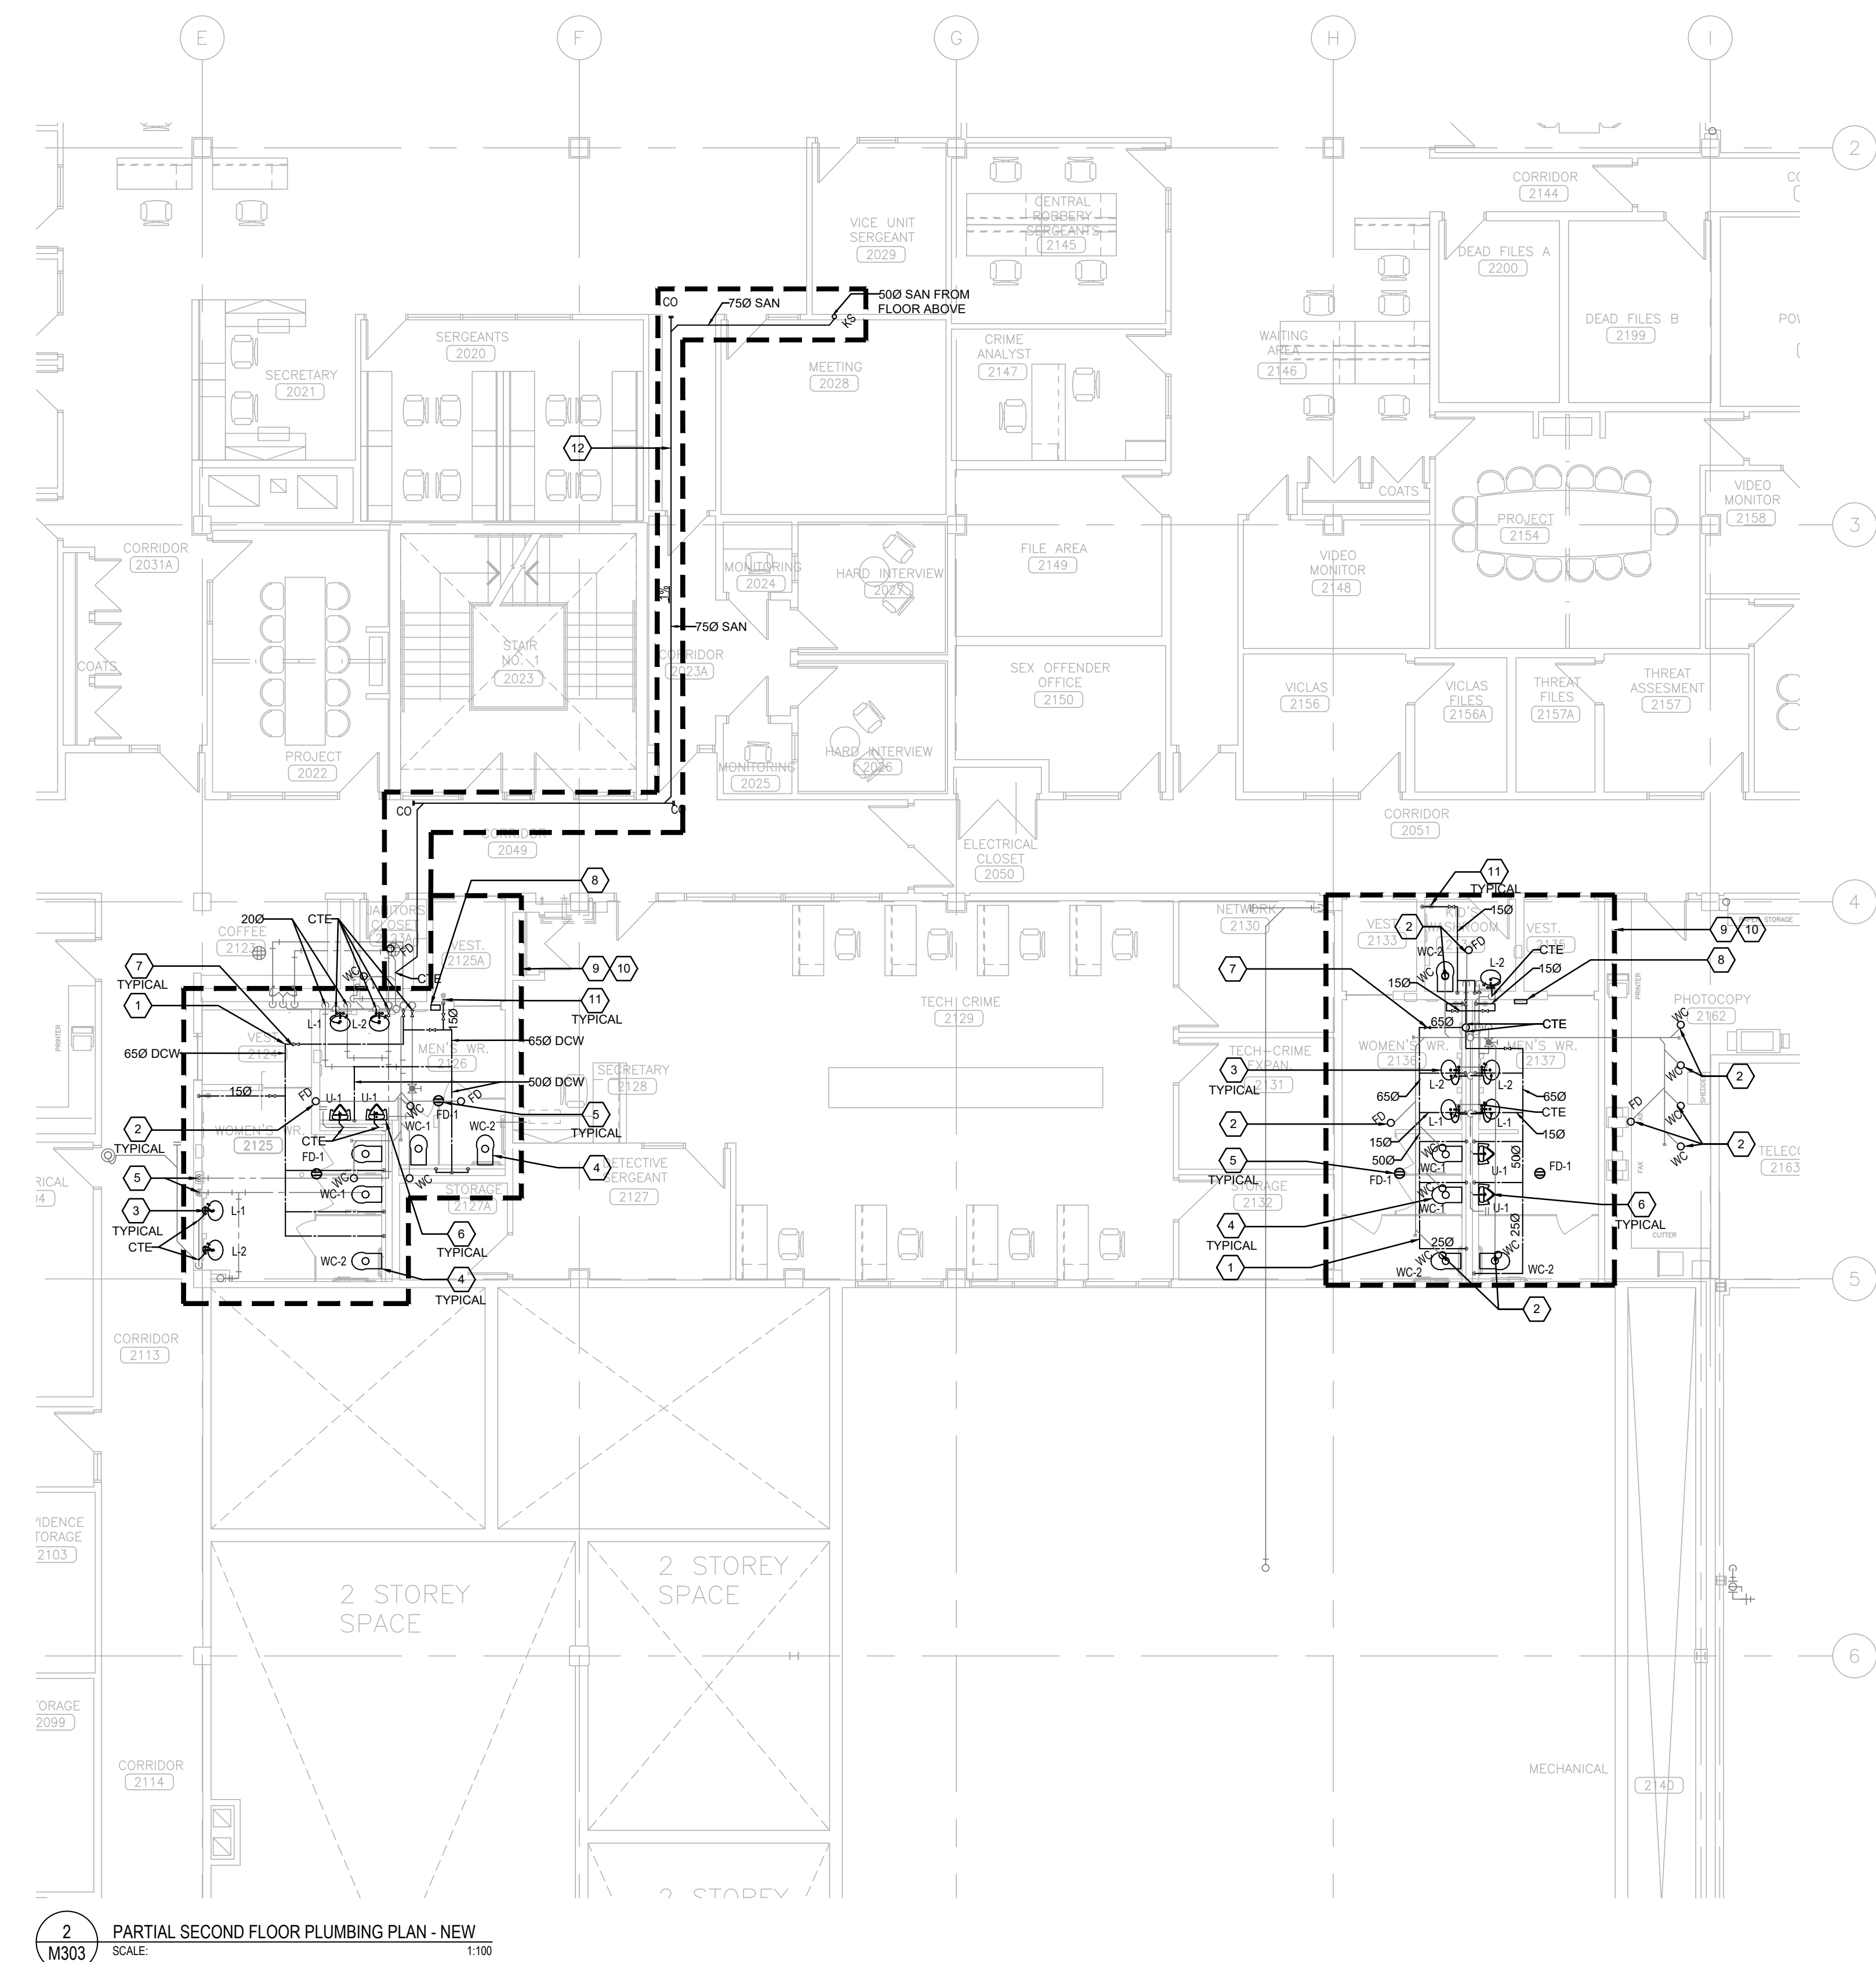
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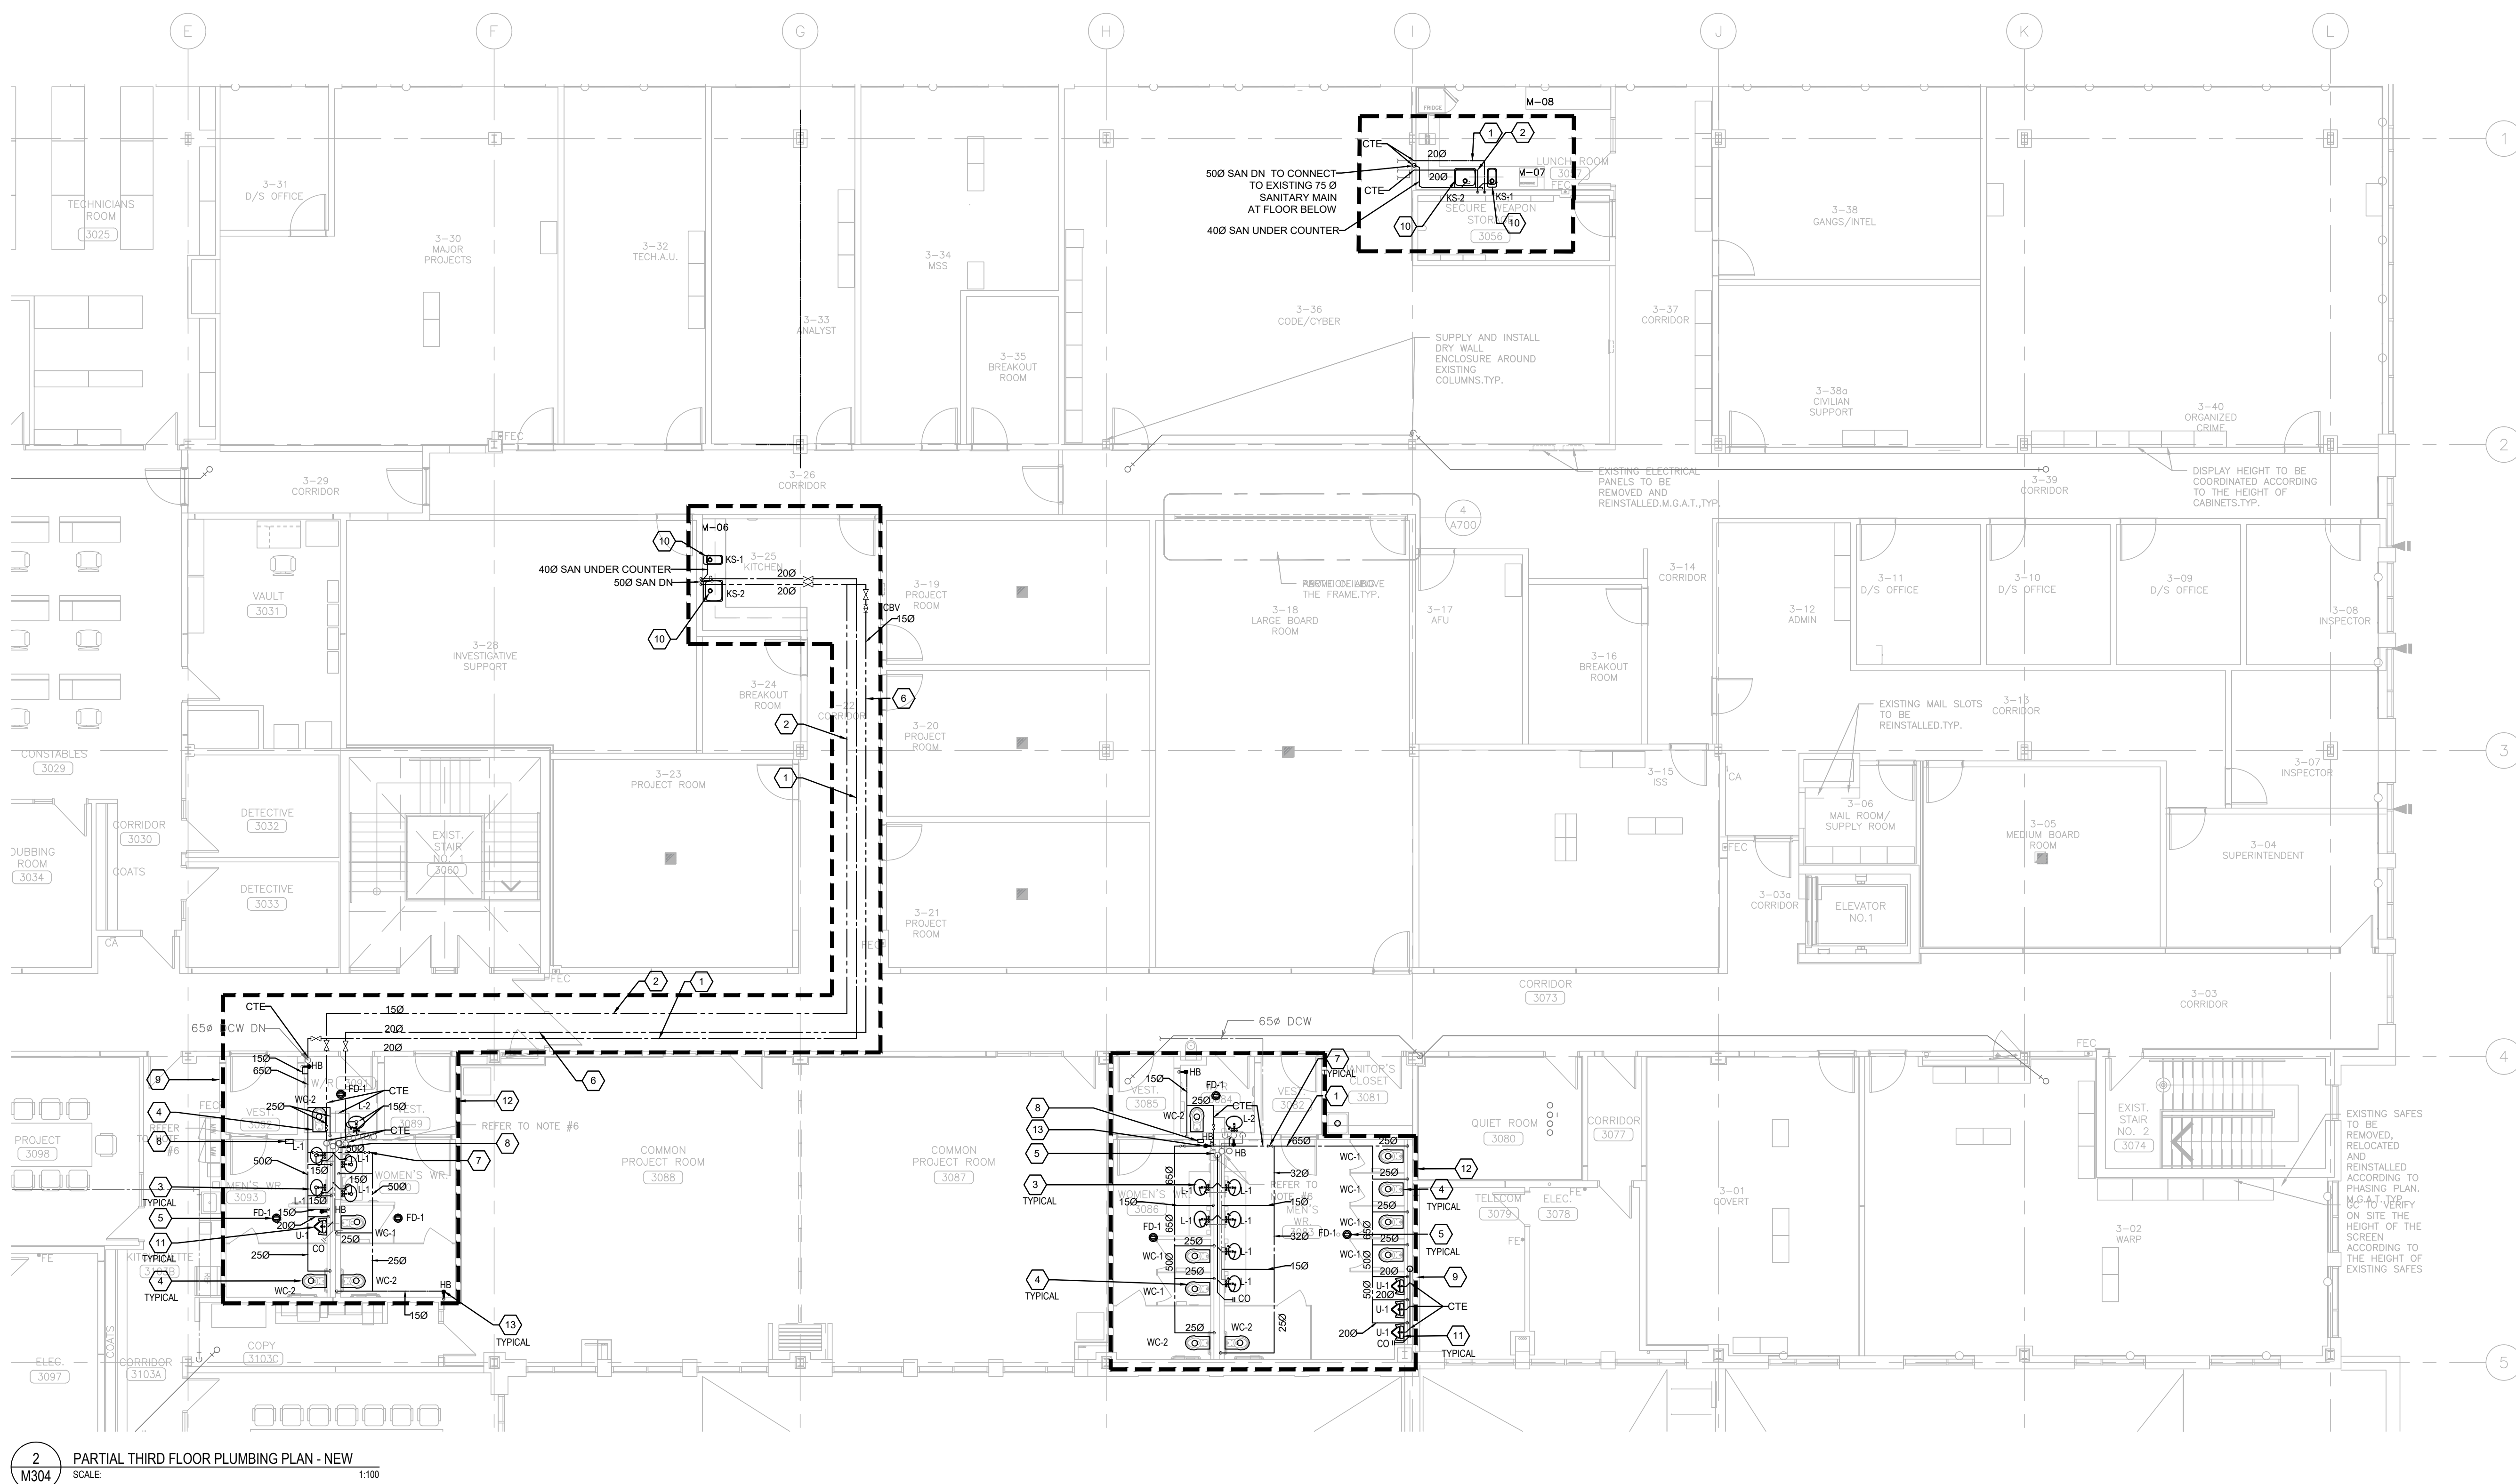
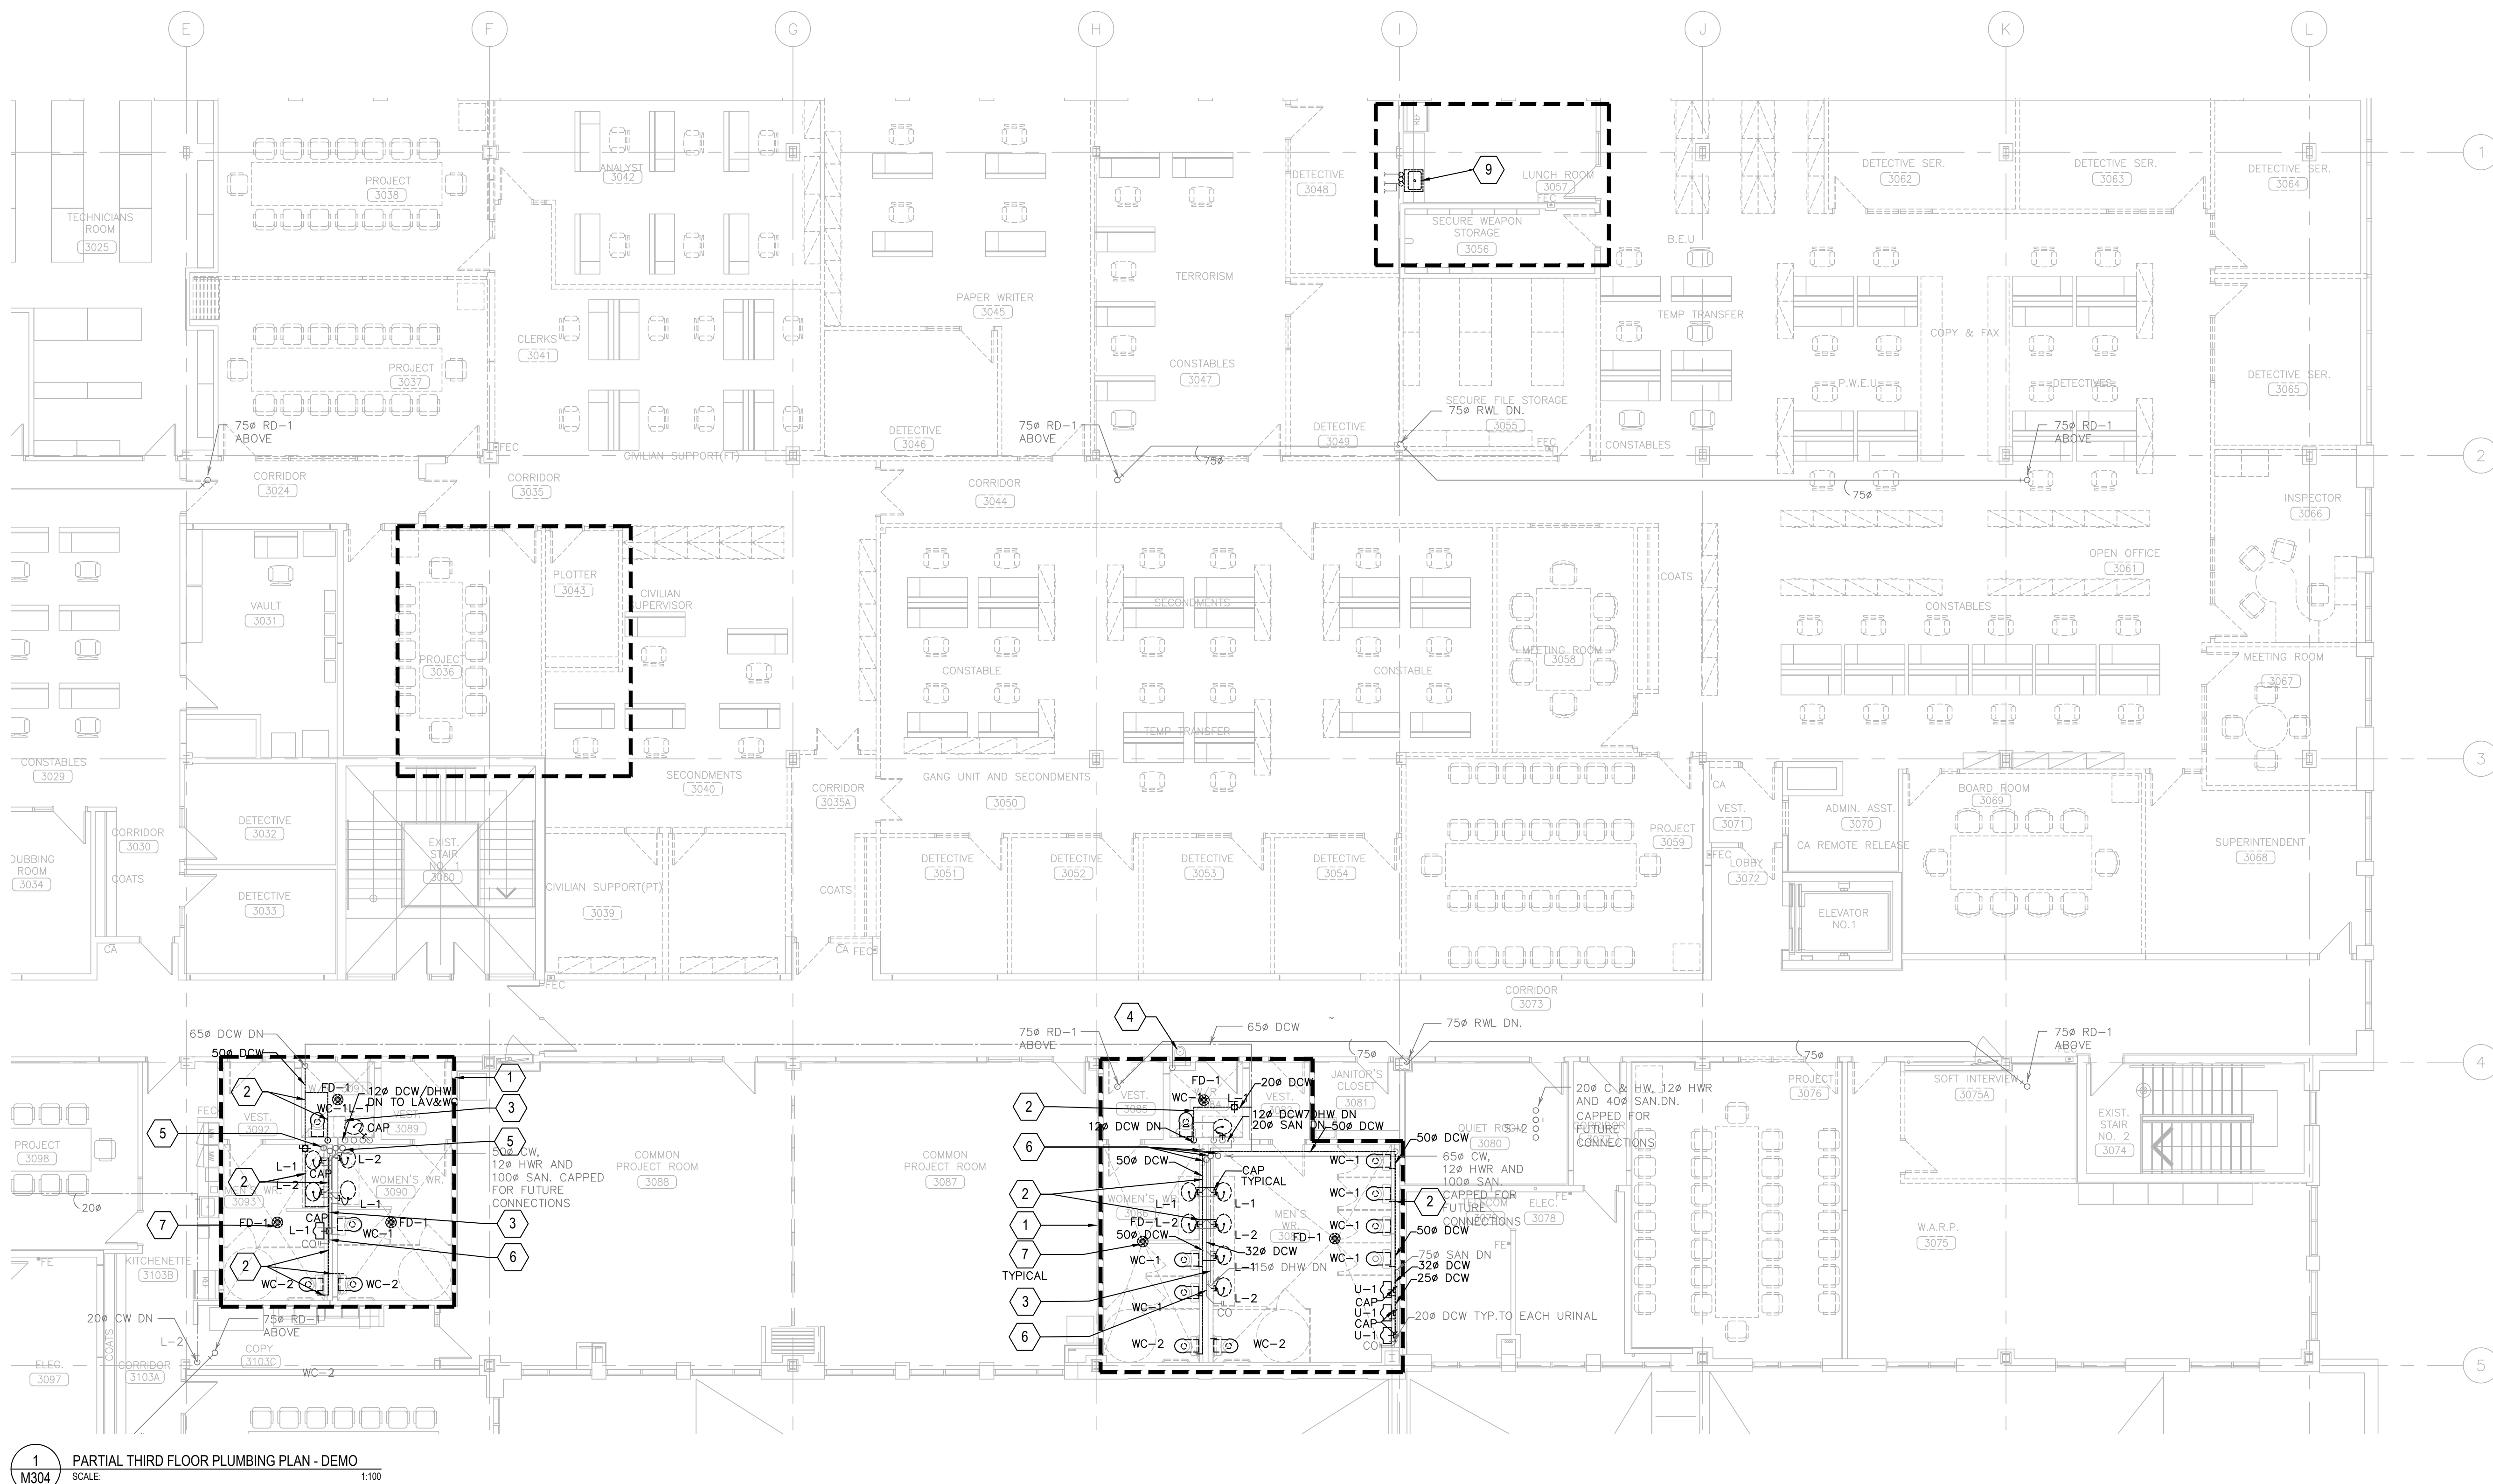


- | PLUMBING ITEM: DRAWING NOTES: | |
|-------------------------------|--|
| 1 | DEMOLISH ALL EXISTING PLUMBING FITTINGS IN THIS SCOPE COMPLETE WITH ALL ASSOCIATED PLUMBING AND TRIMS, INCLUDING BUT NOT LIMITED TO DOMESTIC COLD AND HOT WATER, VENT, SINK, AND SHOWER. REMOVE TO THE FLOOR BELOW AT MAIN. FOR FUTURE CONNECTION. INSULATION, HANGERS AND SUPPORTS ARE BEING REMOVED AS PART OF THE SCOPE. SILENT BATH ALL WALL-CORE WORKING TO MATCH EXISTING OR FOLLOW THE ARCHITECTURAL REQUIREMENT. |
| 2 | EXISTING SHOWER, SINK, SILENT BATH MAIN BRANCH AS INDICATED ON THE PLAN. PROVIDE NEW SIZE DOW PIPE, AND RISER AS INDICATED ON THE WORK PLAN. |
| 3 | EXISTING SHOWER, DRAIN DISTRIBUTION MAIN BRANCH TO REMAIN. |
| 4 | REMOVE EXISTING FLOOR DRAIN, CARRY SANITARY DRAIN MAIN IN CEILING SPACE AT FLOOR BELOW FOR FUTURE CONNECTION. TYPICAL. |
| 5 | EXISTING SANITARY DRAIN, CARRY SANITARY SERVICE ABOVE FLOOR TOILET, FLOOR DRAIN AND PENETRATING THE SLAB DOWN TO THE FLOOR CEILING SPACE TO BE REMOVED AND CARRY BACK TO MAIN. TYPICAL. |
| 6 | EXISTING SANITARY DRAIN, DRAIN RISER IN PIPE CHASE TO REMAIN. |
| 7 | EXISTING SANITARY DRAIN TO BE SERVICE ABOVE TO REMAIN. |

- PLUMBING GENERAL NEW WORK NOTES:**
1. ALL WORK SHALL BE DONE IN ACCORDANCE WITH THE REQUIREMENTS OF THE ONTARIO BUILDING CODE, MINISTRY OF THE ENVIRONMENT, MINISTRY OF LABOUR, MINIA, BUILDING MANAGEMENTS GUIDELINES (REFER TO ARCH. SPEC).
 2. ALL NEW SERVICES SHOWN ARE DIAGRAMMATIC ONLY. THE ARRANGEMENTS OF EQUIPMENT SHOWN ARE APPROXIMATE AND MAY BE ALTERED ON SITE TO MEET THE ON-SITE CONDITIONS OF THE PROJECT. CONTRACTOR TO REVIEW ALL THE EXISTING SERVICES AND COORDINATE WITH THE NEW INSTALLATION.
 3. CONTRACTOR TO COORDINATE WITH THE BUILDING MANAGEMENT FOR APPROVAL OF ANY SHUT DOWN OF EXISTING SYSTEMS/SERVICES. THE CONTRACTOR SHALL DETERMINE THE LOCATION OF THE SHUT DOWN, INTERRUPTION AND IMPACT ON FACILITY OPERATION, INCLUDING USE OF HOT/TEMPERATURE FREEZING AND AFTER-HOUR WORK AS REQUIRED. PROVIDE MIN. ONE WEEK NOTICE FOR BUILDING MANAGEMENT TO PLAN THE SHUT DOWN. CONTRACTOR TO ENSURE MIN. SHUTDOWNS.
 4. CONTRACTOR TO REROUTE ANY EXISTING SERVICES IF REQUIRED TO INSTALL NEW SERVICES. ALL SERVICES SHALL BE INSTALLED USING EXISTING BEAMS AND MACHINERY. ALL SERVICES SHALL BE INSTALLED THROUGH BEAM OPENINGS. SERVICES SHALL BE INSTALLED AS HIGH AS POSSIBLE TO THE UNDERSIDE OF THE BEAM. COORDINATE ALL SERVICES PRIOR TO INSTALLATION. THE LOWER SERVICES WILL BE ASSIGNED TO THE UNDERSIDE OF THE BEAM.
 5. COORDINATE WITH ALL CONSULTANT DRAWINGS BEFORE ORDERING ANY NEW EQUIPMENT, GRILLES & DIFFUSERS, SPRINKLER HEADS ETC.
 6. CONTRACTOR TO INCLUDE FOR ALL OFFSETS REQUIRED FOR COORDINATION WITH MECHANICAL AND ELECTRICAL SERVICES. THE OFFSETTING INCLUDES ALL HVAC, HYDRONICS, PLUMBING AND FIRE PROTECTION SERVICES.
 7. THE DRAWINGS AND SPECIFICATIONS PROVIDED THE MINIMUM PERFORMANCE REQUIREMENTS. THE FIRE PROTECTION SYSTEM SHALL BE PREPARED, COMPLETE, STAMPED, SIGNED, AND APPROVED BY A LICENSED SPRINKLER CONTRACTOR. IT IS THE CONTRACTOR'S RESPONSIBILITY TO OBTAIN ALL TEST INFORMATION PRIOR TO PREPARATION OF THE DRAWINGS AND CALCULATIONS.
 8. CONTRACTOR TO PROVIDE FIRE WATCH AS REQUIRED TO MAINTAIN FIRE SAFETY OF THE CONSTRUCTION SITE SCOPE AREA.
 9. THE CONTRACTOR SHALL PROVIDE FIRE STOPPING ON ALL NEW PIPING AND CONDUIT PENETRATIONS THROUGH A FIRE-RATED WALL OR FLOOR AND ANY HOLES THAT RESULT FROM REMOVAL OF EXISTING SERVICES THROUGH A FIRE-RATED WALL OR FLOOR.
 10. READ ALL THE DRAWINGS FOR COMPLETE INFORMATION.
 11. INCLUDE FOR FREEZING OF ALL SERVICES WITH THE ASSUMPTION THAT NO VALVES WILL HOLD AND REPLACE ALL WITH NEW LEVER BALL VALVES (OR SCREW TYPE VALVE WHERE APPROPRIATE)
 12. THE EXISTING SERVICES SHOWN ON THIS DRAWING HAVE BEEN TAKEN FROM THE ORIGINAL CONSTRUCTION DRAWINGS AND SITE SURVEYS. THE MECHANICAL CONTRACTOR SHALL CARRY OUT A FULL SURVEY OF ALL EXISTING SERVICES TO CONFIRM THE SIZE AND LOCATION OF THESE SERVICES. THE CONTRACTOR SHALL BE RESPONSIBLE FOR THE CORRECTION OF ANY WORK.
 13. THE CONTRACTOR SHALL VERIFY ALL EXISTING CONDITIONS PRIOR TO CUTTING EXISTING WALLS AND FLOOR SLAB. IF EXISTING SERVICES ARE CUT/DAMAGED IT IS THE CONTRACTOR'S RESPONSIBILITY TO PATCH AND REPAIR THE SERVICE.
 14. THE CONTRACTOR SHALL MAINTAIN CONTINUOUS OPERATION OF PLUMBING STAKES AND WATER SUPPLY MAINS THAT REQUIRE OFFSETS AND MAKE ANY NEW CONNECTIONS RESPECTIVELY DURING CONSTRUCTION PERIOD.
 15. THE CONTRACTOR SHALL COORDINATE WITH OTHER TRADES FOR FINAL SERVICE ROUTING ON SITE.
 16. CONTRACTOR TO ALLOW AN ADDITIONAL 20 PIPE HANDERS/FLOOR SUPPORTS TO EXISTING PIPING IF NECESSARY. THE CREDIT FOR THE HANDERS SHALL BE GIVEN BACK TO THE BUILDING MANAGEMENT IF NOT USED.
 17. CONTRACTOR TO ALLOW FOR INSULATION ON EXISTING PIPING IF IT IS DAMAGED OR MISSED.
 18. CAP ALL OBLIQUE WASTE PIPING BELOW THE SLAB. WATER PIPING BACK TO MAINS AND VENT PIPING ABOVE FINISHED CEILING. PATCH ALL FLOORS, WALLS AND CEILINGS AS REQUIRED TO MEET FIRE RATINGS.
 19. FOR DISCREET DUCT, CAP EXISTING DUCTS IN THE CONSTRUCTION AREA. CONNECTION TO EXISTING AIR DUCTS TO BE DONE AFTER COMPLETION OF ALL DUCT PRODUCING TASKS.
 20. REMOVE ALL REDUNDANT PIPES, CONDUITS, INCLUDING LOOSE WRINGS AND DUCTWORK. CAP AT MAIN.
 21. COORDINATE WITH BUILDING OPERATION TEAM FOR SHUT DOWNS AND DRAINING FIRE LINE PRIOR TO COMMENCING NEW WORK. PROVIDE FIRE WATCH AS REQUIRED TO ENSURE BUILDING SAFETY DURING SPRINKLER MAIN PIPE REMOVAL.
 22. CONTRACTOR TO PROVIDE TRAP SEAL, PUMP AND PIPING SYSTEM PER OBC PART 7.
 23. CONTRACTOR TO PROVIDE SANITARY VENT PIPE PER OBC PART 7 REQUIREMENT WITHIN VET WALL AND UP TO CEILING TO CONNECT TO EXISTING BUILDING VENT MAIN. CONTRACTOR TO VERIFY THE EXISTING AVAILABLE VENT PIPE LOCATION AND THE EXACT CONNECT POINT ON SITE.
 24. ALL SERVICES WITHIN THE CEILING SPACE SHALL BE OUTSIDE THE SHAFT AND ALL SERVICES BELOW THE CEILING SHALL BE CAPTED WITHIN THE SHAFT.

- PLUMBING NEW WORK DRAWING NOTES:**
1. PROVIDE NEW DOMESTIC COLD WATER PIPE (DWC) CIVIL INSULATION AND ALL ACCESSORIES FROM DOW SUPPLY RISER WITH CEILING SPACE TO SERVE NEW PLUMBING FIXTURES AS SHOWN.
 2. INSTALL NEW SANITARY DRAIN FROM FLOOR ABOVE, BY PENETRATING THE SLAB AND CONNECTING IT TO THE EXISTING SANITARY MAIN BRANCH IN THE CEILING SPACE. THE CONTRACTOR MUST COORDINATE AND ADJUST THE PENETRATION POINTS AS NECESSARY TO ACCOMMODATE THE NEW FIXTURES. ALL FLOOR AND SLAB OPENINGS MUST BE PATCHED AND SEALED TO MATCH THE EXISTING FINISH OR MEET THE ARCHITECT'S SPECIFICATIONS. THIS REQUIREMENT APPLIES TO ALL SUCH INSTALLATIONS.
 3. NEW LAVATORY, PROVIDE NEW 150 HOT AND COLD WATER LINES, 320 VENT LINE AND 420 SANITARY LINE FROM L1/L2 TO THE BACK TO EXISTING DOW DHH AND SANITARY DRAIN BRANCH TO THE WALL. ALLOW FOR CUTTING AND PATCHING WALL, FLOOR, CEILING ON FLOOR ABOVE AS NEEDED. (TYPICAL). CONTRACTOR TO VERIFY THE EXACT CONNECTION POINT AND COORDINATE ON SITE. (TYPICAL).
 4. NEW FLOOR MOUNTED TOILET TO REPLACE EXISTING AT SAME LOCATION. PROVIDE 250 COLD WATER LINE DOWN TO NEW WC-1/ WC-2. 500 VENT LINE UP FROM WC-1/ WC-2 AND 420 SANITARY LINE DOWN TO NEW WC-1/2 TO EXISTING DRAIN BRANCH. ALLOW FOR CUTTING AND PATCHING WALL, FLOOR AND CEILING ON FLOOR BELOW AS NEEDED. ALLOW FOR X-RAY/SCANNING OF EXISTING FLOOR SLAB CONTRACTOR TO VERIFY THE EXACT CONNECTION POINT AND COORDINATE ON SITE. (TYPICAL).
 5. NEW FLOOR DRAIN "TD-1". PROVIDE NEW DRAIN TRAP AND 1000 DRAIN BRANCH TO THE BACK TO EXISTING SANITARY DRAIN AT FLOOR BELOW. CONTRACTOR TO VERIFY THE EXACT CONNECTION POINT AND COORDINATE ON SITE. ALLOW FOR X-RAY/SCANNING OF EXISTING FLOOR SLAB. ALLOW FOR CUTTING AND PATCHING WALL, FLOOR AND CEILING ON FLOOR BELOW AS NEEDED. (TYPICAL).
 6. NEW WALL MOUNTED URINAL, AT SAME LOCATION TO REPLACE EXISTING. PROVIDE 300 COLD WATER LINE DOWN TO NEW U-1/ 400 VENT LINE UP FROM URINAL TO EXISTING SANITARY DRAIN BRANCH TO THE BACK TO EXISTING SANITARY DRAIN IN WALL. ALLOW FOR CUTTING AND PATCHING WALL, FLOOR AND CEILING ON FLOOR BELOW AS NEEDED. ALLOW FOR X-RAY/SCANNING OF EXISTING FLOOR SLAB. CONTRACTOR TO VERIFY THE EXACT CONNECTION POINT AND COORDINATE ON SITE. (TYPICAL).
 7. PROVIDE NEW SHUTOFF VALVE IN NEW OR EXISTING COWDWHY LINE AS INDICATED ON THE PLAN. TYPICAL.
 8. PROVIDE ELECTRONIC TYPE TRAP SEAL PRIMER AS PER OBC PART 7 REQUIREMENT. FINAL LOCATION TO BE COORDINATE ON SITE (TYPICAL).
 9. PROVIDE SANITARY VENT PIPE PER OBC PART 7 REQUIREMENT WITH NET WALL AND UP TO CEILING TO CONNECT TO EXISTING BUILDING VENT MAIN. CONTRACTOR TO VERIFY THE EXISTING AVAILABLE VENT LINE LOCATION AND THE EXACT CONNECT ON SITE (TYPICAL).
 10. PROVIDE SHUT-OFF VALVE FOR ALL THE NEW PLUMBING FIXTURES COWDWHY SUPPLY BRANCH. TYPICAL OF ALL.
 11. NEW FLOOR MOUNTED 150 HOSE BIB AND ASSOCIATE DOW PIPE SUPPLY (TYPE P). (S).
 12. INSTALL NEW SANITARY DRAIN FROM FLOOR ABOVE, BY PENETRATING THE SLAB AND CONNECTING IT TO THE EXISTING SANITARY MAIN BRANCH IN THE CEILING SPACE. THE CONTRACTOR MUST COORDINATE AND ADJUST THE PENETRATION POINTS AS NECESSARY TO ACCOMMODATE THE NEW FIXTURES. ALL FLOOR AND SLAB OPENINGS MUST BE PATCHED AND SEALED TO MATCH THE EXISTING FINISH OR MEET THE ARCHITECT'S SPECIFICATIONS. THIS REQUIREMENT APPLIES TO ALL SUCH INSTALLATIONS.

[illegible]



PLUMBING GENERAL DEMO NOTES:

- ALL EXISTING AND NEW PLUMBING PIPE SIZES SHOWN AS METRIC (MM).
- PRIOR TO COMMENCEMENT OF THE WORK, ORDERING OF EQUIPMENT AND/OR FABRICATING MATERIALS, THE MECHANICAL CONTRACTOR SHALL VISIT THE SITE TO VERIFY EXISTING CONDITIONS. THIS SHALL BE DONE IN ORDER TO CONFIRM THAT EQUIPMENT AND SERVICES CAN BE INSTALLED AS SHOWN ON DRAWINGS. IT IS THE CONTRACTOR'S RESPONSIBILITY TO NOTIFY THE ENGINEER OF ANY DISCREPANCIES, OMISSIONS AND/OR INTERFERENCES PRIOR TO COMMENCEMENT OF THE WORK.
- DEMOLITION DRAWINGS HAVE BEEN PREPARED AS A GENERAL GUIDE TO THE CONTRACTOR. NOT ALL SERVICES HAVE BEEN SHOWN. THE CONTRACTOR SHALL REMOVE ALL REDUNDANT SERVICES TO THE NEAREST ACTIVE REMAINING SOURCE, WHETHER THEY HAVE OR HAVE NOT BEEN SHOWN. NO EXTRAS WILL BE ENTERTAINED FOR DEMOLITION.
- SOME DEMOLITION HAS BEEN SHOWN BASED ON EXISTING "AS BUILT" DWG FROM ORIGINAL CONSTRUCTION AND VARIOUS KNOWN RETROFITS AND ALTERNATIONS. NOT ALL SERVICES HAVE BEEN SHOWN. IT SHALL BE THE RESPONSIBILITY OF THE CONTRACTOR TO SURVEY THE SPACE AND VERIFY EXTENT OF DEMOLITION WORK INVOLVED.
- UNLESS SPECIFICALLY SHOWN TO REMAIN ON THE DRAWINGS, REMOVE ALL EXISTING (SAN, V, ST, CW, HW, HW, ETC.) PIPING FIXTURES & FITTINGS, EQUIPMENT, SUPPORTS ETC. FROM AREA OF RENOVATION. ALLOW FOR CUTTING AND PATCHING OF CEILINGS AND WALLS NECESSARY TO REMOVE SERVICES IN THE EVENT THAT THE EXISTING CEILINGS OR WALLS ARE NOT BEING REMOVED BY THE GENERAL CONTRACTOR.
- REMOVE PLUMBING FIXTURES AS SHOWN. CUT BACK DRAIN, VENT, WATER PIPING ETC. BACK TO RISER OR NEAREST ACTIVE SOURCE. COORDINATE WITH MAINTENANCE DEPARTMENT WHICH FIXTURES THEY WISH TO KEEP. TRANSPORT THOSE FIXTURE TO STORAGE. REMOVE AND DISPOSE ALL UNWANTED FIXTURES.
- PRIOR TO DEMOLITION, COORDINATE SHUT DOWN WITH BUILDING OPERATION TEAM AND ISOLATE SERVICES. PHASING REQUIREMENTS OF PROJECT MAY REQUIRE SOME EXISTING SERVICE BE LEFT IN OPERATION UNTIL NEW SERVICES ARE INSTALLED. CAREFULLY REVIEW PHASING SET OUT BY ARCHITECT.
- WHERE MECHANICAL EQUIPMENT (E, A/C UNIT, ELECTRIC WATER HEATER, FAN, DISHWASHER) IS REMOVED, COORDINATE PROMPTLY WITH GENERAL CONTRACTOR AND ELEC. DIV. TO DISCONNECT AND MAKE SAFE TIE ASSOCIATED POWER SUPPLY. MECH. DIV. 15 SHALL ENSURE THAT NO ABANDONED LIVE POWER CORD IS LEFT UNPROTECTED AT ANY TIME.
- WHERE PIPE IS REMOVED THROUGH FIRE-RATED WALL OR FLOOR ASSEMBLIES, PROVIDE UL-C CLASSIFIED FIRE STOPPING SYSTEMS THAT ARE TESTED IN ACCORDANCE WITH CAN/UL-S118. INSTALL ALL FIRE STOPPING SYSTEM IN STRICT ACCORDANCE WITH THE MANUFACTURER'S INSTALLATION INSTRUCTION. STANDARD OF ACCEPTANCE: 3H, HLTI.
- DURING DEMOLITION, CONTRACTOR SHOULD INCLUDE VIDEO SCOPING FOR THE PLUMBING WORK BEFORE AND AFTER CONSTRUCTION AND REPORT BACK TO ENGINEER FOR ANY DAMAGE, BROKEN, LEAKAGE AND ANY DISCREPANCIES. WHERE EXISTING PIPE INSULATIONS DAMAGES FOUND TO REQUIRE REPAIR, RECORD THE EXTENT OF THE REPAIRS REPAIR ON PLANS AND REPORT TO THE CLIENT/CONSULTANT.

PLUMBING DEMO DRAWING NOTES:

- DEMOLISH ALL EXISTING PLUMBING FIXTURES IN THIS SCOPE COMPLETE WITH ALL ASSOCIATED PLUMBING AND TRIM, INCLUDING BUT NOT LIMITED TO DOMESTIC COLD/HOT WATER, VENT AND SANITARY. ALSO TO INCLUDE CAP BACK TO WALL, LAVATORY AND URINAL, SANITARY DRAIN CAP BACK TO WALL FOR FUTURE CONNECTION. TOILET, SANITARY DRAIN CAP BACK TO THE FLOOR BELOW AT MAIN FOR FUTURE CONNECTION. INSULATION, HANGERS AND SUPPORT NOT BEING REUSED AS PART OF THIS CONTRACT. SEAL AND PATCH ALL WALLS AND FLOORS TO MATCH EXISTING OR FOLLOW THE ARCHITECT REQUIREMENT. TYPICAL.
- EXISTING DOW MAIN BRANCH AND BRANCH TO BE REMOVED AND REPLACE TO NEW SIZE AS INDICATED ON NEW DRAWING PLAN. CONTRACTOR TO VERIFY THE EXACT SIZE AND LOCATION ON SITE.
- EXISTING DOW, DW, HW DISTRIBUTION MAIN BRANCH TO REMAIN.
- EXISTING DRINK FOUNTAIN TO REMAIN.
- EXISTING DOW, DW, HW RISER IN PIPE CHASE TO REMAIN.
- EXISTING SANITARY DRAIN IN PIPE CHASE TO REMAIN.
- REMOVE EXISTING FLOOR DRAIN, CAP SANITARY DRAIN BACK TO MAIN IN CEILING SPACE AT FLOOR BELOW FOR FUTURE CONNECTION. TYPICAL.
- REMOVE EXISTING FLOOR DRAIN, CAP SANITARY DRAIN BACK TO MAIN IN CEILING SPACE AT FLOOR BELOW FOR FUTURE CONNECTION. TYPICAL.
- REMOVE EXISTING KITCHEN SINK WITH ALL ASSOCIATED PLUMBING AND TRIM, INCLUDING BUT NOT LIMITED TO DOMESTIC COLD/HOT WATER, VENT AND SANITARY. ALL DOW, DW, HW BRANCH PIPING SHALL BE CAPPED BACK TO WALL. SANITARY DRAIN TO BE CUT BACK TO SLAB BELOW. CONTRACTOR TO VERIFY THE EXISTING PLUMBING ON SITE AND REPORT BACK TO ENGINEER.



PLUMBING GENERAL NEW WORK NOTES:

- ALL WORK SHALL BE DONE IN ACCORDANCE WITH THE REQUIREMENTS OF THE ONTARIO BUILDING CODE, MINISTRY OF THE ENVIRONMENT, MINISTRY OF LABOUR, NFPA, BUILDING MANAGEMENTS GUIDELINES (REFER TO ARCH. SPEC).
- ALL NEW SERVICES SHOWN ARE DIAGRAMMATIC ONLY. THE ARRANGEMENTS OF EQUIPMENT SHOWN ARE APPROXIMATE AND MAY BE ALTERED ON SITE TO MEET THE ON-SITE CONDITIONS OF THE PROJECT. CONTRACTOR TO REVIEW ALL THE EXISTING SERVICES AND COORDINATE WITH THE NEW INSTALLATION.
- CONTRACTOR TO COORDINATE WITH THE BUILDING MANAGEMENT FOR APPROVAL OF ANY SHUT DOWN OF EXISTING SYSTEMS/SERVICES. THE CONTRACTOR SHALL DETERMINE THE BEST METHOD TO MINIMIZE SERVICE INTERRUPTION AND IMPACT ON FACILITY OPERATION, INCLUDING USE OF HOT TAP/TEMPORARY FREEZING AND REQUIRED. PROVIDE MIN. ONE WEEK NOTICE FOR BUILDING MANAGEMENT TO PLAN THE SHUT DOWN. CONTRACTOR TO ENSURE MIN. SHUTDOWNS.
- CONTRACTOR TO REMOVE ANY EXISTING SERVICES IF REQUIRED TO INSTALL NEW SERVICES. ALL SERVICES SHALL BE INSTALLED USING EXISTING BEAM OPENINGS AS MUCH AS POSSIBLE. IN THE EVENT OF NO SPACE THROUGH BEAM OPENING, SERVICES SHALL BE INSTALLED AS HIGH AS POSSIBLE TO THE UNDERSIDE OF THE BEAM. COORDINATE ALL SERVICES PRIOR TO INSTALLATION. THE LOWER SERVICES INSTALLED WILL BE ASKED TO RELOCATE IF SPACE AVAILABLE AT HIGH LEVEL.
- COORDINATE WITH ALL CONSULTANT DRAWINGS BEFORE ORDERING ANY NEW EQUIPMENT, GRILLES & DIFFUSERS, SPRINKLER HEADS ETC.
- CONTRACTOR TO INCLUDE FOR ALL OFFSETS REQUIRED FOR COORDINATION WITH MECHANICAL AND ELECTRICAL SERVICES. THE OFFSETTING INCLUDES ALL HVAC, HYDRONICS, PLUMBING AND FIRE PROTECTION SERVICES.
- THE DRAWINGS AND SPECIFICATIONS ARE PROVIDING THE MINIMUM PERFORMANCE REQUIREMENTS. THE FIRE PROTECTION SYSTEM SHALL BE PREPARED, COMPLETE, STAMPED, SIGNED, AND APPROVED BY A LICENSED SPRINKLER CONTRACTOR. IT IS THE CONTRACTOR'S RESPONSIBILITY FOR THE FLOW TEST INFORMATION PRIOR TO PREPARATION OF DRAWINGS AND HYDRAULIC CALCULATIONS.
- CONTRACTOR TO PROVIDE FIRE WATCH AS REQUIRED TO MAINTAIN FIRE SAFETY OF THE CONSTRUCTION SITE SCOPE AREA.
- THE CONTRACTOR SHALL PROVIDE FIRE STOPPING ON ALL NEW PIPING AND CONDUIT PENETRATIONS THROUGH A FIRE-RATED WALL OR FLOOR AND ANY HOLES THAT RESULT FROM REMOVAL OF EXISTING SERVICES THROUGH A FIRE-RATED WALL OR FLOOR.
- READ ALL THE DRAWINGS FOR COMPLETE INFORMATION.
- INCLUDE FOR FREEZING OF ALL SERVICES WITH THE ASSUMPTION THAT NO VALVES WILL HOLD AND REPLACE ALL WITH NEW LEVER BALL VALVES (OR SCREW TYPE ONLY WHERE APPROPRIATE).
- THE EXISTING SERVICES SHOWN ON THIS DRAWING HAVE BEEN TAKEN FROM THE ORIGINAL CONSTRUCTION DRAWINGS AND SITE SURVEYS. THE MECHANICAL SHALL CARRY OUT A FULL SURVEY OF ALL EXISTING SERVICES TO CONFIRM THE SIZE AND LOCATION OF THESE SERVICES BEFORE THE COMMENCEMENT OF ANY WORK.
- THE CONTRACTOR SHALL VERIFY ALL EXISTING CONDITIONS PRIOR TO CUTTING EXISTING WALLS AND FLOOR SLAB. IF EXISTING SERVICES ARE OUTDAMAGED, IT IS THE CONTRACTOR'S RESPONSIBILITY TO PATCH AND REPAIR THE SERVICE.
- THE CONTRACTOR SHALL MAINTAIN CONTINUOUS OPERATION OF PLUMBING STACKS AND WATER SUPPLY MAINS THAT REQUIRE OFFSETTING AND MAKE ANY NEW CONNECTIONS RESPECTIVELY DURING CONSTRUCTION PERIOD.
- THE CONTRACTOR SHALL COORDINATE WITH OTHER TRADES FOR FINAL SERVICE ROUTING ON SITE.
- CONTRACTOR TO ALLOW ADDITIONAL 30 PIPE HANGERS/FLOOR AND SUPPORTS ON EXISTING PIPING IF NECESSARY. THE CREDIT FOR THE HANGERS SHALL BE GIVEN BACK TO THE BUILDING MANAGEMENT IF NOT USED.
- CONTRACTOR TO ALLOW FOR INSULATION ON EXISTING PIPING IF IT IS DAMAGED OR MISSED.
- CAP ALL OBSOLETE WASTE PIPING BELOW THE SLAB. WATER PIPING BACK AT MAINS AND VENT PIPING ABOVE FINISHED CEILINGS. PATCH ALL FLOORS, WALL AND CEILINGS AS REQUIRED TO MEET FIRE RATINGS.
- FOR DUST CONTROL, CAP EXISTING DUCTS IN THE CONSTRUCTION AREA. CONNECTION TO EXISTING AIR DUCTS TO BE DONE AFTER COMPLETION OF ALL DUST PRODUCING TASKS.
- REMOVE ALL REDUNDANT PIPES, CONDUITS, INCLUDING LOOSE WIRES AND DUCTWORK. CAP AT MAIN.
- COORDINATE WITH BUILDING OPERATION TEAM FOR SHUT DOWNS AND DRAINING FIRE LINE PRIOR TO COMMENCING NEW WORK. PROVIDE FIRE WATCH AS REQUIRED TO ENSURE BUILDING SAFETY DURING SPRINKLER MAIN PIPE REMOVAL.
- CONTRACTOR TO PROVIDE TRAP SEAL PRIMER AND PIPING SYSTEM PER OBC PART 7.
- CONTRACTOR TO PROVIDE SANITARY VENT PIPE PER OBC PART 7 REQUIREMENT WITHIN WET WALL AND UP TO CEILING TO CONNECT TO EXISTING BUILDING VENT MAIN. CONTRACTOR TO VERIFY THE EXISTING AVAILABLE VENT PIPE LOCATION AND THE EXACT CONNECTION POINT ON SITE.
- ALL SERVICES WITHIN THE CEILING SPACE SHALL BE OUTSIDE THE SHAFT AND ALL SERVICES BELOW CEILING SHALL BE CAPPED WITHIN THE SHAFT ENCLOSURE. CONTRACTOR TO COORDINATE THE SHAFT OPENING SIZE.

PLUMBING NEW WORK DRAWING NOTES:

- PROVIDE NEW DOMESTIC COLD WATER PIPE CW INSULATION AND ALL ACCESSORIES FROM DOW SUPPLY RISER WITHIN CEILING SPACE TO SERVE NEW PLUMBING FIXTURES AS SHOWN.
- PROVIDE NEW DOMESTIC HOT WATER PIPE CW INSULATION AND ALL ACCESSORIES FROM EXISTING DHW SUPPLY MAIN WITHIN CEILING SPACE TO SERVE PLUMBING FIXTURE AS SHOWN.
- INSTALLED NEW LAVATORY. PROVIDE NEW 150 HOT AND COLD WATER LINES. 320 VENT LINE AND 400 SANITARY LINE FROM 1-17/2 TO THE BACK TO EXISTING DOW, DHW AND SANITARY DRAIN BRANCH. BACK TO THE WALL. ALLOW FOR CUTTING AND PATCHING WALL, FLOOR, CEILING ON FLOOR ABOVE AS NEEDED. (TYPICAL). CONTRACTOR TO VERIFY THE EXISTING AVAILABLE VENT PIPE LOCATION AND THE EXACT CONNECTION POINT ON SITE. (TYPICAL).
- INSTALL NEW FLOOR MOUNTED TOILET TO REPLACE EXISTING AT SAME LOCATION. PROVIDE 280 COLD WATER LINE DOWN TO NEW WC-11/WC-2, 500 VENT LINE UP FROM WC-11/WC-2 AND 750 SANITARY LINE DOWN FROM WC-11/WC-2 TIE TO EXISTING DRAIN BRANCH. ALLOW FOR CUTTING AND PATCHING WALL, FLOOR AND CEILING ON FLOOR BELOW AS NEEDED. ALLOW FOR RAYSCANNING OF EXISTING FLOOR SLAB. CONTRACTOR TO VERIFY THE EXACT CONNECTION POINT AND COORDINATE ON SITE. (TYPICAL).
- INSTALL NEW FLOOR DRAIN "FD-1". PROVIDE NEW DRAIN TRAP AND 1000 DRAIN BRANCH THE BACK TO EXISTING SANITARY DRAIN AT FLOOR BELOW. CONTRACTOR TO VERIFY THE EXACT CONNECTION POINT AND COORDINATE ON SITE. ALLOW FOR RAYSCANNING OF EXISTING FLOOR SLAB. ALLOW FOR CUTTING AND PATCHING WALL, FLOOR AND CEILING ON FLOOR BELOW AS NEEDED. (TYPICAL).
- PROVIDE NEW DOMESTIC HOT WATER RE-CIRCULATION PIPE CW INSULATION AND ALL ACCESSORIES FROM EXISTING DHW SUPPLY MAIN WITHIN CEILING TO SERVE NEW KITCHEN.
- PROVIDE NEW SHUTOFF VALVE IN NEW OR EXISTING DOW/HW LINE. AS INDICATED ON THE PLAN. TYPICAL.
- PROVIDE ELECTRONIC TYPE TRAP SEAL PRIMER AS PER OBC PART 7 REQUIREMENT. FINAL LOCATION TO BE COORDINATE ON SITE (TYPICAL).
- IN THIS SCOPE WORK, PROVIDE SANITARY VENT PIPE PER OBC PART 7 REQUIREMENT WITHIN WET WALL AND UP TO CEILING TO CONNECT TO EXISTING BUILDING VENT MAIN. CONTRACTOR TO VERIFY THE EXISTING AVAILABLE VENT PIPE LOCATION AND THE EXACT CONNECTION POINT ON SITE. (TYPICAL).
- PROVIDE NEW KITCHEN SINK (X'S), FAUCET AND ALL NECESSARY WATER SUPPLIES. SHUT-OFF VALVES. P-TRAP. CLEAN OUT AND PLUMBING ACCESSORIES FOR COMPLETE OPERATIONAL INSTALLATION. INSTALL 150 HOT AND COLD WATER LINE DOWN TO NEW X'S. 320 VENT LINE UP FROM X'S AND 400 SANITARY LINE DOWN FROM X'S. ALLOW FOR CUTTING AND PATCHING OF CEILING AND WALL AS NEEDED. EXTEND 150 VALVED W. LINE FOR DISHWASHER CONNECTION. (TYPICAL).
- PROVIDE NEW 280 COLD WATER LINE DOWN TO NEW 1-11 AND 500 VENT UP FROM 1-11 AND 500 SANITARY LINE DOWN FROM 1-11 THE BACK TO EXISTING SANITARY DRAIN AT FLOOR BELOW. ALLOW FOR CUTTING AND PATCHING OF CEILING AND WALL AS NEEDED. (TYPICAL).
- PROVIDE SHUT-OFF VALVE FOR ALL THE NEW PLUMBING FIXTURES DOW/HW SUPPLY BRANCH (TYPICAL).
- PROVIDE WALL MOUNTED 150 HOSE BIB AND ASSOCIATE DOW PIPE SUPPLY (TYP. OF 6).

<p>REGION OF PEEL</p> <p>EMIL V. KOLB CENTRE PEEL REGIONAL POLICE FACILITY INTERIOR RENOVATION PROJECT 180 DERRY ROAD EAST, MISSISSAUGA, ON L5T 2Y5</p>	
<p>6 ISSUED FOR TENDER 2026.05.01</p> <p>4 ISSUED FOR BUILDING PERMIT 2026.04.08</p> <p>3 ISSUED FOR 100% CLIENT REVIEW 2026.03.31</p> <p>2 ISSUED FOR 65% CLIENT REVIEW 2026.01.09</p> <p>1 ISSUED FOR COSTING REVIEW 2025.11.24</p>	
NO.	DESCRIPTION
<p>REVISIONS</p> <p>PROJECT</p>	
<p>STRUCTURAL CONSULTANT Stephenson Engineering</p> <p>MECHANICAL CONSULTANT EXP Services Inc.</p> <p>ELECTRICAL CONSULTANT EXP Services Inc.</p>	
<p>SHEET TITLE PARTIAL THIRD FLOOR - PLUMBING DEMO & NEW</p>	
SHEET NO.	DRAWN BY
M304	MRK-25008951-A0
SCALE	CHECKED
	ME

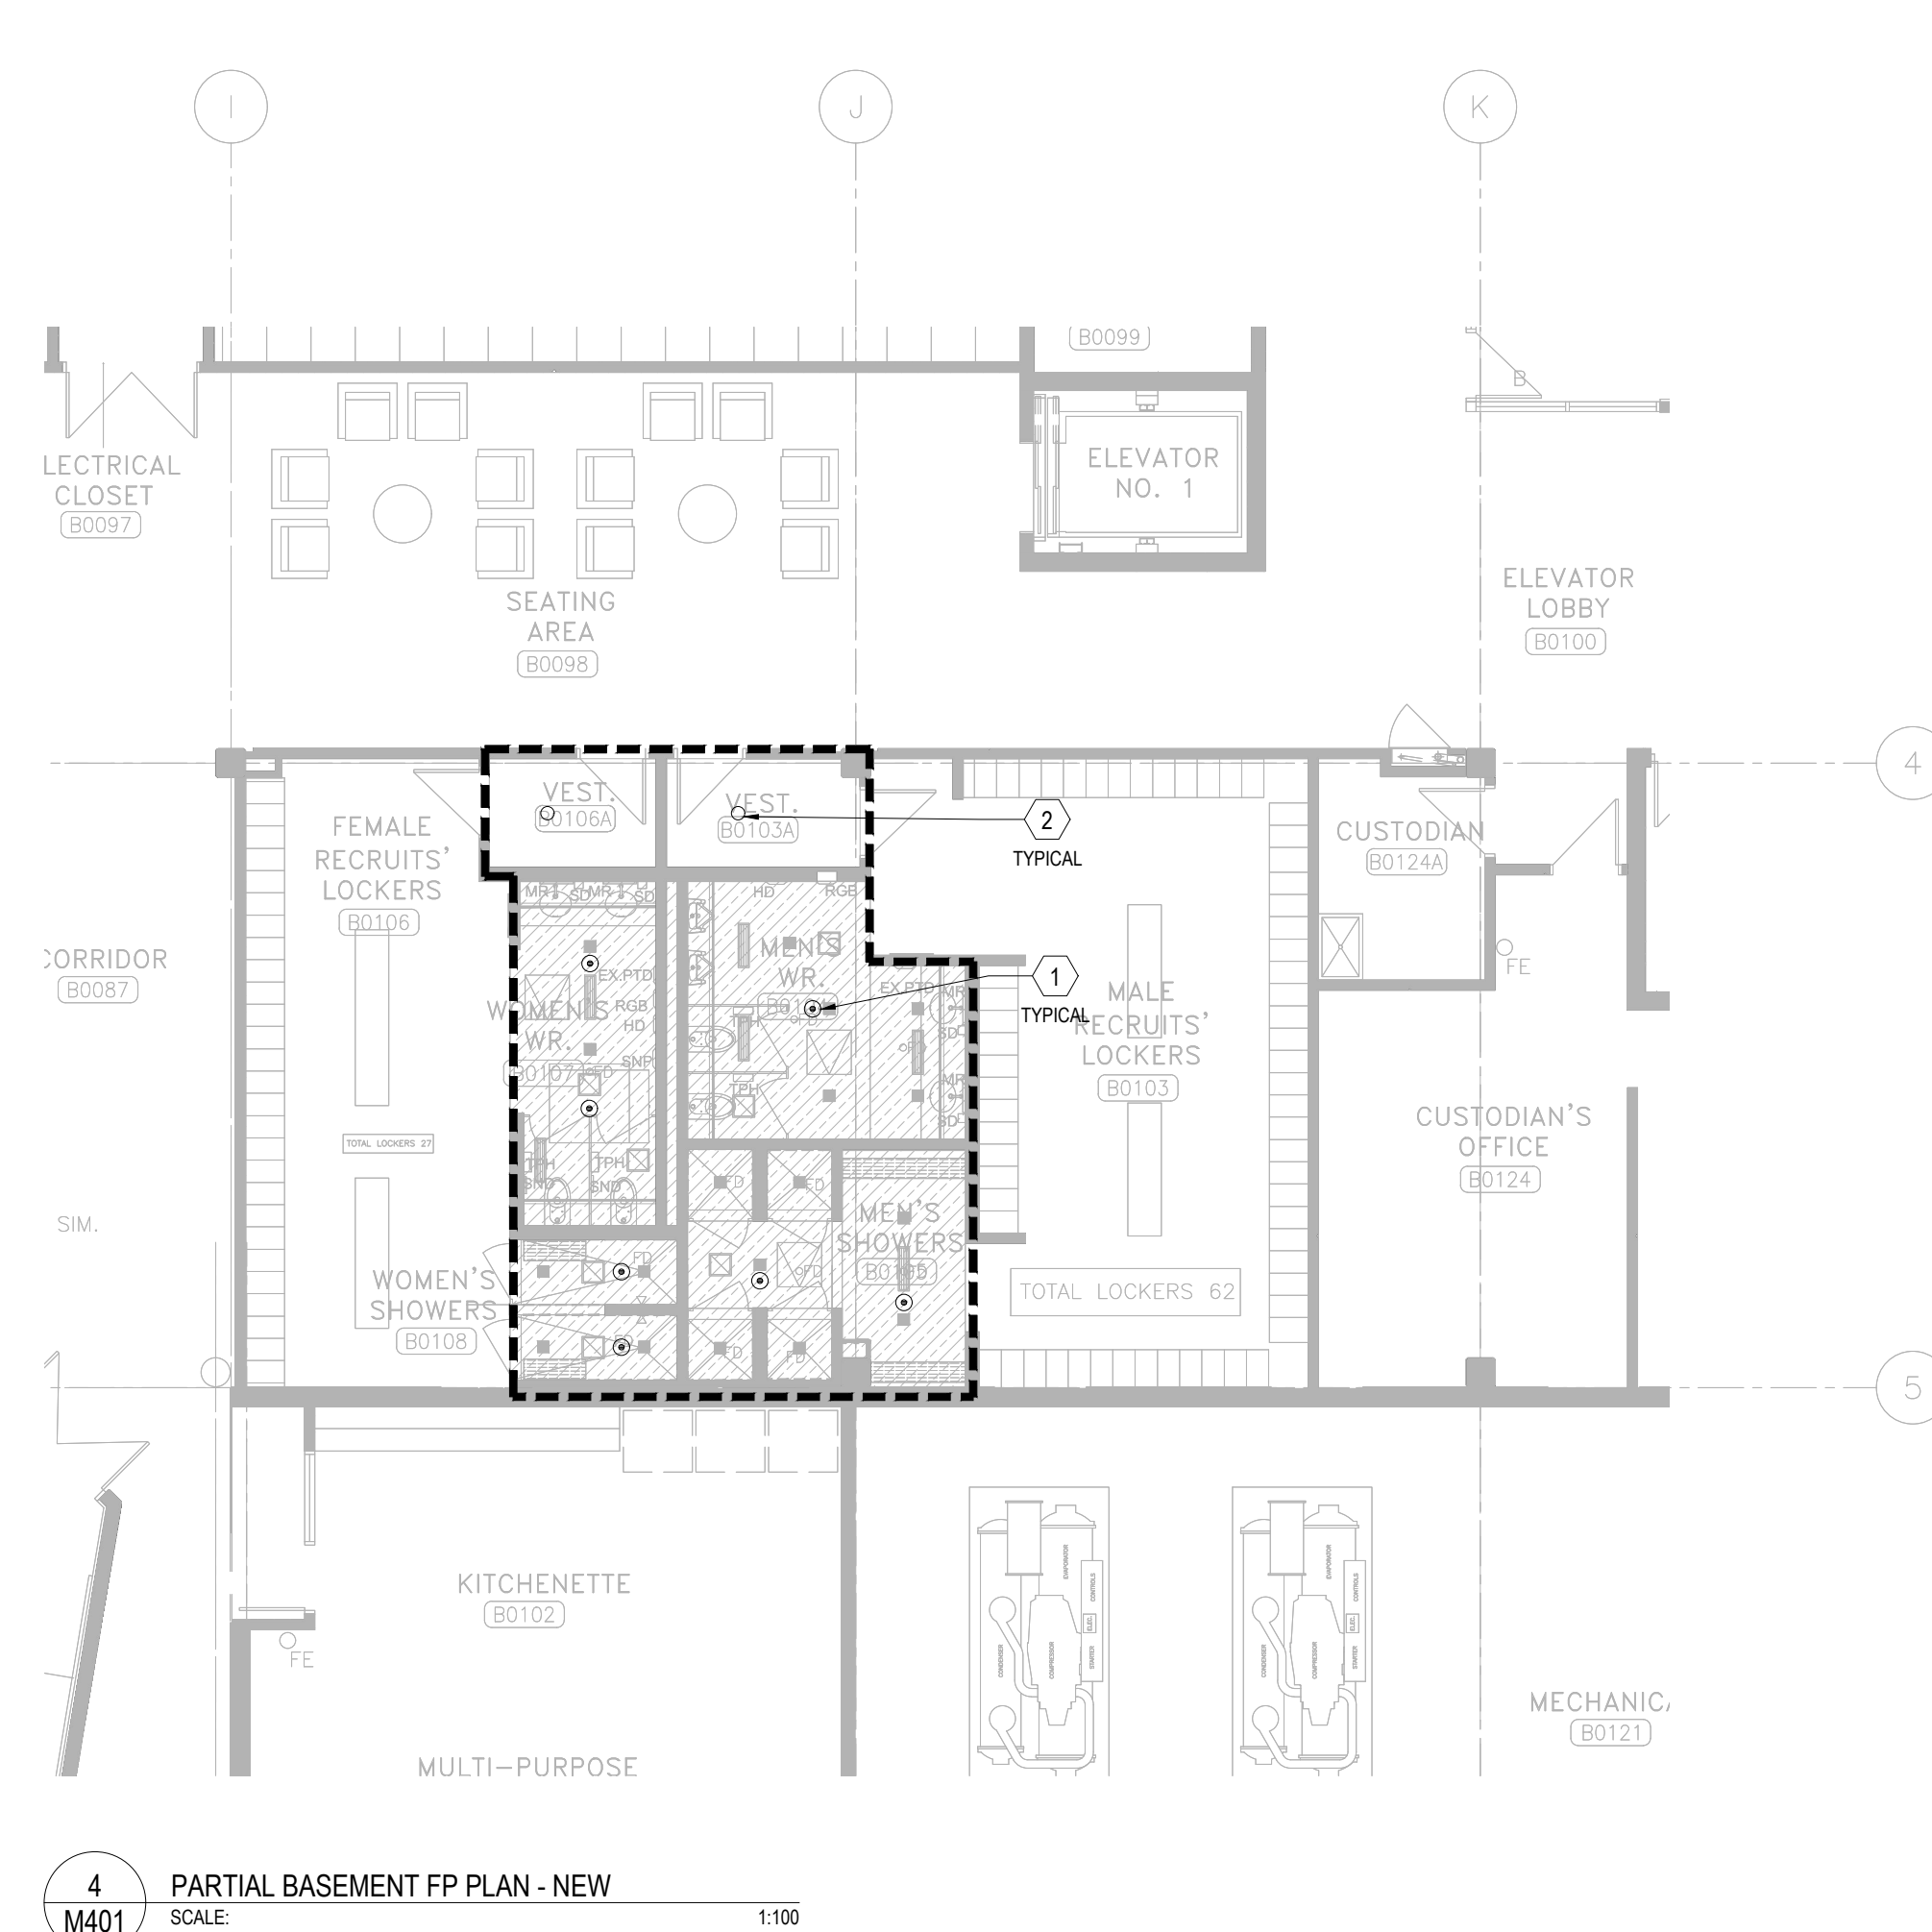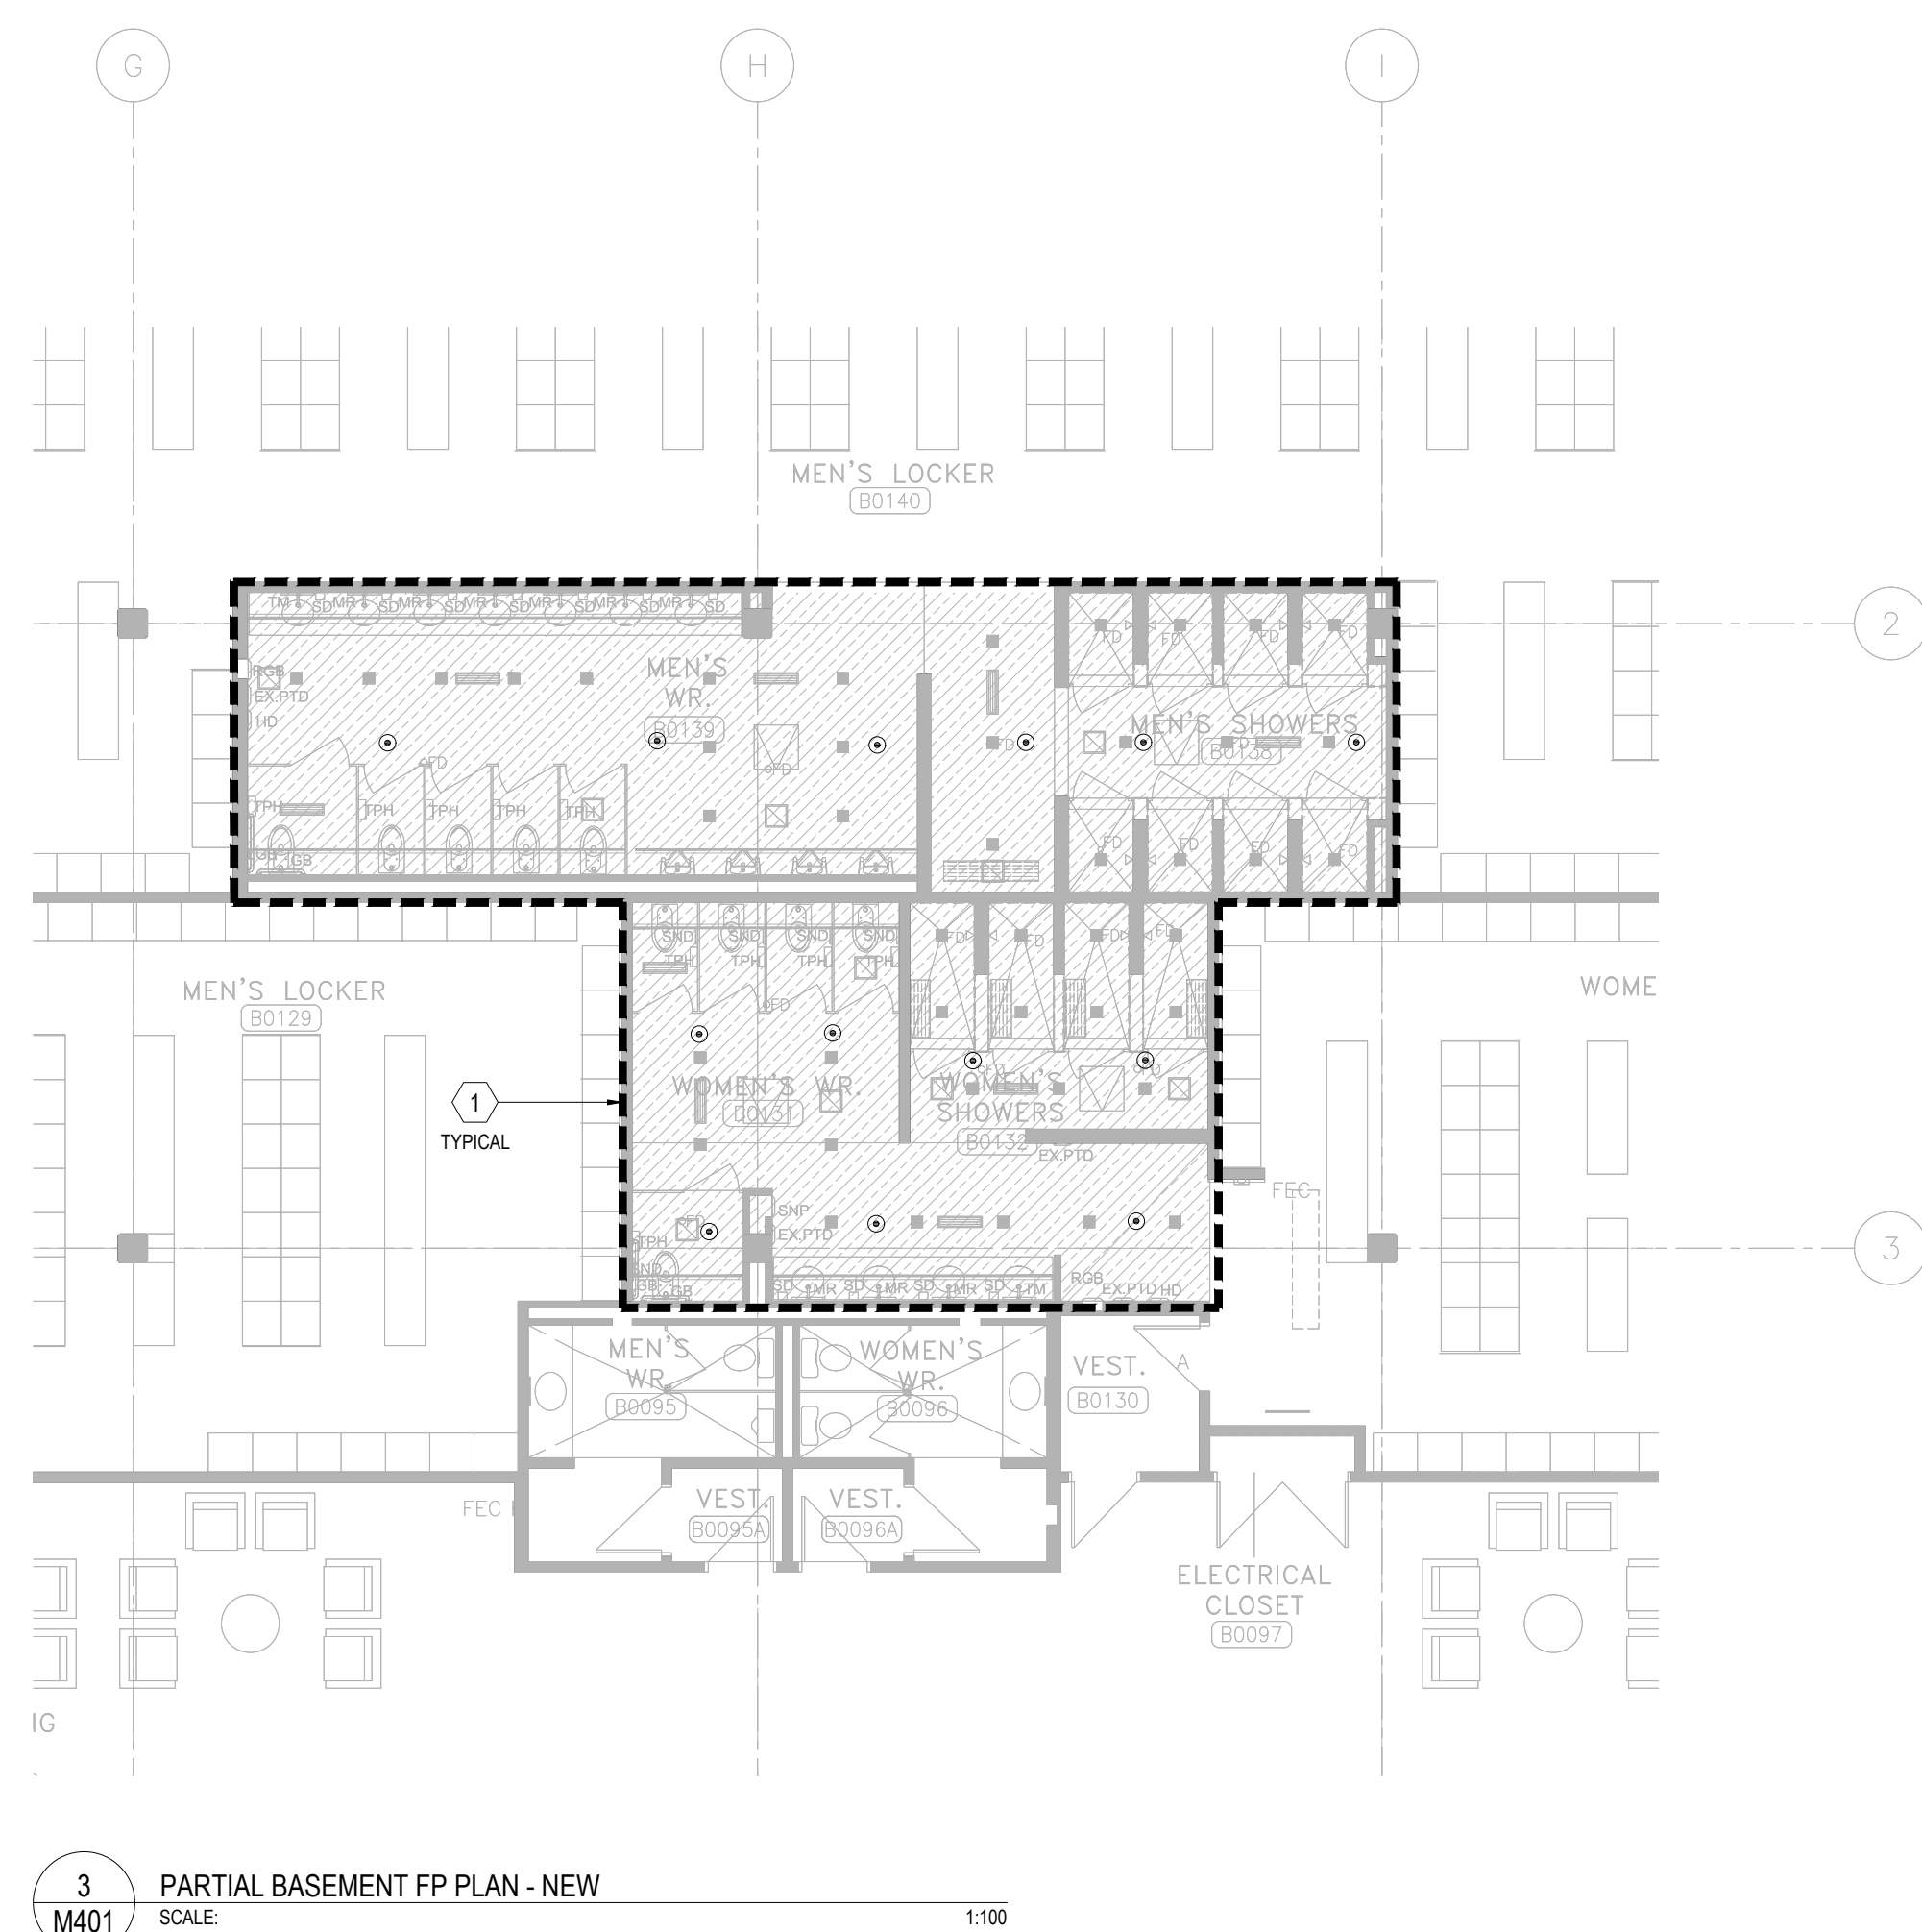

- FIRE PROTECTION DEMOLITION DRAWING NOTES:
- ① ALL EXISTING SPRINKLER SYSTEMS/UPPLY MAIN TO REMAIN. (TYPICAL)
 - ② ALL EXISTING CEILING MOUNTED SPRINKLER HEADS WITHIN THE AREA TO BE DEMOLISHED. CAP BRANCH BACK TO MAIN. PROVIDE IF REQUIRED FOR THE DURATION WHEN SPRINKLER SYSTEM IS DRAINED DOWN. (TYPICAL OF ALL)
 - ③ EXISTING SPRINKLER ZONE CONTROL VALVE CABINET TO REMAIN. (TYPICAL)
 - ④ ALL EXISTING FIRE EXTINGUISHERS WITHIN THIS RENOVATION AREA TO BE REMOVED AND TURNING BACK TO LANDLORD. (TYPICAL)

- GENERAL NOTES:**
1. DO NOT SCALE DRAWINGS. LOCATIONS OF ITEMS ARE APPROXIMATE AND ARE INTENDED TO BE USED FOR COORDINATION. EXACT LOCATIONS ARE DEPENDANT UPON SITE CONDITIONS. REVIEW ANY REVISIONS WITH CONSULTANT.
 2. HEAD LOCATION, HEAD QUANTITY, AND LAYOUT OF SPRINKLER SYSTEMS SHOWN ON DRAWINGS ARE TO ASSIST TENDER COORDINATION ONLY. IT IS THE RESPONSIBILITY OF THE CONTRACTOR TO ENSURE ADEQUATE HEAD COVERAGE, HEAD QUANTITIES, PIPE SIZING, ZONING, AND VALVING FOR THE SYSTEM AS PER NFPA 13 ADHOC OCCUPANCIES, OWNER'S INSURERS' REQUIREMENTS, AND AUTHORITIES HAVING JURISDICTION. INSTALL ADDITIONAL HEADS, VALVES, AND ZONING AS REQUIRED AT NO ADDITIONAL COST TO THE OWNER.
 3. UPON COMPLETION, DIVISION 15 SHALL SUBMIT FIRE PROTECTION ENGINEER'S STAMPED LETTER CERTIFYING THAT ALL FIRE SPRINKLER WORK WITHIN THE EXTENT OF THIS PROJECT COMPLIES WITH NFPA 13 AND CBC.
 4. SIZE REDUCTION OF SPRINKLER MAN SHALL NOT BE ACCEPTED UNLESS APPROVED BY THE CONSULTANT. RE-ROUTING OF SPRINKLER MAN SHALL BE APPROVED IN ADVANCE BY THE CONSULTANT.
 5. EXIST PIPE ROUTES, DROPS, AND FINAL CONNECTIONS SHALL BE DETERMINED ON SITE WITH PROJECT MANAGER. REFER TO INTERIOR DESIGNER DRAWINGS AND SHOP DRAWINGS FOR ALL EQUIPMENT AND FEATURE LOCATIONS AND CONNECTIONS.
 6. PROVIDE ALL REQUIRED CUTTING AND PATCHING OF EXISTING FLOORING TO FACILITATE THE INSTALLATION OF THE MECHANICAL SERVICES OUTLINED FOR THIS SCOPE OF WORK.
 7. SPRINKLER SHOP DRAWINGS INCLUDING HYDRAULIC CALCULATIONS SHALL BE SUBMITTED TO MECHANICAL CONSULTANT IN ORDER TO OBTAIN REVIEW DRAWINGS AND APPROVAL. REVIEW SHALL BE CERTIFIED BY A PROFESSIONAL ENGINEER CURRENTLY PRACTICING IN THE FIRE PROTECTION INDUSTRY.
 8. PROVIDE NEW PORTABLE FIRE EXTINGUISHERS FOR SPACE PER OC OCCUPANCIES.
 9. ALL FIRE PROTECTION SYSTEM SHOULD KEEP IN OPERATION DURING ALL THE CONSTRUCTION STAGES. PROVIDE BUILDING FIRE WATCH DURING SPRINKLER HEAD DEMOLISH AND INSTALLATION PERIOD.

- FIRE PROTECTION NEW WORK DRAWING NOTES:
- ① PROVIDE NEW CEILING CONCEALED PENDANT SPRINKLER HEADS FOR ALL GYPSUM ARMSTRONG WOOD WORKS FLAT CEILING AREA. EXTEND OR PROVIDE NEW BRANCH PIPE TO SUIT NEW SPRINKLER HEAD LOCATION. (TYPICAL).
- ② PROVIDE NEW UPRIGHT SPRINKLER HEADS FOR EXPOSED CEILING AREA. EXTEND OR PROVIDE NEW BRANCH PIPE TO SUIT NEW SPRINKLER HEAD LOCATION. (TYPICAL).

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5.	ISSUED FOR TENDER	2026.05.01
4.	ISSUED FOR BUILDING PERMIT	2026.04.08
3.	ISSUED FOR 100% CLIENT REVIEW	2026.03.31
2.	ISSUED FOR 66% CLIENT REVIEW	2026.01.09
1.	ISSUED FOR COSTING REVIEW	2025.11.24

REVISION
PROJECT




REGION OF PEEL
EMIL V. KOLB CENTRE
PEEL REGIONAL POLICE FACILITY
INTERIOR RENOVATION PROJECT
180 DERRY ROAD EAST, MISSISSAUGA, ON L5T 2Y5





The contractor shall check and verify all dimensions and report all errors and omissions to the architect and the design professional whose seal is affixed to this drawing. Do not scale the drawings.

This drawing shall not be used for construction purposes until

NORTH	STRUCTURAL CONSULTANT	DATE
PROJECT NO. 	Stephenson Engineering	
	MECHANICAL CONSULTANT	
	EXP Services Inc.	
	ELECTRICAL CONSULTANT	
	EXP Services Inc.	


SHEET TITLE
**PARTIAL BASEMENT FLOOR
- FP DEMO & NEW**

SHEET NO. M401	DRAWN BY SS/LL	CHECKED KE
	PROJECT NO. MRK-25008951-A0	
	SCALE	

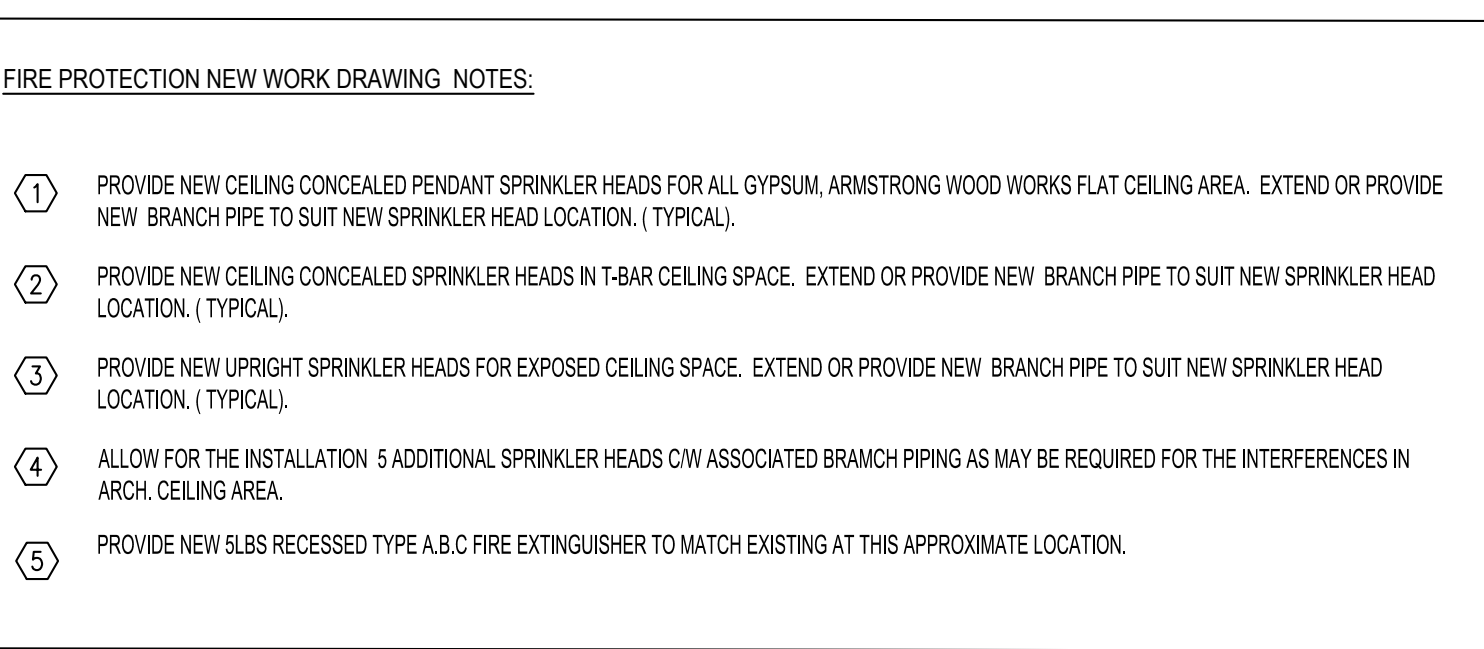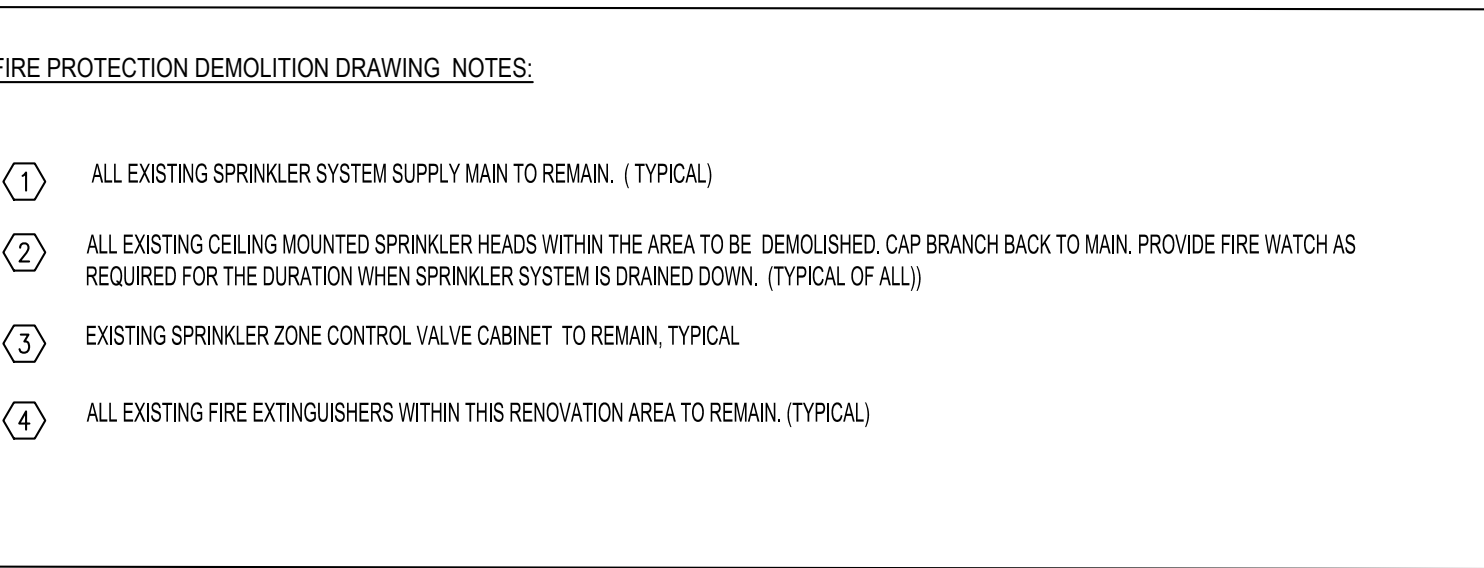


2 PARTIAL GROUND FLOOR FP PLAN - NEW
M402 SCALE: 1:100


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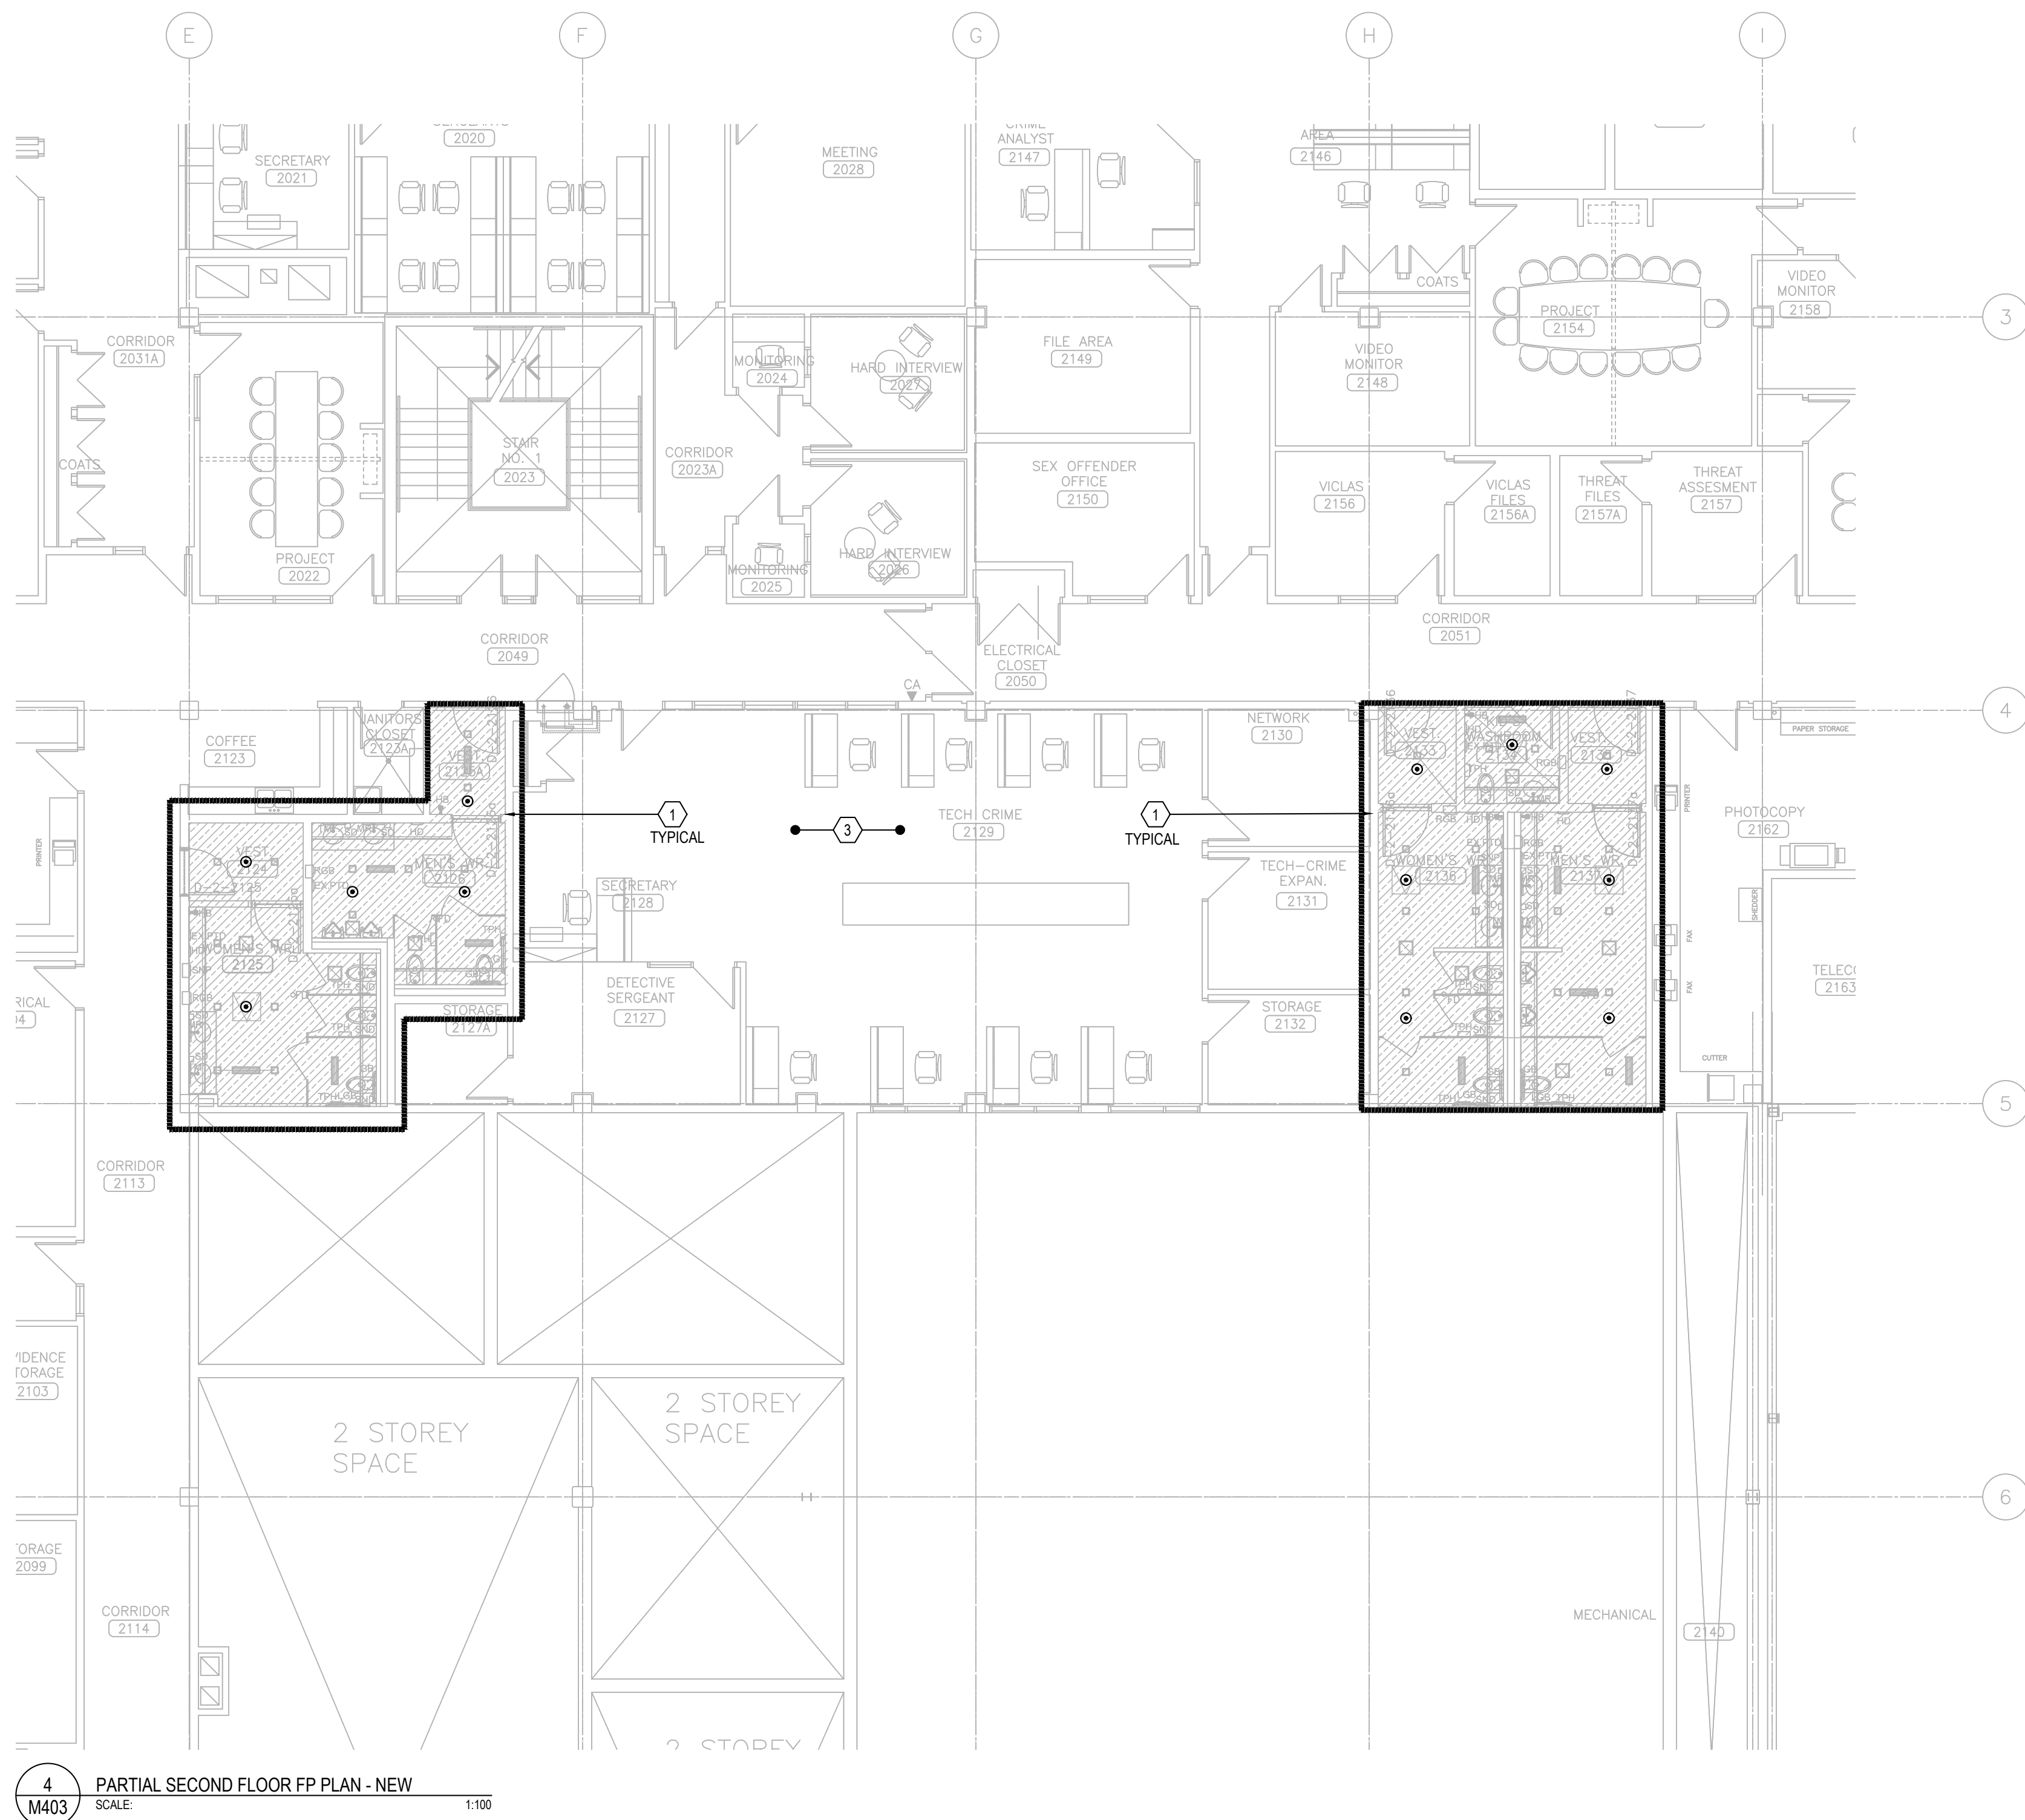
1 PARTIAL SECOND FP PLAN - DEMO
SCALE 1:100

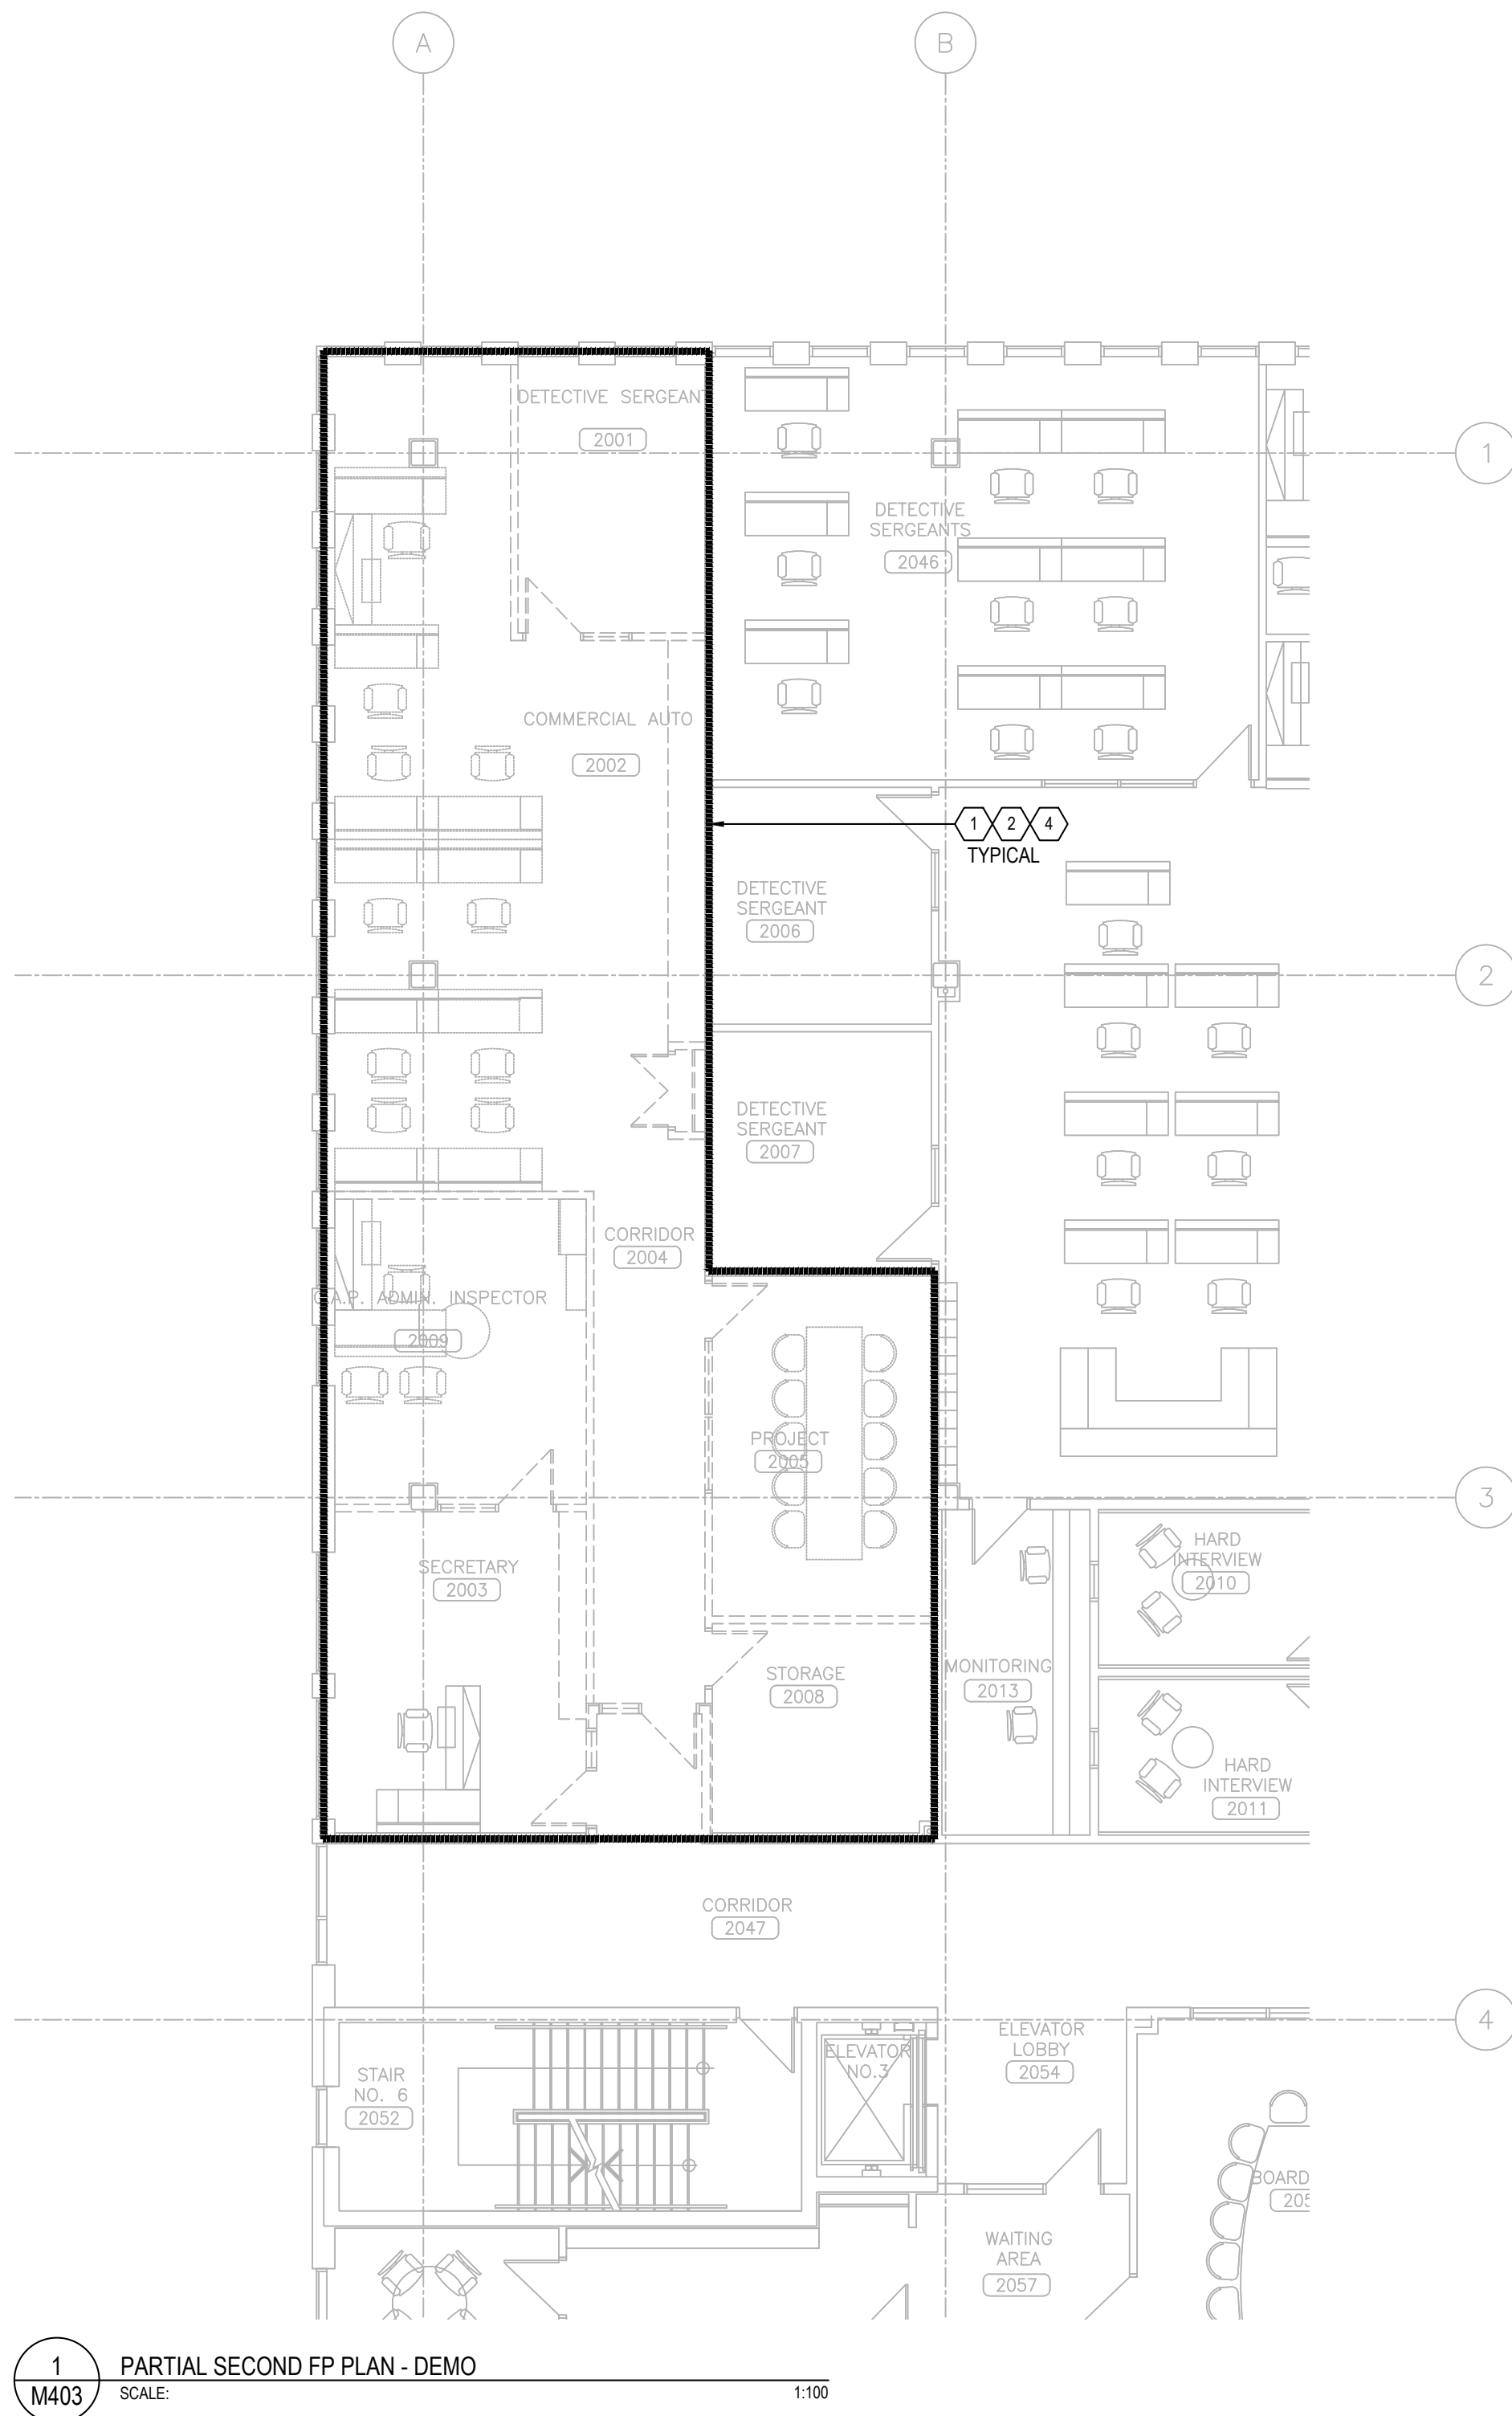

2 PARTIAL SECOND FP PLAN - DEMO
SCALE 1:100

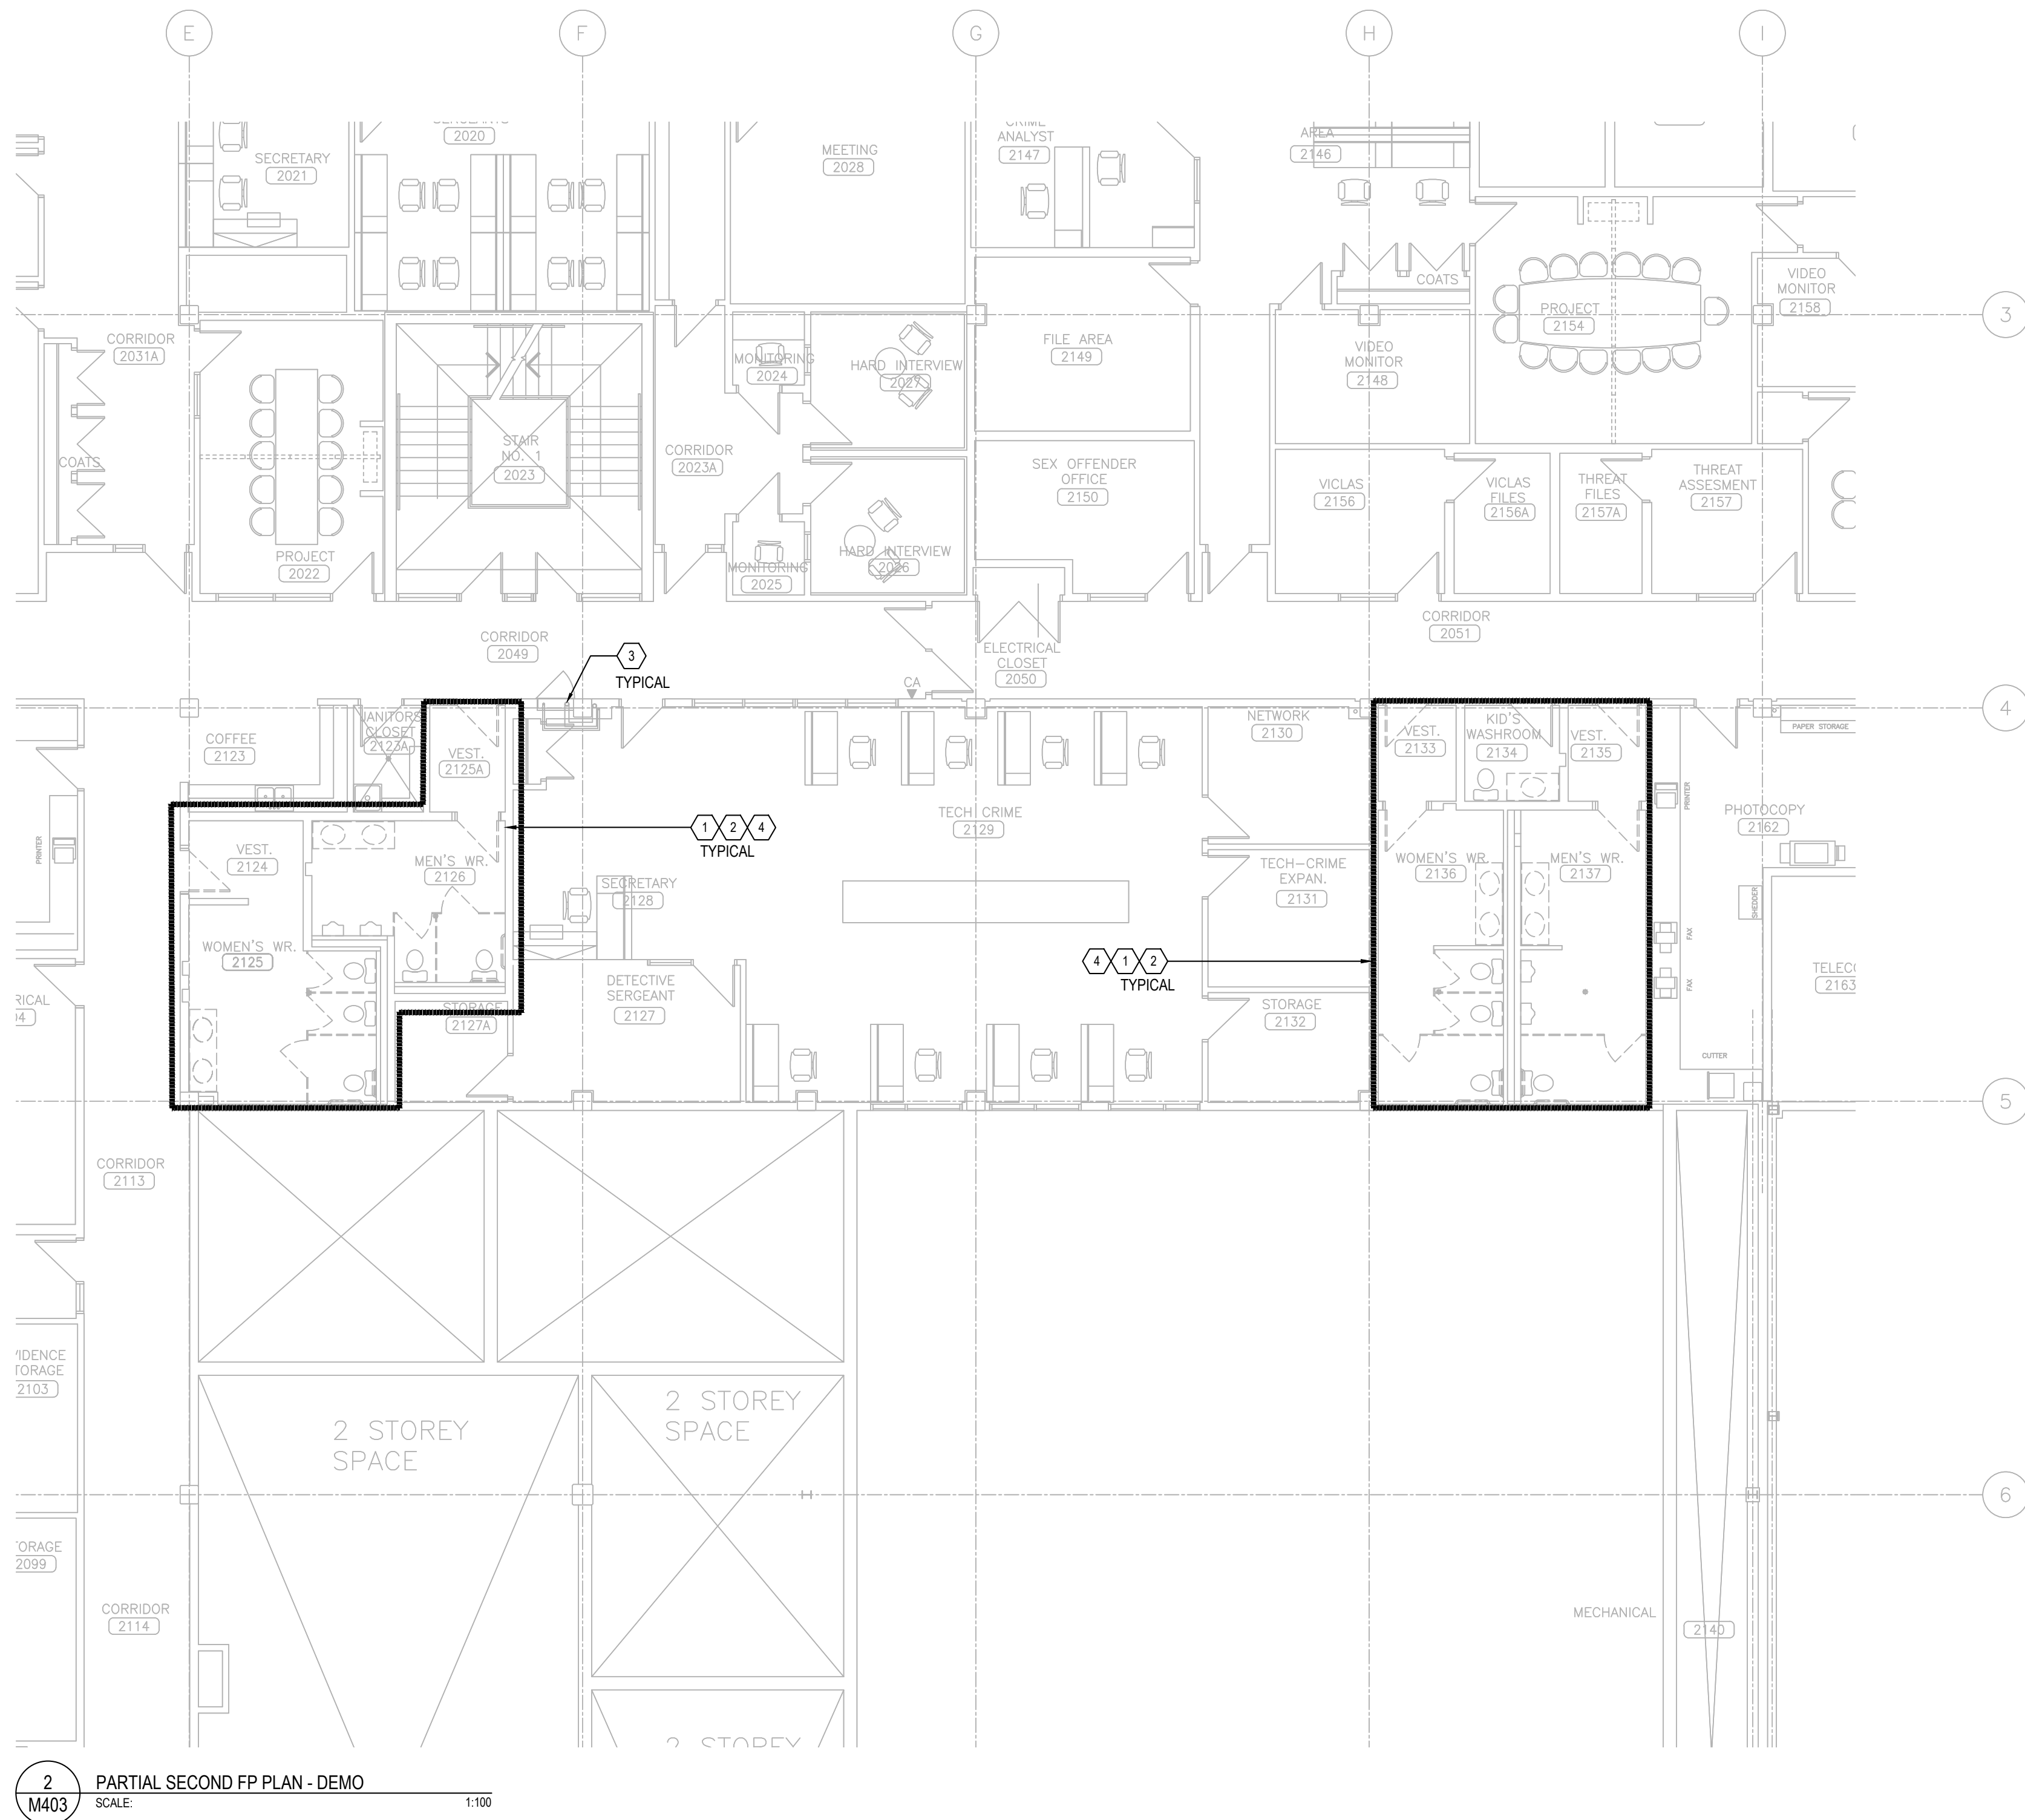

3 PARTIAL SECOND FLOOR FP PLAN - NEW
SCALE 1:100

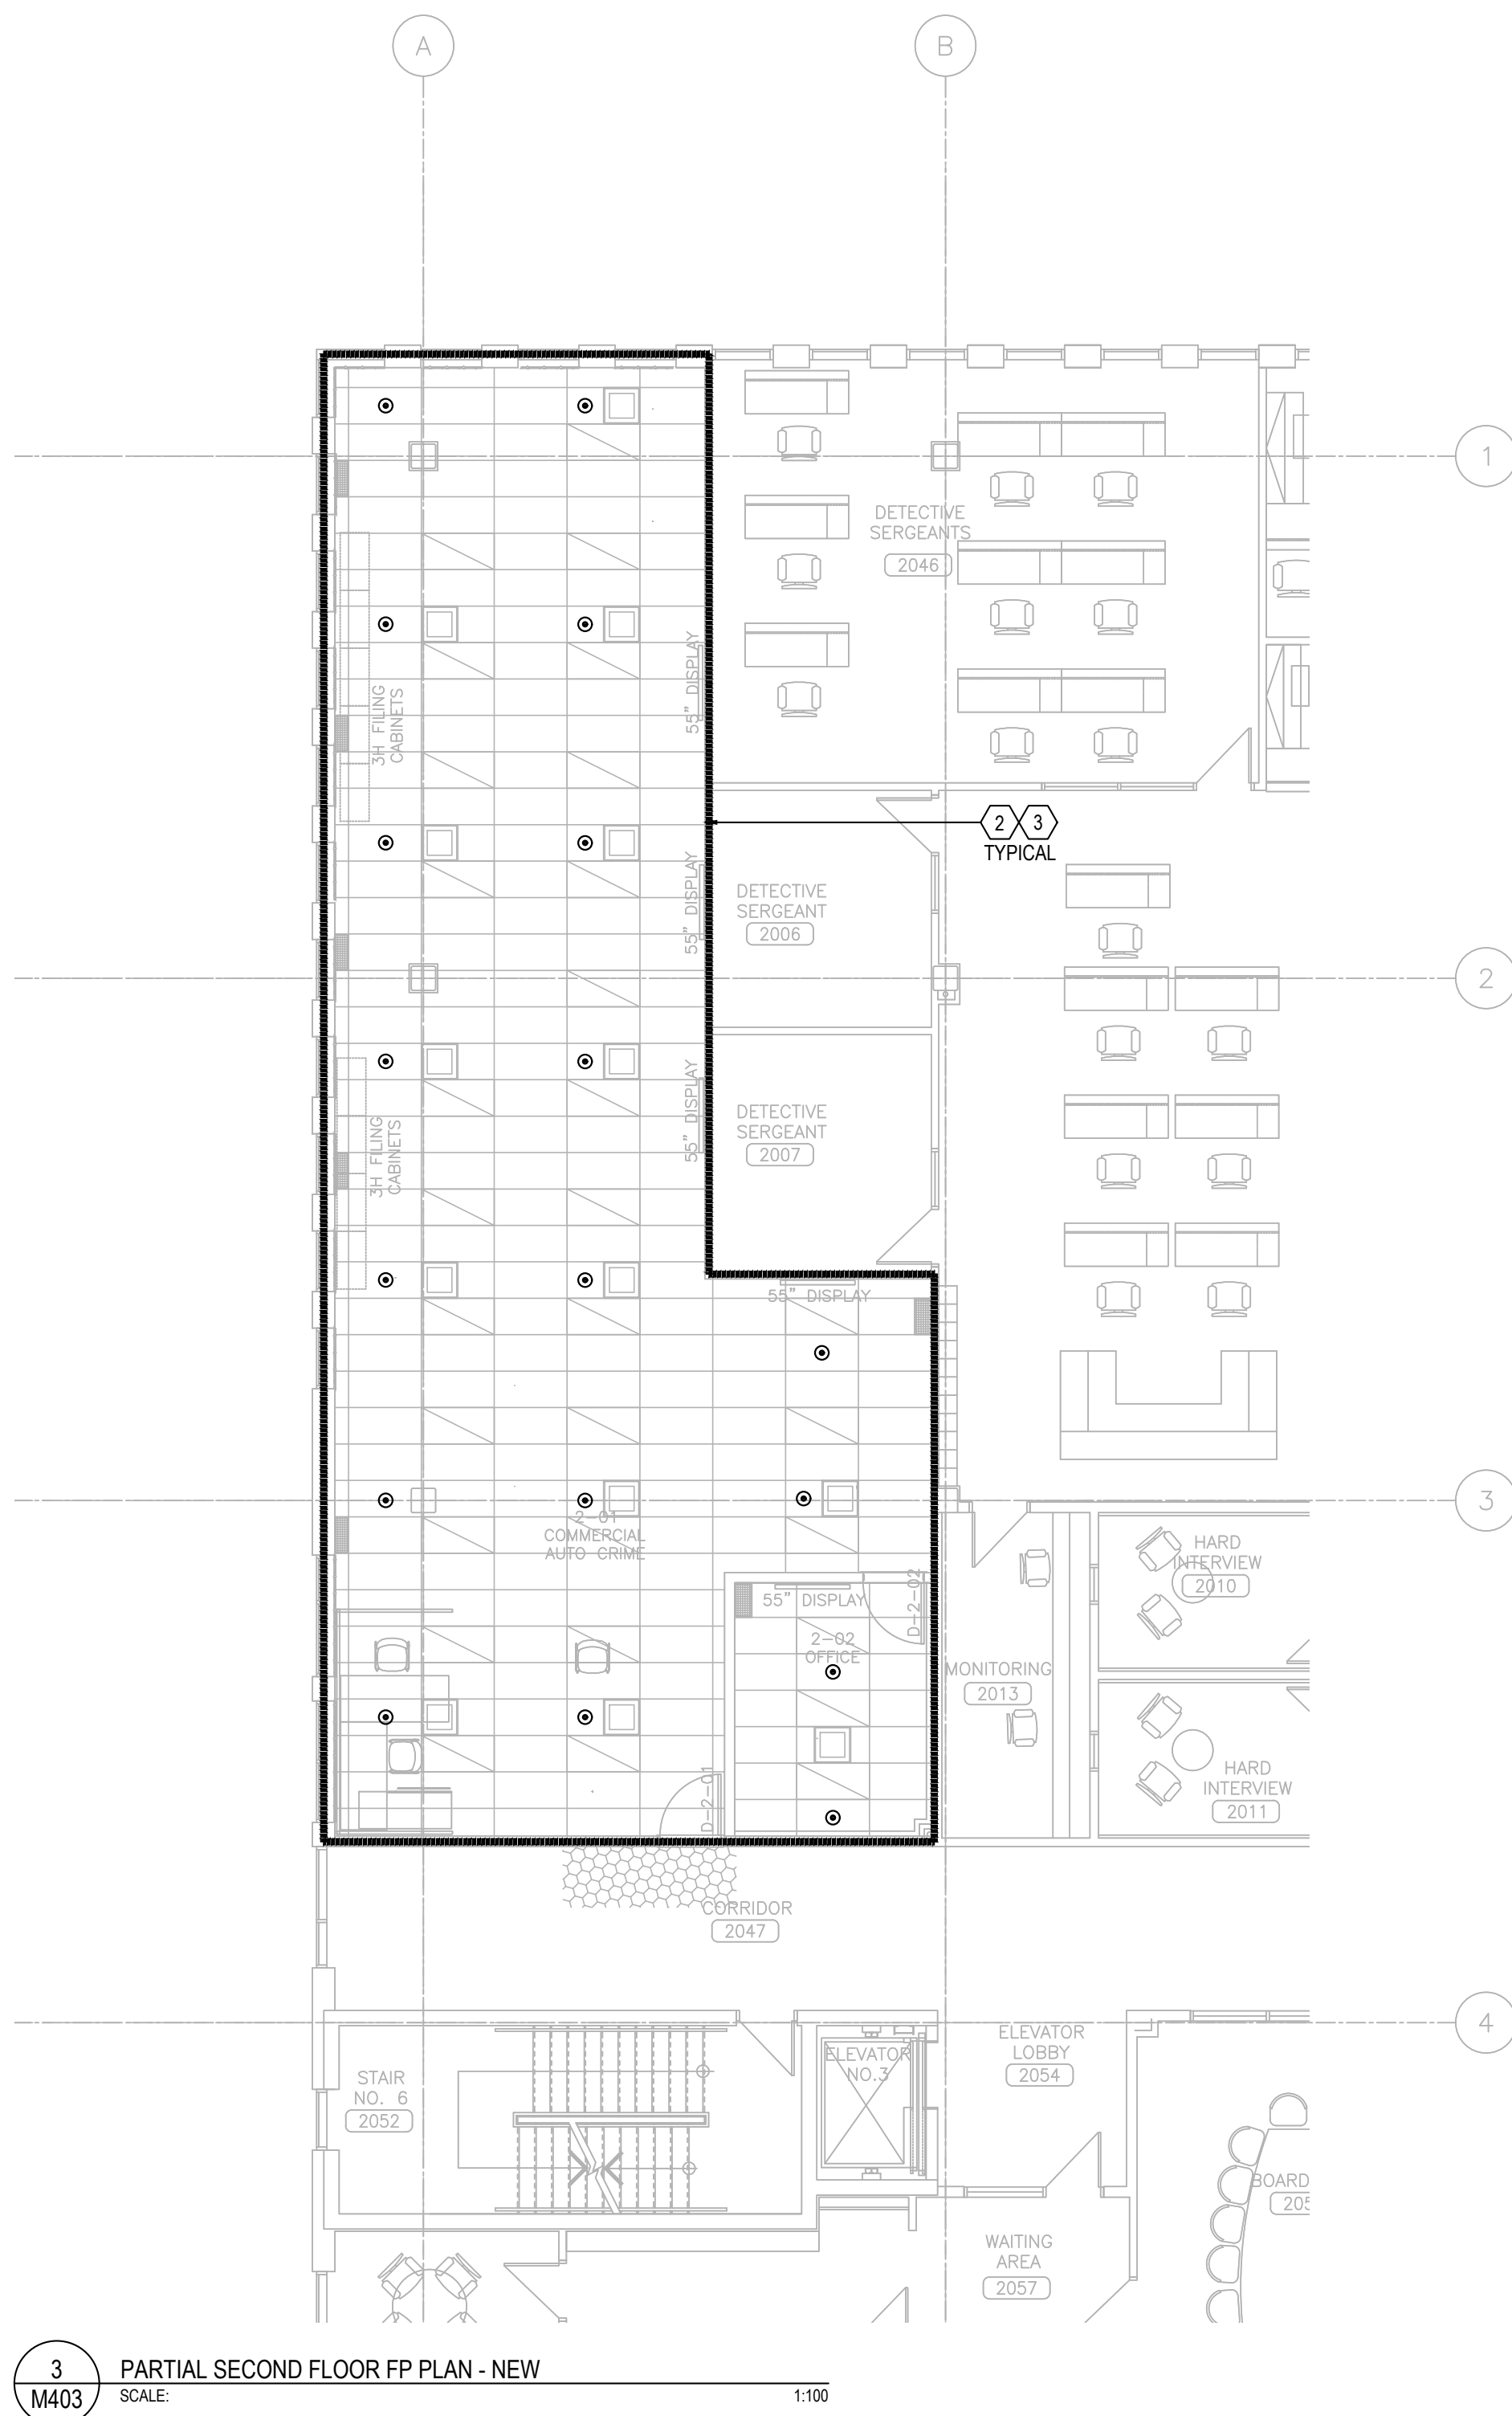

4 PARTIAL SECOND FLOOR FP PLAN - NEW
SCALE 1:100

- GENERAL NOTES:**
1. PRIOR TO COMMENCEMENT OF THE WORK, ORDERING OF EQUIPMENT AND/OR FABRICATING MATERIALS, THE MECHANICAL CONTRACTOR SHALL VISIT THE SITE TO VERIFY EXISTING CONDITIONS. THIS SHALL BE DONE IN ORDER TO CONFIRM THAT EQUIPMENT AND SERVICES CAN BE INSTALLED AS SHOWN ON THE DRAWINGS. IT IS THE CONTRACTOR'S RESPONSIBILITY TO NOTIFY THE ENGINEER OF ANY DISCREPANCIES, OMISSIONS AND/OR INTERFERENCES PRIOR TO COMMENCEMENT OF THE WORK.
 2. DEMOLITION DRAWINGS HAVE BEEN PREPARED AS A GENERAL GUIDE TO THE CONTRACTOR. NOT ALL SERVICES HAVE BEEN SHOWN. THE CONTRACTOR SHALL REMOVE ALL REDUNDANT SERVICES TO THE NEAREST ACTIVE REMAINING SOURCE, WHETHER THEY HAVE OR HAVE NOT BEEN SHOWN. NO EXTRAS WILL BE ENTERAINED FOR DEMOLITION.
 3. DEMOLITION SCOPE REFER ON EXISTING 'AS BUILT' DRAWING FROM ORIGINAL CONSTRUCTION REFER TO APPENDIX. NOT ALL SERVICES HAVE BEEN SHOWN. IT SHALL BE THE RESPONSIBILITY OF THE CONTRACTOR TO SURVEY THE SPACE AND VERIFY EXTENT OF DEMOLITION WORK INVOLVED.
 4. DURING DEMOLITION STAGE THE SPRINKLER HEAD WILL BE TURNED UPRIGHT TO SUIT REMOVAL OF REFLECTED CEILING. ALL FIRE PROTECTION SYSTEM SHOULD KEEP IN OPERATION DURING ALL STAGES OF CONSTRUCTION OTHERWISE CONTRACTOR SHOULD COORDINATE WITH BUILDING OPERATION TEAM TO PROVIDE FIRE WATCH DURING FIRE PROTECTION SYSTEM SHORT TIME NON WORKING PERIOD.
 5. UNLESS SPECIFICALLY SHOWN TO REMAIN ON THE DRAWINGS, REMOVE ALL EXISTING SPRINKLER HEADS FROM AREA OF RENOVATION. CAP EXISTING SPRINKLER BRANCH PIPE FOR NEW CONNECTION. ALLOW FOR CUTTING AND PATCHING OF CEILING AND WALLS NECESSARY TO REMOVE SERVICES IN THE EVENT THAT THE EXISTING CEILING OR WALLS ARE NOT BEING REMOVED BY THE GENERAL CONTRACTOR.
 6. PRIOR TO DEMOLITION, COORDINATE SHUT DOWN WITH BUILDING OPERATION TEAM AND ISOLATE SERVICES. PHASING REQUIREMENTS OF PROJECT MAY REQUIRE SOME EXISTING SERVICE BE LEFT IN OPERATION UNTIL NEW SERVICES ARE INSTALLED. CAREFULLY REVIEW PHASING SET OUT BY ARCHITECT.

- FIRE PROTECTION DEMOLITION DRAWING NOTES:**
1. ALL EXISTING SPRINKLER SYSTEMS SUPPLY MAIN TO REMAIN. (TYPICAL)
 2. ALL EXISTING CEILING MOUNTED SPRINKLER HEADS WITHIN THE AREA TO BE DEMOLISHED. CAP BRANCH BACK TO MAIN. PROVIDE FIRE WATCH AS REQUIRED FOR THE DURATION WHEN SPRINKLER SYSTEM IS DRAINED DOWN. (TYPICAL OF ALL)
 3. EXISTING SPRINKLER ZONE CONTROL VALVE CABINET TO REMAIN. (TYPICAL)
 4. ALL EXISTING FIRE EXTINGUISHERS WITHIN THIS RENOVATION AREA TO BE REMOVED AND TURNING BACK TO LANDLORD. (TYPICAL)

- GENERAL NOTES:**
1. DO NOT SCALE DRAWINGS. LOCATIONS OF ITEMS ARE APPROXIMATE AND ARE INTENDED TO BE USED FOR COORDINATION. EXACT LOCATIONS ARE DEPENDANT UPON SITE CONDITIONS. REVIEW ANY REVISIONS WITH CONSULTANT.
 2. HEAD LOCATION, HEAD QUANTITY, AND LAYOUT OF SPRINKLER SYSTEMS SHOWN ON DRAWINGS ARE TO ASSIST TENDER COORDINATION ONLY. IT IS THE RESPONSIBILITY OF THE CONTRACTOR TO INSURE ADEQUATE HEAD COVERAGE, HEAD QUANTITIES, PIPE SIZING, ZONING, AND VALVING FOR THE SYSTEM AS PER NFPA 13 HAZARDOUS OCCUPANCIES, OWNER'S INSURERS' STANDARDS, AND AUTHORITIES HAVING JURISDICTION. INSTALL ADDITIONAL HEADS, VALVES, AND RESIZE PIPING AS REQUIRED AT NO ADDITIONAL COST TO THE OWNER.
 3. UPON COMPLETION, DIVISION 15 SHALL SUBMIT FIRE PROTECTION ENGINEER STAMPED LETTER CERTIFYING THAT ALL FIRE SPRINKLER WORKS WITHIN THE EXTENT OF THIS PROJECT COMPLIES WITH NFPA 13 AND CBC.
 4. SIZE REDUCTION OF SPRINKLER MAIN SHALL NOT BE ACCEPTED UNLESS APPROVED BY THE CONSULTANT. RE-ROUTING OF SPRINKLER MAIN SHALL BE APPROVED IN ADVANCE BY THE CONSULTANT.
 5. EXACT PIPE ROUTES, DROPS, AND FINAL CONNECTIONS SHALL BE DETERMINED ON SITE WITH PROJECT MANAGER. REFER TO INTERIOR DESIGNER DRAWINGS AND SHOP DRAWINGS FOR ALL EQUIPMENT AND FIXTURE LOCATIONS AND CONNECTIONS.
 6. PROVIDE ALL REQUIRED CUTTING AND PATCHING OF EXISTING FLOORING TO FACILITATE THE INSTALLATION OF THE MECHANICAL SERVICES OUTLINED FOR THIS SCOPE OF WORK.
 7. SPRINKLER SHOP DRAWINGS INCLUDING HYDRAULIC CALCULATIONS SHALL BE SUBMITTED TO MECHANICAL CONSULTANT IN DUPLICATE FOR REVIEW. DRAWINGS AND CALCULATIONS SHALL BE CERTIFIED BY A PROFESSIONAL ENGINEER CURRENTLY PRACTICING IN THE FIRE PROTECTION INDUSTRY.
 8. PROVIDE NEW PORTABLE FIRE EXTINGUISHERS FOR SPACE PER OFC REQUIREMENTS.
 9. ALL FIRE PROTECTION SYSTEM SHOULD KEEP IN OPERATION DURING ALL THE CONSTRUCTION STAGES. PROVIDE BUILDING FIRE WATCH DURING SPRINKLER HEAD DEMOLISH AND INSTALLATION PERIOD.

- FIRE PROTECTION NEW WORK DRAWING NOTES:**
1. PROVIDE NEW CEILING CONCEALED PENDANT SPRINKLER HEADS FOR ALL GYPSUM, ARMSTRONG WOOD WORKS FLAT CEILING AREA. EXTEND OR PROVIDE NEW BRANCH PIPE TO SUIT NEW SPRINKLER HEAD LOCATION (TYPICAL)
 2. PROVIDE NEW CEILING CONCEALED SPRINKLER HEADS IN T-BAY CEILING SPACE. EXTEND OR PROVIDE NEW BRANCH PIPE TO SUIT NEW SPRINKLER HEAD LOCATION (TYPICAL)
 3. ALLOW FOR THE INSTALLATION 5 ADDITIONAL SPRINKLER HEADS ON ASSOCIATED BRANCH PIPING AS MAY BE REQUIRED FOR THE INTERFERENCES IN ARCH. CEILING AREA.


NO.	DESCRIPTION	DATE
6	ISSUED FOR TENDER	2026.05.01
4	ISSUED FOR BUILDING PERMIT	2026.04.08
3	ISSUED FOR 100% CLIENT REVIEW	2026.03.31
2	ISSUED FOR 60% CLIENT REVIEW	2026.01.09
1	ISSUED FOR COSTING REVIEW	2025.11.24

REVISIONS

PROJECT




REGION OF PEEL
EMIL V. KOLB CENTRE
PEEL REGIONAL POLICE FACILITY
INTERIOR RENOVATION PROJECT
180 DERRY ROAD EAST, MISSISSAUGA, ON L5T 2Y5

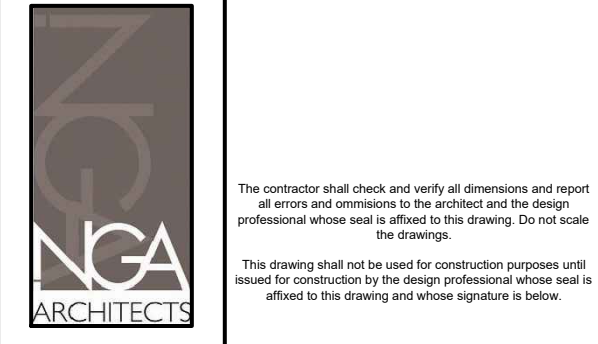

STRUCTURAL CONSULTANT
STEPHENSON ENGINEERING
MECHANICAL CONSULTANT
EXP SERVICES INC.
ELECTRICAL CONSULTANT
EXP SERVICES INC.

SHEET TITLE
PARTIAL SECOND FLOOR -
FP DEMO & NEW

SHEET NO.	DRAWN BY	CHECKED BY
M403	SBILL	ME
PROJECT NO.	MRK-25008951-A0	SCALE

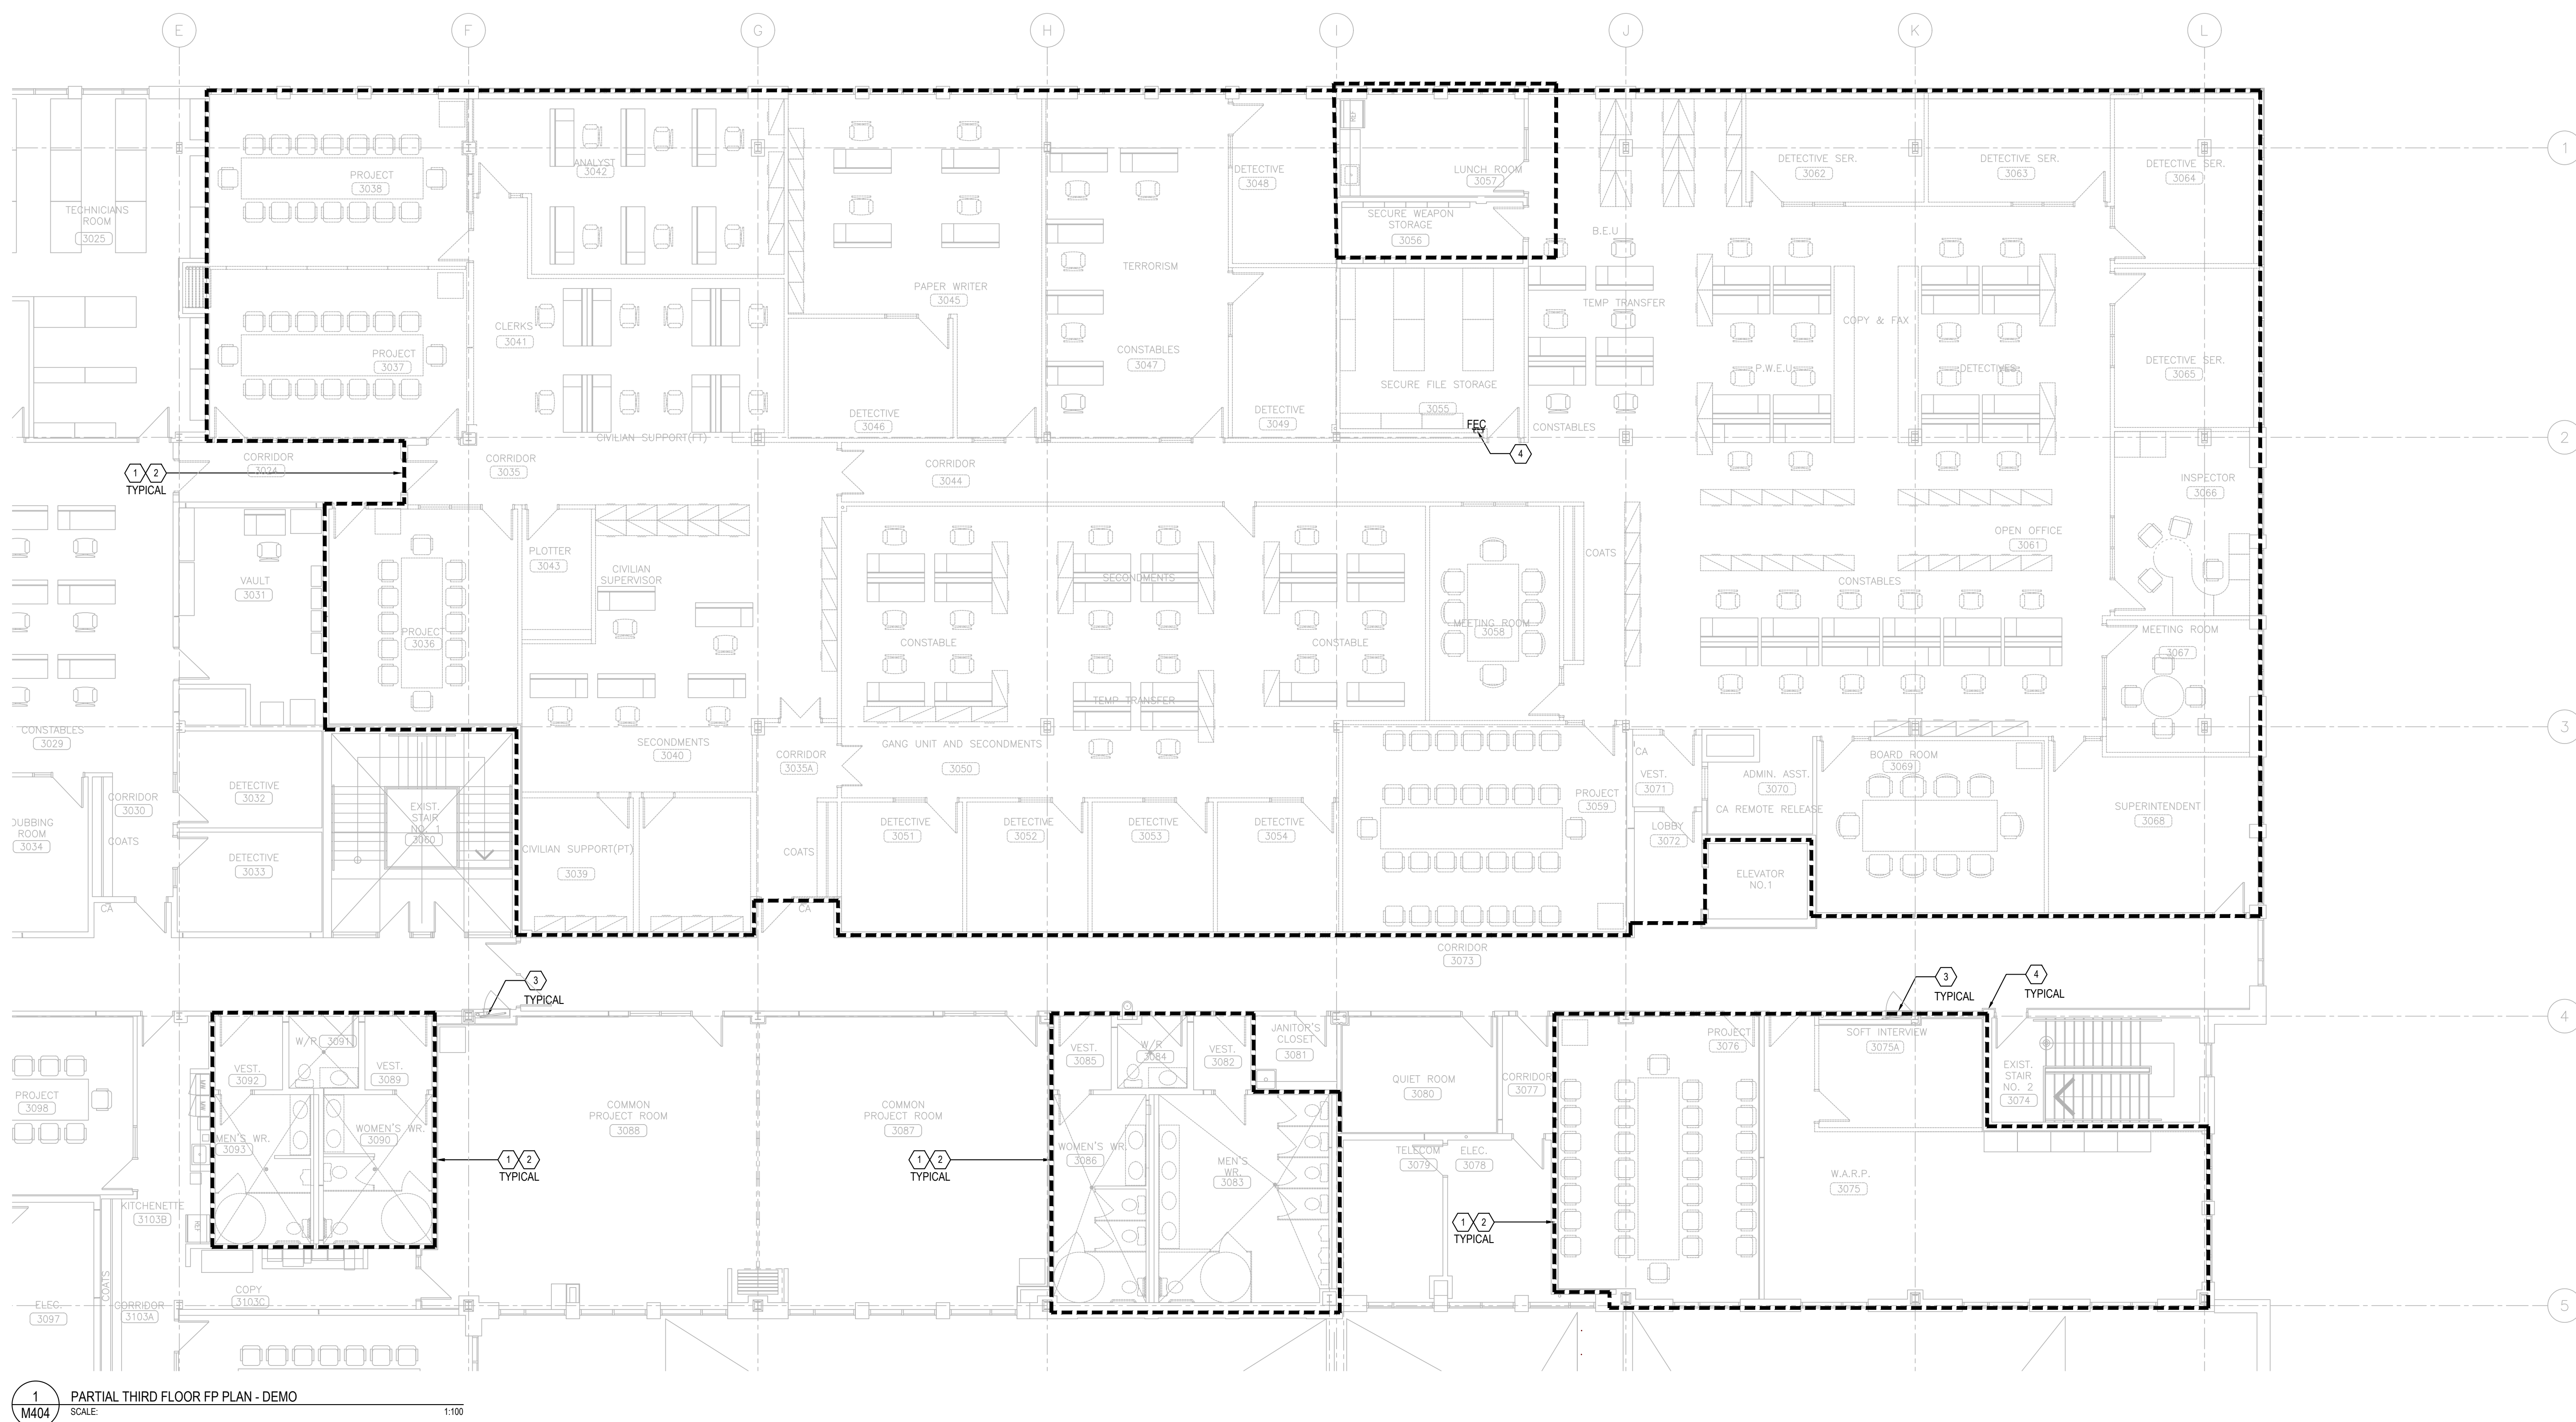


GENERAL NOTES:

1. PRIOR TO COMMENCEMENT OF THE WORK, ORDERING OF EQUIPMENT AND/OR FABRICATING MATERIALS, THE MECHANICAL CONTRACTOR SHALL VISIT THE SITE TO VERIFY EXISTING CONDITIONS. THIS SHALL BE DONE IN ORDER TO CONFIRM THAT EQUIPMENT AND SERVICES CAN BE INSTALLED AS SHOWN ON THE DRAWINGS. IT IS THE CONTRACTOR'S RESPONSIBILITY TO NOTIFY THE ENGINEER OF ANY DISCREPANCIES, OMISSIONS AND/OR INTERFERENCES PRIOR TO COMMENCEMENT OF THE WORK.
2. DEMOLITION DRAWINGS HAVE BEEN PREPARED AS A GENERAL GUIDE TO THE CONTRACTOR. NOT ALL SERVICES HAVE BEEN SHOWN. THE CONTRACTOR SHALL REMOVE ALL REDUNDANT SERVICES TO THE NEAREST ACTIVE REMAINING SOURCE, WHETHER THEY HAVE OR HAVE NOT BEEN SHOWN. NO EXTRAS WILL BE ENTERTAINED FOR DEMOLITION.
3. DEMOLITION SCOPE REFER ON EXISTING 'AS BUILT' DRAWING FROM ORIGINAL CONSTRUCTION REFER TO APPENDIX. NOT ALL SERVICES HAVE BEEN SHOWN. IT SHALL BE THE RESPONSIBILITY OF THE CONTRACTOR TO SURVEY THE SPACE AND VERIFY EXTENT OF DEMOLITION WORK INVOLVED.
4. DURING DEMOLITION STAGE THE SPRINKLER HEAD WILL BE TURNED UPRIGHT TO SUIT REMOVAL OF REFLECTED CEILINGS ALL FIRE PROTECTION SYSTEM SHOULD KEEP IN OPERATION DURING ALL STAGES OF CONSTRUCTION OTHERWISE CONTRACTOR SHOULD COORDINATE WITH BUILDING OPERATION TEAM TO PROVIDE FIRE WATCH DURING FIRE PROTECTION SYSTEM SHORT TIME NON WORKING PERIOD.
5. UNLESS SPECIFICALLY SHOWN TO REMAIN ON THE DRAWINGS, REMOVE ALL EXISTING SPRINKLER HEADS FROM AREA OF RENOVATION. CAP EXISTING SPRINKLER BRANCH PIPE FOR NEW CONNECTION, ALLOW FOR CUTTING AND PATCHING OF CEILINGS AND WALLS NECESSARY TO REMOVE SERVICES IN THE EVENT THAT THE EXISTING CEILINGS OR WALLS ARE NOT BEING REMOVED BY THE GENERAL CONTRACTOR.
6. PRIOR TO DEMOLITION, COORDINATE SHUT DOWN WITH BUILDING OPERATION TEAM AND ISOLATE SERVICES. PHASING REQUIREMENTS OF PROJECT MAY REQUIRE SOME EXISTING SERVICE BE LEFT IN OPERATION UNTIL NEW SERVICES ARE INSTALLED. CAREFULLY REVIEW PHASING SET OUT BY ARCHITECT.

FIRE PROTECTION DEMOLITION DRAWING NOTES:

1. ALL EXISTING SPRINKLER SYSTEMS SUPPLY MAIN TO REMAIN (TYPICAL)
2. ALL EXISTING CEILING MOUNTED SPRINKLER HEADS WITHIN THE AREA TO BE DEMOLISHED, CAP BRANCH BACK TO MAIN, PROVIDE FIRE WATCH AS REQUIRED FOR THE DURATION WHEN SPRINKLER SYSTEM IS DRAINED DOWN (TYPICAL OF ALL)
3. EXISTING SPRINKLER ZONE CONTROL VALVE CABINET TO REMAIN, TYPICAL
4. ALL EXISTING FIRE EXTINGUISHERS WITHIN THIS RENOVATION AREA MOUNTED ON DEMOLISHED WALL TO BE REMOVED AND TURNING BACK TO LANDLORD OTHER WELLS TO REMAIN AT SAME LOCATION (TYPICAL)

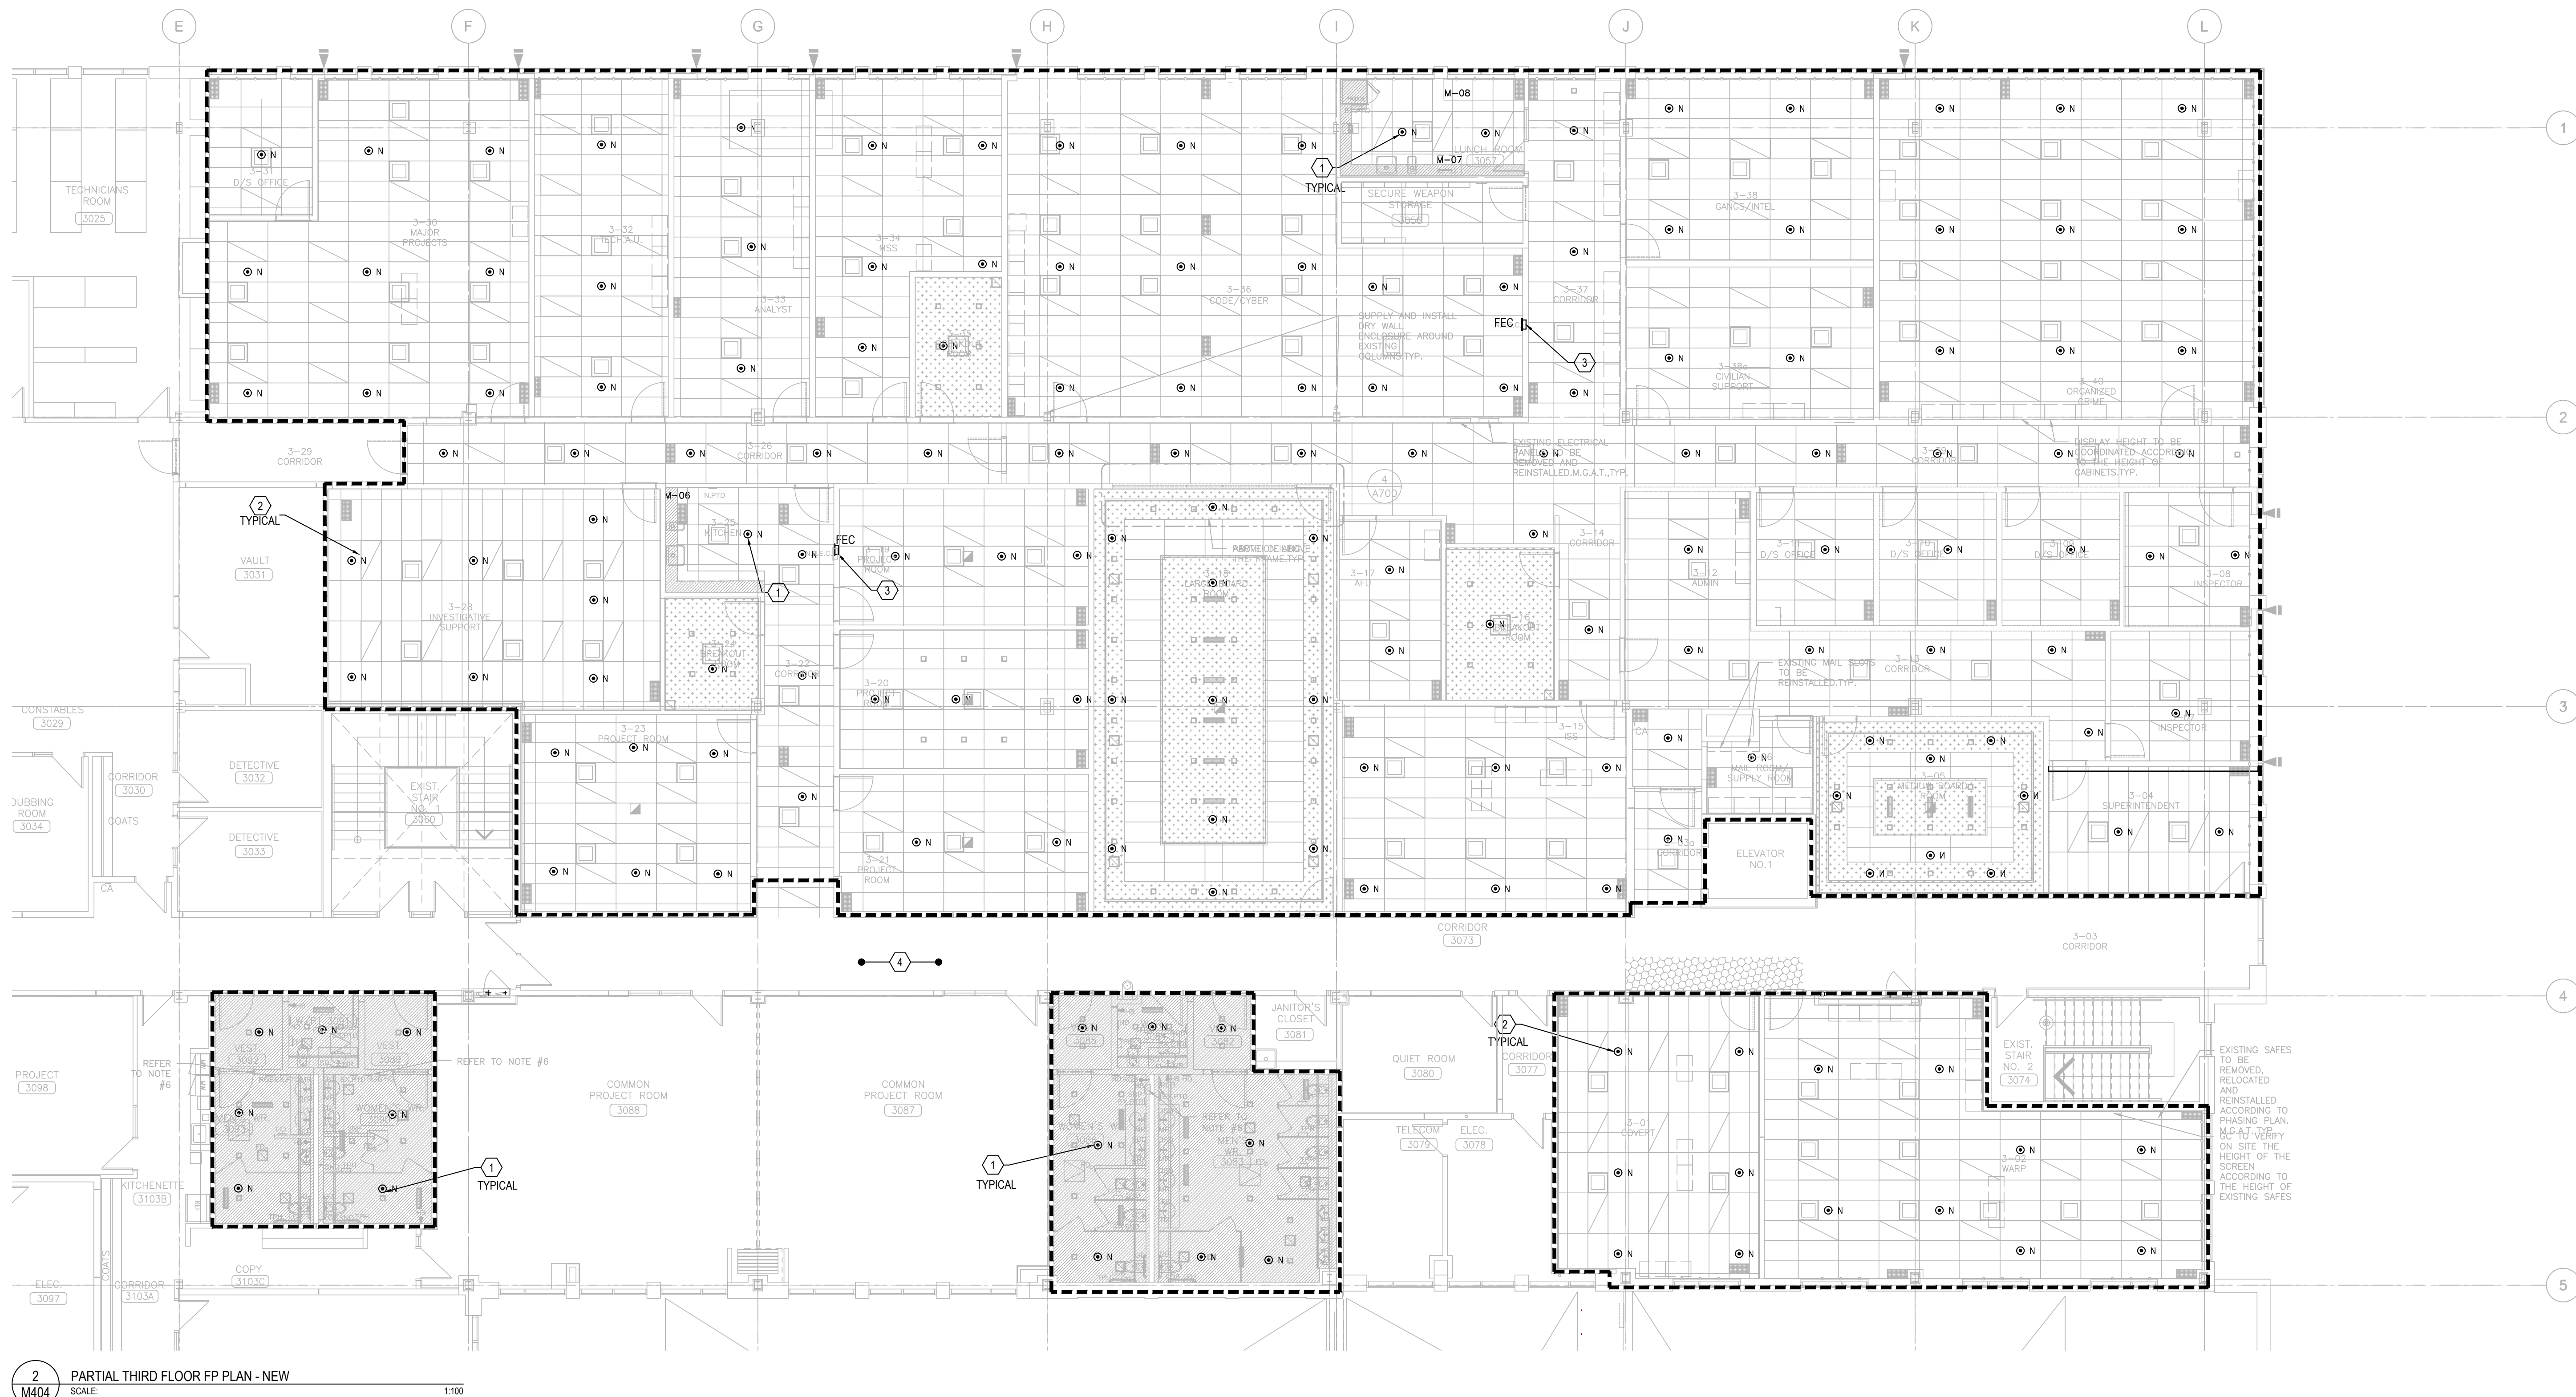

GENERAL NOTES:

1. DO NOT SCALE DRAWINGS. LOCATIONS OF ITEMS ARE APPROXIMATE AND ARE INTENDED TO BE USED FOR COORDINATION. EXACT LOCATIONS ARE DEPENDANT UPON SITE CONDITIONS. REVIEW ANY REVISIONS WITH CONSULTANT.
2. HEAD LOCATION, HEAD QUANTITY, AND LAYOUT OF SPRINKLER SYSTEMS SHOWN ON DRAWINGS ARE TO ASSIST TENDER COORDINATION ONLY. IT IS THE RESPONSIBILITY OF THE CONTRACTOR TO ENSURE ADEQUATE HEAD COVERAGE. HEAD QUANTITIES, PIPE SIZING, ZONING, AND VALVING FOR THE SYSTEM AS PER NFPA 13 HAZARD OCCUPANCIES, OWNERS INSURERS' STANDARDS, AND AUTHORITIES HAVING JURISDICTION. INSTALL ADDITIONAL HEADS, VALVES, AND RESIZE PIPING AS REQUIRED AT NO ADDITIONAL COST TO THE OWNER.
3. UPON COMPLETION, DIVISION 15 SHALL SUBMIT FIRE PROTECTION ENGINEER-STAMPED LETTER CERTIFYING THAT ALL FIRE SPRINKLER WORKS WITHIN THE EXTENT OF THIS PROJECT COMPLIES WITH NFPA 13 AND CBC.
4. SIZE REDUCTION OF SPRINKLER MAIN SHALL NOT BE ACCEPTED UNLESS APPROVED BY THE CONSULTANT. RE-ROUTING OF SPRINKLER MAIN SHALL BE APPROVED IN ADVANCE BY THE CONSULTANT.
5. EXACT PIPE ROUTES, DROPS, AND FINAL CONNECTIONS SHALL BE DETERMINED ON SITE WITH PROJECT MANAGER. REFER TO INTERIOR DESIGNER DRAWINGS AND SHOP DRAWINGS FOR ALL EQUIPMENT AND FIXTURE LOCATIONS AND CONNECTIONS.
6. PROVIDE ALL REQUIRED CUTTING AND PATCHING OF EXISTING FLOORING TO FACILITATE THE INSTALLATION OF THE MECHANICAL SERVICES OUTLINED FOR THIS SCOPE OF WORK.
7. SPRINKLER SHOP DRAWINGS INCLUDING HYDRAULIC CALCULATIONS SHALL BE SUBMITTED TO MECHANICAL CONSULTANT IN DUPLICATE FOR REVIEW. DRAWINGS AND CALCULATIONS SHALL BE CERTIFIED BY A PROFESSIONAL ENGINEER CURRENTLY PRACTICING IN THE FIRE PROTECTION INDUSTRY.
8. PROVIDE NEW PORTABLE FIRE EXTINGUISHERS FOR SPACE PER OFC REQUIREMENTS.
9. ALL FIRE PROTECTION SYSTEM SHOULD KEEP IN OPERATION DURING ALL THE CONSTRUCTION STAGES. PROVIDE BUILDING FIRE WATCH DURING SPRINKLER HEAD DEMOLISH AND INSTALLATION PERIOD.

FIRE PROTECTION NEW WORK DRAWING NOTES:

1. PROVIDE NEW CEILING CONCEALED PENDANT SPRINKLER HEADS FOR ALL GYPSUM, ARMSTRONG WOOD WORKS FLAT CEILING AREA. EXTEND OR PROVIDE NEW BRANCH PIPE TO SUIT NEW SPRINKLER HEAD LOCATION (TYPICAL)
2. PROVIDE NEW CEILING CONCEALED SPRINKLER HEADS IN T-BAR CEILING SPACE. EXTEND OR PROVIDE NEW BRANCH PIPE TO SUIT NEW SPRINKLER HEAD LOCATION (TYPICAL)
3. PROVIDE NEW 8.66 RECESSED TYPE A.B.C FIRE EXTINGUISHER TO MATCH EXISTING AT THIS APPROXIMATE LOCATION
4. ALLOW FOR THE INSTALLATION 5 ADDITIONAL SPRINKLER HEADS CW ASSOCIATED BRANCH PIPING AS MAY BE REQUIRED FOR THE INTERFERENCES IN AREA CEILING AREA

NO.	DESCRIPTION	DATE
1	ISSUED FOR TENDER	2025.05.01
2	ISSUED FOR BUILDING PERMIT	2025.04.08
3	ISSUED FOR 100% CLIENT REVIEW	2025.03.31
4	ISSUED FOR 66% CLIENT REVIEW	2025.01.09
5	ISSUED FOR COSTING REVIEW	2025.11.24

NO.	DESCRIPTION	DATE
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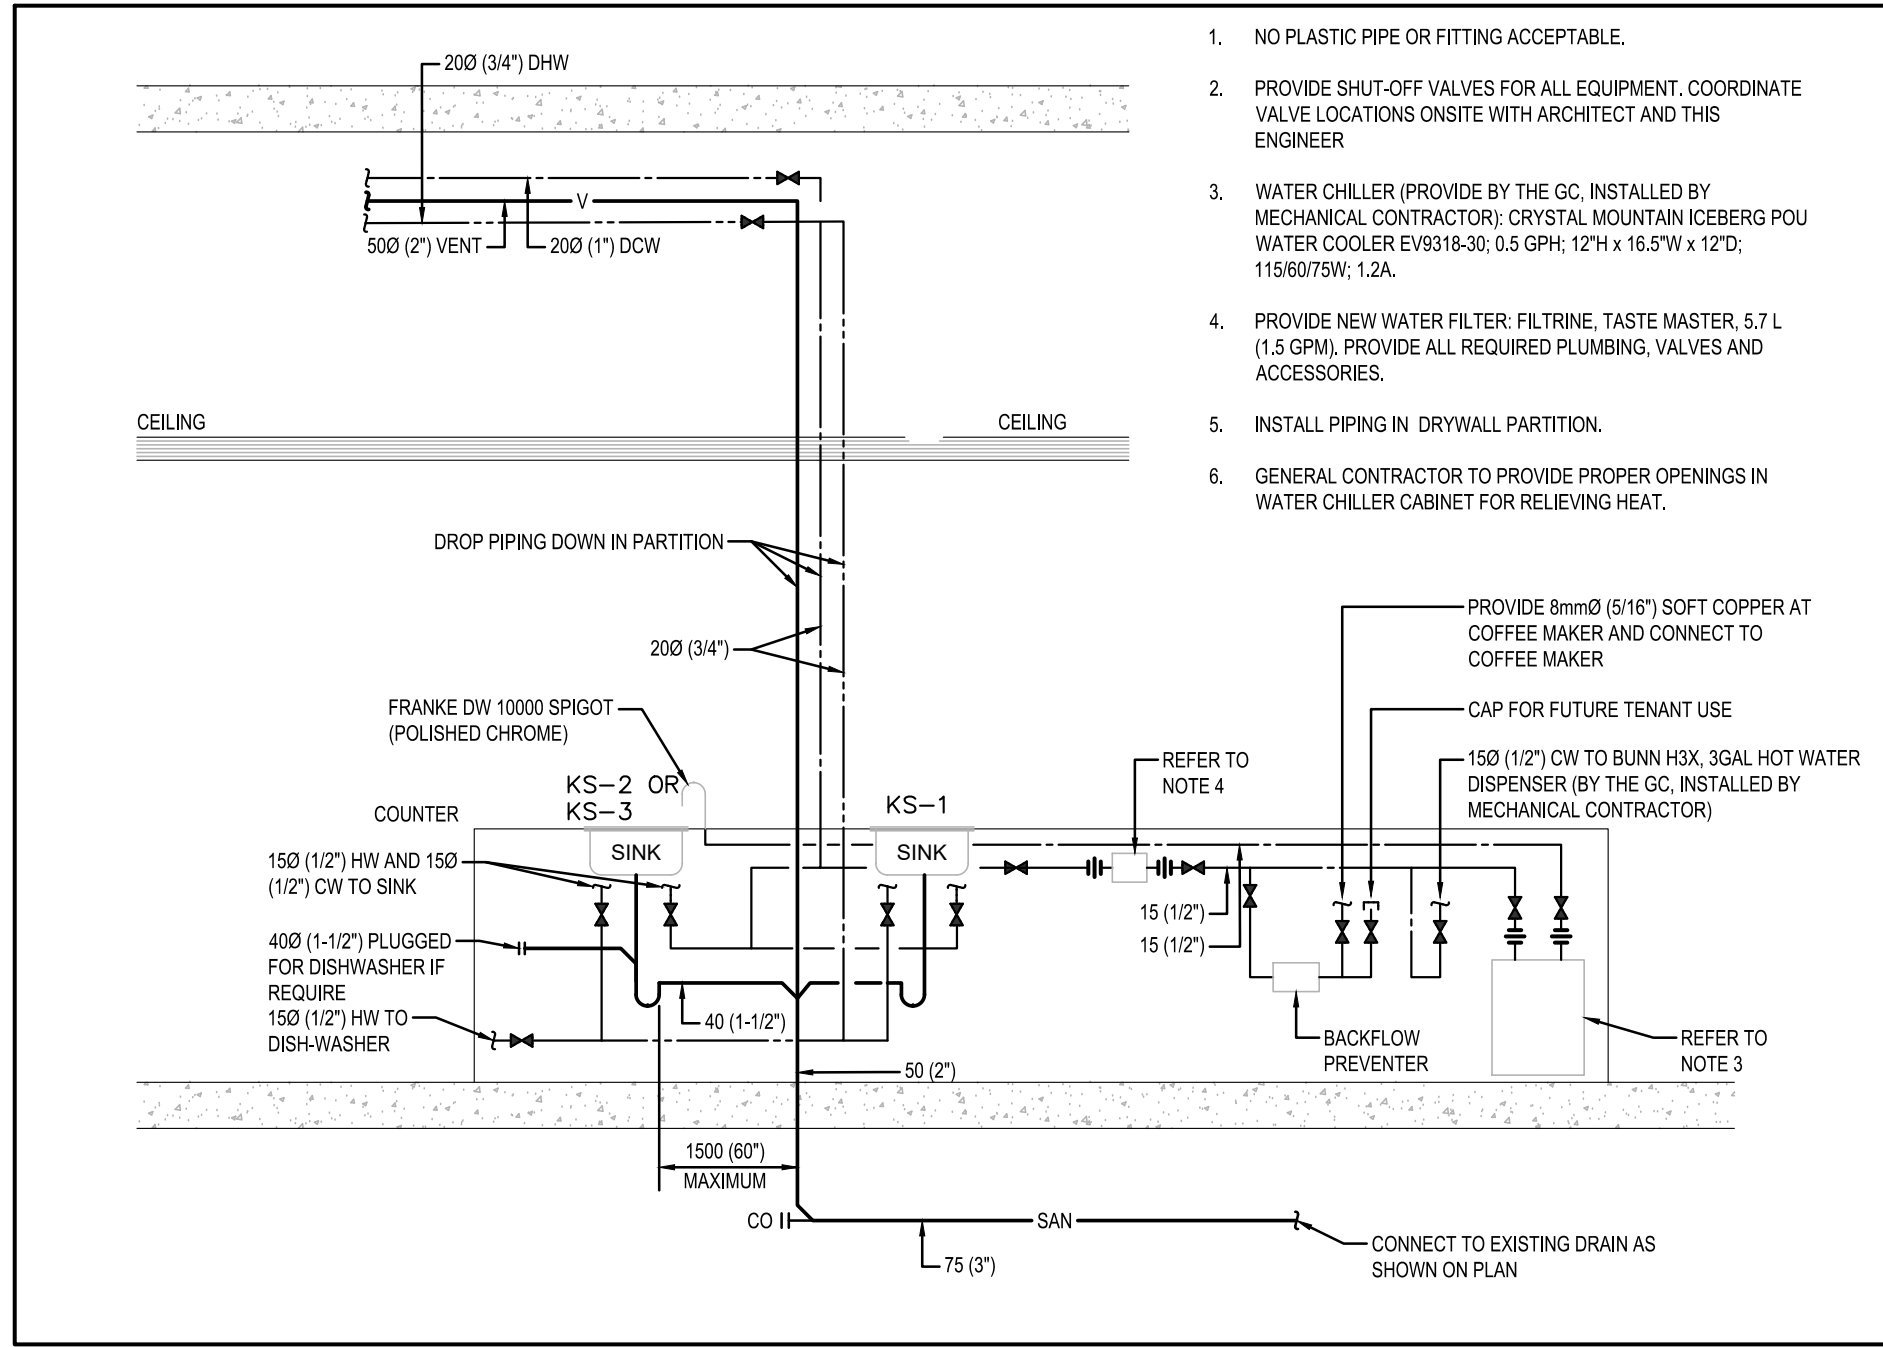
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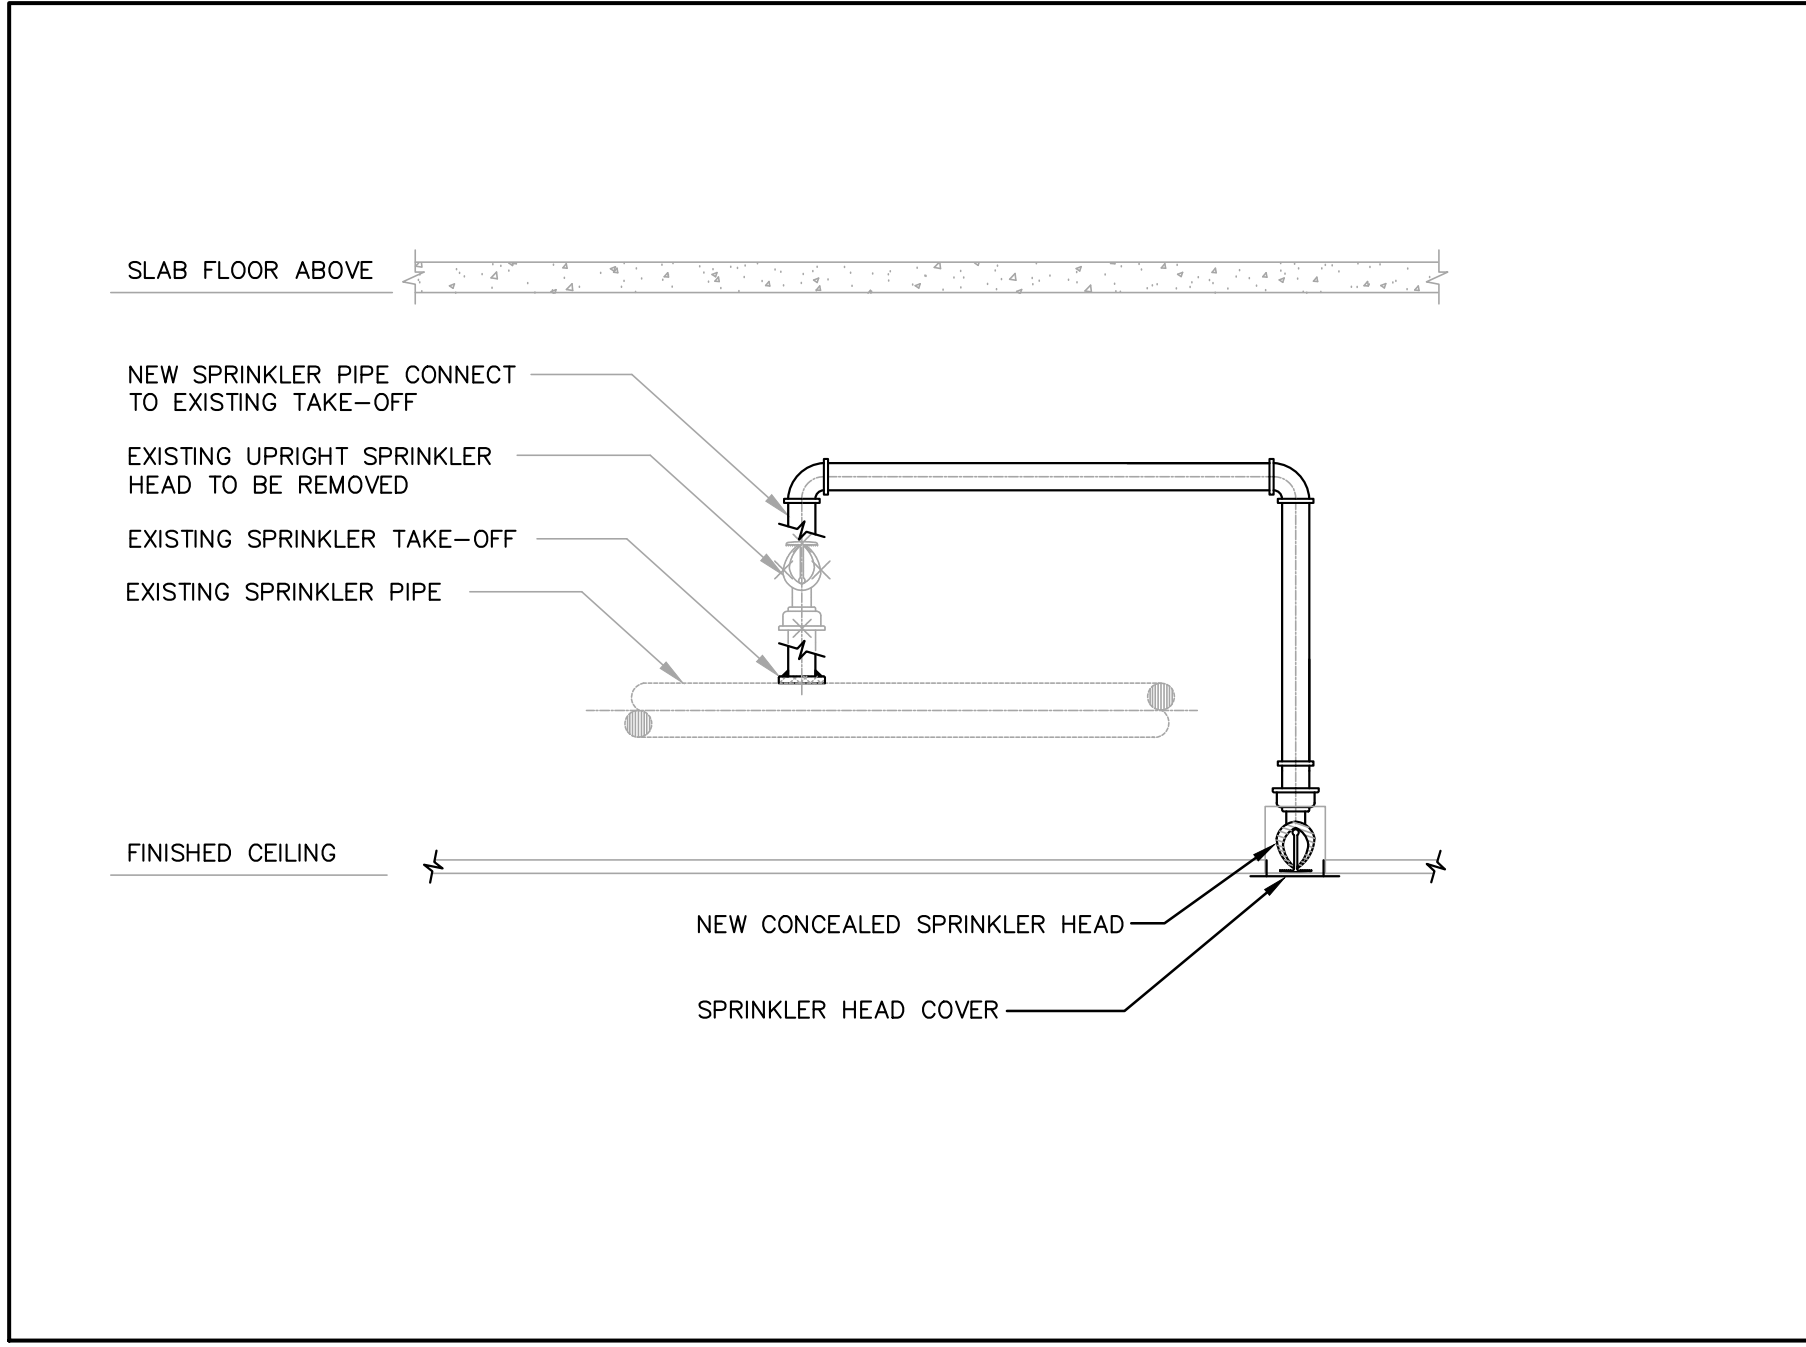
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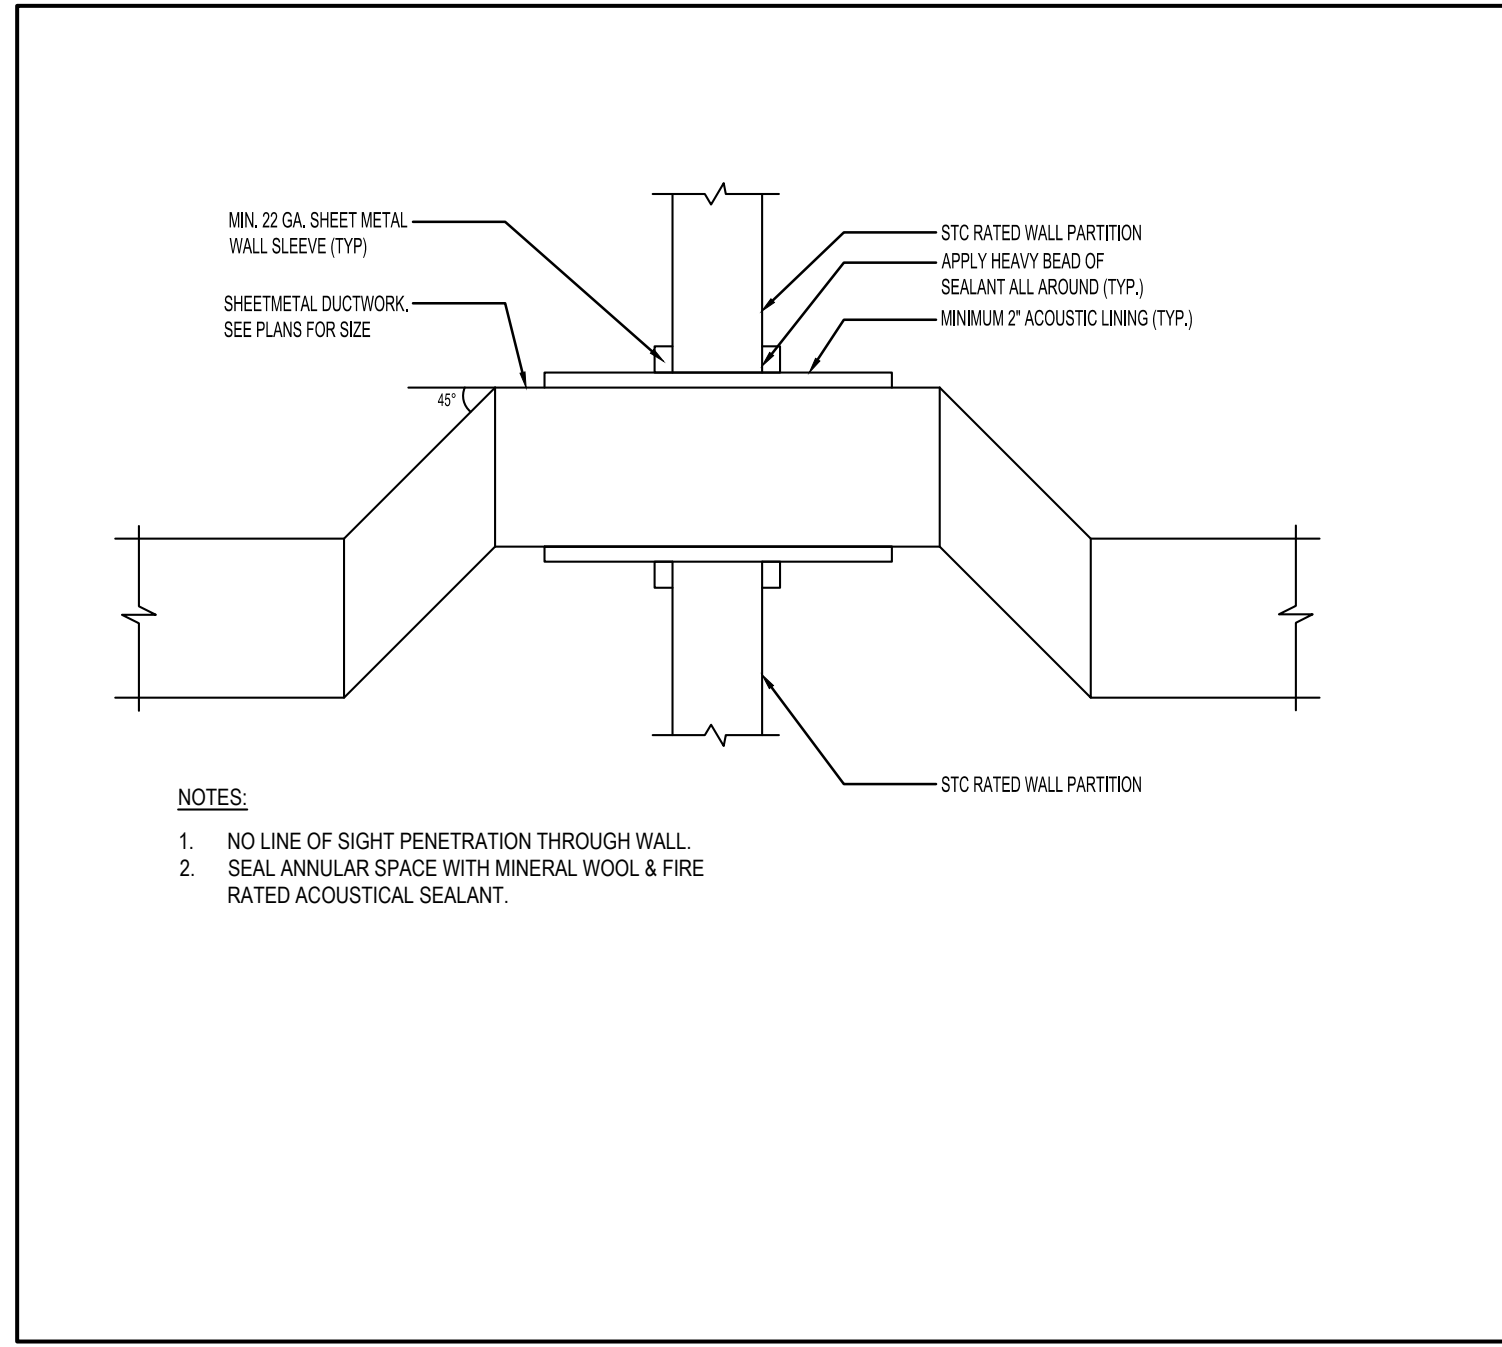
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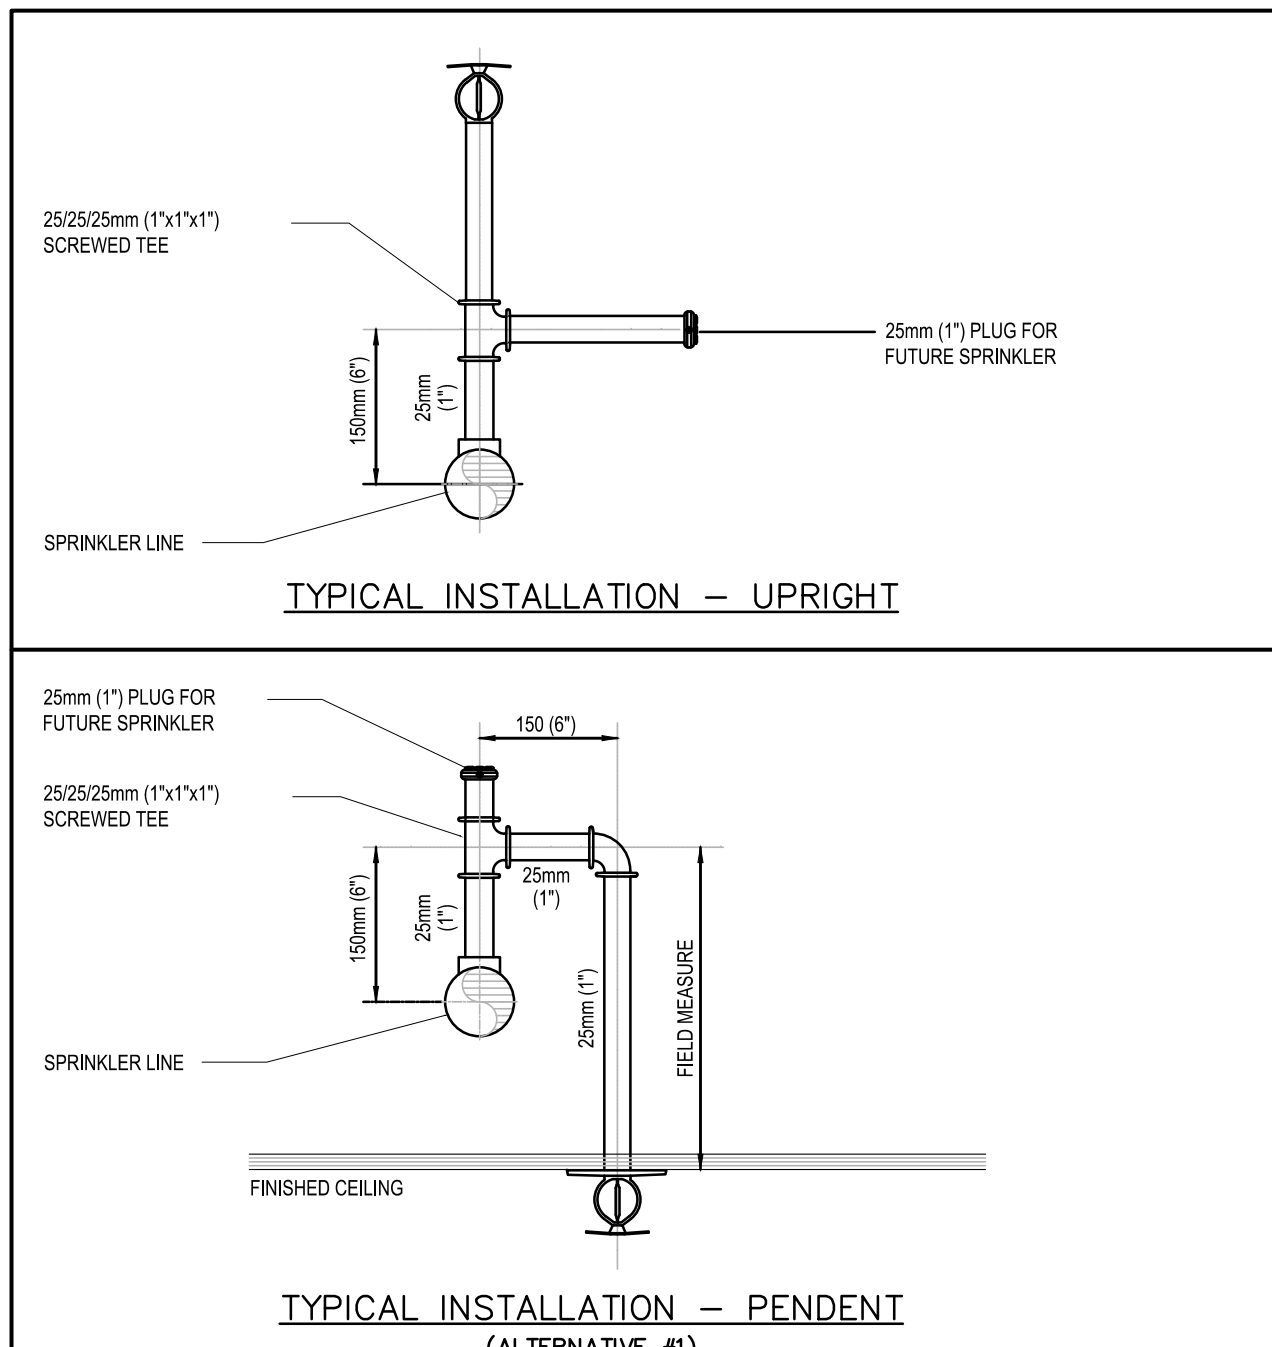
1 KITCHEN SINK 'KS-1,2,3' PIPING DIAGRAM
N.T.S.




2 NEW CONCEALED SPRINKLER HEAD DETAIL
N.T.S.




3 TYPICAL DUCT PENETRATION THRU STC-RATED WALL
N.T.S.




4 TYPICAL SPRINKLER HEAD INSTALLATION
N.T.S.

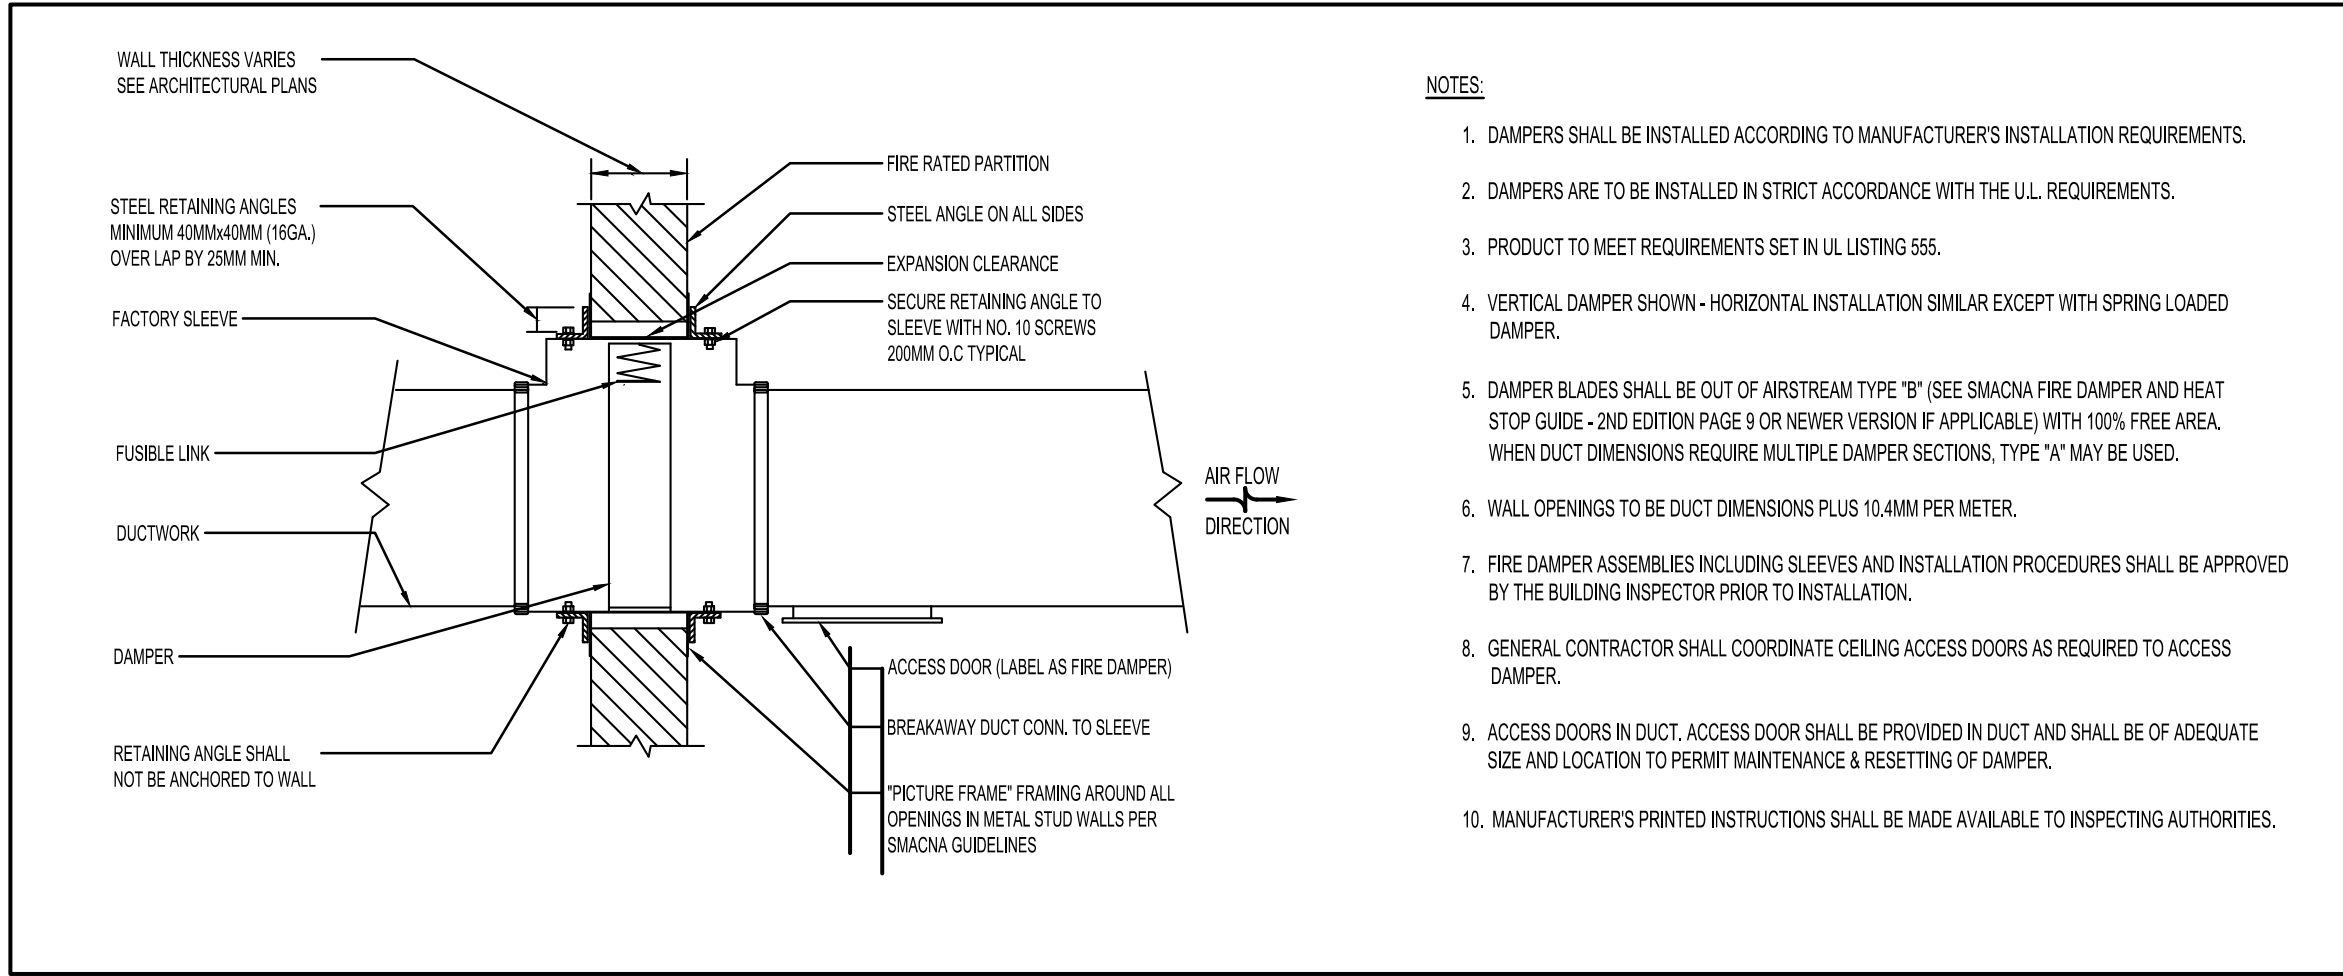


5 VERTICAL FIRE DAMPER
N.T.S.

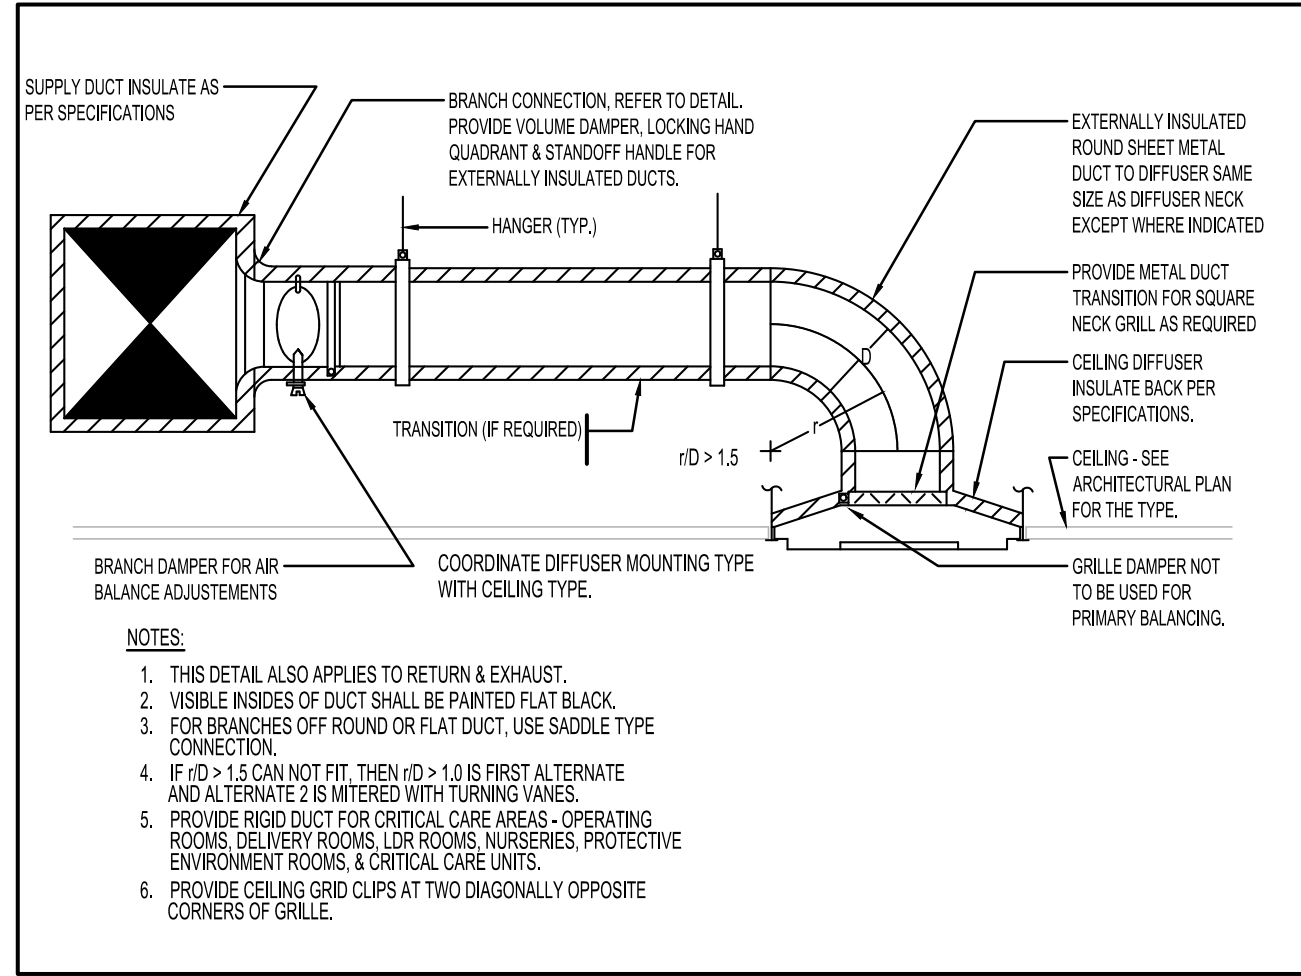


6 CEILING DIFFUSER-RIGID DUCT
N.T.S.

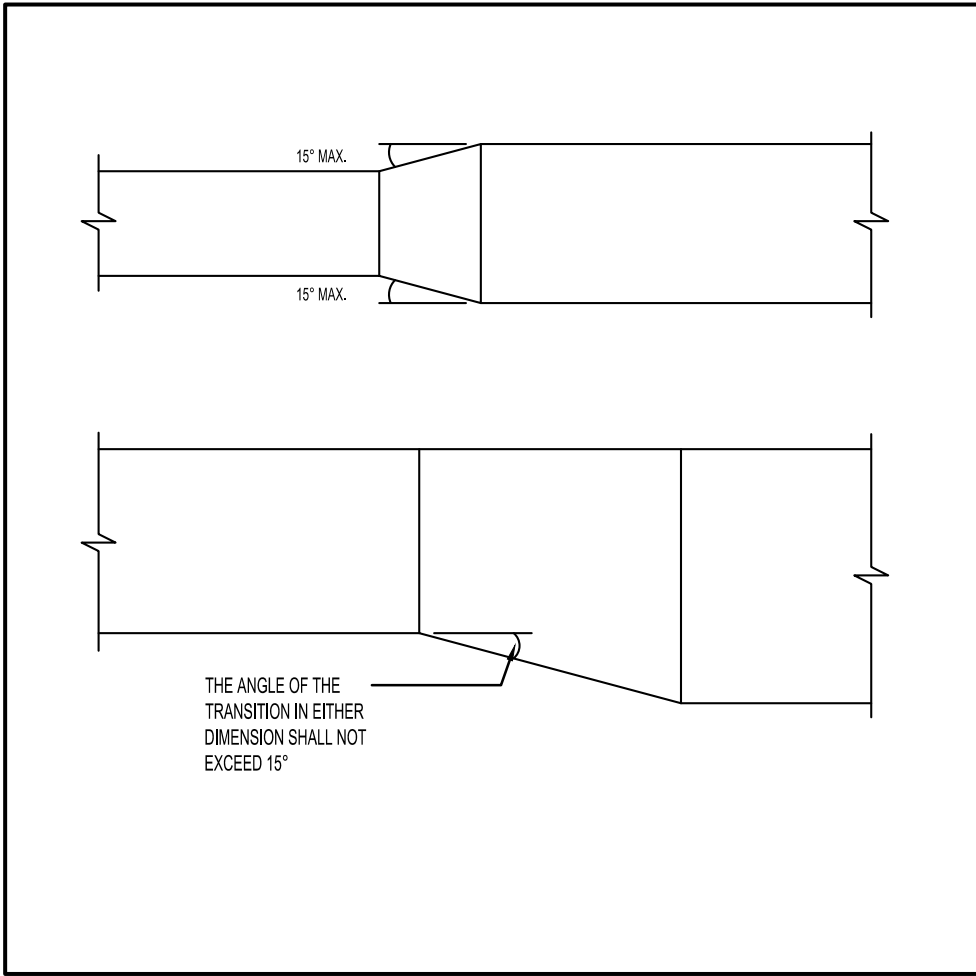


7 DUCT TRANSITION
N.T.S.

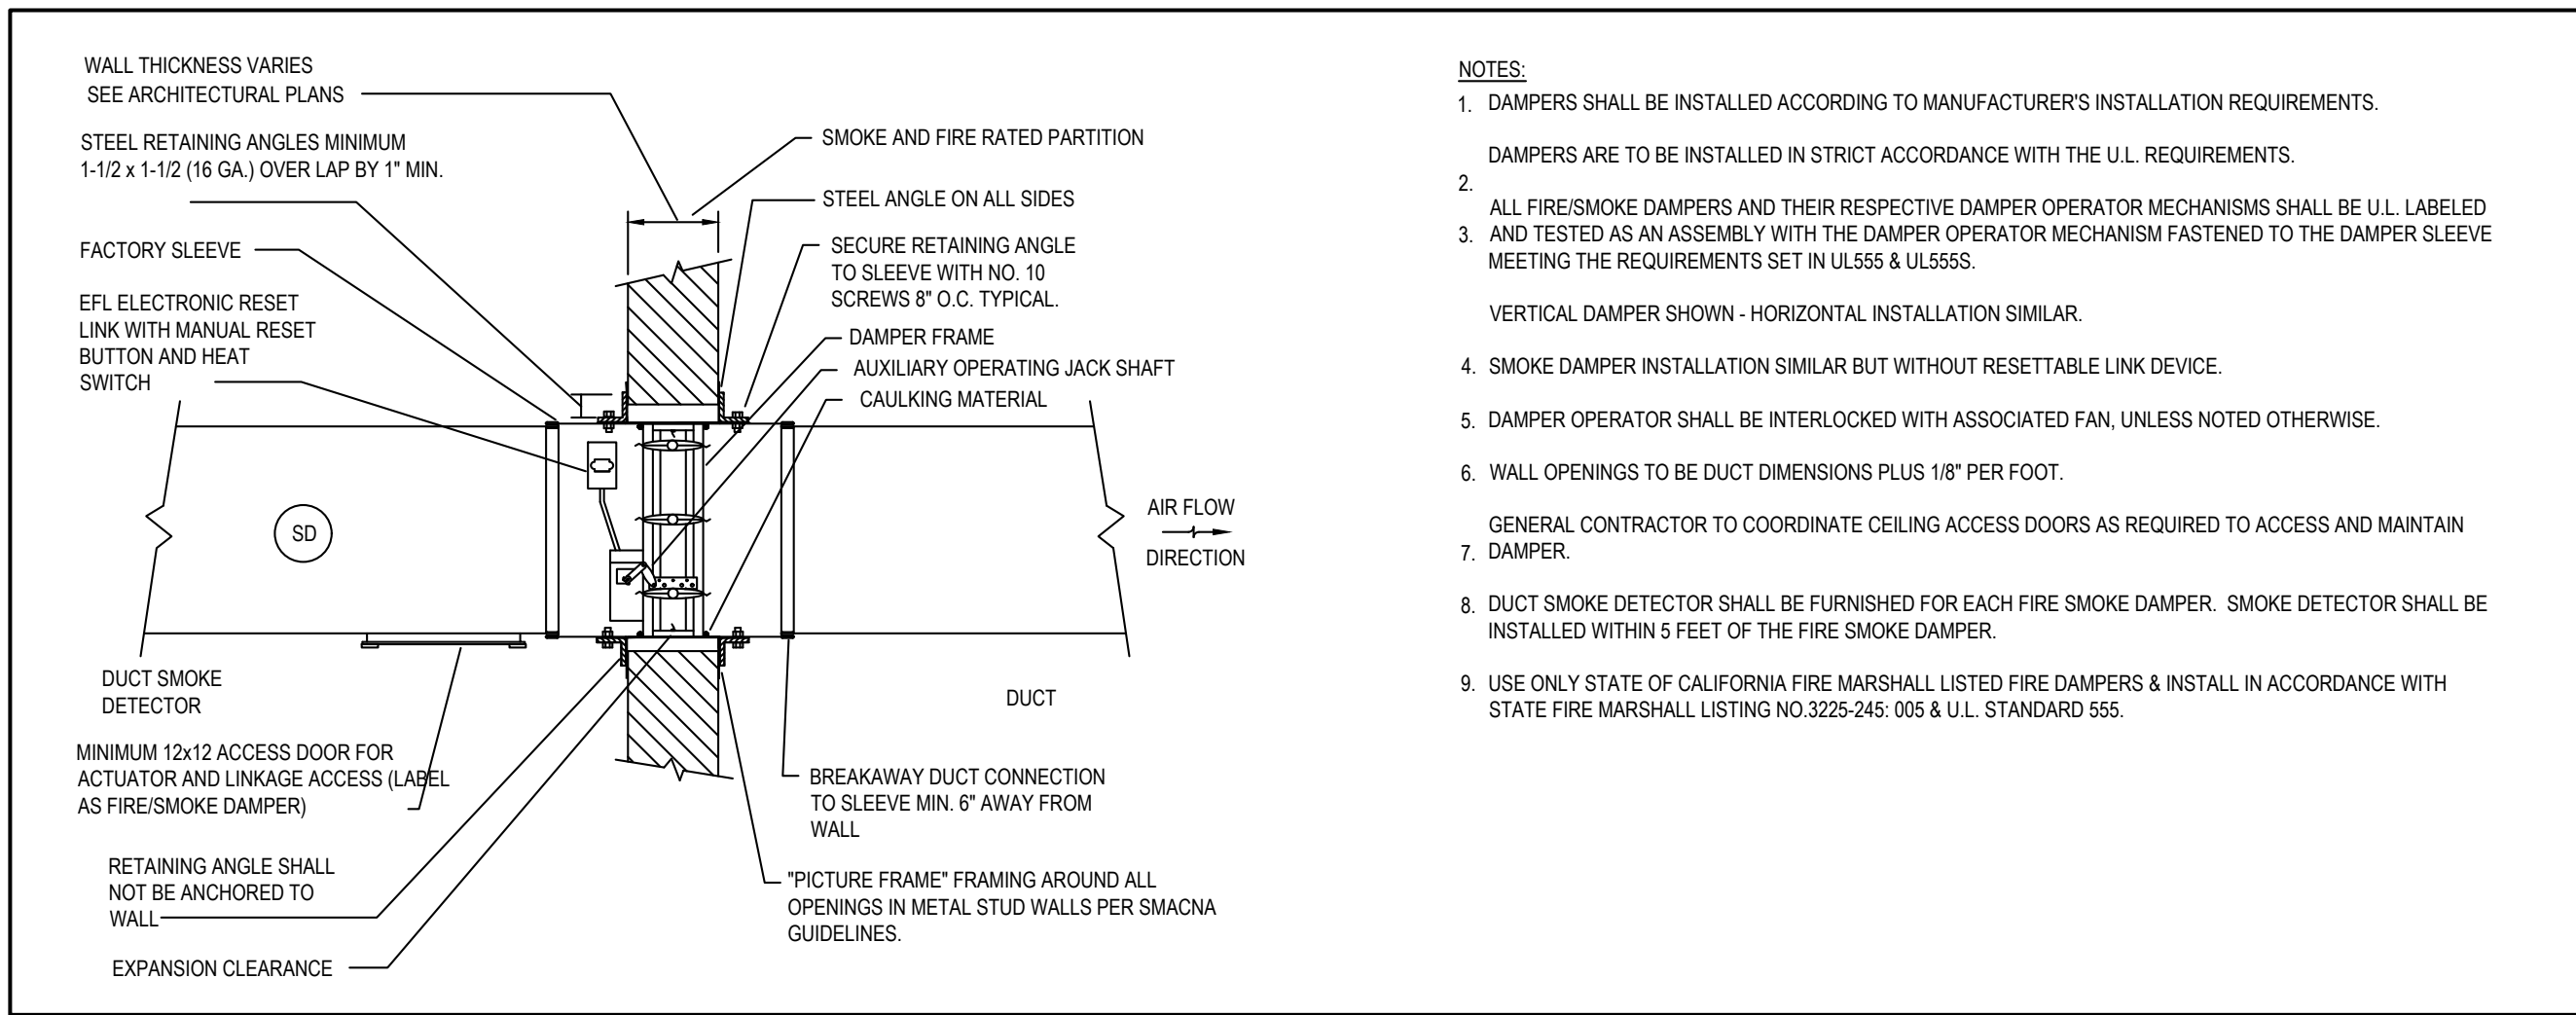

8 COMBINATION FIRE SMOKE DAMPER
N.T.S.

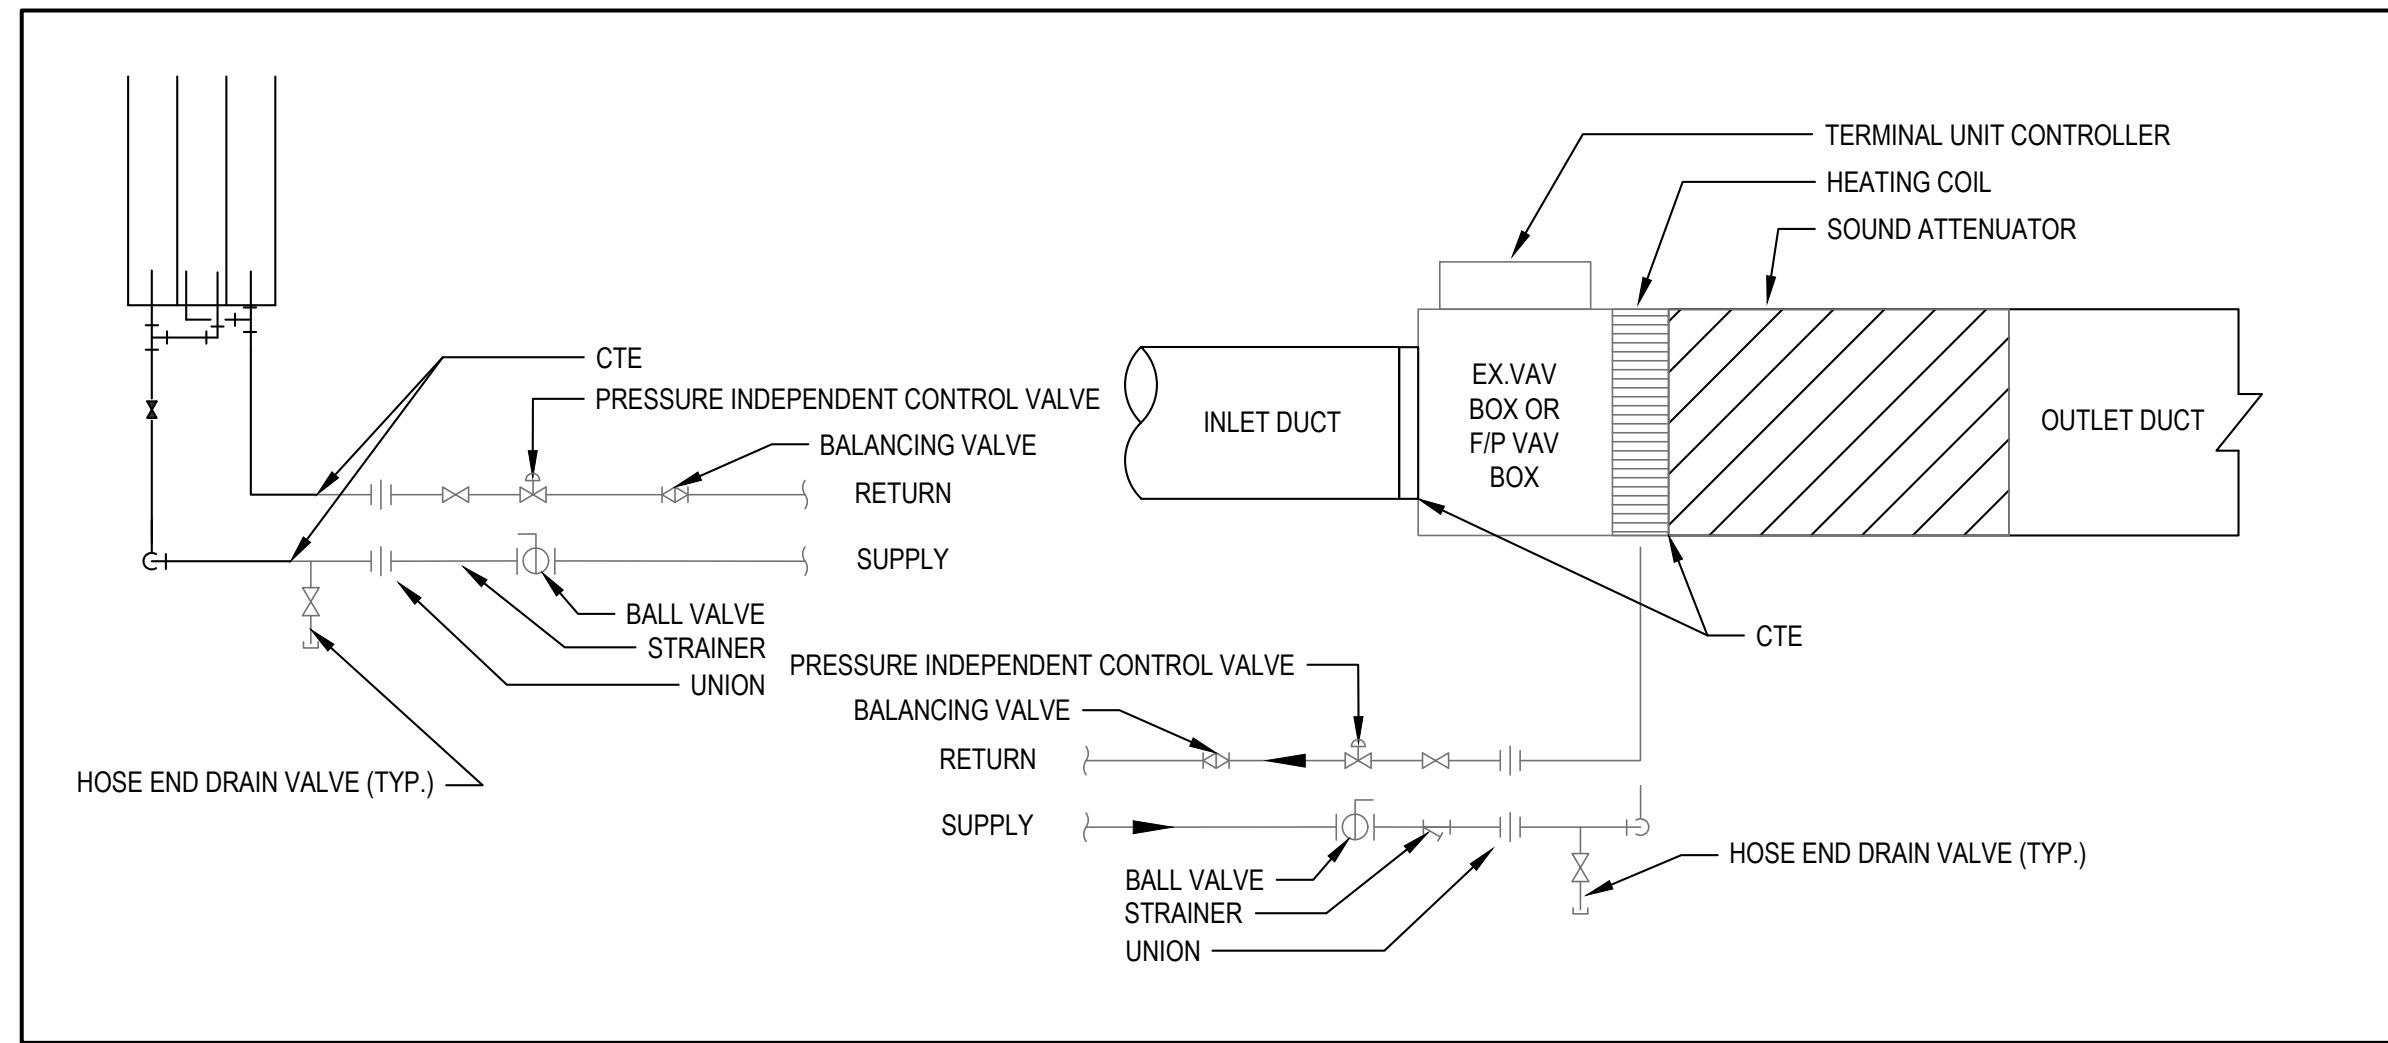

9 VAV BOX COIL AND RADIANT PANEL PIPING DETAIL
N.T.S.

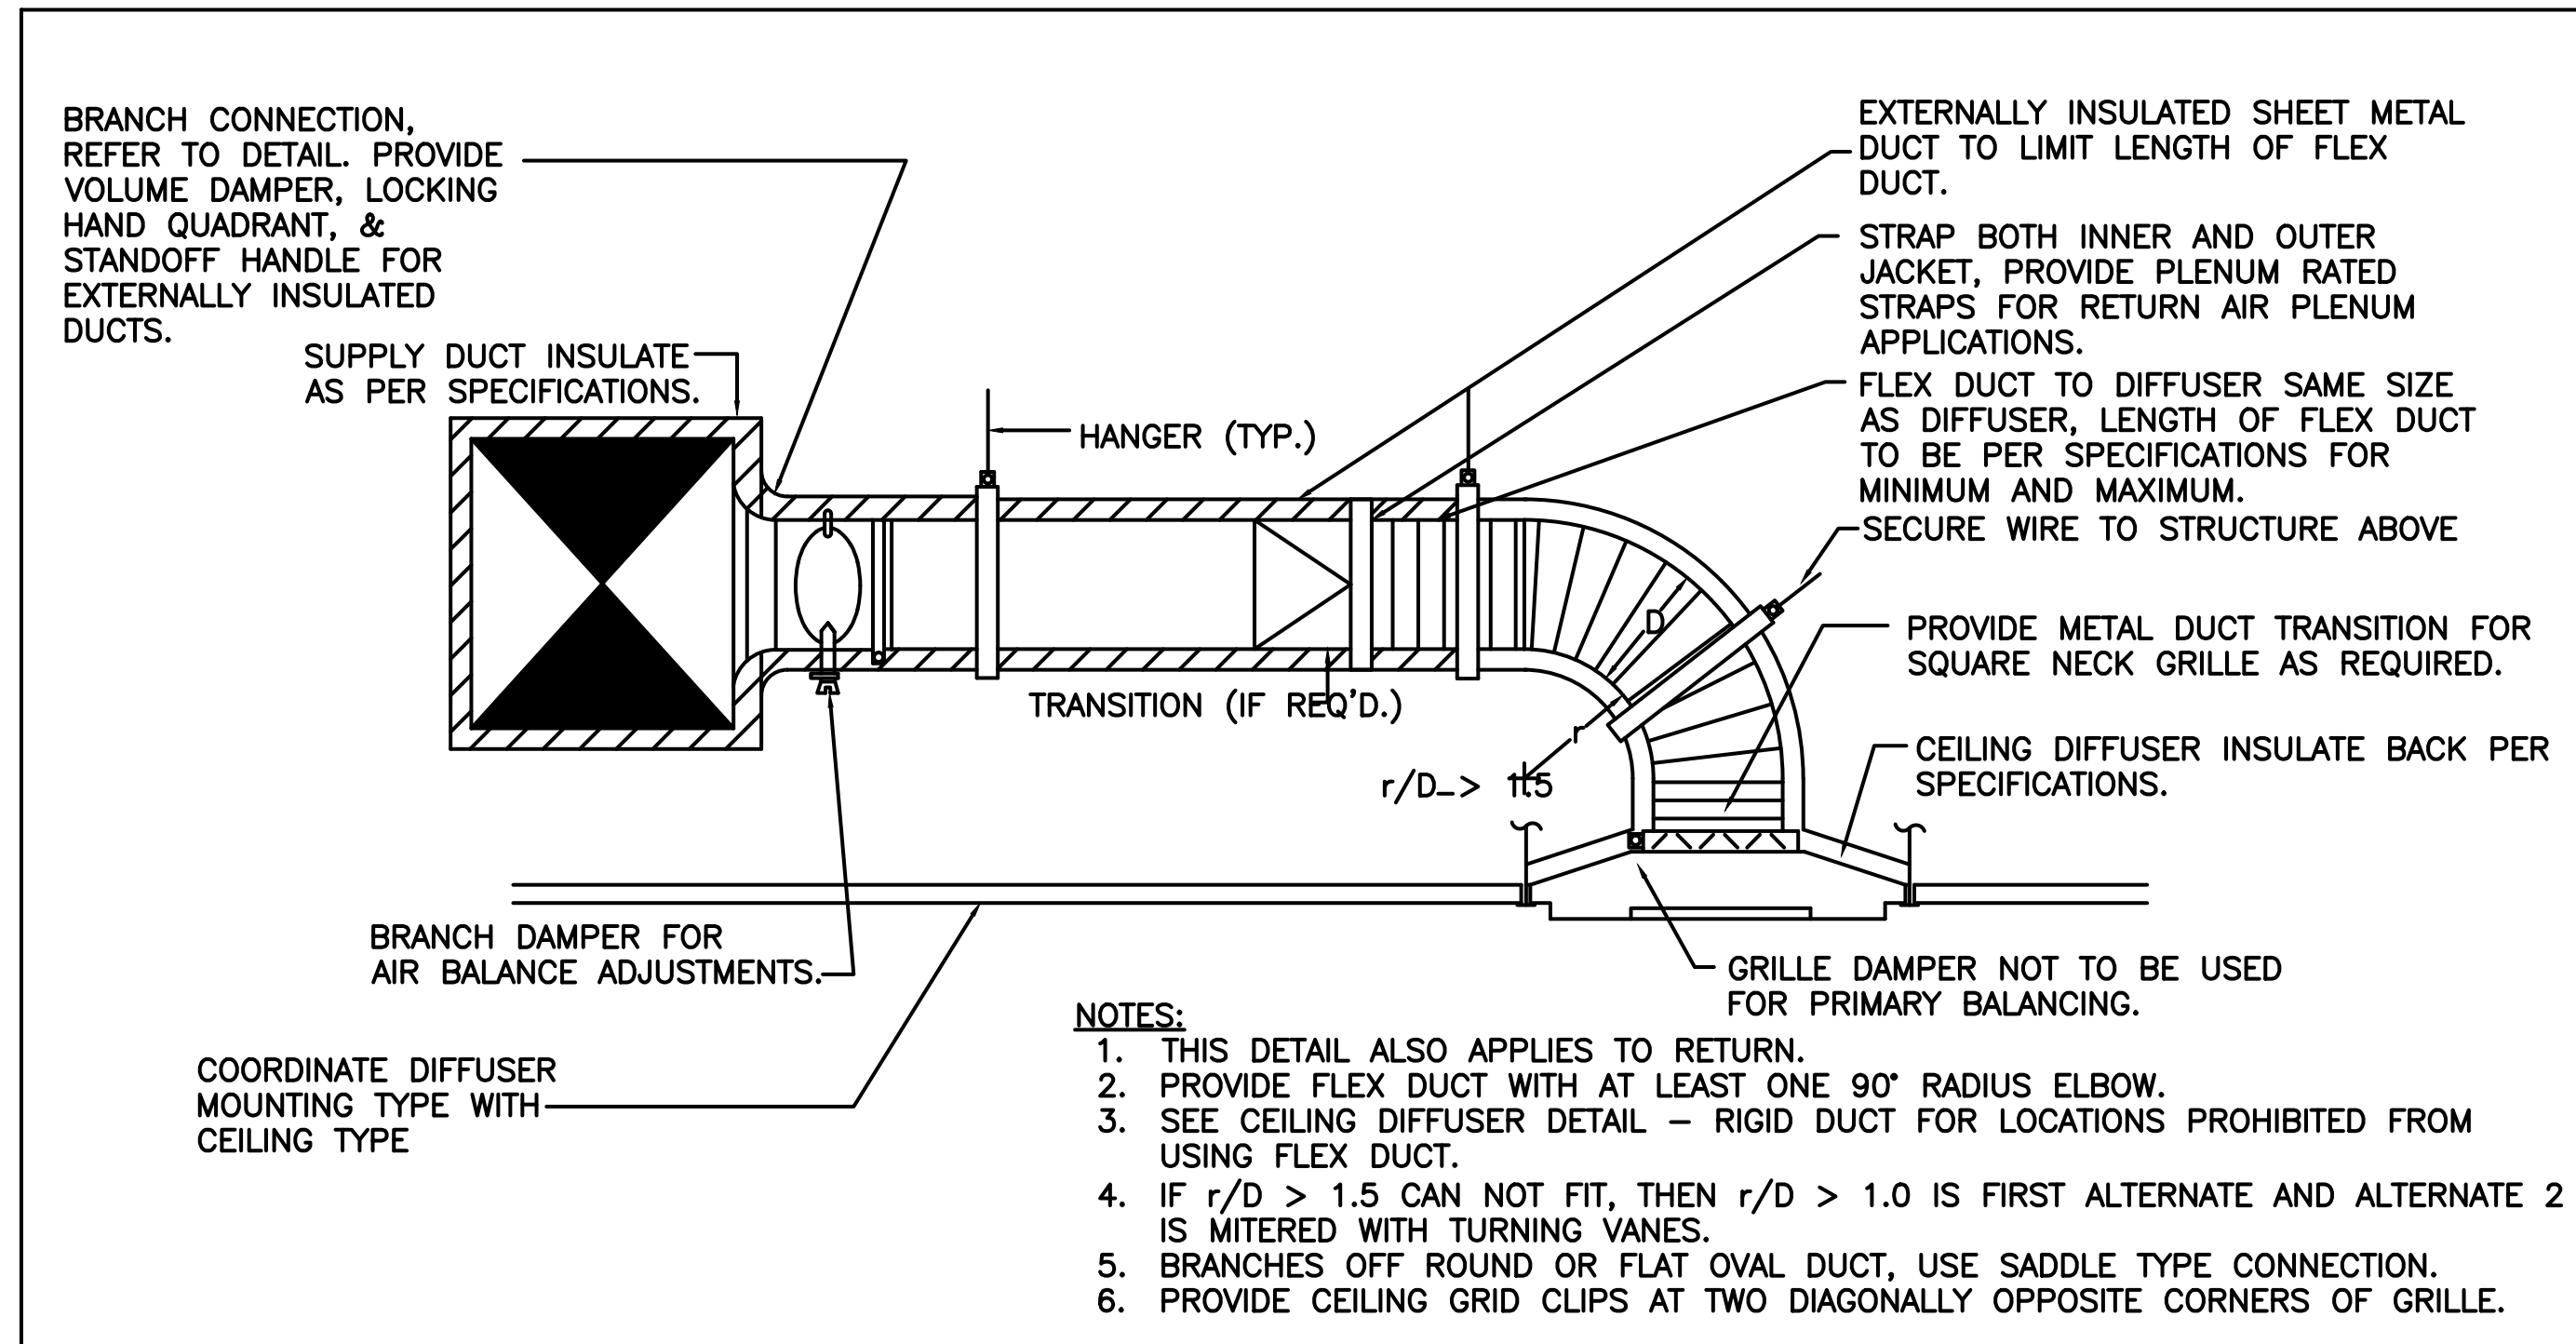

10 CEILING DIFFUSER-FLEXIBLE DUCT POLY. TYP. LINING
N.T.S.

MISCELLANEOUS PLUMBING EQUIPMENT
WATER CHILLER: SHALL BE OASIS MODEL R1P REMOTE DRINKING WATER CHILLER. POWER SUPPLY 115/160 FLA 1.3 135 WATTS. UNIT ON GLASS FILLER MODEL 04M1-001. 1/8" O.D. POWDER COATED GALVANIZED STEEL CABINET WITH PLASTIC FRONT. UNDER COUNTER MOUNT. STAINLESS STEEL WATER TUBE CONNECTIONS.
WATER FILTER PACKAGE: SHALL BE EVERPURE MODEL QL3 SINGLE HEAD COMMERCIAL GRADE FILTER HEAD EV9259-14 WITH BUILT IN SHUT OFF VALVE. FILTER CARTRIDGE SHALL BE EVERPURE MODEL APC-5.0 MICRON FILTER CARTRIDGE EV9262-31. CAPABLE OF DELIVERING 2.5 GPM OF FLOW FOR 15,000 GALLONS OF SERVICE. 1/4" NOMINAL INLET AND OUTLET CONNECTIONS.
FOR QUARRY OR MOSAIC TILED AREAS PROVIDE 125MM X 125MM (5" X 5") SQUARE NICKEL BRONZE STRAINER. WATTS L5-1.5" X 5" (127 MM X 127 MM) NICKEL BRONZE. HEAVY DUTY. SQUARE STRAINER.

PIPE IDENTIFICATION
1. STENCILING: 1.1. STENCILING TO BE PERFORMED IN A NEAT, QUALITY MANNER. 1.2. USE CAPITAL LETTERS MINIMUM 5MM (7/32") HIGH FOR DN80 (3") DIAMETER PIPING OR LARGER. INCLUDING INSULATION, AND 19MM (3/4") SIZE CAPITAL LETTERS ON SMALLER DIAMETERS. 1.3. USE FLOW ARROWS TO INDICATE DIRECTION OF FLOW. USE DOUBLE ARROW WHERE FLOW IS REVERSIBLE. ARROW SHALL BE SOLID BLACK OR WHITE. MINIMUM 152MM (6") LONG BY 51MM (2") WIDE FOR DN80 (3") DIAMETER PIPING OR LARGER. INCLUDING INSULATION, AND 102MM (4") LONG BY 19MM (3/4") WIDE ON SMALLER DIAMETERS. 1.4. USE WORDING SHOWN ON THE LEGEND ON THE DRAWINGS OR AS INSTRUCTED BY THE CONSULTANT. SPECIAL SYSTEM DESIGNATIONS AND ABBREVIATIONS SHALL BE SUBMITTED TO CONSULTANT FOR APPROVAL PRIOR TO USE. 1.5. COLOUR CODING TO BE AS PER THE FOLLOWING SCHEDULE. FOR ALL OTHER SERVICES. PROVIDE COLOUR CODING IN CONFORMANCE WITH CAN/CSB-34.3, ANSI AND MANUFACTURER'S RECOMMENDATIONS.
2. LOCATION: 2.1. LOCATE IDENTIFICATION AND FLOW ARROWS AS FOLLOWS: - BEHIND EACH ACCESS DOOR. - AT EACH CHANGE OF DIRECTION AND TAKE-OFF. - NOT MORE THAN 12.2M (40 FT) APART ON ALL PIPES EXPOSED AND/OR LOCATED BEHIND ACCESSIBLE CEILING. - ON BOTH SIDES OF SLEEVES. - ADJACENT TO VALVES. - ABOVE EACH FLOOR OR PLATFORM FOR VERTICAL EXPOSED PIPES APPROXIMATELY 1.52MM (5 FT.) ABOVE FLOOR.
3. MARKER LEGEND: DESCRIPTION AND SERVICE DOMESTIC COLD WATER DOMESTIC HOT WATER PLUMBING VENT FIRE LINE CLASSIFICATION COLOR GREEN GREEN GREEN RED

PIPE CONNECTION				
SYMBOL	ITEM	DCW	DHW	DRAIN
WC	WATER CLOSET (FLUSH PAN)	150	-	750
WC	WATER CLOSET (FLUSH VALVE)	200	-	750
SH	SHOWER	150	150	400
LAV	LAVATORY	150	150	300
KS	KITCHEN SINK	150	150	400
DW	DISHWASHER (ROUGH-IN ONLY)	-	150	400
FD	FLOOR DRAIN	PRIMED	-	500/750

NOTES: - ALL SANITARY VENTING TO BE INSTALLED IN ACCORDANCE WITH LATEST EDITION OF THE OBC. - ALL FLOOR DRAINS & HUB DRAINS SHALL BE TRAPPED, VENTED AND PRIMED BELOW FLOOR.

6. ISSUED FOR TENDER2025.05.01

4. ISSUED FOR BUILDING PERMIT2025.04.08

3.1. ISSUED FOR 100% CLIENT REVIEW2025.03.31

2. ISSUED FOR 60% CLIENT REVIEW2025.01.09

1. ISSUED FOR COSTING REVIEW2025.11.24

NO. DESCRIPTIONDATE

REVISIONS

PROJECT

PEEL REGIONAL POLICE

REGION OF PEEL

EMIL V. KOLB CENTRE
PEEL REGIONAL POLICE FACILITY
INTERIOR RENOVATION PROJECT
180 RORY ROAD EAST, MISSISSAUGA, ON L5T 2Y5

NCA
ARCHITECTS

The consultant shall check and verify all dimensions and spatial requirements and ensure that the building design meets the requirements of the building code and the client's needs. The consultant shall also ensure that the building design meets the requirements of the building code and the client's needs. The consultant shall also ensure that the building design meets the requirements of the building code and the client's needs.

STRUCTURAL CONSULTANT
STEPHENSON ENGINEERING

MECHANICAL CONSULTANT
EXP SERVICES INC.

ELECTRICAL CONSULTANT
EXP SERVICES INC.

SHEET TITLE

MECHANICAL DETAILS

SHEET NO.

M501

DRAWN BY

MSL

CHECKED

ME

PROJECT NO.

MRK-25008951-A0


SCALE

EXISTING EXHAUST FAN SCHEDULE (FOR REFERENCE)					
SYSTEM REFERENCE TAG	DESCRIPTION	LOCATION	AIR FLOW (LS)	FAN E.S.P. (Pa)	REMARKS
EF-1	MAIN WASH ROOM	ROOF	3,230	250	
EF-7	WASH ROOMS	ROOF	1,350	175	
NOTES:					

5.	ISSUED FOR TENDER	2026.05.01
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
NEWS

PROJECT



REGION OF PEEL

EMIL V. KOLB CENTRE
PEEL REGIONAL POLICE FACILITY
INTERIOR RENOVATION PROJECT
180 DERRY ROAD EAST, MISSISSAUGA, ON L5T 2Y5



NORTH
Architects

The architect shall attend and oversee all drawings and report progress of drawings to the client. The architect shall provide professional services and shall be responsible for the design and construction of the project. The architect shall be responsible for the design and construction of the project. The architect shall be responsible for the design and construction of the project.

READY FOR CONSTRUCTION

07/24

STRUCTURAL CONSULTANT
Stephenson Engineering
MECHANICAL CONSULTANT
EXP Services Inc.
ELECTRICAL CONSULTANT
EXP Services Inc.

SHEET TITLE

MECHANICAL SCHEDULES

SHEET NO.	DRAWN BY	CHECKED BY
M602	SKILL	HE
PROJECT NO.	MRK-25008951-A0	
SCALE		

POWER SINGLE LINE DIAGRAM SYMBOLS	
	CKT BREAKER, "###" INDICATES TRIP SETTING, "N" INDICATES NUMBER OF POLES
	DRAIN-OUT CKT BREAKER, "###" INDICATES TRIP SETTING, "N" INDICATES NUMBER OF POLES
	FUSED SWITCH, "###" INDICATES TRIP SETTING, "N" INDICATES NUMBER OF POLES
	ENCLOSED CIRCUIT BREAKER
	ENCLOSED NON-FUSED SWITCH
	ENCLOSED FUSED SWITCH
	INTERLOCK
	AUTOMATIC TRANSFER
	SOLID STATE, ELECTRONIC ADJUSTABLE TRIP
	GROUND FAULT PROTECTION
	SURGE PROTECTIVE DEVICE
	DIGITAL MULTIMETER
	UTILITY METER
	AUTOMATIC/MANUAL TRANSFER SWITCH
	AUTOMATIC TRANSFER SWITCH, WITH BYPASS ISOLATION
	TRANSFORMER
	GENERATOR
	PANELBOARD
	PAD MOUNTED TRANSFORMER
	GROUND
	POTENTIAL TRANSFORMER
	CURRENT TRANSFORMER

POWER DISTRIBUTION AND SMALL POWER			
	DUPLEX RECEPTACLE, WALL MOUNTED		DOUBLE DUPLEX RECEPTACLE, WALL MOUNTED
	DUPLEX RECEPTACLE, ABOVE BACKSLASH OF CABINET, COUNTERTOP OR SINK		DOUBLE DUPLEX RECEPTACLE, ABOVE BACKSLASH OF CABINET, COUNTERTOP OR SINK
	DUPLEX RECEPTACLE, FLUSH MTD IN CEILING		DOUBLE DUPLEX RECEPTACLE, FLUSH MOUNTED IN CEILING
	HALF SWITCHED DUPLEX RECEPTACLE, WALL MOUNTED		SIMPLEX RECEPTACLE, WALL MOUNTED
	SPECIAL PURPOSE RECEPTACLE, WALL MOUNTED, NEMA CONFIGURATION AS NOTED ON PLANS		SPECIAL PURPOSE RECEPTACLE, CEILING MOUNTED NEMA CONFIGURATION AS NOTED ON PLANS
	SHADING REPRESENTS RECEPTACLE ON LIFE SAFETY BRANCH		SHADING REPRESENTS RECEPTACLE ON UPS BRANCH
	SHADING REPRESENTS RECEPTACLE ON NON-LIFE SAFETY BRANCH		SHADING REPRESENTS RECEPTACLE WITH ISOLATED GROUND
	DISCONNECT SWITCH, REFER TO EQUIPMENT CONNECTION SCHEDULE FOR DISCONNECT TYPE, LION		
	COMBINATION MOTOR STARTER DISCONNECT		
	MOTOR STARTER		
	VARIABLE FREQUENCY DRIVE		
	DIRECT CONNECTION, WALL MOUNTED, SUBSCRIPT 'X' INDICATES UNIQUE IDENTIFIER, REFER TO EQUIPMENT CONNECTION SCHEDULE.		
	DIRECT CONNECTION, CEILING MOUNTED, SUBSCRIPT 'X' INDICATES UNIQUE IDENTIFIER, REFER TO EQUIPMENT CONNECTION SCHEDULE.		
	MOTOR, SUBSCRIPT 'X' DENOTES MOTOR DESIGNATION, REFER TO EQUIPMENT CONNECTION SCHEDULE.		
	GROUND BUS BAR		
	FURNITURE FEED - POWER AND DATA (F - FLOOR, P - PAC POLE, W - WALL, WM - WIREMOLD, CL-CEILING)		
	PANELBOARD		
	TRANSFORMER		
	FLOOR BOX, DUPLEX RECEPTACLE		SPECIAL FLOORBOX, "N" INDICATES UNIQUE FLOOR BOX TYPE
	FLOOR BOX, DOUBLE DUPLEX RECEPT		
<div> <div> <div>RECEPTACLE TYPE</div> <div>NUMBER INDICATES BRANCH CIRCUIT NUMBER</div> </div> </div>			

FLOOR BOX SCHEDULE			
SYMBOL ON PLAN	FLOOR BOX TYPE AND SIZE	ELECTRICAL	DATA
	8" POKE THRU	THREE (3) DUPLEX	TWO (2) DROPS
	6" POKE THRU	TWO (2) DUPLEX	TWO (2) DROPS
	6" POKE THRU	TWO (2) DUPLEX	FOUR (4) DROPS
	8" POKE THRU	ONE (1) DUPLEX	FIVE (5) DROPS

CIRCUITING	
	BLDG-E1MDPH-A-10
	3#12 #12G 21mmC
	CIRCUIT NUMBER
	PANEL DESIGNATION
	CONDUIT SIZE
	GROUND CONDUCTOR QUANTITY AND SIZE
	CIRCUIT CONDUCTOR QUANTITY AND SIZE

LIGHTING, LIGHTNG SWITCHING & CONTROLS			
	AF10 7ab	UPPER CASE LETTERS INDICATE LIGHTING FIXTURE TYPE	NUMBER INDICATES CIRCUIT NUMBER, LOWER CASE LETTER INDICATES SWITCH/LEG
	LIGHTING FIXTURE ON NORMAL BRANCH POWER - CEILING MOUNTED		LIGHTING FIXTURE ON NIGHT LIGHT CIRCUIT - CEILING MOUNTED
	LIGHTING FIXTURE ON NORMAL BRANCH POWER - WALL MOUNTED		LIGHTING FIXTURE ON NIGHT LIGHT CIRCUIT -WALL MOUNTED
	STRIP LIGHTING FIXTURE ON NORMAL BRANCH POWER		STRIP LIGHTING FIXTURE ON NIGHT LIGHT CIRCUIT
	PENDANT LINEAR FIXTURE ON NORMAL BRANCH POWER		PENDANT LINEAR FIXTURE ON NIGHT LIGHT CIRCUIT
	DOWNLIGHT LIGHTING FIXTURE ON NORMAL BRANCH POWER - RECESSED MOUNTED		DOWNLIGHT LIGHTING FIXTURE ON ENIGHT LIGHT CIRCUIT - RECESSED MOUNTED
	PENDANT LIGHTING FIXTURE ON NORMAL BRANCH POWER		PENDANT LIGHTING FIXTURE ON NIGHT LIGHT CIRCUIT
	WALL WASH LIGHTING FIXTURE ON NORMAL BRANCH POWER - ARROW INDICATES DIRECTION OF BEAM		WALL WASH LIGHTING FIXTURE ON ENIGHT LIGHT CIRCUIT - ARROW INDICATES DIRECTION OF BEAM
	WALL SCONCE LIGHTING FIXTURE ON NORMAL BRANCH POWER - WALL MOUNTED		WALL SCONCE LIGHTING FIXTURE ON NIGHT LIGHT CIRCUIT - WALL MOUNTED
	TRACK LIGHT HEAD ON NORMAL BRANCH POWER		TRACK LIGHT HEAD ON ENIGHT LIGHT CIRCUIT
	BOLLARD LIGHT FIXTURE ON NORMAL BRANCH POWER		BOLLARD ON NIGHT LIGHT CIRCUIT
	SITE LIGHTING SINGLE HEAD ON NORMAL BRANCH POWER - POLE MOUNTED		SITE LIGHTING SINGLE HEAD ON NIGHT LIGHT CIRCUIT - POLE MOUNTED
	SITE LIGHTING DUAL HEAD ON NORMAL BRANCH POWER - POLE MOUNTED		SITE LIGHTING DUAL HEAD ON NIGHT LIGHT CIRCUIT - POLE MOUNTED
	EXIT SIGN - SINGLE FACE - CEILING MOUNTED		EXIT SIGN - DUAL FACE - CEILING MOUNTED
	EXIT SIGN - SINGLE FACE - WALL MOUNTED		EXIT SIGN - DUAL FACE - WALL MOUNTED
	LOW LEVEL EXIT SIGN - SINGLE FACE - WALL OR DOOR MOUNTED		SINGLE REMOTE EMERGENCY LIGHT - WALL MOUNTED
	DUAL HEAD EMERGENCY LIGHT WITH INTEGRAL BATTERY PACK - WALL MOUNTED		DUAL REMOTE EMERGENCY LIGHT - WALL MOUNTED
	SPST SWITCH, WALL MOUNTED, "ab" INDICATES INDIVIDUAL GANGED SWITCHES AND ASSOCIATED SWITCH LEGS CONTROLLED, SUBSCRIPT 'X' INDICATES:		K - KEY OPERATED
	2 - DOUBLE POLE		LV - LOW VOLTAGE
	3 - THREE WAY		P - PILOT LIGHT
	4 - FOUR WAY		T - WALL BOX TIMER
	D - WALL BOX DIMMER		WP - WEATHER PROOF
	OCCUPANCY SENSOR, CEILING MOUNTED		
	OCCUPANCY SENSOR, WALL MOUNTED		
	VACANCY SENSOR, CEILING MOUNTED		
	VACANCY SENSOR, WALL MOUNTED		
	DIMMING CONTROL PANEL, SUBSCRIPT 'X' INDICATES TYPE		
	DIMMING CONTROL STATION, SUBSCRIPT 'X' INDICATES TYPE OR UNIQUE IDENTIFIER		
	LIGHTING CONTROL PANEL		
	SHUNT TRIP PUSH BUTTON		
	TIME CLOCK, SUBSCRIPT 'X' INDICATES UNIQUE IDENTIFIER		
	DAYLIGHT SENSOR, CEILING MOUNTED		
	PHOTOCELL		

FIRE ALARM SYSTEM			
	FIRE ALARM STROBE, WALL MOUNTED		FIRE ALARM STROBE, CEILING MOUNTED.
	FIRE ALARM HORN, WALL MOUNTED		FIRE ALARM HORN, CEILING MOUNTED
	FIRE ALARM HORN/STROBE, WALL MOUNTED		FIRE ALARM HORN/STROBE, CEILING MOUNTED
	FIRE ALARM SPEAKER, WALL MOUNTED		FIRE ALARM SPEAKER, CEILING MOUNTED
	FIRE ALARM SPEAKER/STROBE, WALL MOUNTED		FIRE ALARM SPEAKER/STROBE, CEILING MOUNTED
	FIRE ALARM BELL, WALL MOUNTED		FIRE ALARM PULL STATION
	HEAT DETECTOR, WALL MOUNTED		HEAT DETECTOR, CEILING MOUNTED
	SMOKE DETECTOR, WALL MOUNTED		SMOKE DETECTOR, CEILING MOUNTED
	SMOKE DETECTOR, DUCT MOUNTED		FIRE/SMOKE DAMPER
	CARBON MONOXIDE DETECTOR		SMOKE DAMPER
	FIREFIGHTERS TELEPHONE OUTLET		SMOKE ALARM
	REMOTE INDICATOR LIGHT		COMBINATION SMOKE ALARM AND CARBON MONOXIDE DETECTOR
	FIRE ALARM CONTROL PANEL		TAMPER SWITCH
	FIRE ALARM REMOTE ANNUNCIATOR PANEL		REMOTE TEST STATION
	DATA GATHERING PANEL		FLOW SWITCH
	FIRE ALARM TERMINAL CABINET		SUPERVISORY VALVE
	FIRE ALARM TRANSPONDER PANEL		ELECTRO-MAGNETIC DOOR HOLDER

MASTER CLOCK SYSTEM	
	ANALOG MASTER CLOCK
	DIGITAL MASTER CLOCK
	ELAPSED DIGITAL TIMER CLOCK

TELECOMMUNICATIONS SYSTEM			
	WALL MOUNT DATA OUTLET		WALL MOUNT DATA OUTLET ABOVE COUNTER
	WALL MOUNT VOICE OUTLET		WALL MOUNT VOICE OUTLET ABOVE COUNTER
	WALL MOUNT DATA/VOICE OUTLET		WALL MOUNT DATA/VOICE OUTLET ABOVE COUNTER
	CEILING MOUNT VOICE OUTLET		FLOOR MOUNT DATA OUTLET
	CEILING MOUNT DATA OUTLET		FLOOR MOUNT VOICE OUTLET
	CEILING MOUNT DATA/VOICE OUTLET		FLOOR MOUNT DATA/VOICE OUTLET
	CEILING MOUNT DATA FOR WIRELESS ACCESS POINT		CONSOLIDATION POINT
<div> <div> <div>DEVICE LEGEND</div> <div> <div> <div>NUMBER OF DATA JACKS</div> <div>NUMBER OF VOICE JACKS</div> </div> </div> <div> <div>NO SUBSCRIPT = (1) DATA/VOICE</div> <div>WIRELESS ACCESS POINT = (2) DATA</div> </div> </div> <div> <div>MOUNTING:</div> <div>OUTLET MOUNTING HEIGHTS TO BE COORDINATED WITH INTERIOR DESIGNER DURING DD PHASE</div> </div> </div>			

SECURITY SYSTEM			
<div> <div> <div>DEVICE LEGEND</div> <div> <div> <div>DEVICE TAG</div> <div> <div> <div>NUMBER OF DATA JACKS</div> <div>NUMBER OF VOICE JACKS</div> </div> </div> <div> <div>NO SUBSCRIPT = (1) DATA/VOICE</div> <div>WIRELESS ACCESS POINT = (2) DATA</div> </div> </div> <div> <div>MOUNTING:</div> <div>OUTLET MOUNTING HEIGHTS TO BE COORDINATED WITH INTERIOR DESIGNER DURING DD PHASE</div> </div> </div> </div></div>			
ALL SECURITY SYSTEM DEVICES ARE WALL MOUNTED UNLESS OTHERWISE INDICATED BY MOUNTING TAG			
	ACCESS CONTROL PANEL		AUTO DOOR OPERATOR
	ALARM DEVICE		CARD READER
	DOOR CONTACT		DOOR CONTROLLER
	DURESS BUTTON		ELECTRIFIED LOCKSET
	ELECTRIFIED PANIC HARDWARE		ELECTRIC STRIKE
	GLASS BREAK DETECTOR		INTERCOM
	INTRUSION DETECTION DEVICE		KEYPAD
	KEY SWITCH		MAGNETIC LOCK
	MOTION SENSOR		PUSH BUTTON
	PANEL / CONTROLLER		PUSH PLATE
	INFRARED CURTAIN		POWER TRANSFER
	INFRARED READER		REQUEST TO EXIT DEVICE
	REMOTE DISPLAY UNIT		ALARM SENSOR
	LOCAL AREA RECEIVER		SECURITY SYSTEM POWER SUPPLY
	DIRECTIONAL PASSIVE TAG DETECTOR		SERVER
	INFRARED		SECURITY WORKSTATION
	RF READER		CCTV CAMERA, WALL-MOUNTED
	RF READER MASTER		CCTV CAMERA, CEILING-MOUNTED
	RF LONG RANGE READER		
	RF ETHERNET READER		

AUDIOVISUAL SYSTEM DEVICES	
<div> <div> <div>DEVICE LEGEND</div> <div> <div> <div>DEVICE TAG</div> <div> <div> <div>NUMBER OF DATA JACKS</div> <div>NUMBER OF VOICE JACKS</div> </div> </div> <div> <div>NO SUBSCRIPT = (1) DATA/VOICE</div> <div>WIRELESS ACCESS POINT = (2) DATA</div> </div> </div> <div> <div>MOUNTING:</div> <div>OUTLET MOUNTING HEIGHTS TO BE COORDINATED WITH INTERIOR DESIGNER DURING DD PHASE</div> </div> </div> </div></div>	
ALL AV SYSTEM DEVICES ARE WALL MOUNTED UNLESS OTHERWISE INDICATED BY MOUNTING TAG	
	AV CONNECTIVITY CW 1-GANG MUD RING CW 27 MMC STUB UP TO CEILING SPACE
	DISPLAY
	DISPLAY INFRASTRUCTURE CW 1-GANG MUD RING BEHIND DISPLAY
	PROJECTOR SCREEN
	PROJECTOR
	AV SYSTEM CAMERA
	INFRARED RADIATOR
	ANTENNA
	AV SYSTEM ROOM OCCUPANCY SENSOR
	AV SYSTEM PARTITION SENSOR
	PHOTOMETRIC SENSOR
	BACHET INTERFACE TO AV SYSTEM
	LIGHTING INTERFACE TO AV SYSTEM
	SHADE/DRAPE INTERFACE TO AV SYSTEM
	MICROPHONE
	TOUCH SCREEN
	ROOM SCHEDULING PANEL
	ROOM SCHEDULING SIGN
	BUTTON PANEL
	AV SYSTEM SPEAKER
	SUBWOOFER SPEAKER
	LOCAL CREDENZA RACK
	AV RACK
	FLOOR BOX "X" DENOTES TYPE, REFER TO AV SYSTEMS DETAILS
	POKE THROUGH "X" DENOTES TYPE, REFER TO AV SYSTEMS DETAILS
	TABLE BOX "X" DENOTES TYPE, REFER TO AV SYSTEMS DETAILS

MISCELLANEOUS DEVICES	
	JUNCTION BOX, WALL MOUNTED
	JUNCTION BOX, CEILING MOUNTED
	CONTACTOR, SUBSCRIPT 'X' INDICATES UNIQUE IDENTIFIER
	CONTROL RELAY & REQUIRED INPUT/OUTPUT MODULE

DEMOLITION	
	EXISTING TO BE REMOVED
	EXISTING TO BE RELOCATED
	EXISTING TO REMAIN
	EXISTING - NEW LOCATION
	DEMOLITION CONDUIT
	DEMOLITION EQUIPMENT
	EXISTING TO REMAIN CONDUIT
	EXISTING TO REMAIN EQUIPMENT
	RELOCATED / NEW CONDUIT
	RELOCATED / NEW EQUIPMENT


TAGS AND CALL OUT SYMBOLS	
	SECTION CALLOUT SECTION DESIGNATION SHEET NUMBER
	DETAIL CALLOUT DETAIL DESIGNATION SHEET NUMBER
	REVISION CALLOUT
	KEYNOTE CALLOUT

ABBREVIATIONS			
A	ANALOG	MD	MOTORIZED DAMPER
AFF	ARC FAULT CIRCUIT INTERRUPTOR	MH	MOUNTING HEIGHT
ATS	ABOVE FINISHED FLOOR	MS	MASTER STATION
BM	AUTOMATIC TRANSFER SWITCH	MJ	MULLION MOUNTED
CK	BEAM MOUNTED	NC	NORMALLY CLOSED
CL	CLOCK HANGER	NO	NORMALLY OPEN
CM	CEILING MOUNTED	OC	OVER THE COUNTER
EMT	ELECTRICAL METALLIC TUBING	PL	POLE MOUNTED
EP	EXPLOSION PROOF	PTZ	PAN, TILT, ZOOM
F	FURNITURE OR MILLWORK MOUNTED	RIO	ROUGH-IN ONLY
FL	FLOOR MOUNTED	ST	SHUNT TRIP
GFI	GROUND FAULT CIRCUIT INTERRUPTER	TP	TAMPER PROOF
MCB	GROUND FAULT INTERRUPTER	VS	VIDEO STATION
MCC	MAIN CIRCUIT BREAKER	WP	WEATHER PROOF

DRAWING LIST	
E001	GENERAL SYMBOLS, LEGENDS AND DRAWING LIST
E101	PARTIAL BASEMENT FLOOR - POWER AND SYSTEMS - DEMO AND NEW
E102	PARTIAL GROUND FLOOR - POWER AND SYSTEMS - DEMO AND NEW
E103	PARTIAL SECOND FLOOR - POWER AND SYSTEMS - DEMO AND NEW
E104	PARTIAL THIRD FLOOR - POWER AND SYSTEMS - DEMO AND NEW
E201	PARTIAL BASEMENT FLOOR - LIGHTING - DEMO AND NEW
E202	PARTIAL FIRST FLOOR - LIGHTING - DEMO AND NEW
E203	PARTIAL SECOND FLOOR - LIGHTING - DEMO AND NEW
E204	PARTIAL THIRD FLOOR - LIGHTING - DEMO AND NEW
E301	ELECTRICAL DETAILS
E311	TECHNOLOGY DETAILS
E312	TECHNOLOGY DETAILS
E401	PANEL SCHEDULES
E402	PANEL SCHEDULES

GENERAL NOTES

1. ELECTRICAL DOCUMENTS ARE BASED ON AVAILABLE INFORMATION AND, SHALL BE READ IN CONJUNCTION WITH OTHER CONSULTANTS INCLUDING BUT NOT LIMITED TO ARCHITECTURAL, STRUCTURAL, MECHANICAL, DOOR HARDWARE CONSULTANT DOCUMENTS.
2. THE ELECTRICAL DRAWINGS ARE DIAGRAMMATIC AND SHOW GENERAL ARRANGEMENTS OF ELECTRICAL AND SYSTEMS DEVICES. THE FINAL LOCATION AND ELEVATION OF ALL ELECTRICAL AND SYSTEMS DEVICES SHALL BE COORDINATED WITH ARCHITECTURAL INTERIOR DESIGNERS PACKAGES. REPORT ANY DISCREPANCIES TO CONSULTANT PRIOR TO ROUGH-IN. FOR DIMENSIONS, REFER TO ARCHITECTURAL/INTERIOR DESIGN PACKAGES.
3. ALL EQUIPMENT LAYOUTS SHOWN ARE FOR REFERENCE ONLY BASED ON INTENDED EQUIPMENT AT TIME OF DESIGN. THE CONTRACTOR MUST PREPARE THE WORKING DRAWINGS BASED ON ACTUAL EQUIPMENT SELECTION (SHOP DRAWINGS) FOR THE EQUIPMENT ROOM LAYOUT PRIOR TO ROUGH-IN AND CONSTRUCTION.
4. THE ELECTRICAL CONTRACTOR SHALL BE RESPONSIBLE TO COORDINATE WITH THE GENERAL CONTRACTOR TO PROVIDE AND INSTALL TEMPORARY POWER FOR PROJECT CONSTRUCTION AS REQUIRED.
5. PROVIDE ELECTRICAL COORDINATION WITH SHOP DRAWING SELECTION AND LOCATION. REFER TO MECHANICAL EQUIPMENT SCHEDULES FOR DETAILS. VERIFY THE FINAL LOCATION OF MECHANICAL EQUIPMENT PRIOR TO INSTALLATION.
6. CONTRACTOR SHALL IDENTIFY AND LABEL CLEARLY ALL CIRCUITS, WIRING, SERVICES, JUNCTION BOXES, PULL BOXES, DEVICES AND EQUIPMENT INSTALLED AND CONNECTED UNDER THE SCOPE OF WORK OF THIS PROJECT. IDENTIFICATION SHALL BE AS PER SPECIFICATION AND ALL APPLICABLE INDUSTRY STANDARDS UNLESS SPECIAL OWNER'S REQUIREMENTS. ALL MARKINGS SHALL BE OF NON-ERASABLE LAMACOD TYPE.
7. ALL OPENINGS, IF APPLICABLE, SHALL BE SEALED WITH APPROVED FIRE STOP MATERIAL. ANY FIREPROOFING MATERIAL REMOVED WILL BE REPLACED WITH A SUITABLE AND APPROVED FIREPROOFING MATERIAL AND SHALL BE INSTALLED AS PER MANUFACTURER'S RECOMMENDATIONS TO APPLICABLE BUILDING AND FIRE CODES.
8. CONTRACTOR SHALL INCLUDE FOR PAYMENT OF REQUIREMENT PERMITS, FEES, LICENCES, CERTIFICATES OF INSPECTION, ETC. IF REQUIRED.
9. CABLE AND CONDUIT SIZES INDICATED ON DRAWINGS ARE MINIMUM SIZES AND SHALL BE INCREASED BASED ON ACTUAL ROUTING AND VOLTAGE DROP.
10. ELECTRICAL CONTRACTOR SHALL COORDINATE WITH MECHANICAL CONTRACTOR FOR ALL SHOP DRAWINGS PRIOR TO PROCUREMENT AND INSTALLATION OF RELATED ELECTRICAL CONNECTIONS. ANY ALTERATIONS DUE TO MECHANICAL COORDINATION SHALL BE RECORDED IN ELECTRICAL AS-BUILTS.
11. ALL NOT IN SCOPE AREAS ARE TO REMAIN ACTIVE AND OPERATIONAL DURING THE ENTIRE DURATION OF WORK. WIRING, CONDUIT, AND EQUIPMENT REQUIRED TO MAINTAIN SERVICE SHALL BE TEMPORARILY SUPPORTED, RE-ROUTED, SERVICED, OR RELOCATED AS REQUIRED. ANY LOSS OF SERVICES TO SPACES OUTSIDE OF THE SCOPE OF WORK SHALL BE COORDINATED WITH FACILITY MANAGEMENT.
12. CONTRACTOR SHALL CONDUCT A SITE REVIEW PRIOR TO PRICING TO BECOME FAMILIAR WITH THE SITE CONDITIONS. VERIFY ALL LOCATIONS, SIZES, AND CONNECTIONS ON SITE AND REPORT ANY DISCREPANCIES TO THE CONSULTANT WITH PROPOSED RESOLUTION AND OBTAIN CONSULTANT'S APPROVAL.
13. MAINTAIN EXISTING FIRE ALARM, EXIT SIGNS AND EMERGENCY LIGHTS IN FULL OPERATION DURING THE ENTIRE CONSTRUCTION STAGE. WHERE DISRUPTION TO LIFE SAFETY SYSTEMS ARE REQUIRED, REPORT TO THE OWNER. PROVIDE CONTINUOUS MONITORING DURING SHUT DOWN PERIOD, AND ENSURE THAT ALL SYSTEMS ARE REACTIVATED PRIOR TO LEAVING THE SITE AT THE END OF EACH WORKING DAY.
14. CONTRACTOR SHALL BE RESPONSIBLE FOR ALL REFINISHING OF DAMAGED BUILDING AREAS AND FINISHES AFFECTED BY THE WORK AS OUTLINED UNDER SCOPE OF WORK OF THIS PROJECT. SHOULD ANY EXISTING SYSTEM BE DAMAGED, MAKE FULL REPAIRS/REPLACES WITHOUT EXTRA COST, AND TO THE SATISFACTION OF THE OWNER.
15. CONTRACTOR SHALL PROVIDE WRITTEN NOTICE TO THE OWNER FOR ANY SHUTDOWN REQUIRED 3 DAYS PRIOR. SHUTDOWNS SHALL BE PERFORMED DURING AFTER HOURS OR ON WEEKENDS AT THE CONTRACTOR'S EXPENSE.
16. CONTRACTOR IS RESPONSIBLE FOR STORAGE AND PROTECTION OF ALL EXISTING ITEMS WHICH WILL BE RELOCATED/REUSED IN THIS PROJECT.
17. HORIZONTAL COMMUNICATIONS CABLES SHALL NOT EXCEED 90 METERS IN LENGTH FROM NETWORK SWITCH TO TERMINATION POINT. WHERE CABLEING DISTANCES EXCEED 90 METERS, CONTRACTOR SHALL REPORT THE CONDITIONS TO THE CONSULTANT AND OWNER FOR FURTHER DIRECTION.
18. IN CEILING CONSULATION POINTS IDENTIFIED ON DRAWINGS ARE PROPOSED APPROXIMATE LOCATIONS ONLY. FINAL PLACEMENTS OF CONSULATION POINTS SHALL BE COORDINATED WITH CEILING CONDITIONS, INCLUDING BUT NOT LIMITED TO CEILING GRID, LIGHT FIXTURES, EXISTING EQUIPMENT, ETC. AND MAY BE MOUNTED WITHIN A 2 METRE RADIUS FROM PROPOSED LOCATIONS. CONTRACTOR SHALL IDENTIFY FINAL AS-BUILT LOCATIONS.
19. ALL EXISTING CABLES IN GOOD CONDITION AND NOT DAMAGED SHALL BE RE-TERMINATED ON NEW JACKS IN PATCH PANELS INSIDE NEW CONSULATION POINTS AS PROPOSED ON NEW LAYOUT. REFER TO SPECIFICATIONS SECTION 27.05.00 COMMON WORK RESULTS FOR COMMUNICATIONS. WHERE PERMANENT LINK TESTING OF EXISTING CABLES YIELDED A FAILED TEST RESULT, CONTRACTOR SHALL REPORT THE CONDITIONS TO THE CONSULTANT AND OWNER FOR FURTHER DIRECTION.
20. ELECTRICAL CONTRACTOR SHALL PROVIDE ALL CONDUIT INFRASTRUCTURE C/W PULL STRIPS FOR DIVISION 27.01 40 AUDIO-VISIO SYSTEMS SCOPES AND DIVISION 28.00 40 ELECTRONIC SAFETY AND SECURITY SCOPES.
21. ALL DIVISION 27.01 40 AUDIO-VISIO SYSTEMS SCOPES AND DIVISION 28.00 40 ELECTRONIC SAFETY AND SECURITY SCOPES INCLUDING BUT NOT LIMITED TO DEVICES, CABLEING, ETC., ARE NOT PART OF THIS CONTRACT AND SHALL BE CARRIED UNDER CASH AWAY DEVICES.
22. ALL DISPLAY LOCATIONS SHALL HAVE PLYWOOD BACKBOARD FOR DISPLAY MOUNTING.
23. ALLOW FOR X-RAY, SCAN, AND CORING AS REQUIRED. CARRY ALL ASSOCIATED COSTS.

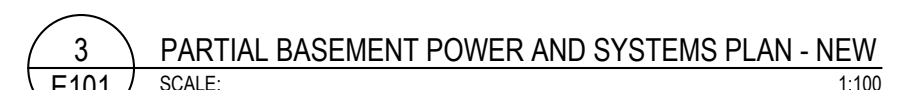

DEMOLITION LEGEND:

ELECTRICAL, IT & SECURITY:

1. EXISTING CONSTRUCTION TO REMAIN.

 ELECTRICAL, IT, AV, & SECURITY:

1. UNLESS OTHERWISE NOTED, REMOVE ALL FLOOR, COLUMN, CEILING, AND WALL MOUNTED POWER, WIRING AND CONDUIT NOT REQUIRED BACK TO SOURCE, TO SUIT THE NEW LAYOUT AND MAKE SAFE.
2. FROM ALL DEVICES INCLUDING, BUT NOT LIMITED TO, SPEAKERS, STROBES, PULL STATIONS AND SMOKE DETECTORS, SHALL BE REMOVED WITHIN THE SCOPE OF WORK AREA. ENSURE ALL EXISTING FIRE ALARM CIRCUITS REMAIN AND ARE MADE SAFE FOR USE DURING THE CONSTRUCTION PHASE.
3. REMOVE ALL LIGHTING FIXTURES, LIGHTING CONTROL DEVICES, AND EXIT SIGNS WITHIN SCOPE OF WORK AREA. REMOVE EXISTING WIRING AND CONDUIT BACK TO NEAREST JUNCTION BOX IN CEILING SPACE AND MAKE SAFE. MAINTAIN THE CIRCUIT FOR NEW LIGHTING FIXTURES.

GENERAL NOTES:

1. CIRCUITING IN PART IS DIAGRAMMATIC INTENDED TO SHOW GENERAL CIRCUIT ARRANGEMENT AND PANEL DESIGNATION. REUSE CIRCUITS OBTAINED FROM DEMOLITION AS THE PRIMARY SOURCE.
2. FOR DEVICES IN EXISTING WALLS, PROVIDE SURFACE MOUNT POWER AND DATE CONDUITS ON THE CORNER OF THE ROOM AND PROVIDE LOW LEVEL RACEWAY TO FINAL DEVICE LOCATIONS.

[illegible]

5.	ISSUED FOR TENDER	2026.05.01
4.	ISSUED FOR BUILDING PERMIT	2026.04.08
3.	ISSUED FOR 100% CLIENT REVIEW	2026.03.31
2.	ISSUED FOR 66% CLIENT REVIEW	2026.01.09


1.	ISSUED FOR COSTING REVIEW	2025.11.24
NO.	DESCRIPTION	DATE

REVISIONS
PROJECT




REGION OF PEEL

EMIL V. KOLB CENTRE
PEEL REGIONAL POLICE FACILITY
INTERIOR RENOVATION PROJECT
180 DERRY ROAD EAST, MISSISSAUGA, ON L5T 2Y5

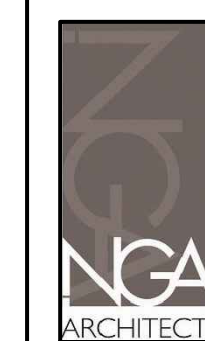


The contractor shall check and verify all dimensions and report all errors and omissions to the architect and the design professional whose seal is affixed to this drawing. Do not scale the drawings.


NORTH	STRUCTURAL CONSULTANT	STEPHENSON ENGINEERING	DATE
PROJECT NUMBER	MECHANICAL CONSULTANT	EXP SERVICES INC.	
	ELECTRICAL CONSULTANT	EXP SERVICES INC.	

SHEET TITLE	EXP. Services Inc.
PARTIAL BASEMENT FLOOR - POWER AND SYSTEM - DEMO & NEW	

SHEET NO. E101	DRAWN BY SS/LL	CHECKED KE
	PROJECT NO. MRK-25008951-A0	
	SCALE	

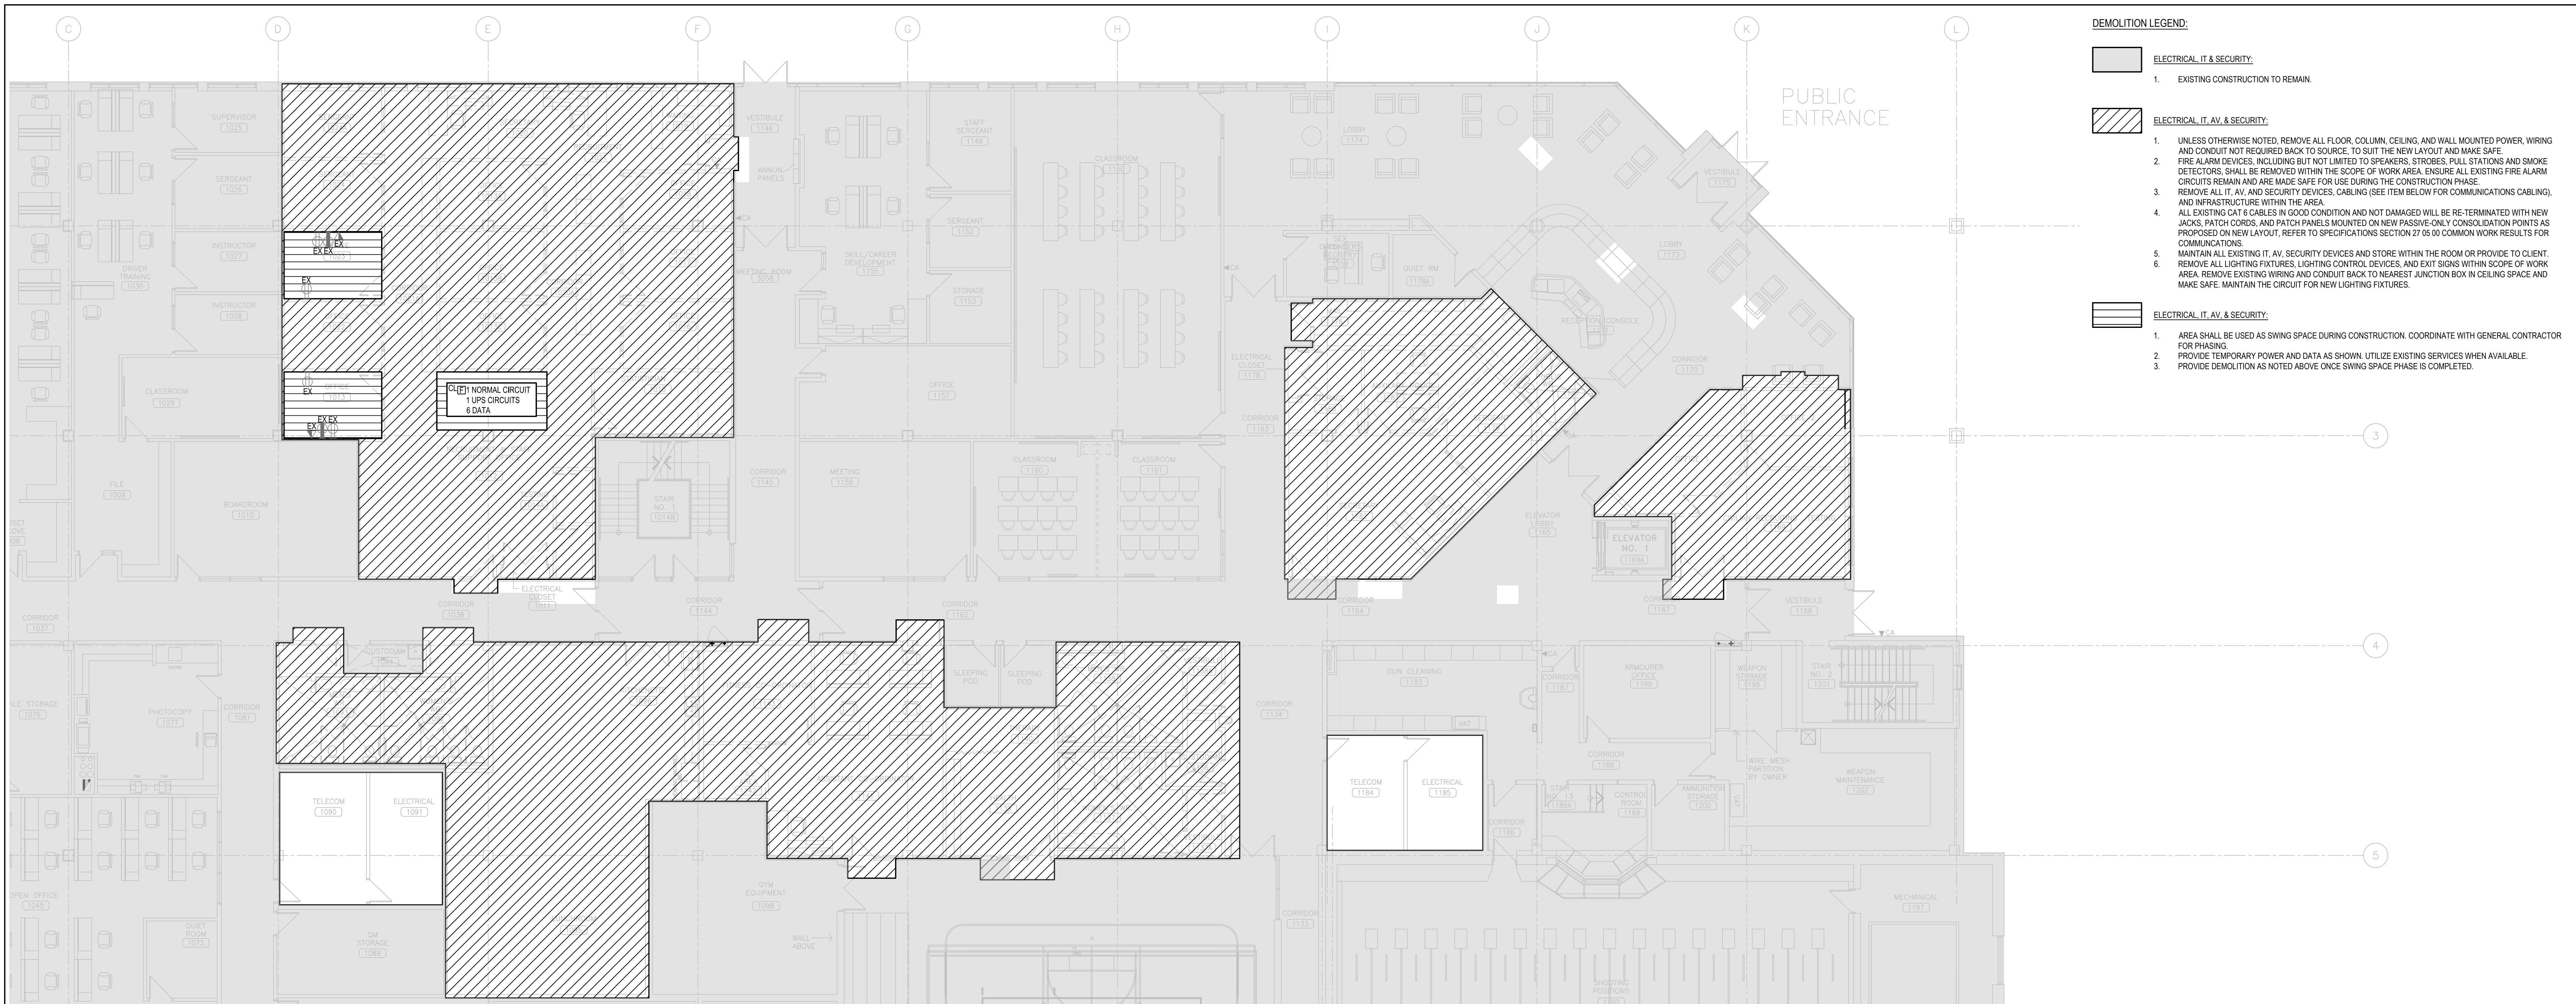

1 PARTIAL GROUND FLOOR POWER AND SYSTEMS PLAN - DEMO
E102

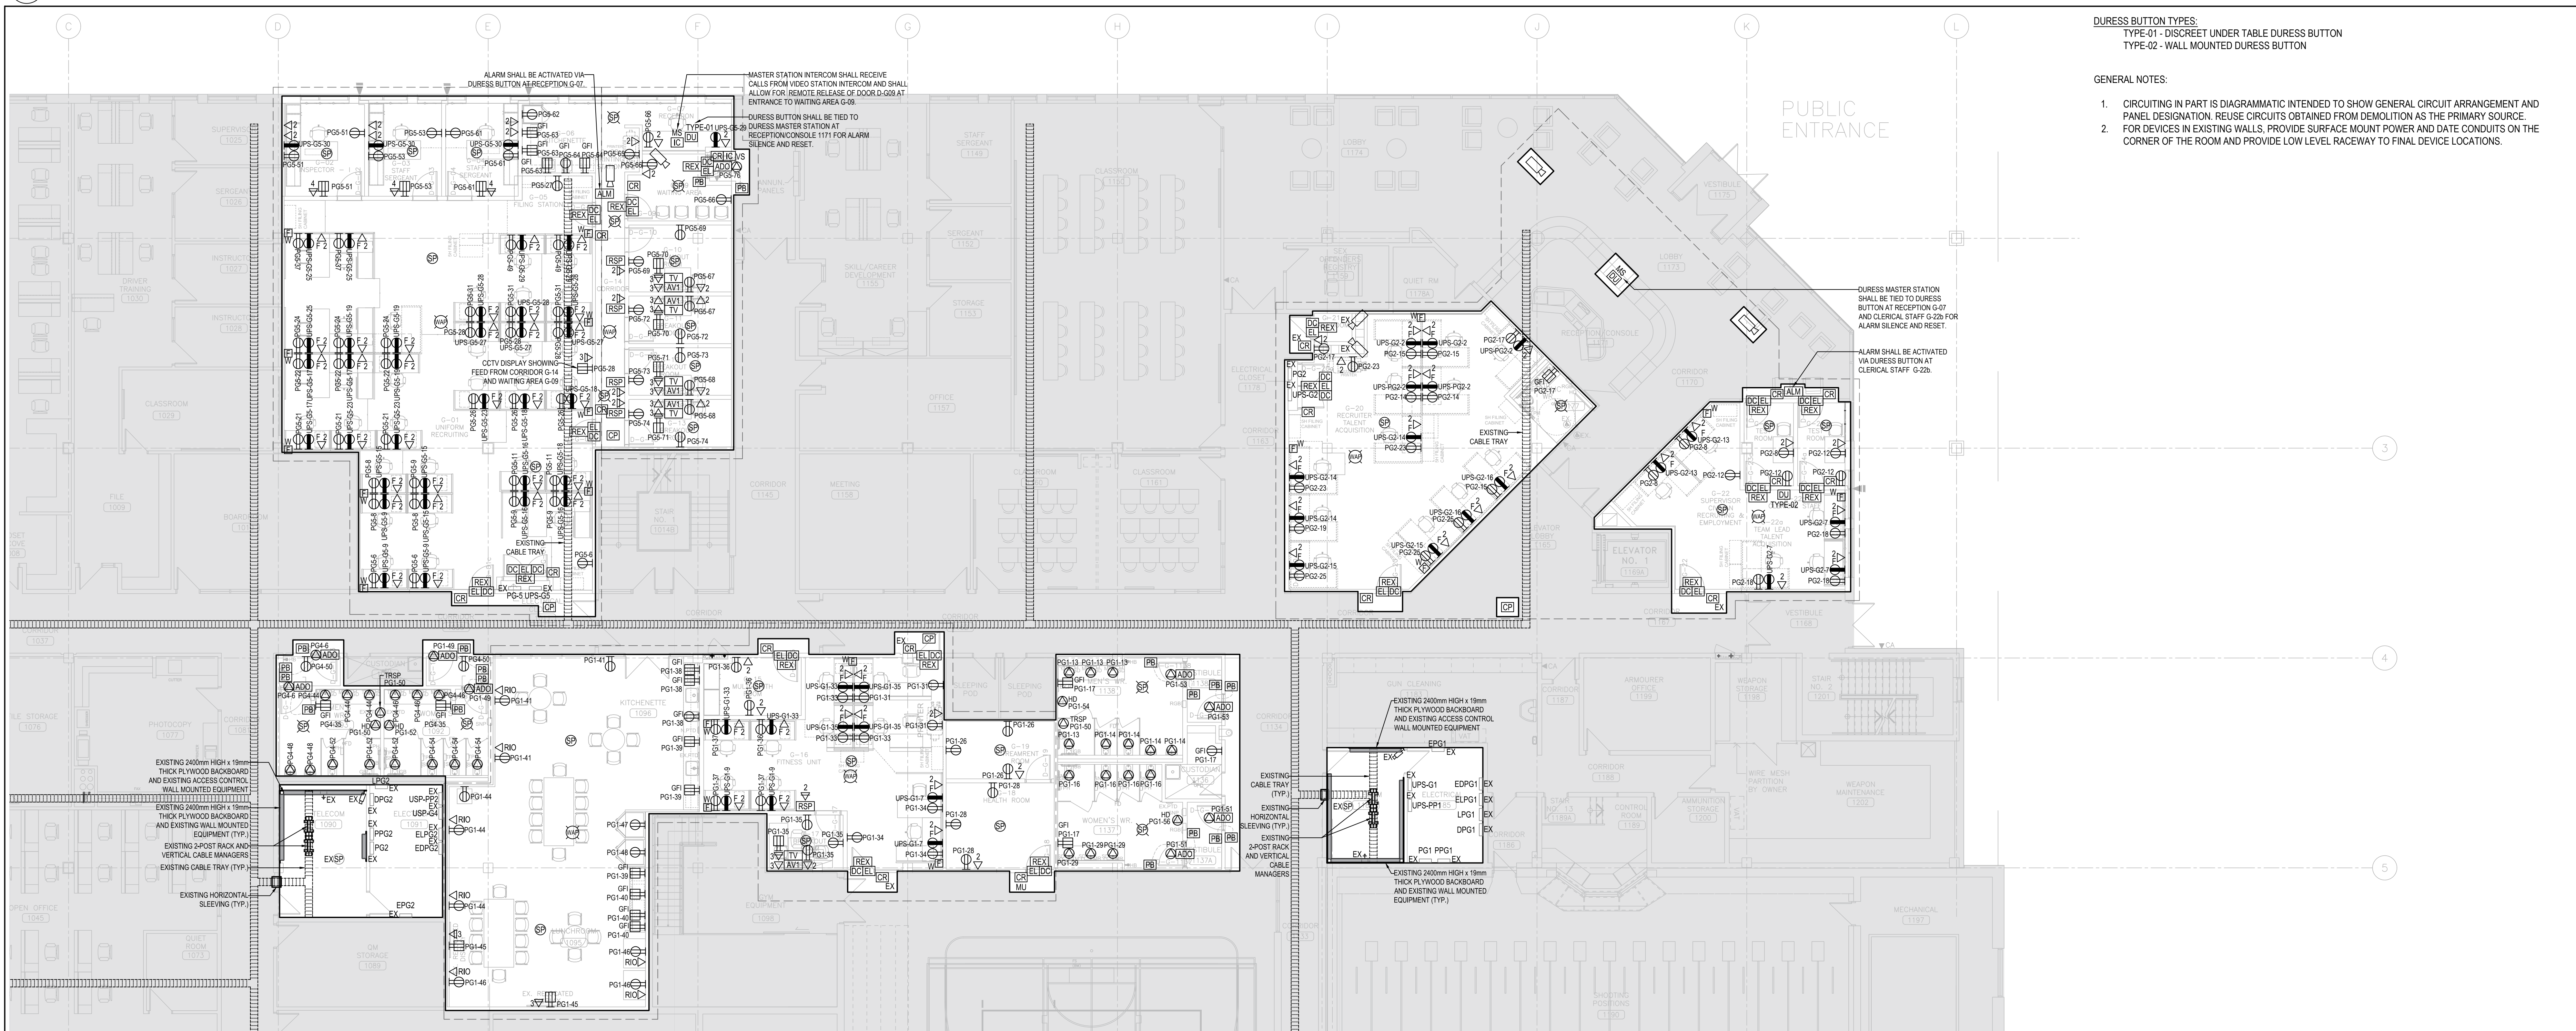

2 PARTIAL GROUND FLOOR POWER AND SYSTEMS PLAN - NEW
E102

NO.	DESCRIPTION	DATE
6	ISSUED FOR TENDER	2026.05.01
4	ISSUED FOR BUILDING PERMIT	2026.04.08
3	ISSUED FOR 100% CLIENT REVIEW	2026.03.31
2	ISSUED FOR 65% CLIENT REVIEW	2026.01.09
1	ISSUED FOR COSTING REVIEW	2025.11.24

NO.	DESCRIPTION	DATE
1	ISSUED FOR COSTING REVIEW	2025.11.24

REVISIONS

PROJECT

PEEL REGIONAL POLICE

REGION OF PEEL

EMIL V. KOLB CENTRE
PEEL REGIONAL POLICE FACILITY
INTERIOR RENOVATION PROJECT
180 DERRY ROAD EAST, MISSISSAUGA, ON L5T 2Y5

NCA
ARCHITECTS

The customer shall check and verify all dimensions and quantities and shall be responsible for any errors or omissions in the drawings. The customer shall be responsible for any errors or omissions in the drawings. The customer shall be responsible for any errors or omissions in the drawings.

STRUCTURAL CONSULTANT
STEPHENSON ENGINEERING
MECHANICAL CONSULTANT
EXP SERVICES INC.
ELECTRICAL CONSULTANT
EXP SERVICES INC.


SHEET TITLE
**PARTIAL GROUND FLOOR -
POWER AND SYSTEMS -
DEMO & NEW**

SHEET NO.	DRAWN BY	CHECKED BY
E102	MBL	ME

PROJECT NO.	SCALE
MRK-25008951-A0	



1 PARTIAL SECOND FLOOR POWER AND SYSTEMS PLAN - DEMO
SCALE

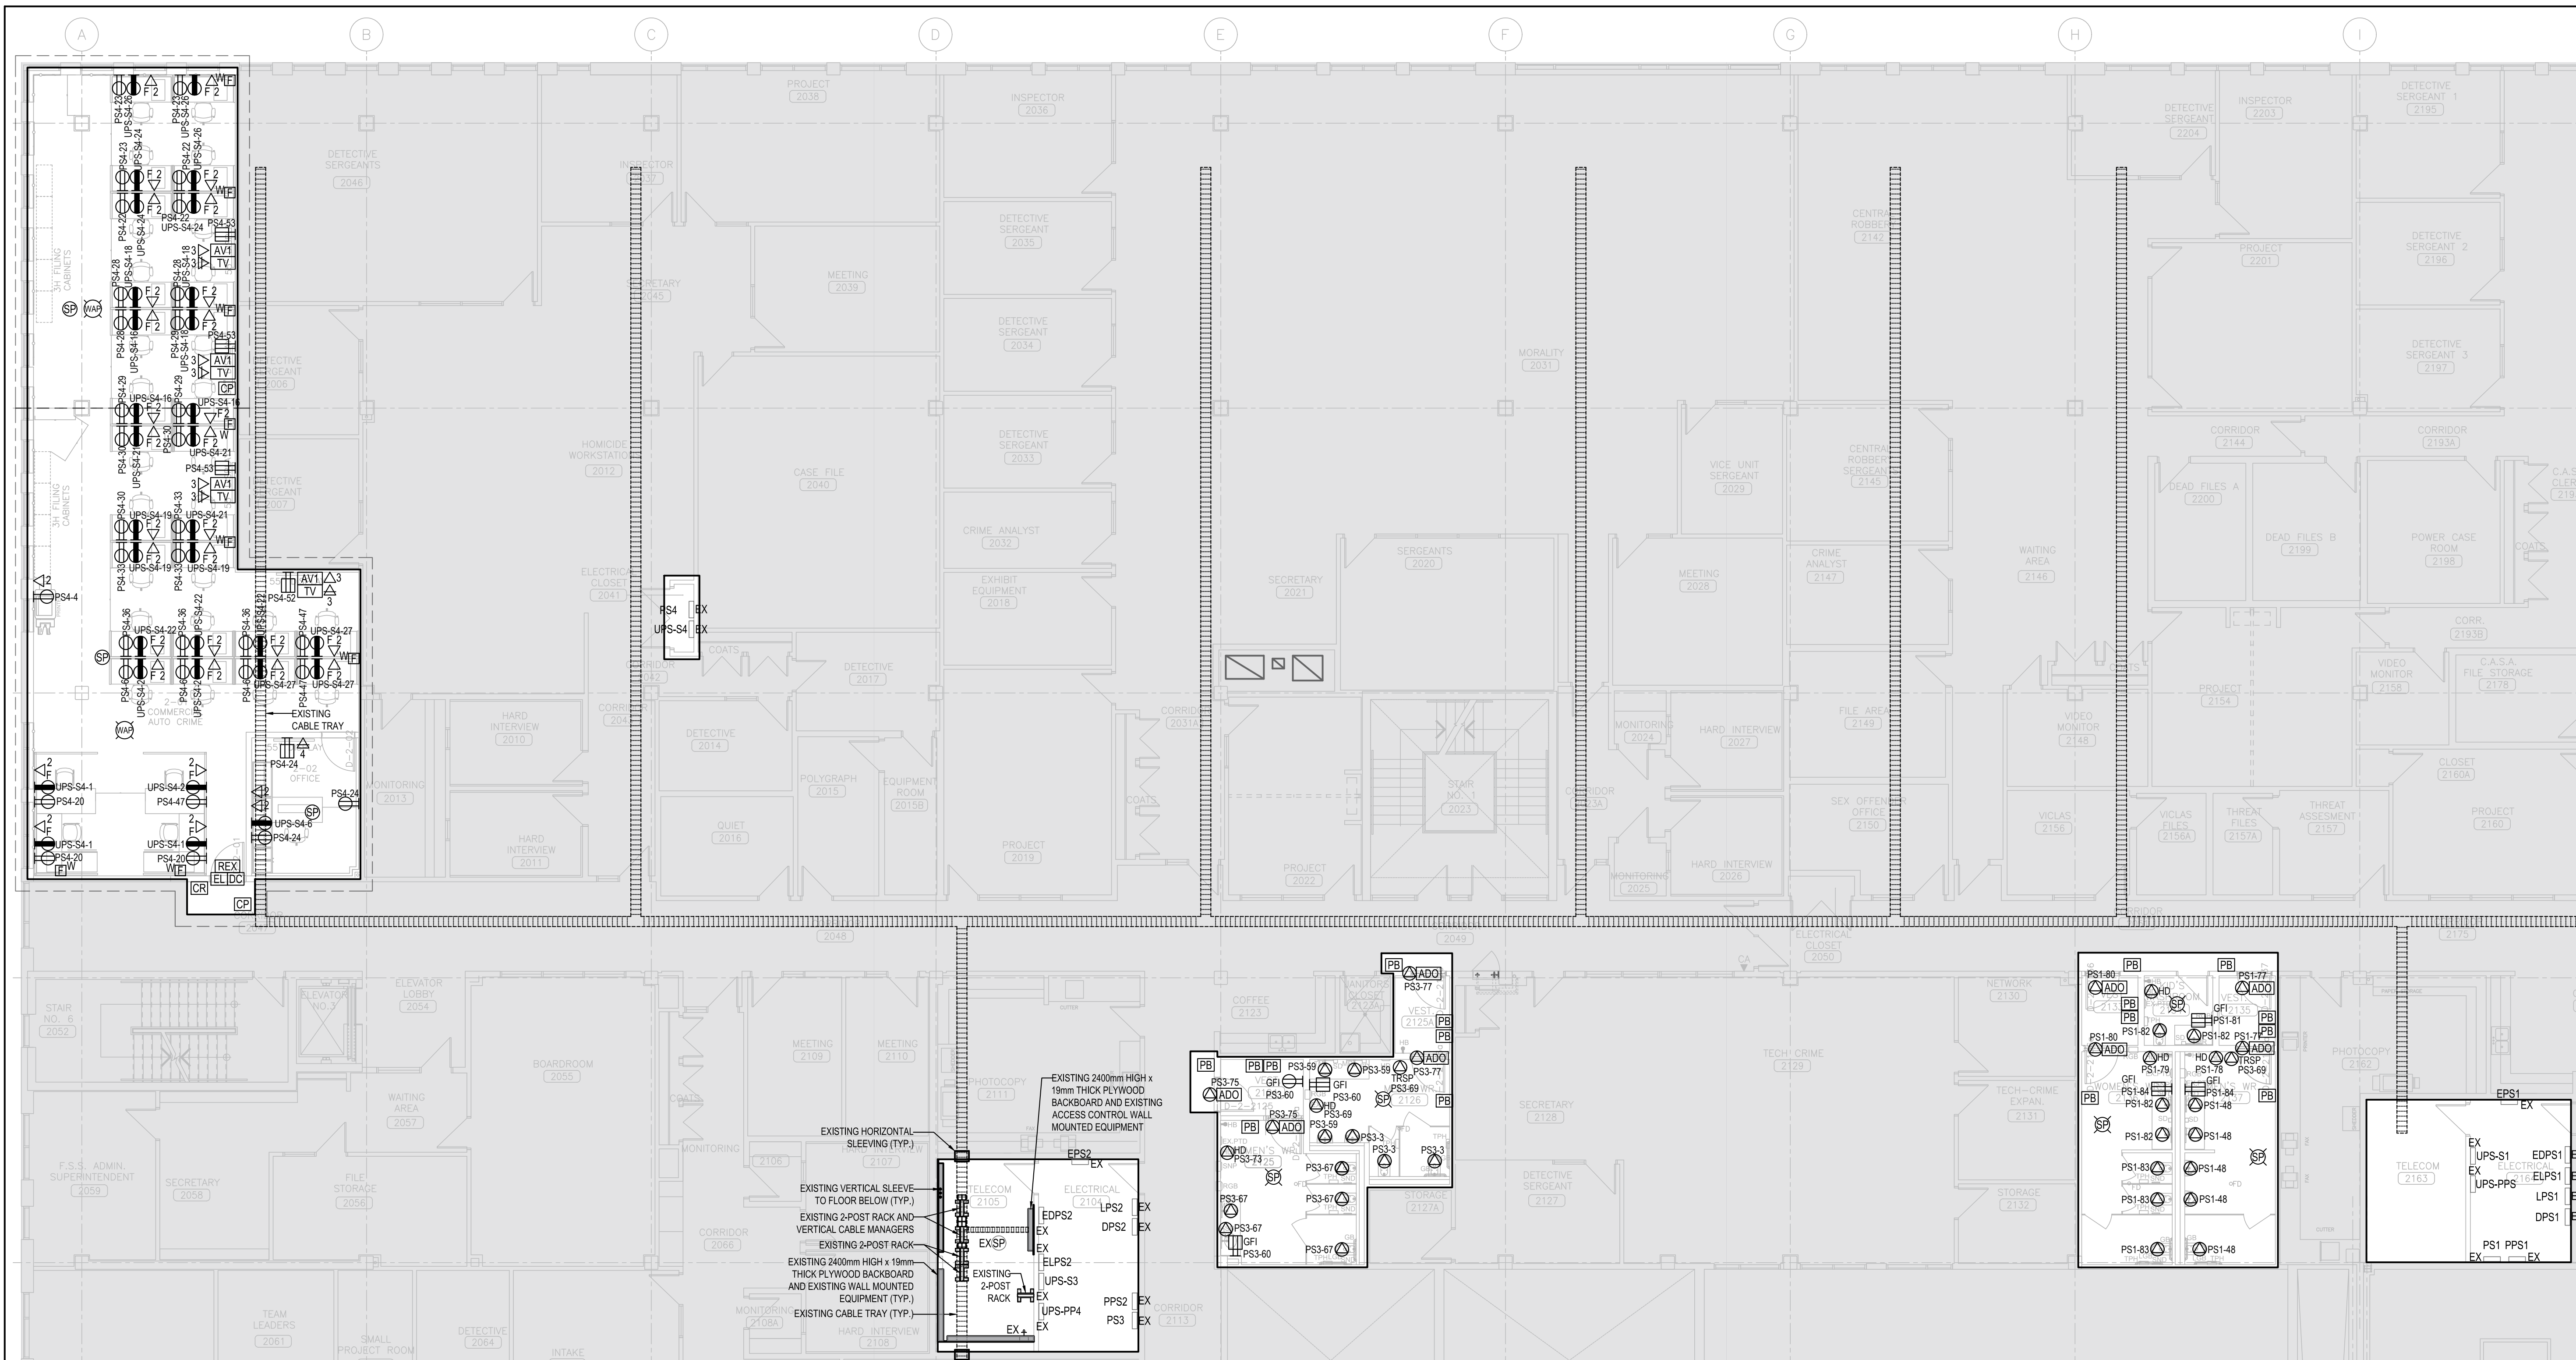

2 PARTIAL SECOND FLOOR POWER AND SYSTEMS PLAN - NEW
SCALE

DEMOLITION LEGEND:

ELECTRICAL, IT & SECURITY:

- EXISTING CONSTRUCTION TO REMAIN.

ELECTRICAL, IT, AV, & SECURITY:




- UNLESS OTHERWISE NOTED, REMOVE ALL FLOOR, COLUMN, CEILING, AND WALL MOUNTED POWER, WIRING AND CONDUIT NOT REQUIRED BACK TO SOURCE, TO SUIT THE NEW LAYOUT AND MAKE SAFE.
- FIRE ALARM DEVICES, INCLUDING BUT NOT LIMITED TO SPEAKERS, STROBES, HALL STATIONS AND SMOKE DETECTORS, SHALL BE REMOVED WITHIN THE SCOPE OF WORK AREA. ENSURE ALL EXISTING FIRE ALARM CIRCUITS REMAIN AND ARE MADE SAFE FOR USE DURING THE CONSTRUCTION PHASE.
- REMOVE ALL IT, AV, AND SECURITY DEVICES, CABLES (SEE ITEM BELOW FOR COMMUNICATIONS CABLES), AND INFRASTRUCTURE WITHIN THE AREA.
- ALL EXISTING CAT 6 CABLES IN GOOD CONDITION AND NOT DAMAGED WILL BE RE-TERMINATED WITH NEW JACKS, PATCH CORDS, AND PATCH PANELS MOUNTED ON NEW PASSIVE-ONLY CONSOLIDATION POINTS AS PROPOSED ON NEW LAYOUT. REFER TO SPECIFICATIONS SECTION 27.05.00 COMMON WORK RESULTS FOR COMMUNICATIONS.
- MAINTAIN ALL EXISTING IT, AV, SECURITY DEVICES AND STORE WITHIN THE ROOM OR PROVIDE TO CLIENT.
- REMOVE ALL LIGHTING FIXTURES, LIGHTING CONTROL DEVICES, AND EXIT SIGNS WITHIN SCOPE OF WORK AREA. REMOVE EXISTING WIRING AND CONDUIT BACK TO NEAREST JUNCTION BOX IN CEILING SPACE AND MAKE SAFE. MAINTAIN THE CIRCUIT FOR NEW LIGHTING FIXTURES.


ELECTRICAL, IT, AV, & SECURITY:

- AREA SHALL BE USED AS SWING SPACE DURING CONSTRUCTION. COORDINATE WITH GENERAL CONTRACTOR FOR PHASING.
- PROVIDE TEMPORARY POWER AND DATA AS SHOWN. UTILIZE EXISTING SERVICES WHEN AVAILABLE.
- REINSTATE TO EXISTING CONDITION ONCE SWING SPACE PHASE IS COMPLETED.


GENERAL NOTES:



- CIRCUITING IN PART IS DIAGRAMMATIC INTENDED TO SHOW GENERAL CIRCUIT ARRANGEMENT AND PANEL DESIGNATION. REUSE CIRCUITS OBTAINED FROM DEMOLITION AS THE PRIMARY SOURCE.
- FOR DEVICES IN EXISTING WALLS, PROVIDE SURFACE MOUNT POWER AND DATA CONDUITS ON THE CORNER OF THE ROOM AND PROVIDE LOW LEVEL RACEWAY TO FINAL DEVICE LOCATIONS.

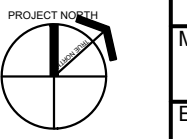6	ISSUED FOR TENDER	2026.05.01
4	ISSUED FOR BUILDING PERMIT	2026.04.08
3	ISSUED FOR 100% CLIENT REVIEW	2026.03.31
2	ISSUED FOR 60% CLIENT REVIEW	2026.01.09
1	ISSUED FOR COSTING REVIEW	2025.11.24
NO	DESCRIPTION	DATE
REVISIONS		
PROJECT		
		
REGION OF PEEL		
EMIL V. KOLB CENTRE PEEL REGIONAL POLICE FACILITY INTERIOR RENOVATION PROJECT 180 DERRY ROAD EAST, MISSISSAUGA, ON L5T 2Y5		
		
The customer shall check and verify all dimensions and quantities and ensure that they are correct before the start of the work. The customer shall be responsible for any errors or omissions in the design. The customer shall be responsible for any errors or omissions in the design. The customer shall be responsible for any errors or omissions in the design.		
NORTH		
		
SHEET TITLE		
PARTIAL SECOND FLOOR - POWER AND SYSTEMS - DEMO & NEW		
SHEET NO.	DRAWN BY	CHECKED
E103	MR	ME
PROJECT NO.	MRK-25008951-A0	
SCALE		

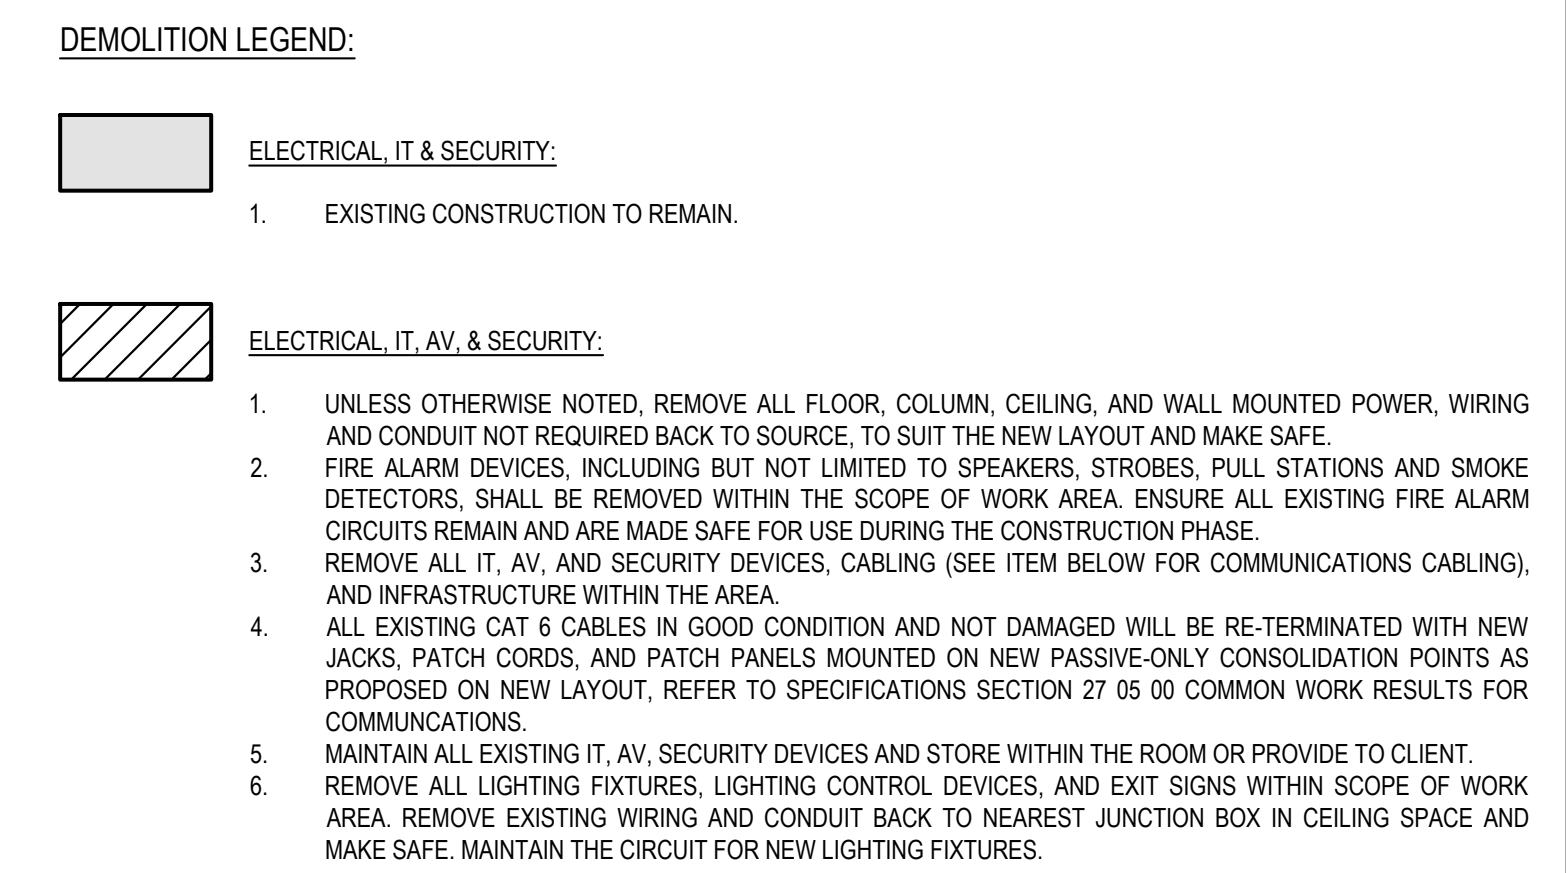


2 PARTIAL THIRD FLOOR POWER AND SYSTEMS PLAN - NEW
E104 SCALE: 1:100

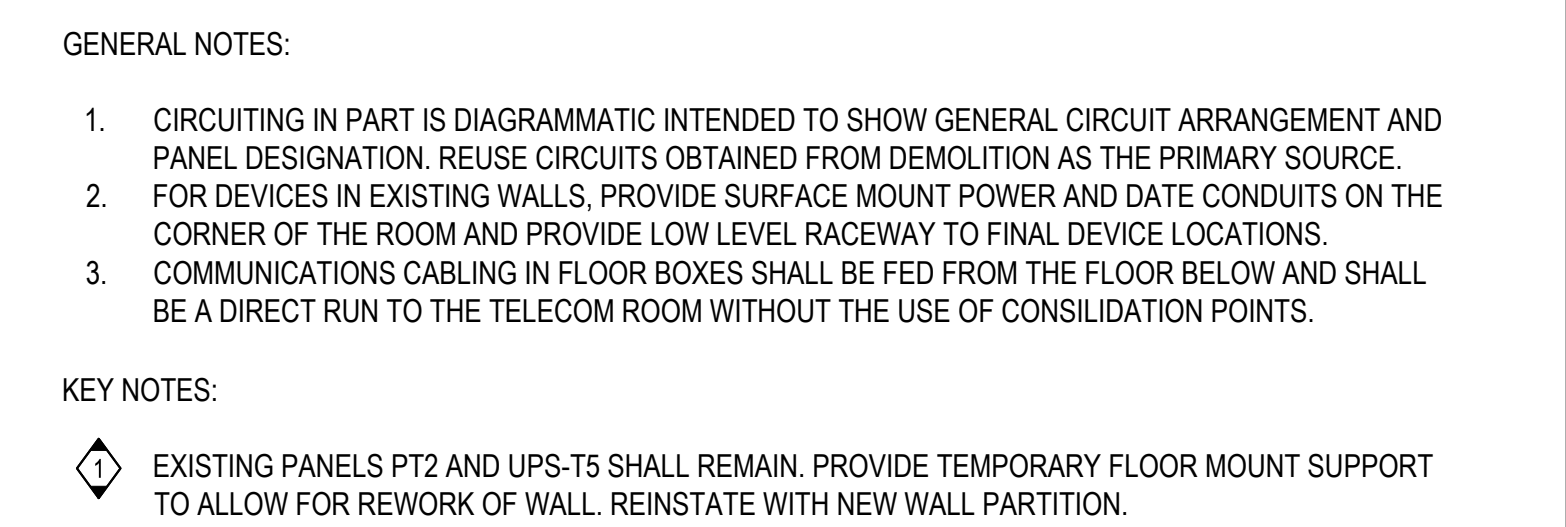[illegible]

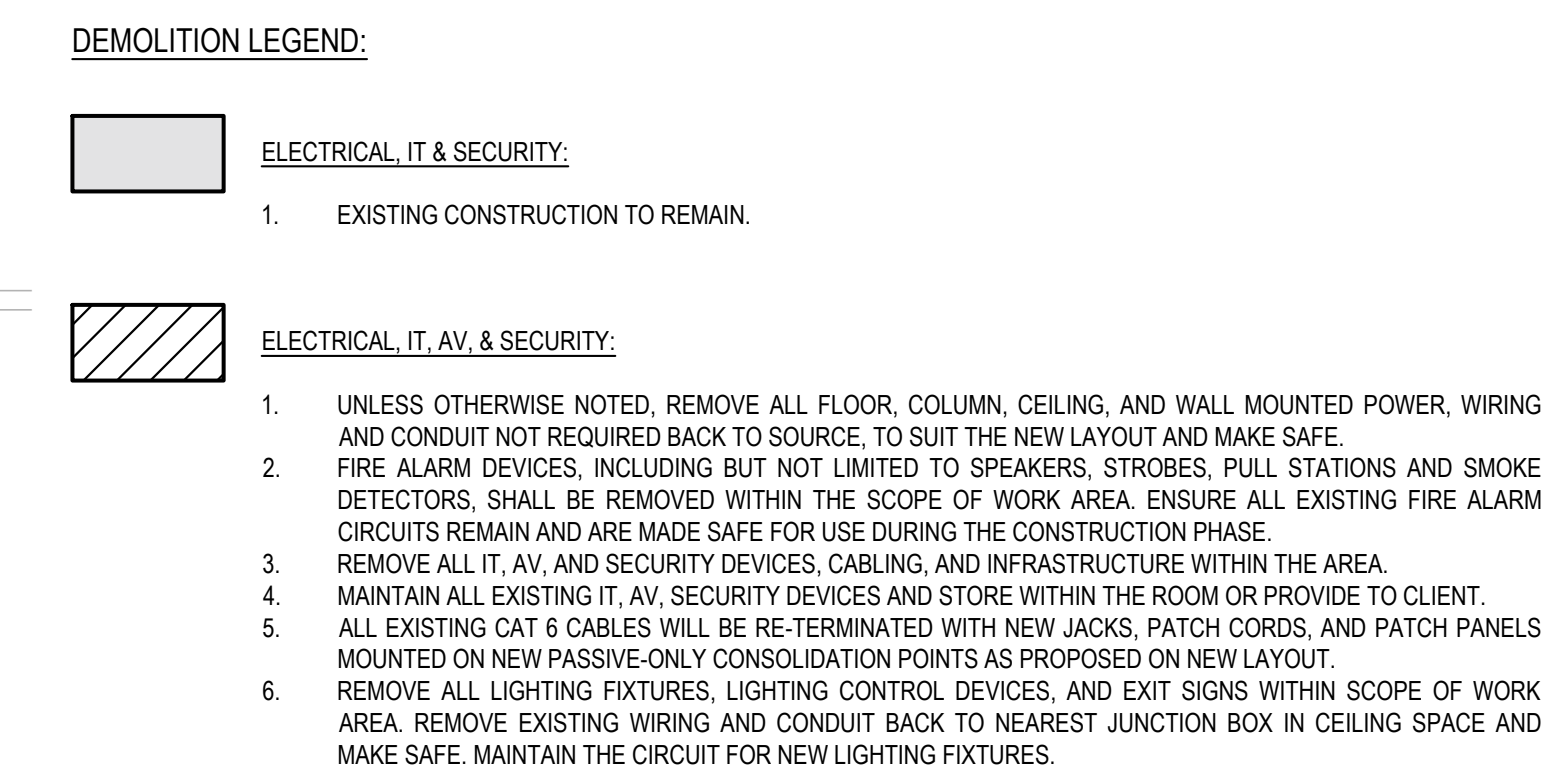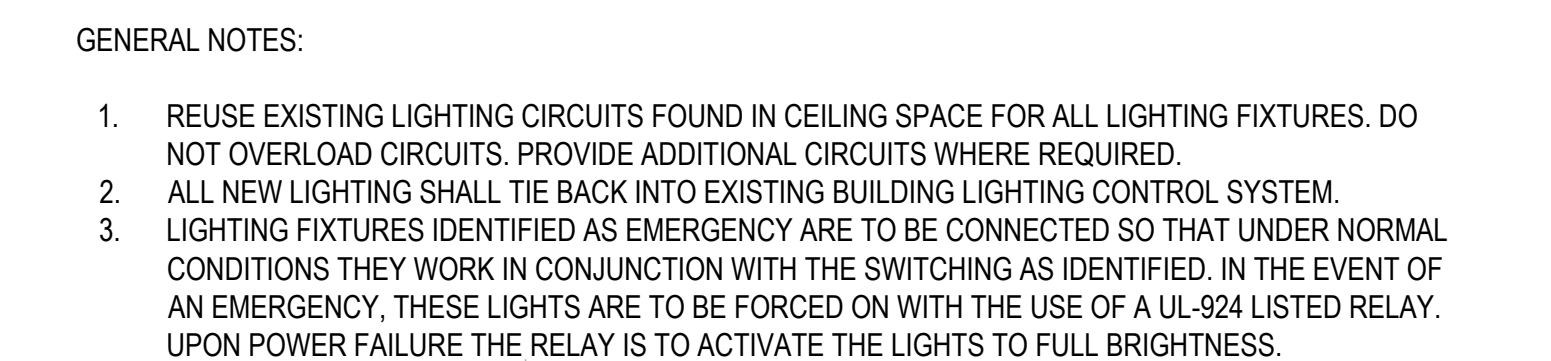[illegible]

 American Psychological Association


[illegible]

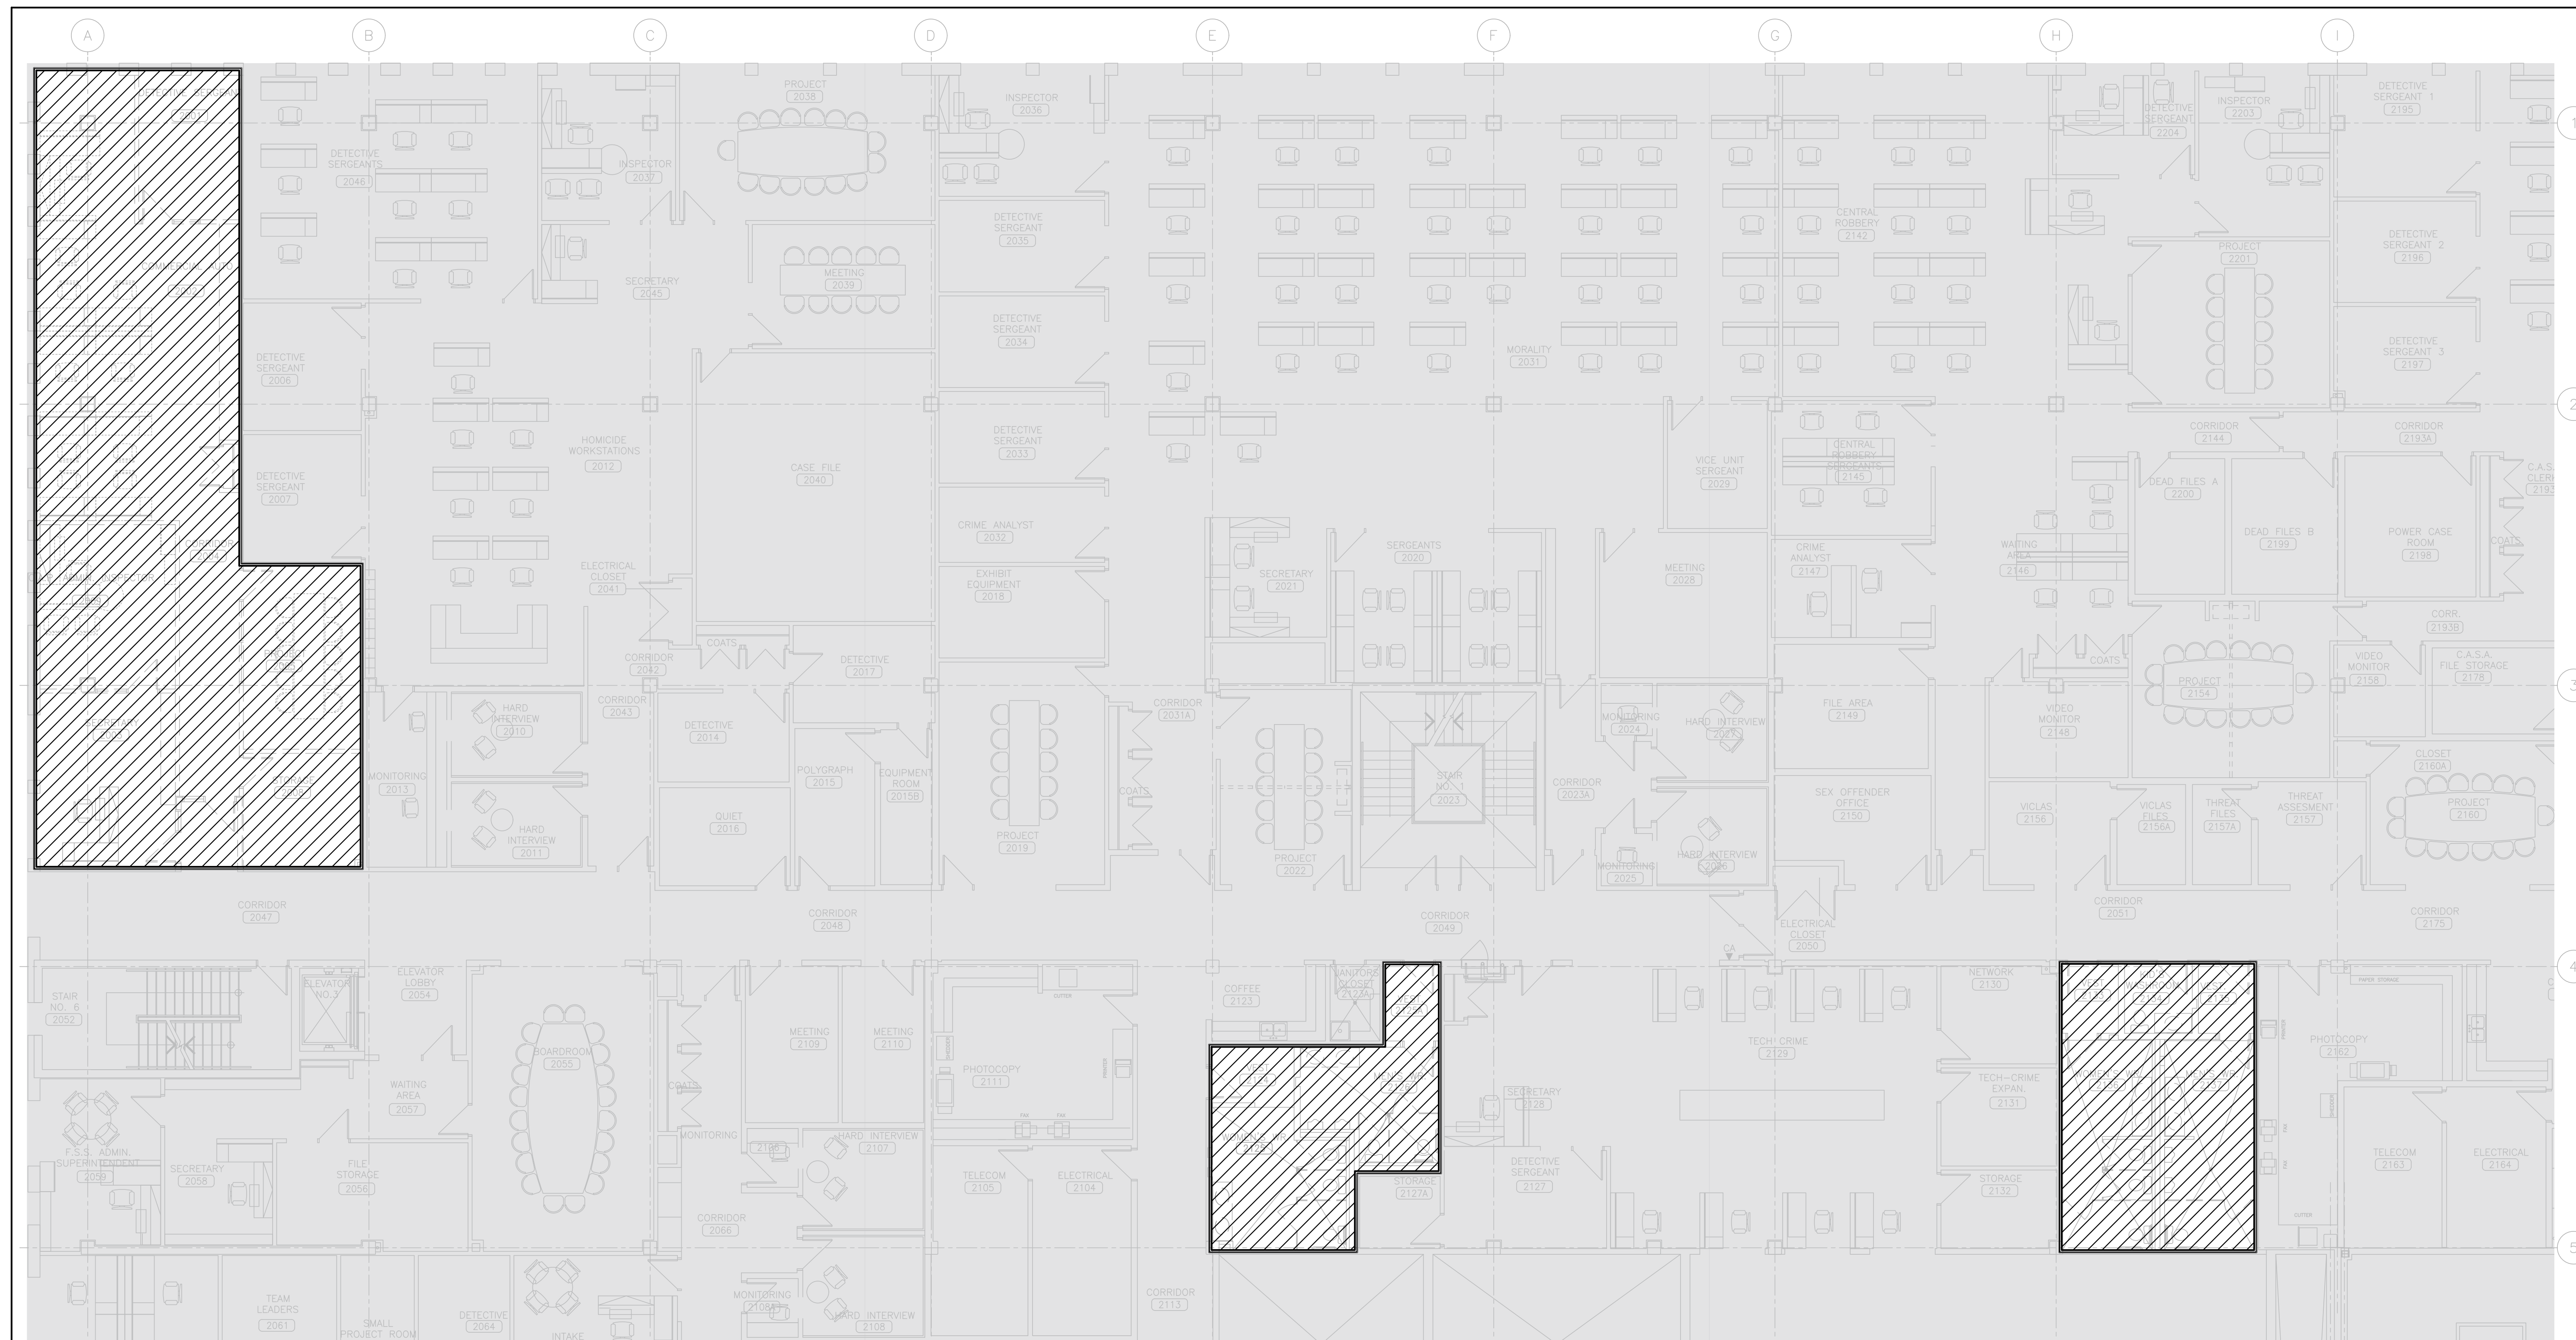


- DEMOLITION LEGEND



1. EXISTING CONSTRUCTION TO REMAIN

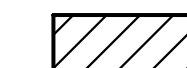

1. UNLESS OTHERWISE NOTED, REMOVE ALL FLOOR, COLUMN, CEILING, AND WALL MOUNTED POWER, WIRING AND CONDUIT NOT REQUIRED BACK TO SOURCE TO SUEE NEW CEILING AND MAKE SAFE.
2. FIRE ALARM DEVICES, INCLUDING BUT NOT LIMITED TO SPEAKERS, STROBES, PULI STATIONS AND SMOKE DETECTORS, SHALL BE REMOVED WITHIN THE SCOPE OF WORK AREA. ENSURE ALL EXISTING FIRE ALARM DEVICES REMAIN AND ARE MAINTAINED AS REQUIRED FOR THE DURING THE CONSTRUCTION PHASE.
3. REMOVE ALL IT, AV, AND SECURITY DEVICES, CABLEING, AND INFRASTRUCTURE WITHIN THE AREA.
4. MAINTAIN ALL EXISTING IT, AV, SECURITY DEVICES AND STORE WITHIN THE ROOM OR PROVIDE TO CLIENT.
5. ALL EXISTING CAT 6 CABLES WILL BE RE-ITERMINATED WITH NEW JACKETS, PATCH CORDS, AND PATCH PANELS MOUNTED TO NEW ISSUES ONLY CONSULTATION WITH THE ARCHITECTS REGARDING NEW LAYOUTS.
6. REMOVE ALL LIGHTING FIXTURES, EXISTING LIGHTING CONDUIT, DEVICES, AND EXITS WITHIN THE SCOPE OF WORK AREA. REMOVE EXISTING WIRING AND CONDUIT BACK TO NEAREST JUNCTION BOX IN CEILING SPACE AND MAKE SAFE. MAINTAIN THE CIRCUIT FOR NEW LIGHTING FIXTURES.

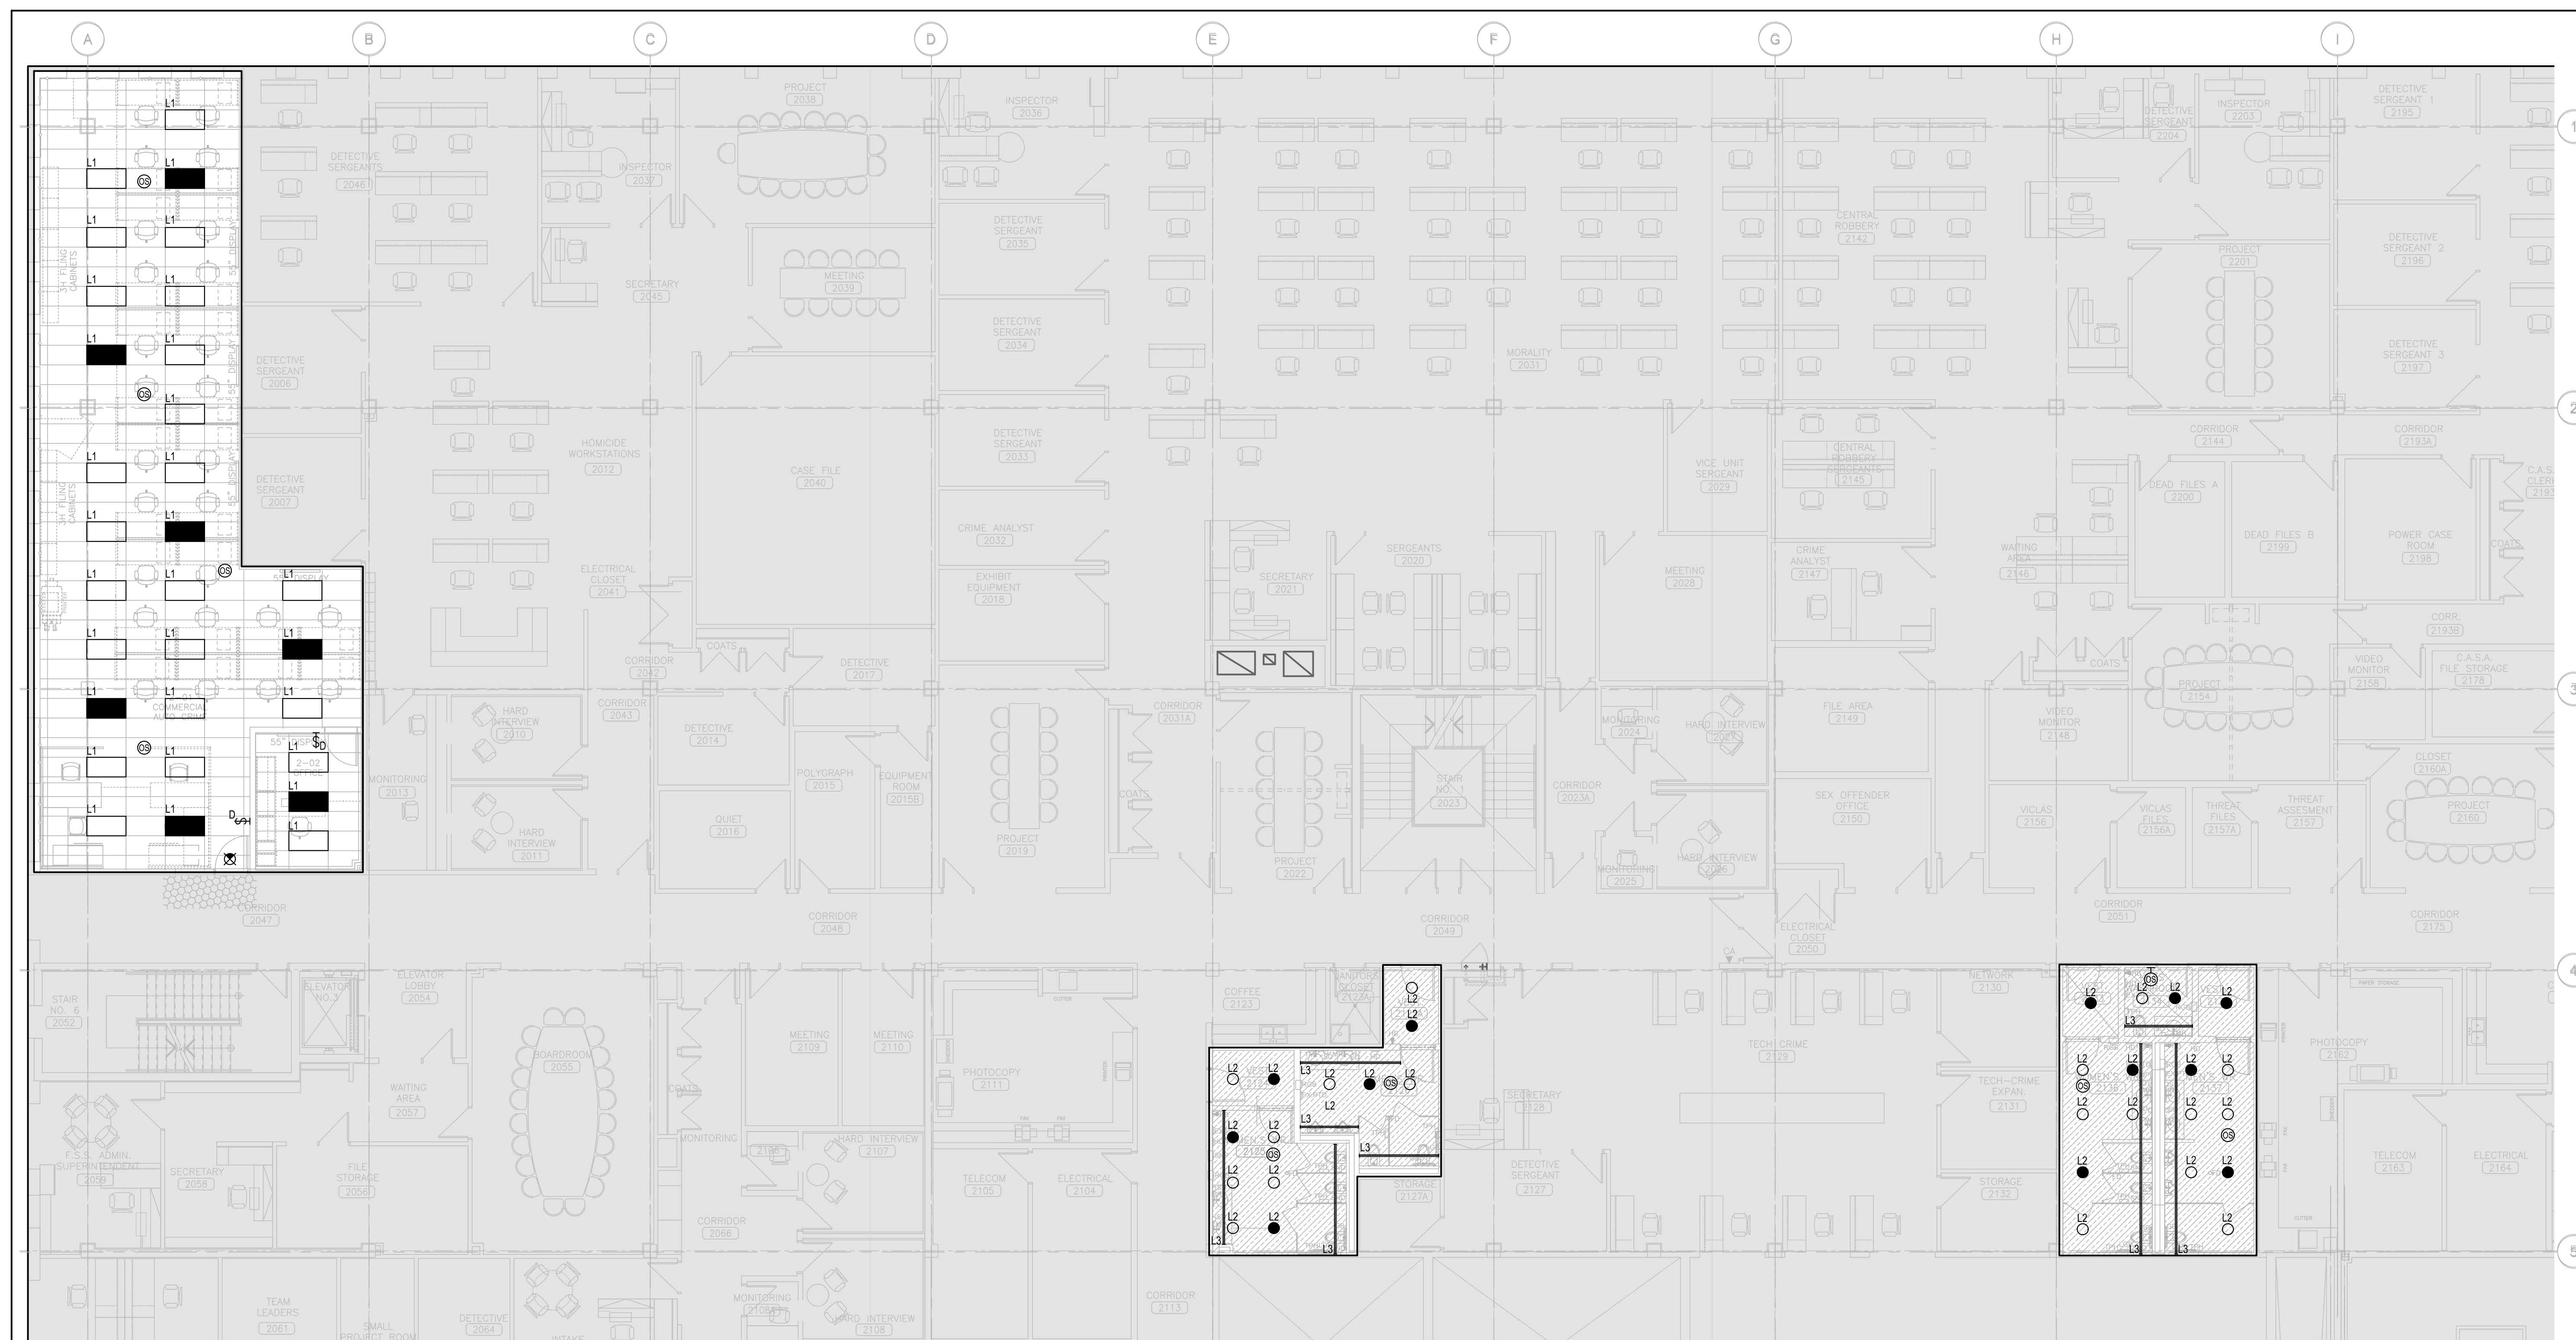

GENERAL NOTES:

1. REUSE EXISTING LIGHTING CIRCUITS FOUND IN CEILING SPACE FOR ALL LIGHTING FIXTURES. DO NOT OVERLOAD CIRCUITS. PROVIDE ADDITIONAL CIRCUITS WHERE REQUIRED.
2. ALL NEW LIGHTING SHALL TIE BACK INTO EXISTING BUILDING LIGHTING CONTROL SYSTEM.
3. LIGHTING FIXTURES IDENTIFIED AS EMERGENCY ARE TO BE CONNECTED SO THAT UNDER NORMAL CONDITIONS THEY WORK IN CONJUNCTION WITH THE SWITCHING AS IDENTIFIED. IN THE EVENT OF AN EMERGENCY, THESE LIGHTS ARE TO BE FORCED ON WITH THE USE OF A UL-924 LATCH RELAY. UPON POWER FAILURE THE RELAY IS TO ACTIVATE THE LIGHTS TO FULL BRIGHTNESS.

[illegible]

5.	ISSUED FOR TENDER	2026.05.01
4.	ISSUED FOR BUILDING PERMIT	2026.04.08
3.	ISSUED FOR 100% CLIENT REVIEW	2026.03.31
2.	ISSUED FOR 66% CLIENT REVIEW	2026.01.09
1.	ISSUED FOR COSTING REVIEW	2025.11.24
NO.	DESCRIPTION	DATE

REVISIONS
PROJECT

PEEL REGIONAL
POLICE

REGION OF PEELEMIL V. KOLB CENTREPEEL REGIONAL POLICE FACILITY
INTERIOR RENOVATION PROJECT

180 DERRY ROAD EAST, MISSISSAUGA, ON L5T 2Y5

— 100 —

Downloaded from <http://ajph.org/> at University of California, San Francisco on June 11, 2015

The contractor shall check and verify all dimensions and report all errors and corrections to the architect and the client.

NCA

ARCHITECTS

[illegible]

	ISSUED FOR CONSTRUCTION	DATE
NORTH	STRUCTURAL CONSULTANT	



Stephenson Engineering
MECHANICAL CONSULTANT

EXP Services Inc.
ELECTRICAL CONSULTANT

	EXP Services Inc.
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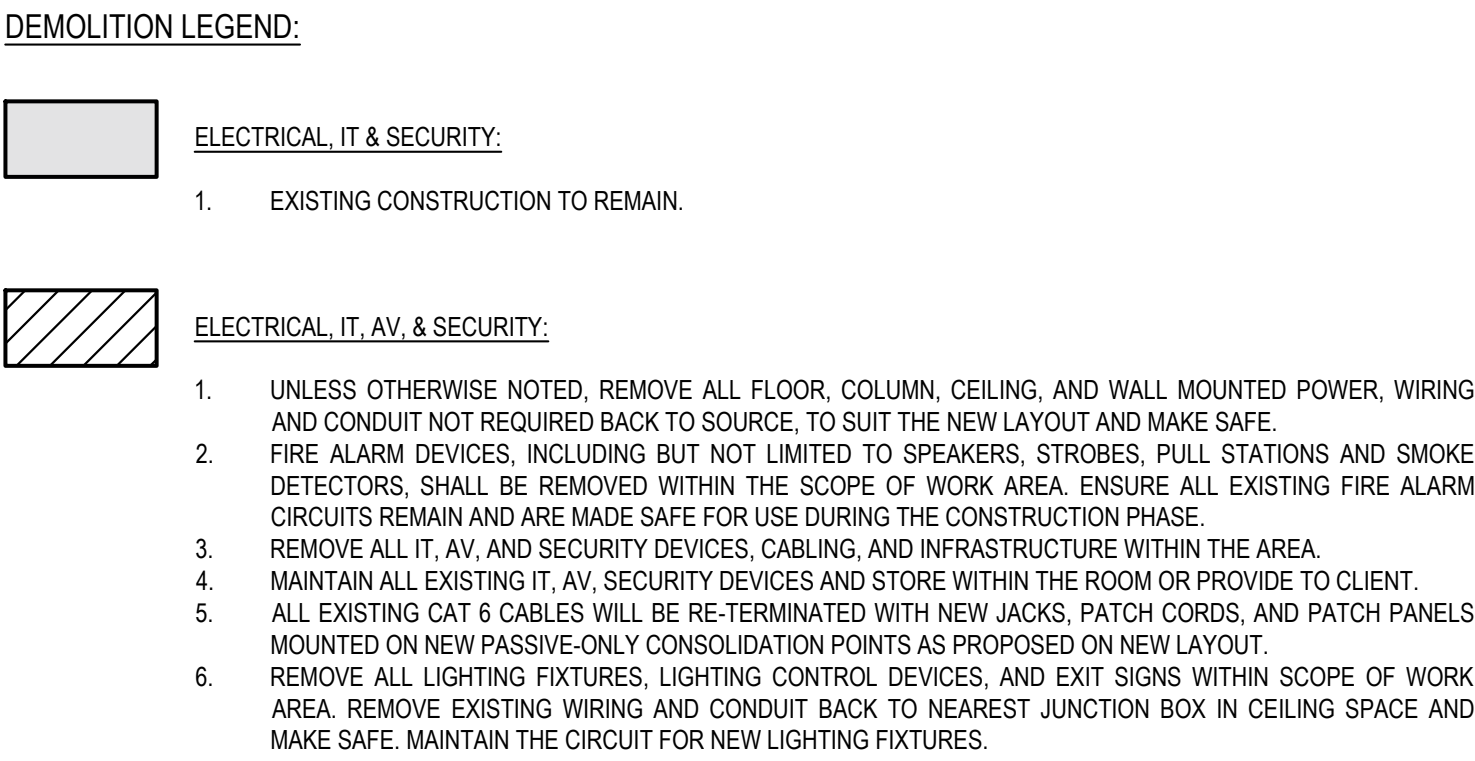
SHEET TITLE
PARTIAL SECOND FLOOR -

POWER AND SYSTEMS -DEMO & NEW


SHEET NO.	DRAWN BY SS/L	CHECKED KE
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F103	PROJECT NO.
	MRK-25008951-A0

E 100	SCALE
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1 PARTIAL THIRD FLOOR LIGHTING PLAN - DEMO
E204 SCALE: 1/8" = 1'-0"



2 PARTIAL THIRD FLOOR LIGHTING PLAN - NEW
E204 SCALE: 1:100

[illegible]

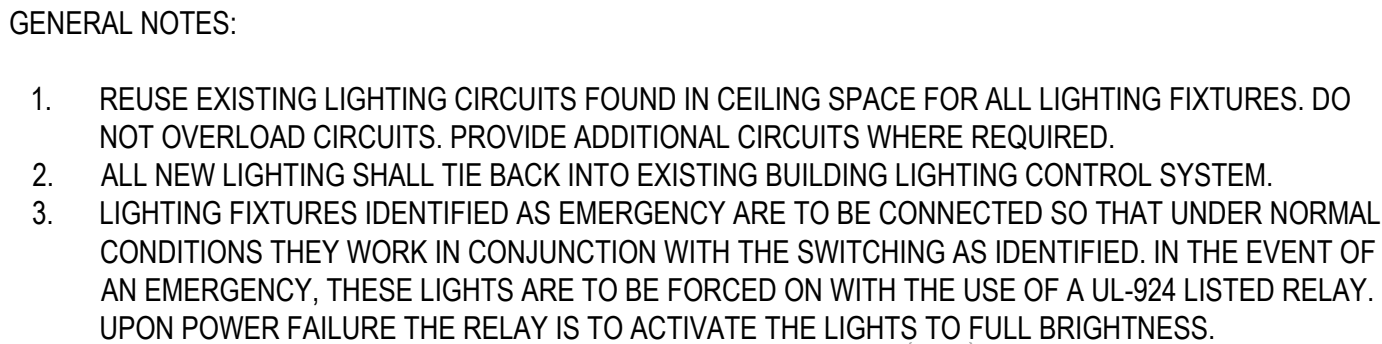5.	ISSUED FOR TENDER	2026.05.01
4.	ISSUED FOR BUILDING PERMIT	2026.04.08
3.	ISSUED FOR 100% CLIENT REVIEW	2026.03.31
2.	ISSUED FOR 66% CLIENT REVIEW	2026.01.09
1.	ISSUED FOR COSTING REVIEW	2025.11.24
NO.	DESCRIPTION	DATE

REVISIONS

PROJECT



REGION OF PEEL

EMIL V. KOLB CENTRE
PEEL REGIONAL POLICE FACILITY
INTERIOR RENOVATION PROJECT
180 DERRY ROAD EAST, MISSISSAUGA, ON L5T 2Y5



This drawing shall not be used for construction purposes until issued for construction by the design professional whose seal is affixed to this drawing and whose signature is below.

NORTH




	EXP Services Inc.
SHEET TITLE	

PARTIAL THIRD FLOOR -
LIGHTING - DEMO & NEW

SHEET NO. E204	DRAWN BY SS/LL	CHECKED KE
	PROJECT NO. MRK-25008951-A0	
	SCALE	

LUMINAIRE SCHEDULE						
TYPE	BASE MANUFACTURER	DESCRIPTION	LUMEN	COLOUR TEMP	VOLTAGE	WATTS
L1	VISIONEERING	2x4' RECESSED LIGHT FIXTURE	4000	3500	120	28
L2	LIGHTOLIER - SIGNIFY	6" SQUARE DOWNLIGHT (WET RATED)	2800	3500	120	28
L3	OPTIC ARTS - LUMINII	COVE LIGHTING	200FT	3500	120	2.5FT
L4	AXIS LIGHTING	4" RECESSED LINEAR	1000FT	3500	120	9.5WFT
L5	LIGHTOLIER - SIGNIFY	6" SQUARE DOWNLIGHT	2800	3500	120	28
L6	VISIONEERING	2x2' RECESSED LIGHT FIXTURE	2000	3500	120	13
L7	ELITE	CABINET LIGHTING	120FT	3500	120	1.5FT
L8	CAMDEN DOOR CONTROLS	LED DOME LIGHT			24	0.1
X1	LUMACELL	UNIVERSAL MOUNT EXIT SIGN			120	2.5
						LA-3-1H-J
NOTES: 1. ALL FINISHES, FLANGE, AND PLASTER COLOURS SHALL BE CONFIRMED WITH THE ARCHITECT PRIOR TO ORDERING LUMINAIRES. 2. ALL LUMINAIRES SHALL BE CSA APPROVED. 3. CONTRACTOR SHALL PROVIDE MOUNTING ACCESSORIES AND HARDWARE TO SUIT CEILING AND WALL FINISHES. 4. PROVIDE PROPOSED EQUAL FIXTURES FOR CONSULTANTS' AND CLIENTS' APPROVAL DURING TENDER. PROVIDE INFORMATION OF PROPOSED APPROVED EQUAL LIGHT FIXTURES INCLUDING BUT NOT LIMITED TO LIGHT FIXTURE OUTPUTS, PHOTOASTINGS, AND RECENT REFERENCE PROJECTS. 5. PROVIDE ACCESSORIES INCLUDING DRIVERS AND STEP-DOWN TRANSFORMERS AS REQUIRED TO MAKE A WORKING SYSTEM.						

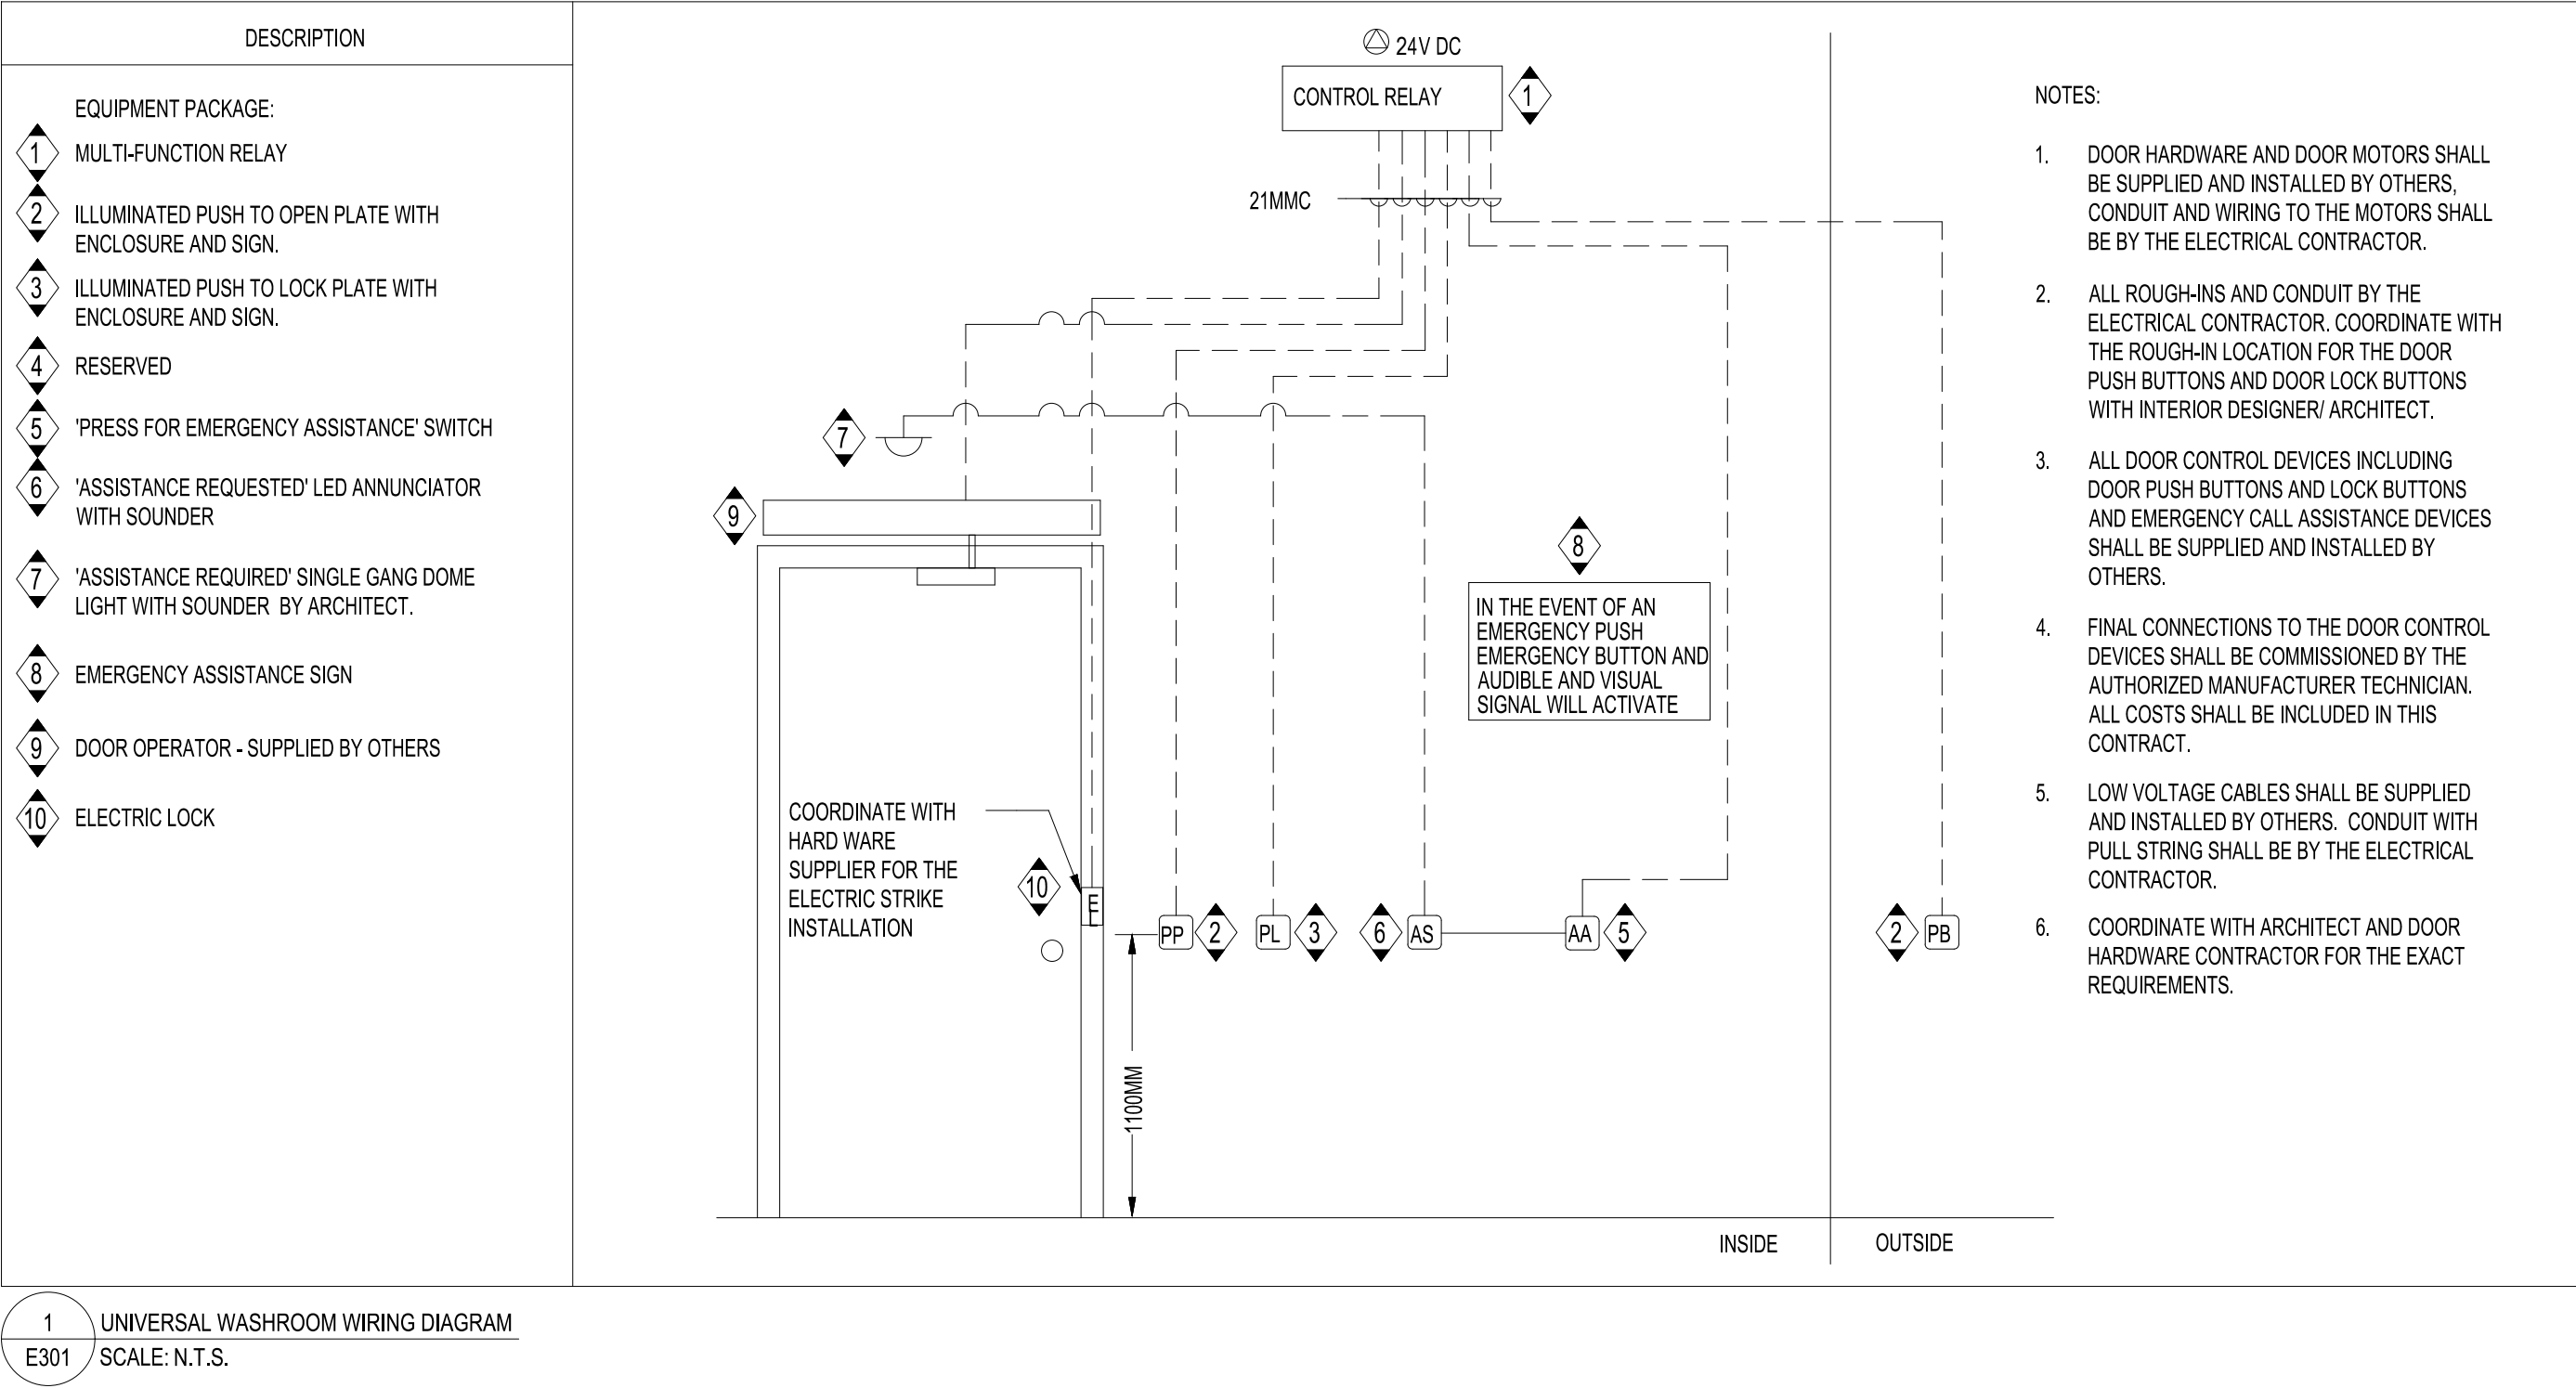

5 WIRELESS ACCESS POINT SUSPENDED CEILING MOUNT DETAIL
E311 NTS

6 CEILING MOUNTED FIXED CAMERA DETAIL
E311 NTS

7 CAMERA WALL MOUNTED DETAIL


1 COMMUNICATIONS RISER DIAGRAM

4 STANDARD MODULAR FURNITURE DATA OUTLET


3 STANDARD SINGLE GANG DATA OUTLET

2 EIA/ TIA T568A WIRING SCHEME DETAIL
E311 NTS


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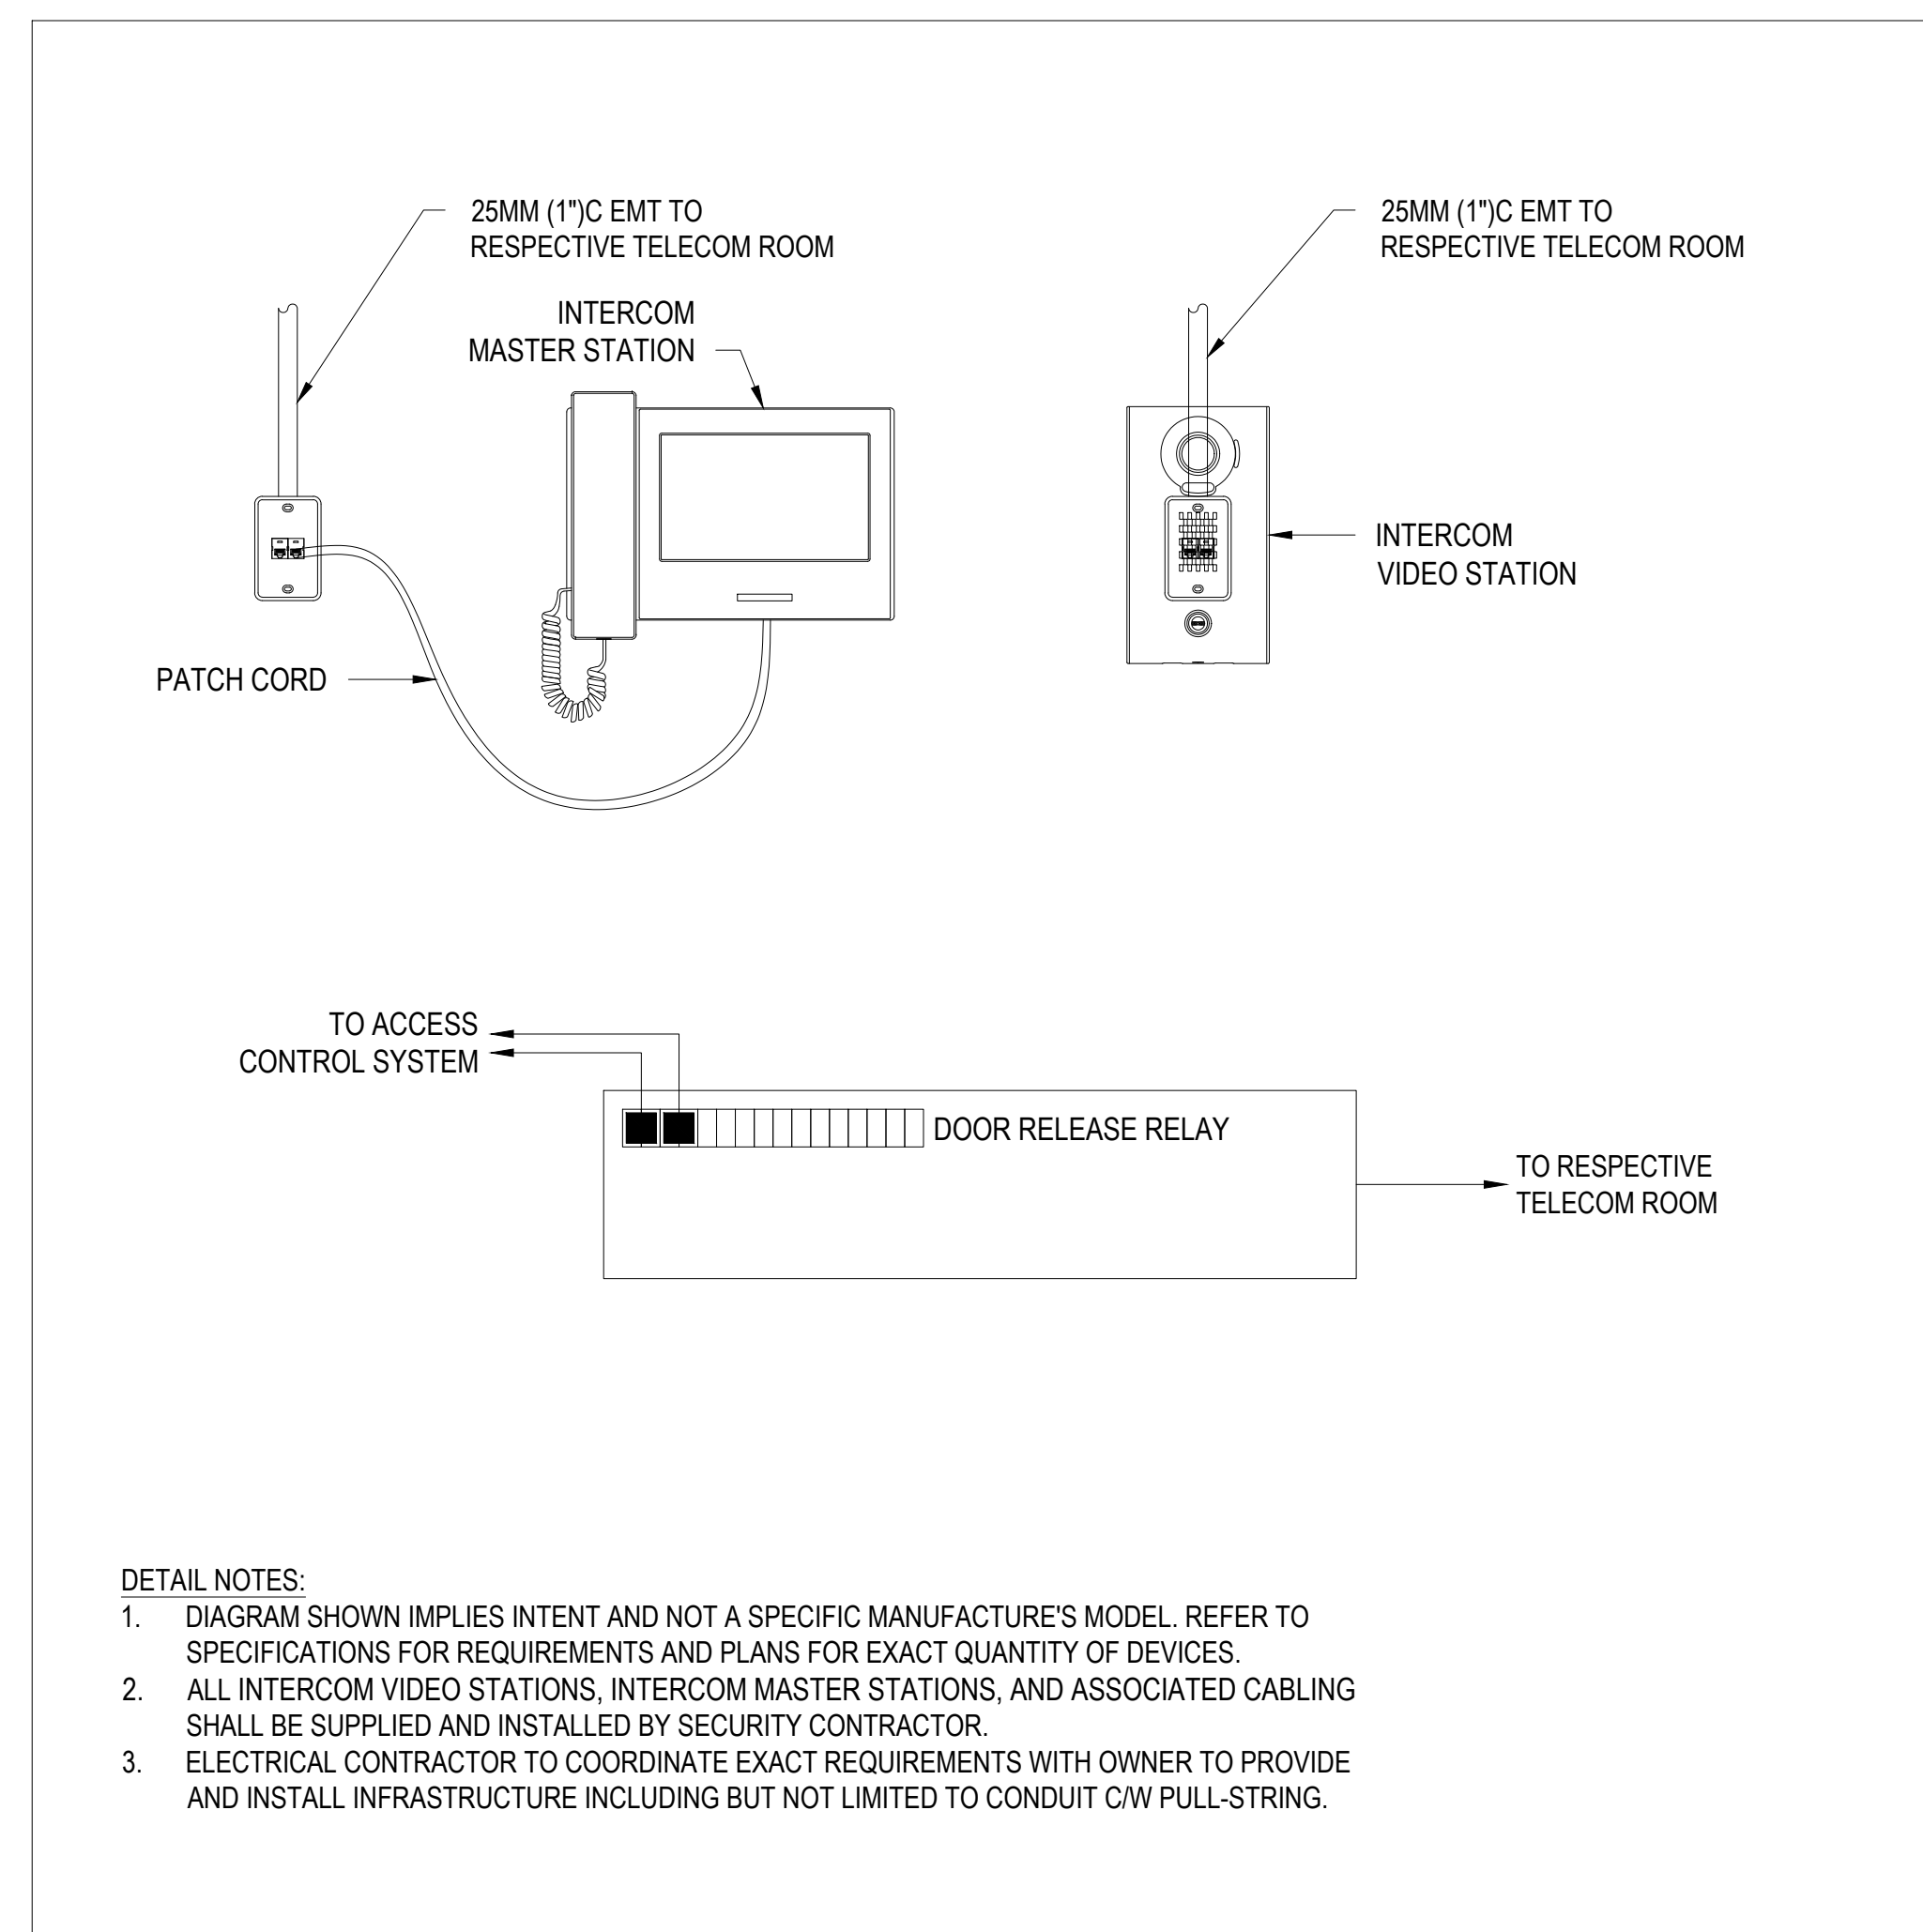
9 AV RISER DIAGRAM - INPUT ON DISPLAY WALL
E312 NTS

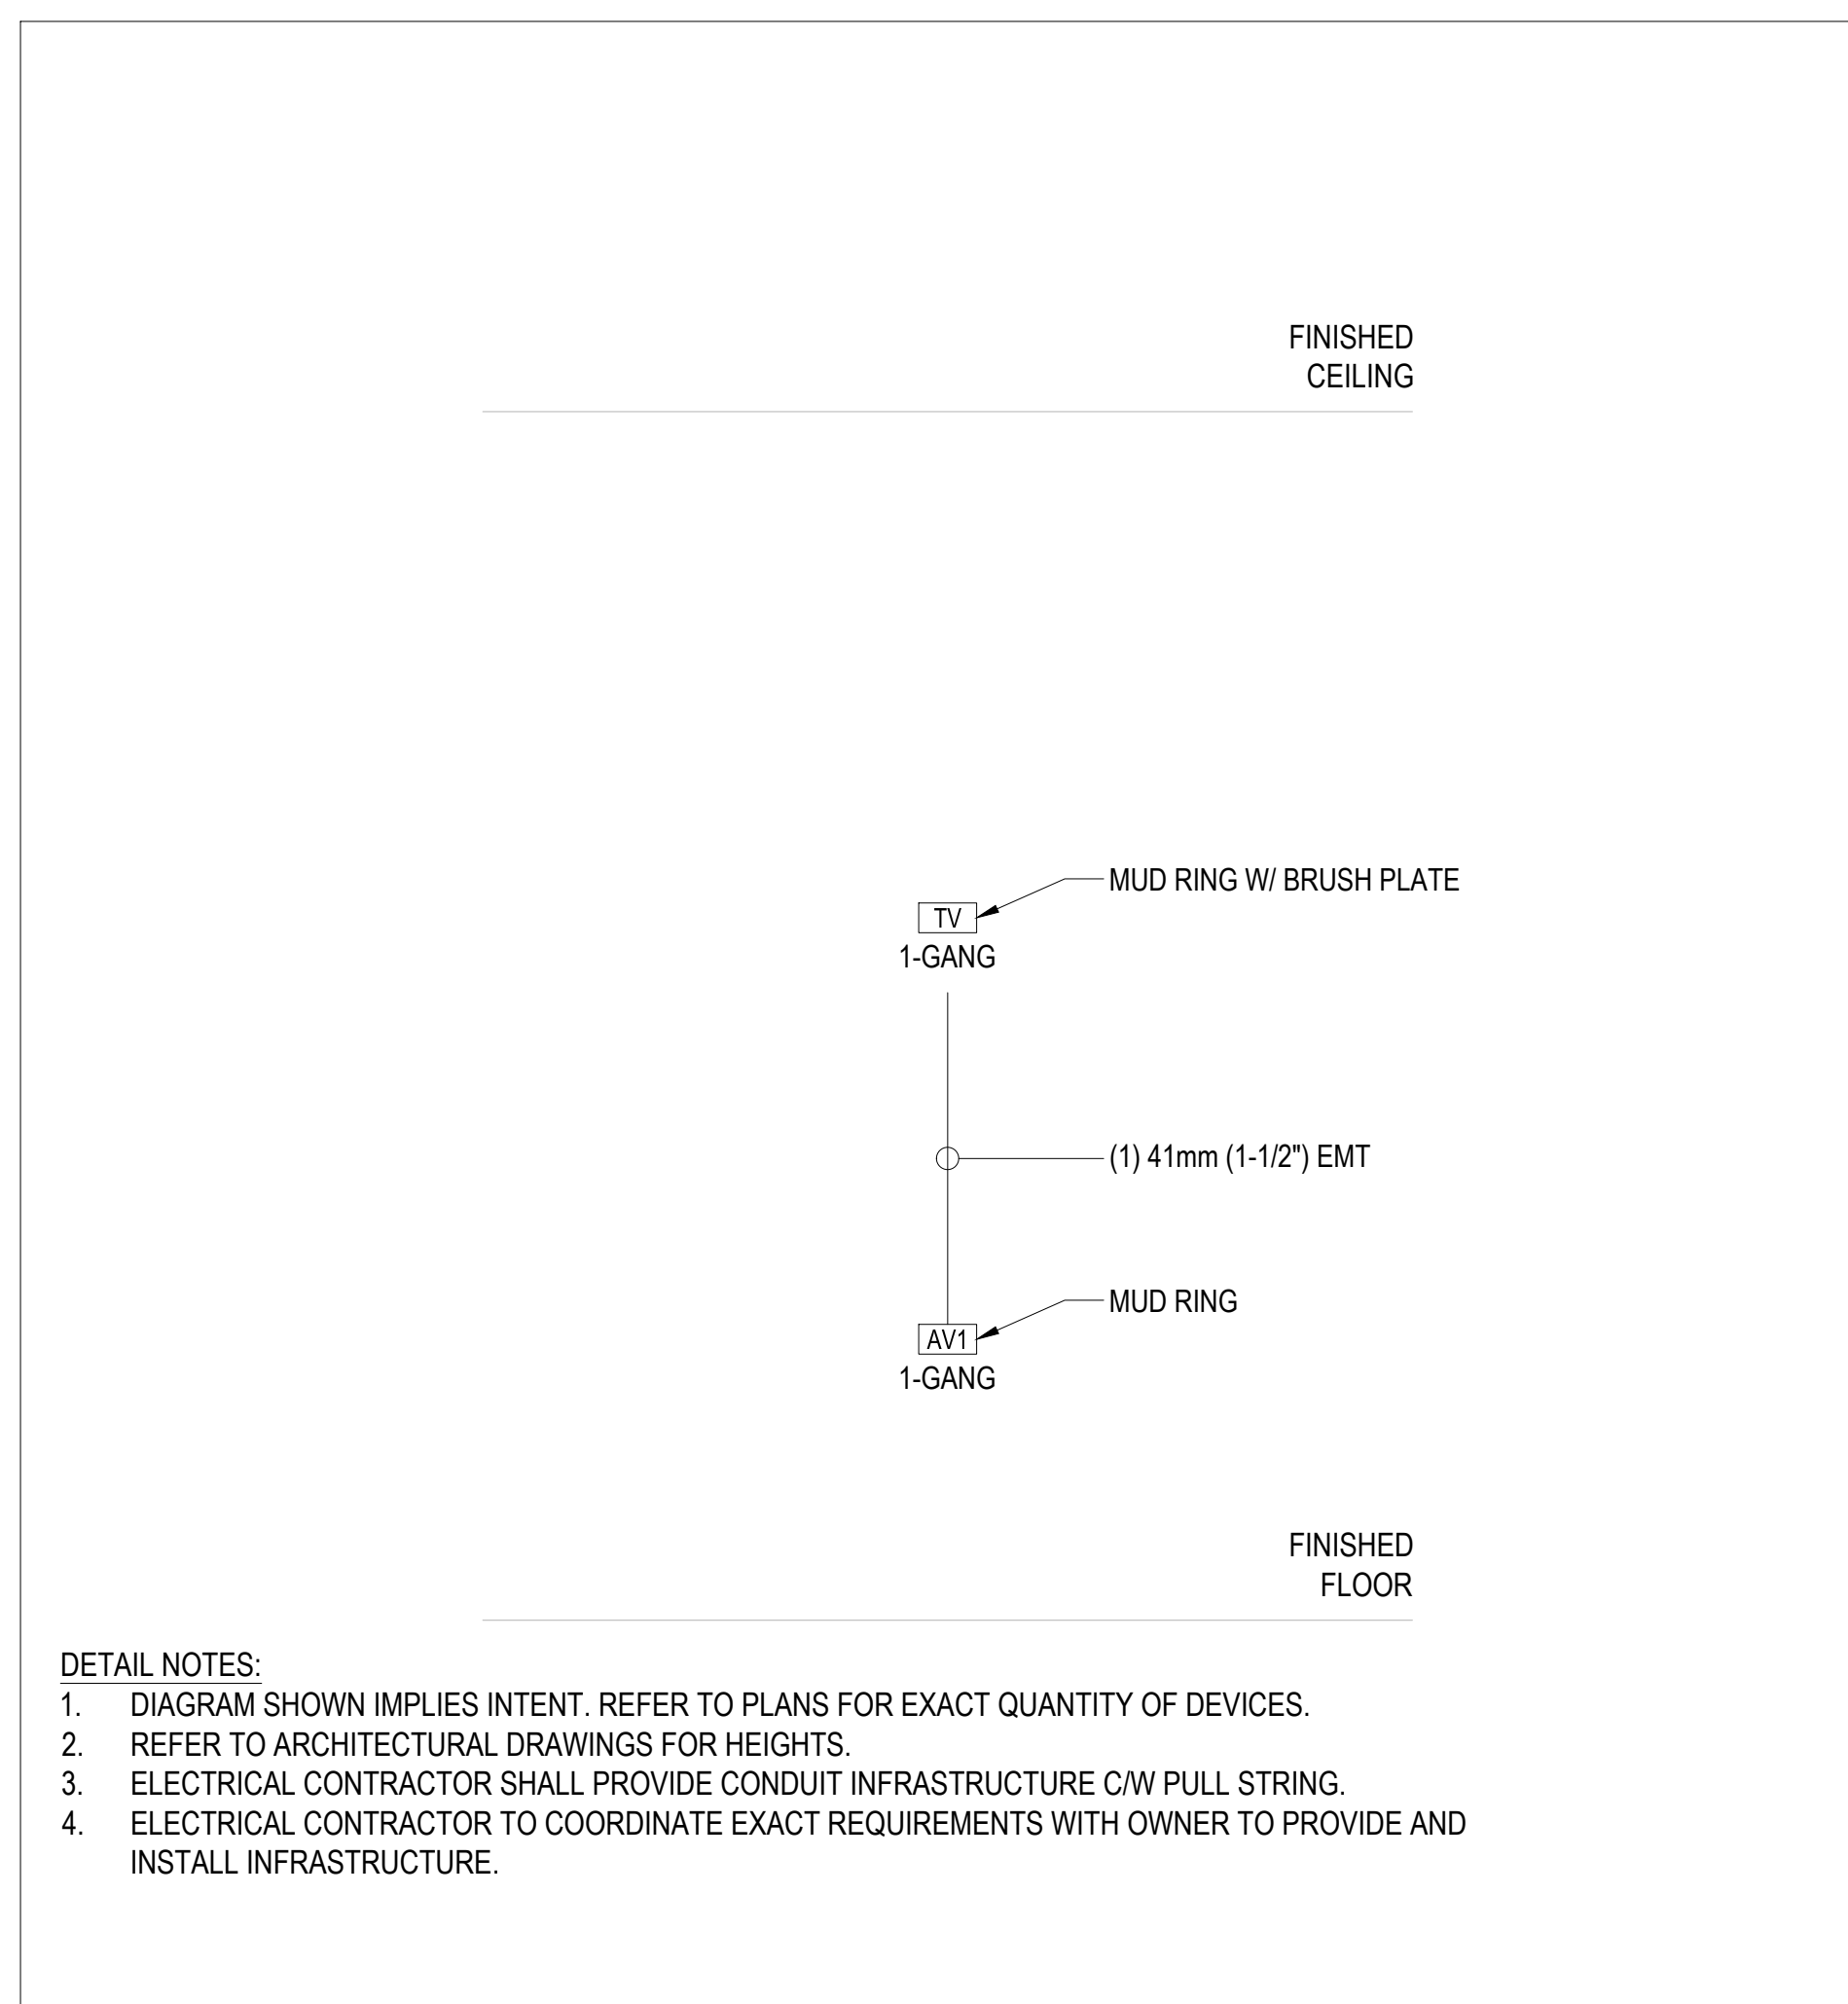


7 SINGLE ACCESS CONTROL DOOR WITH ELECTRIFIED LOCK DETAIL
E312 NTS

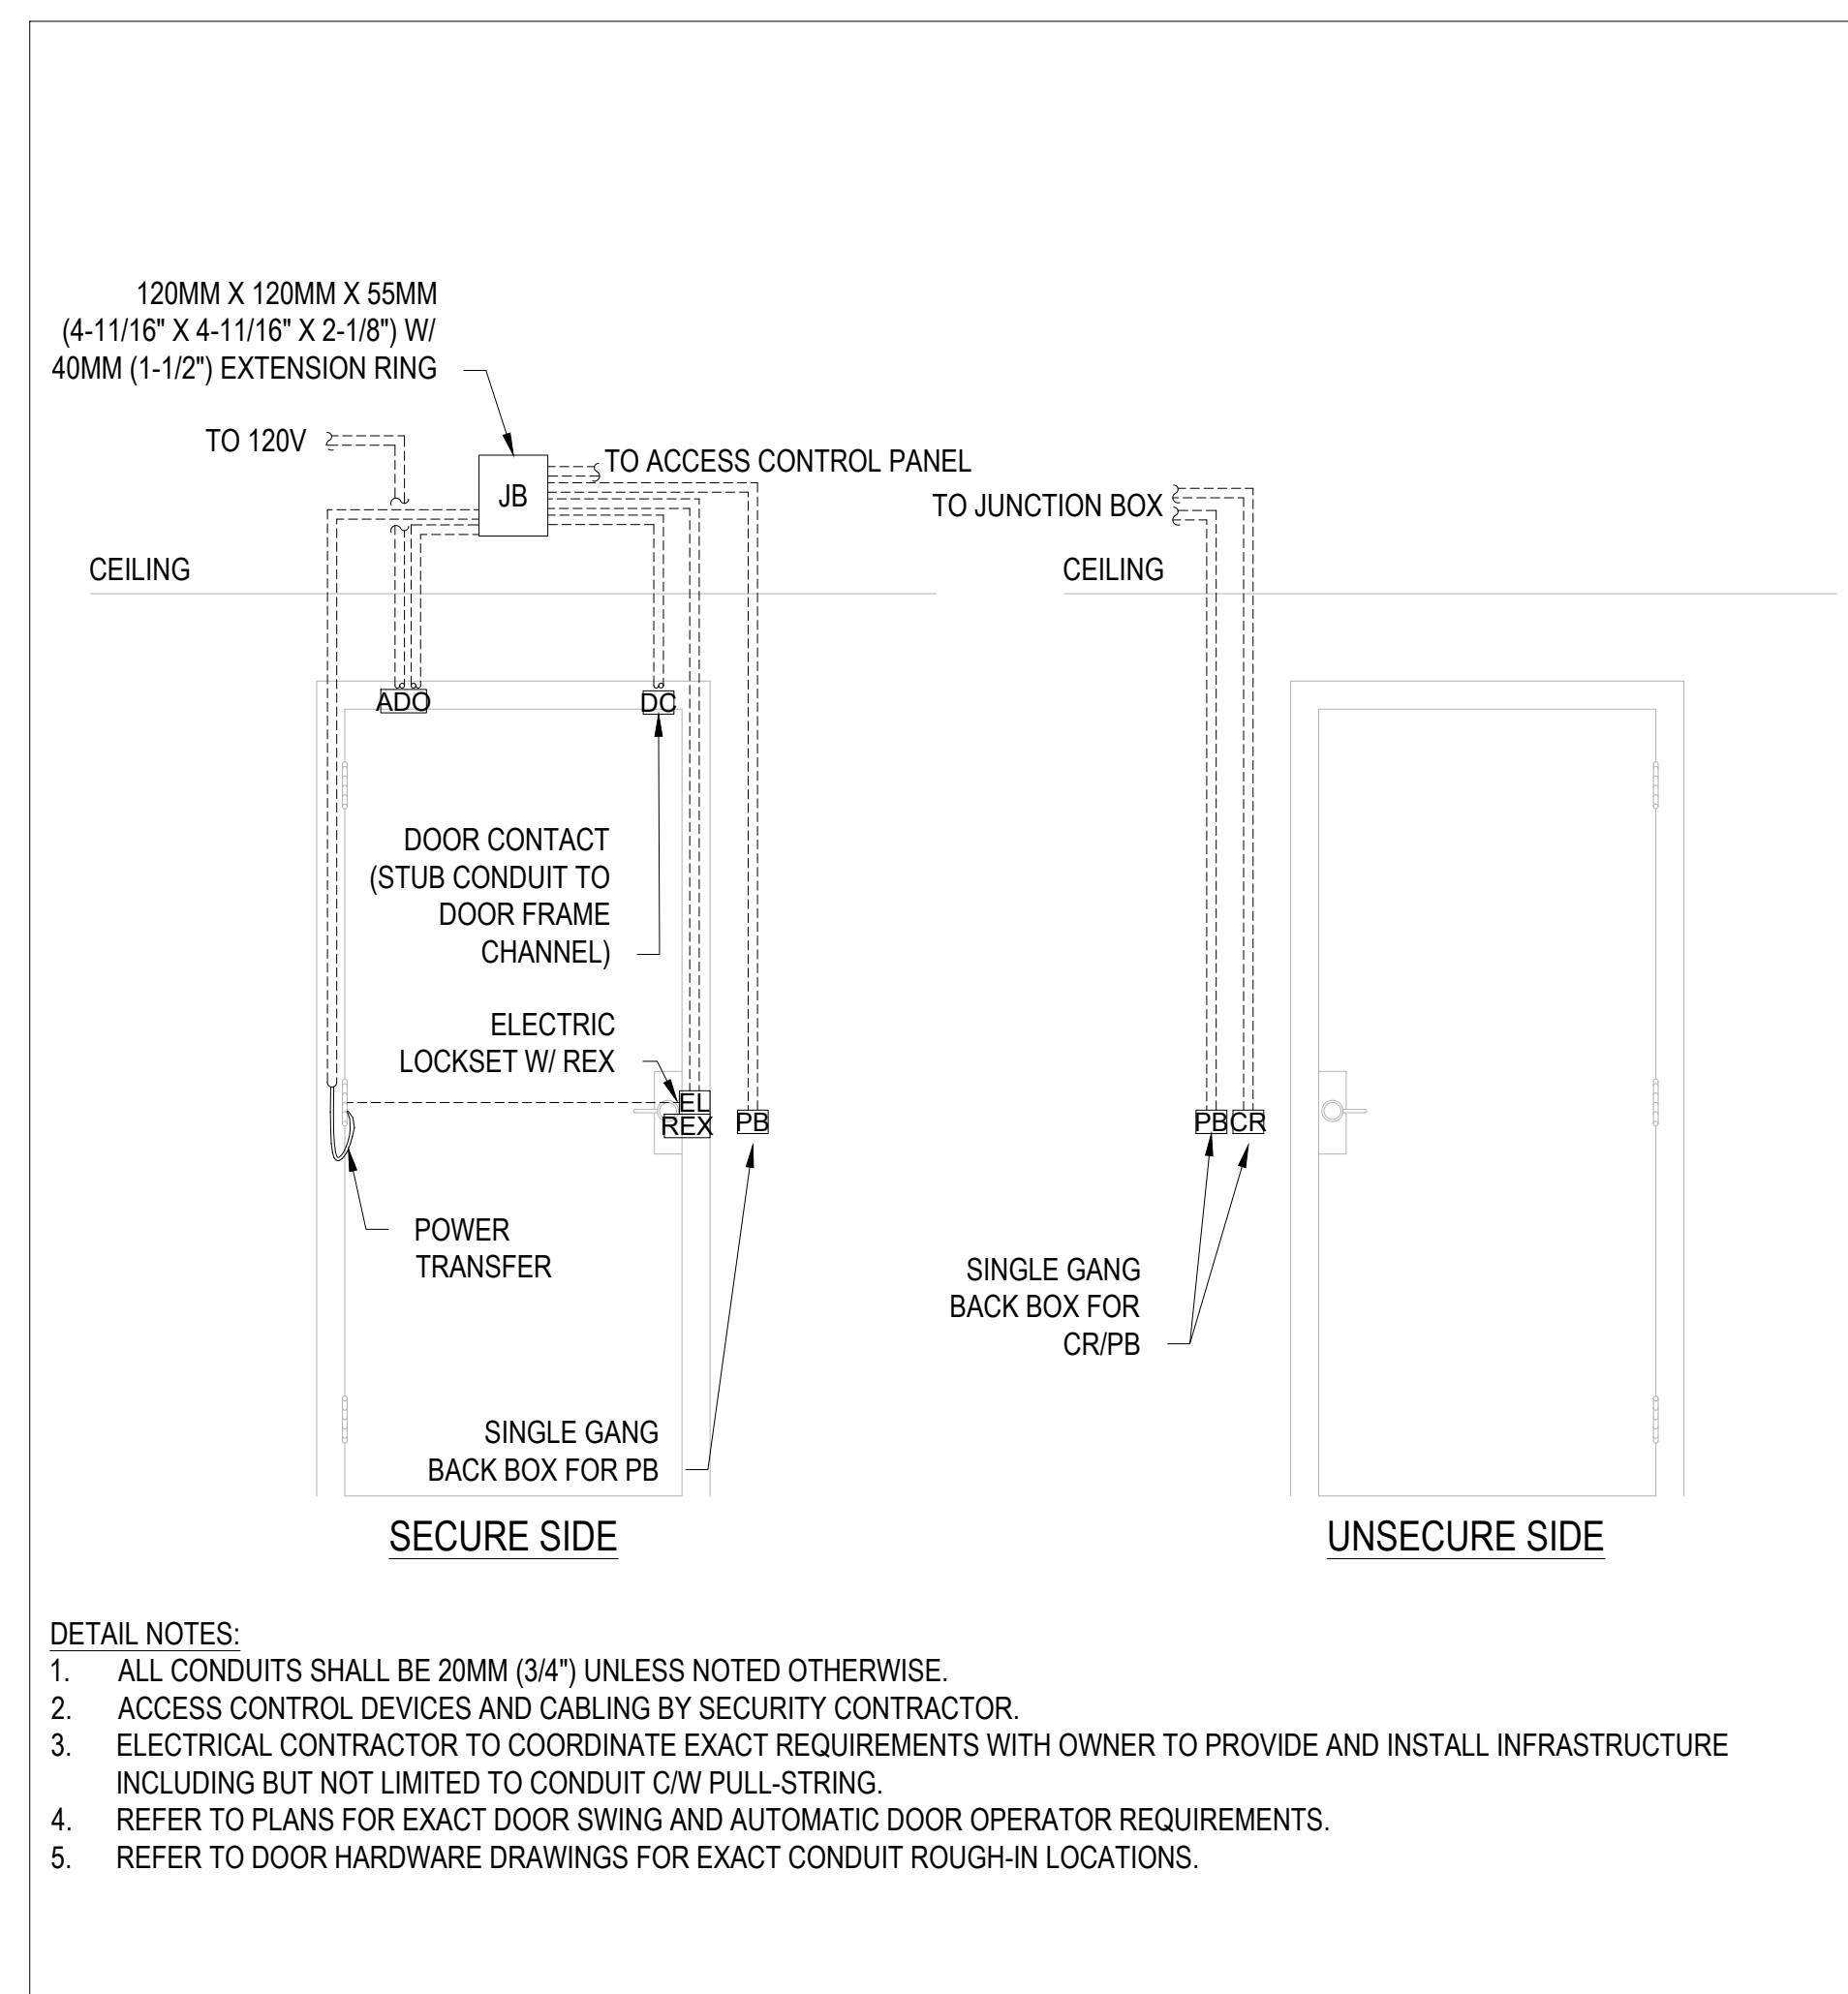


4 DURESS BUTTON DETAIL
E312 NTS

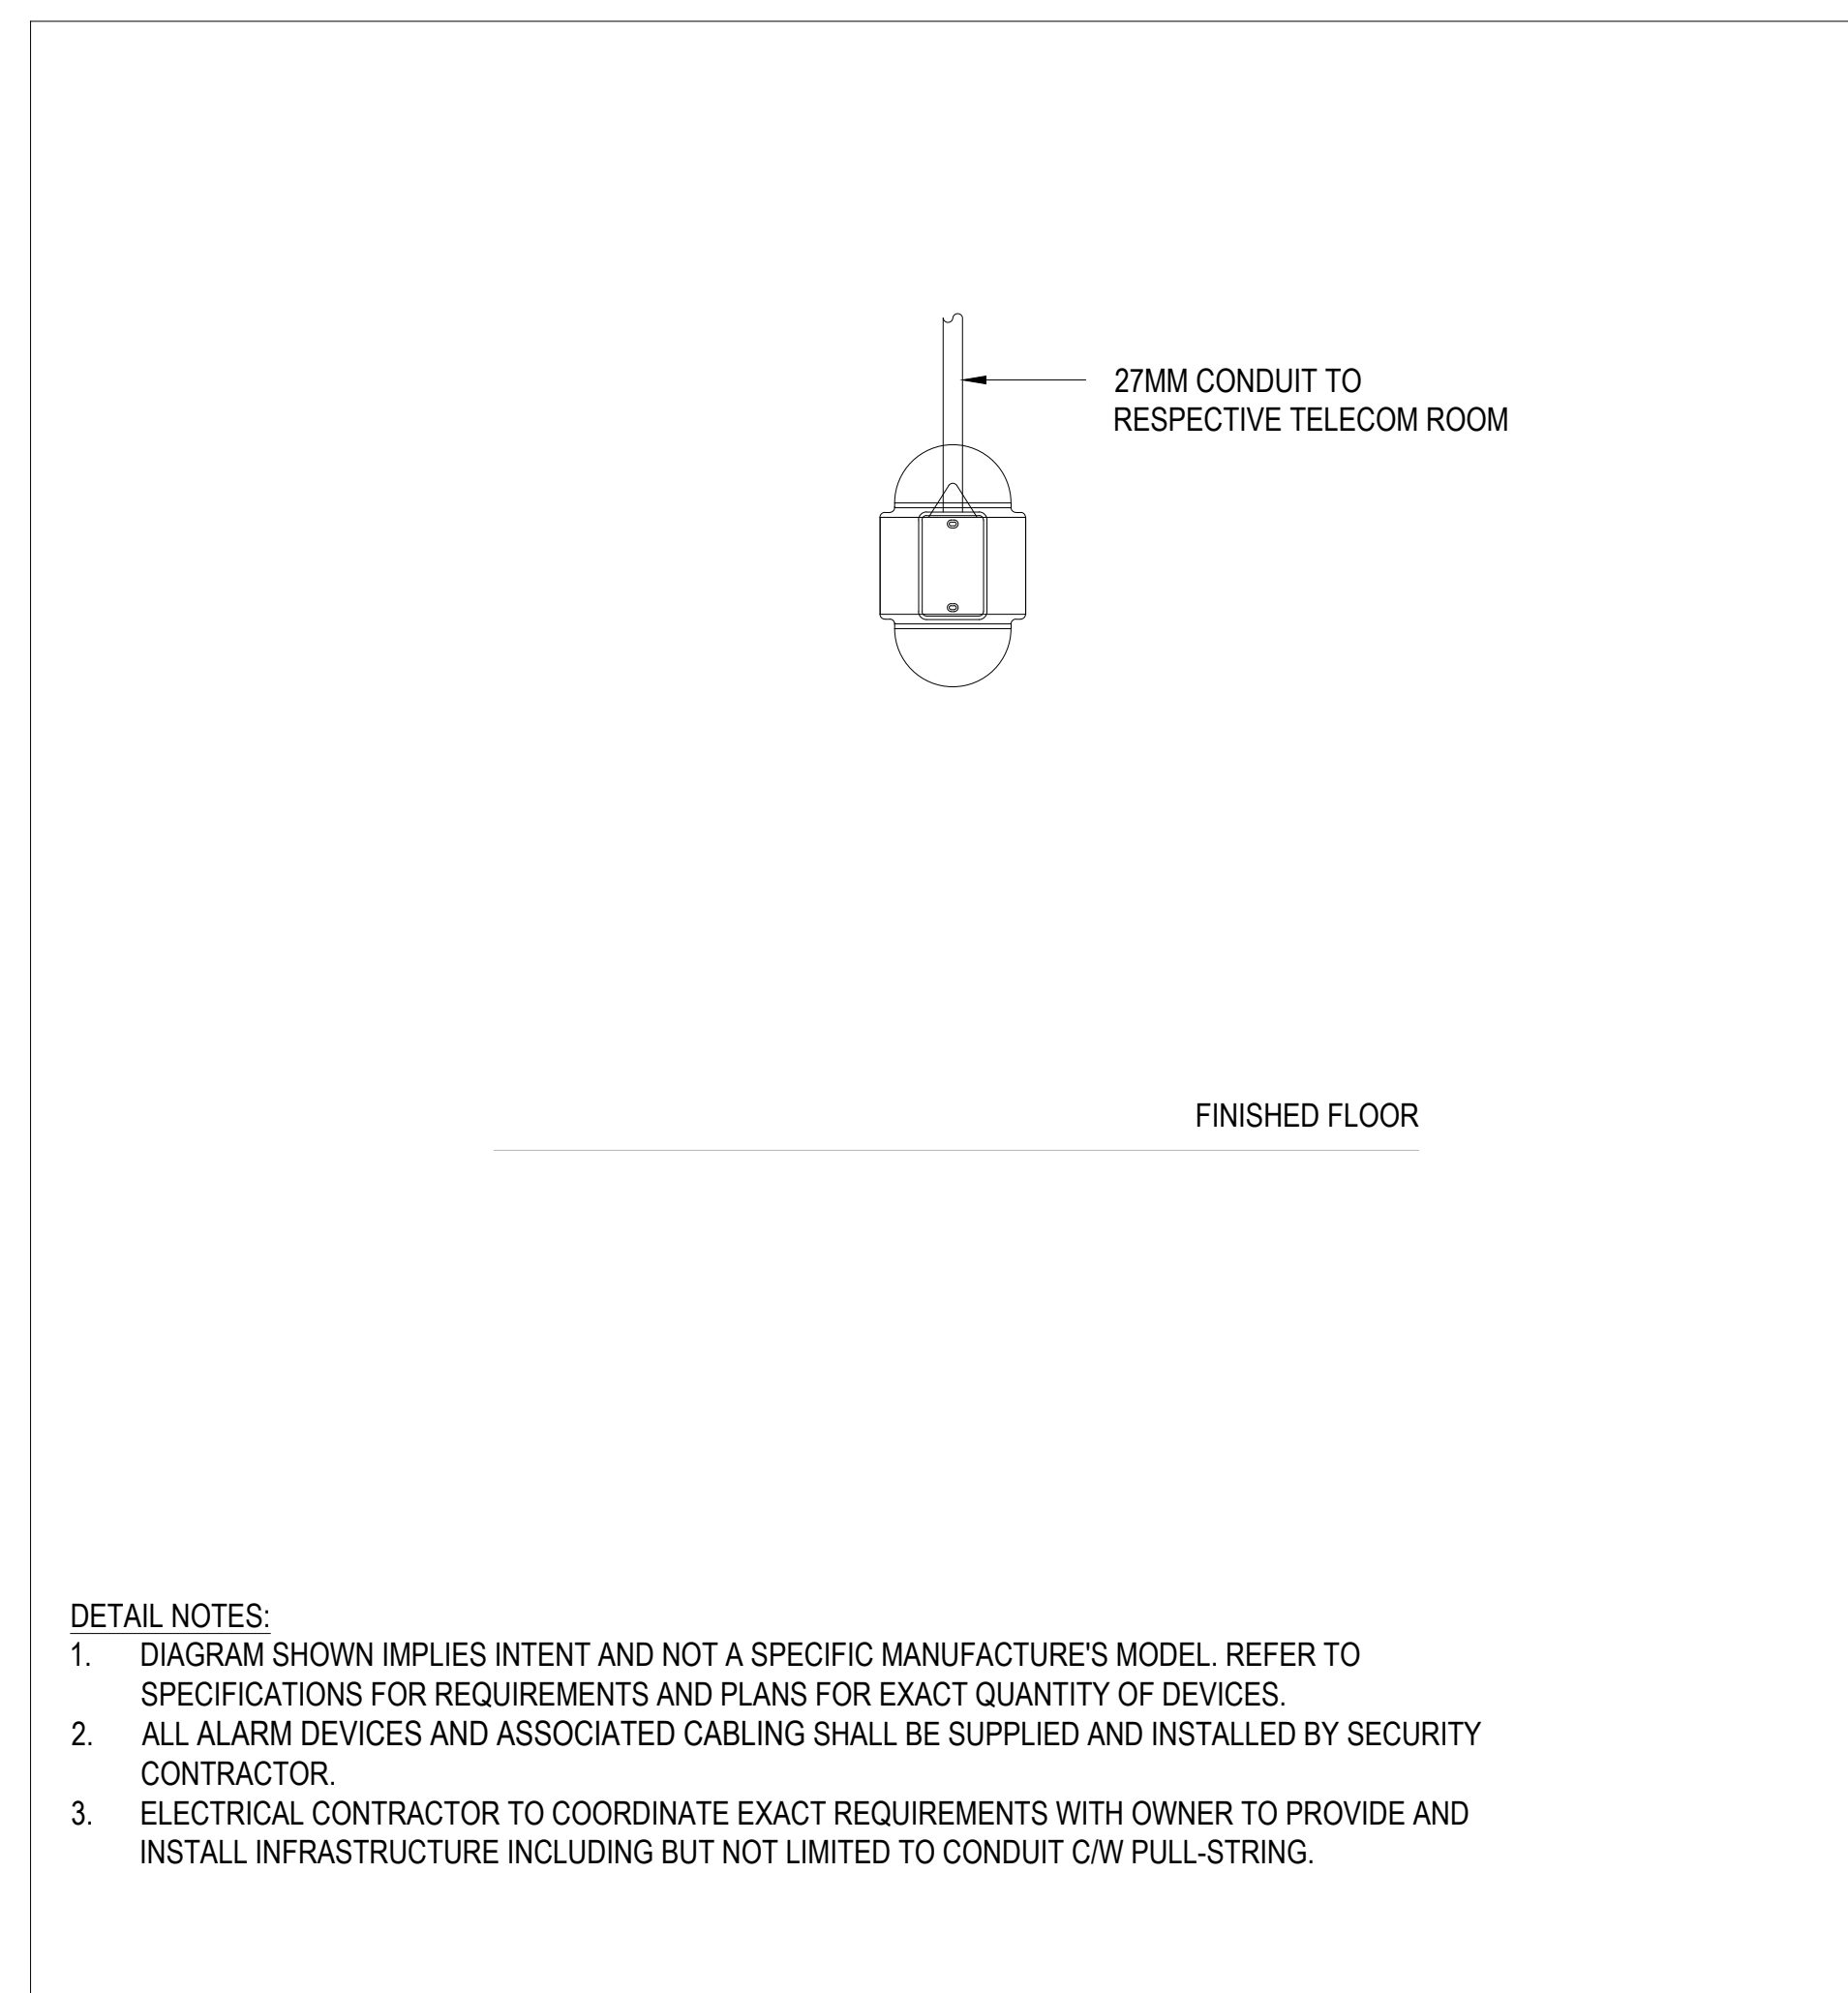


1 INTERCOM VIDEO/MASTER STATION DETAIL

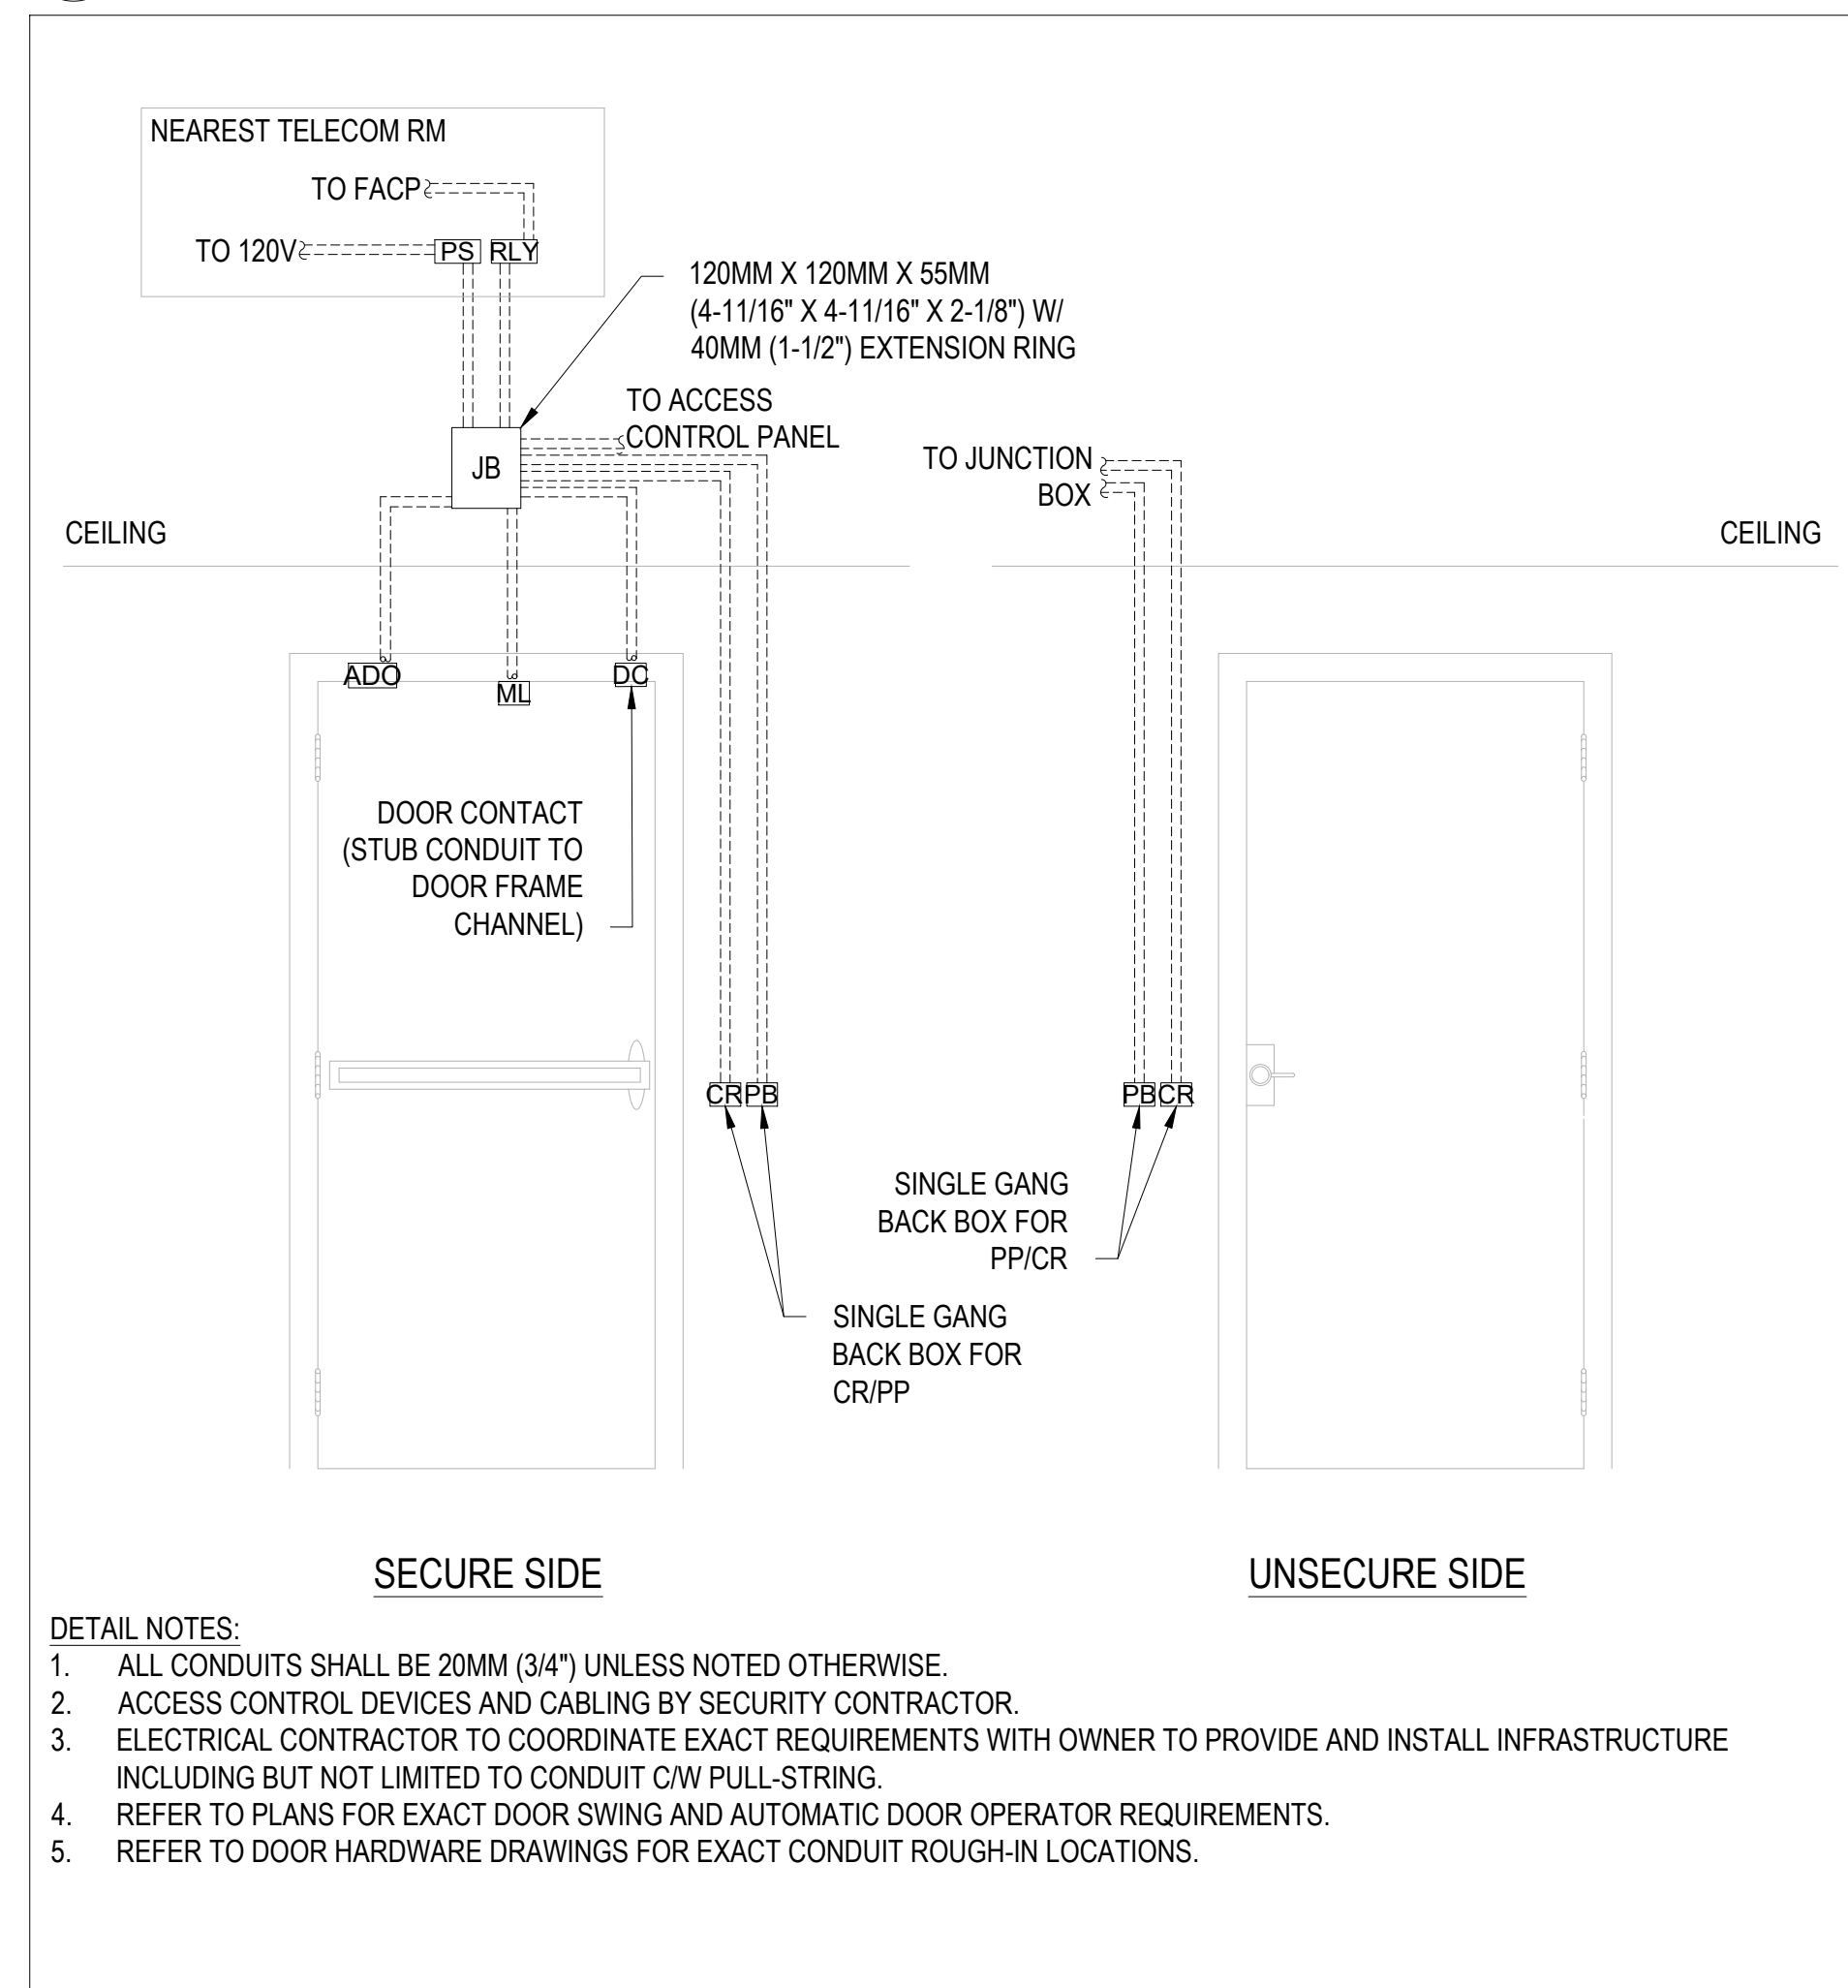


8 SINGLE DOOR WITH DOOR CONTACT AND ALARM DETAIL
E312 NTS

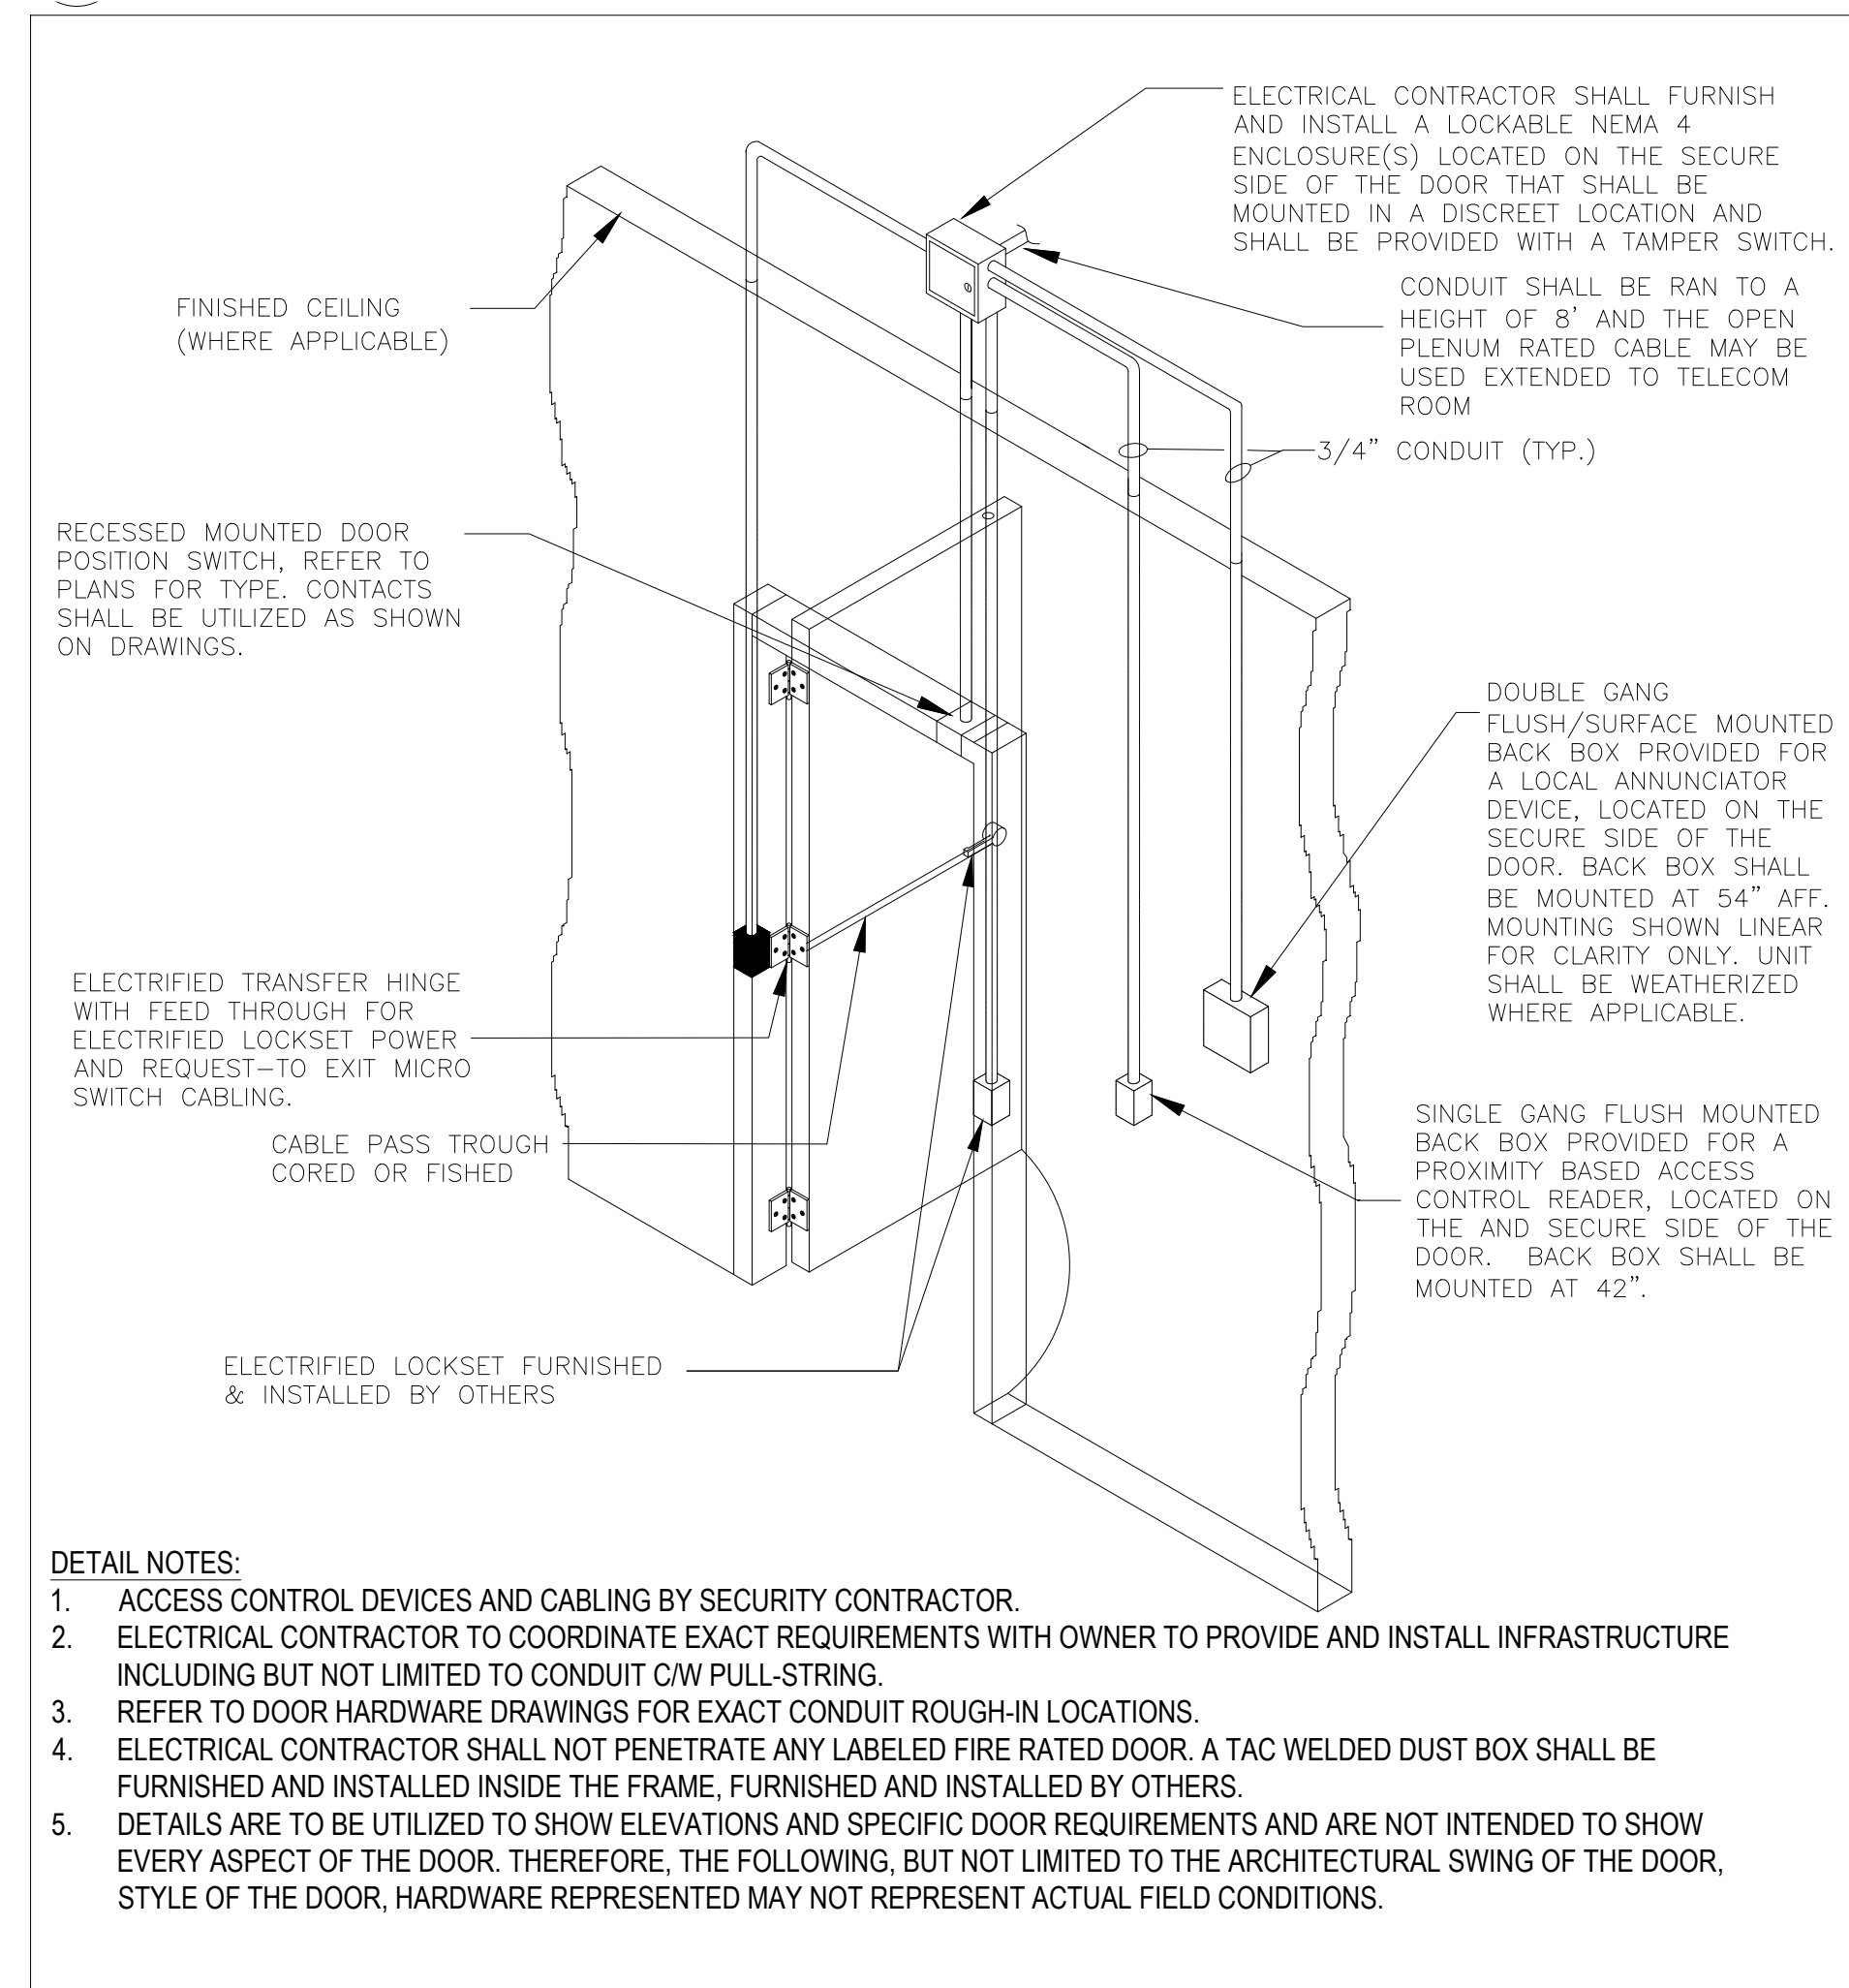


5 SINGLE ACCESS CONTROL DOOR DETAIL
E312 NTS

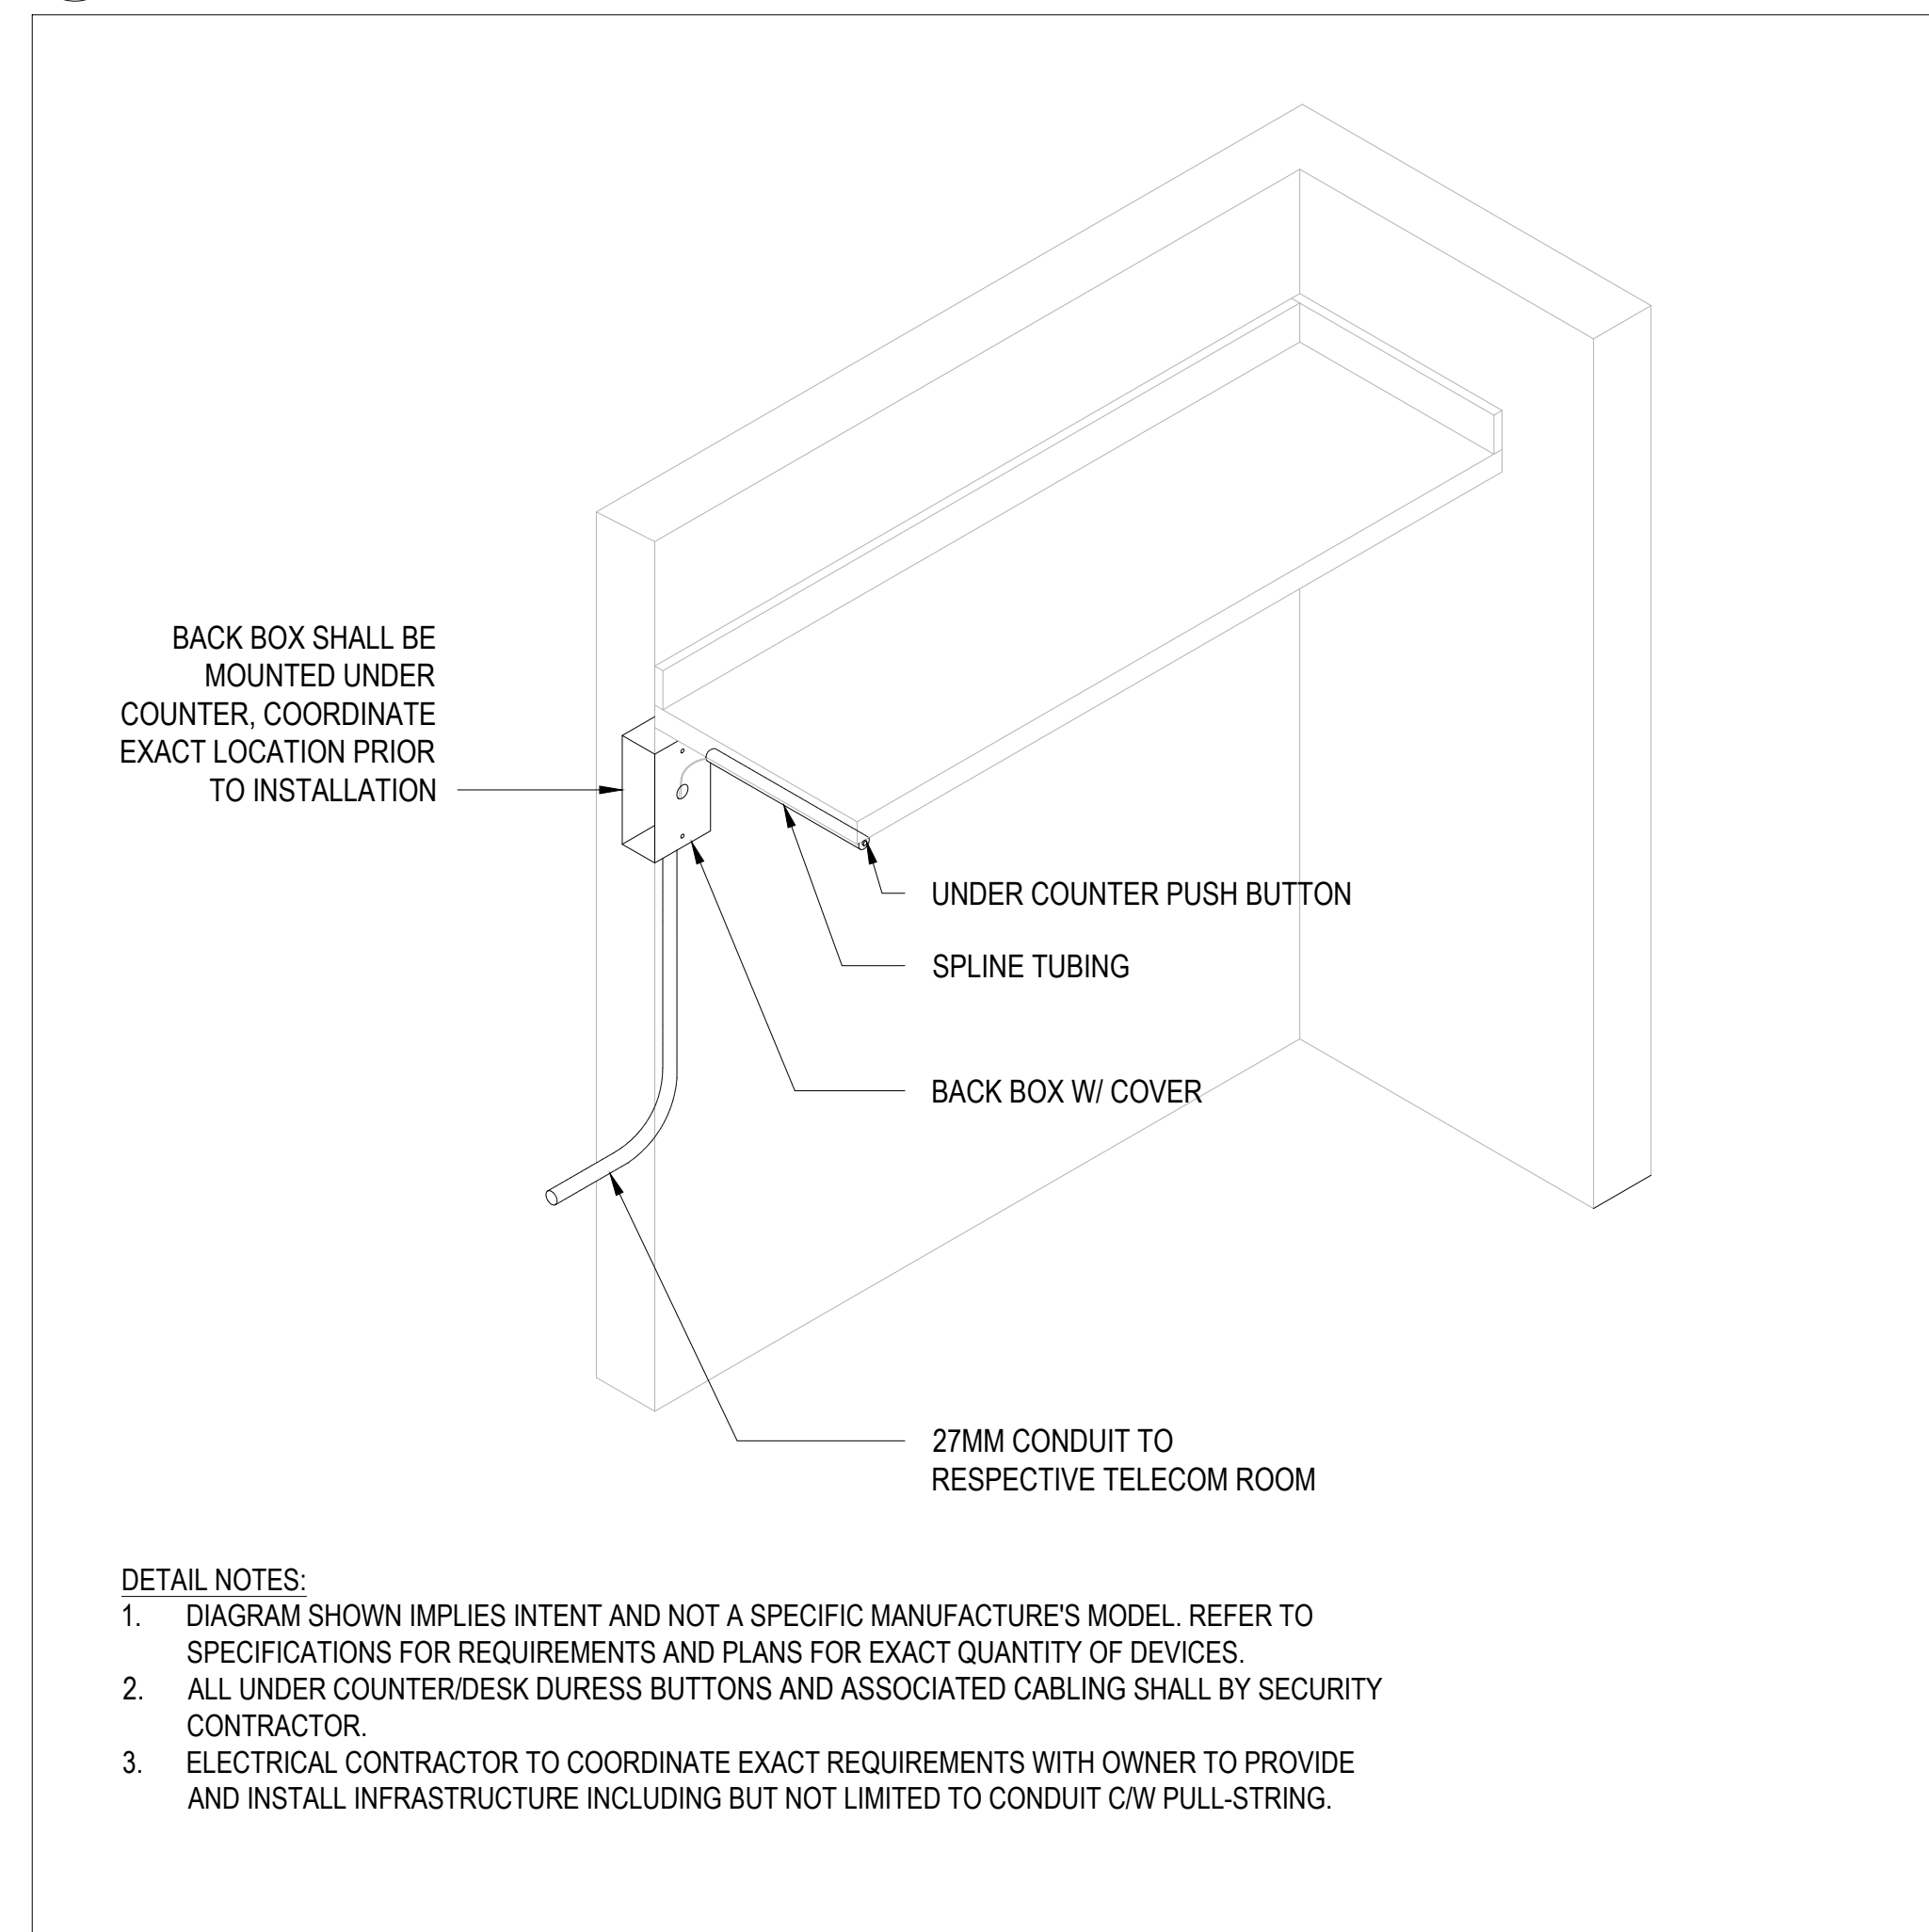

2 UNDER COUNTER/DESK DURESS BUTTON DETAIL
E312 NTS

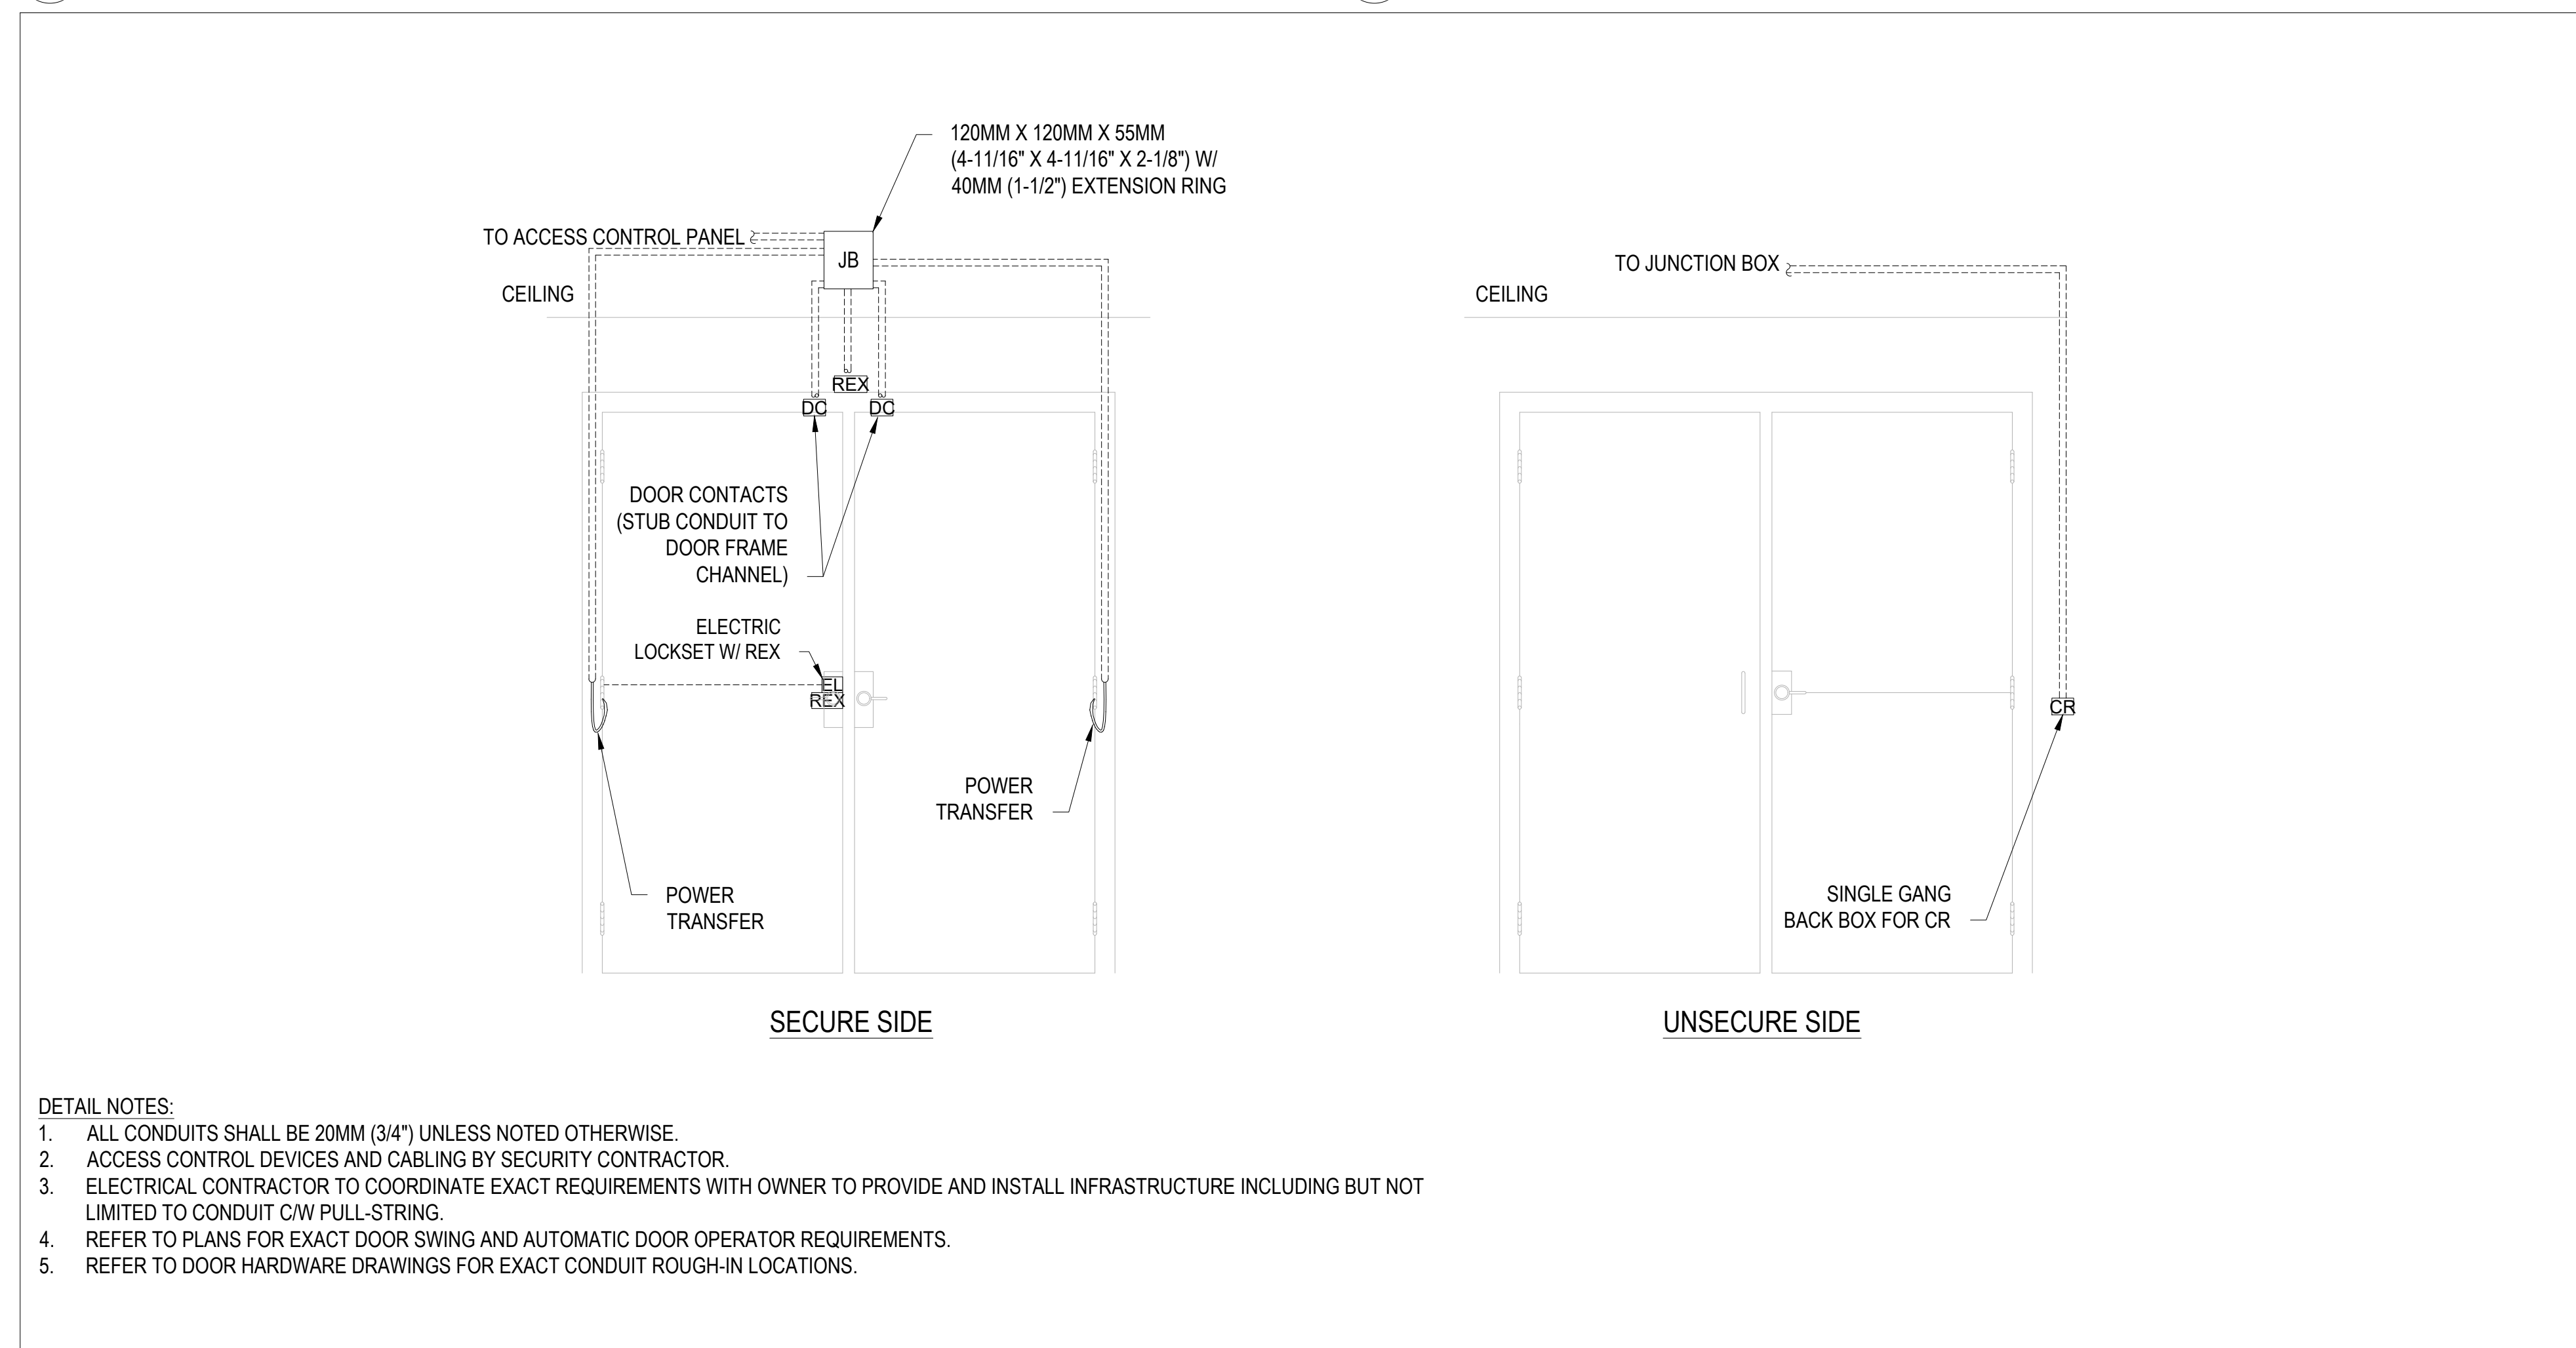

6 DOUBLE DOOR WITH ELECTRIFIED LOCK DETAIL
E312 NTS

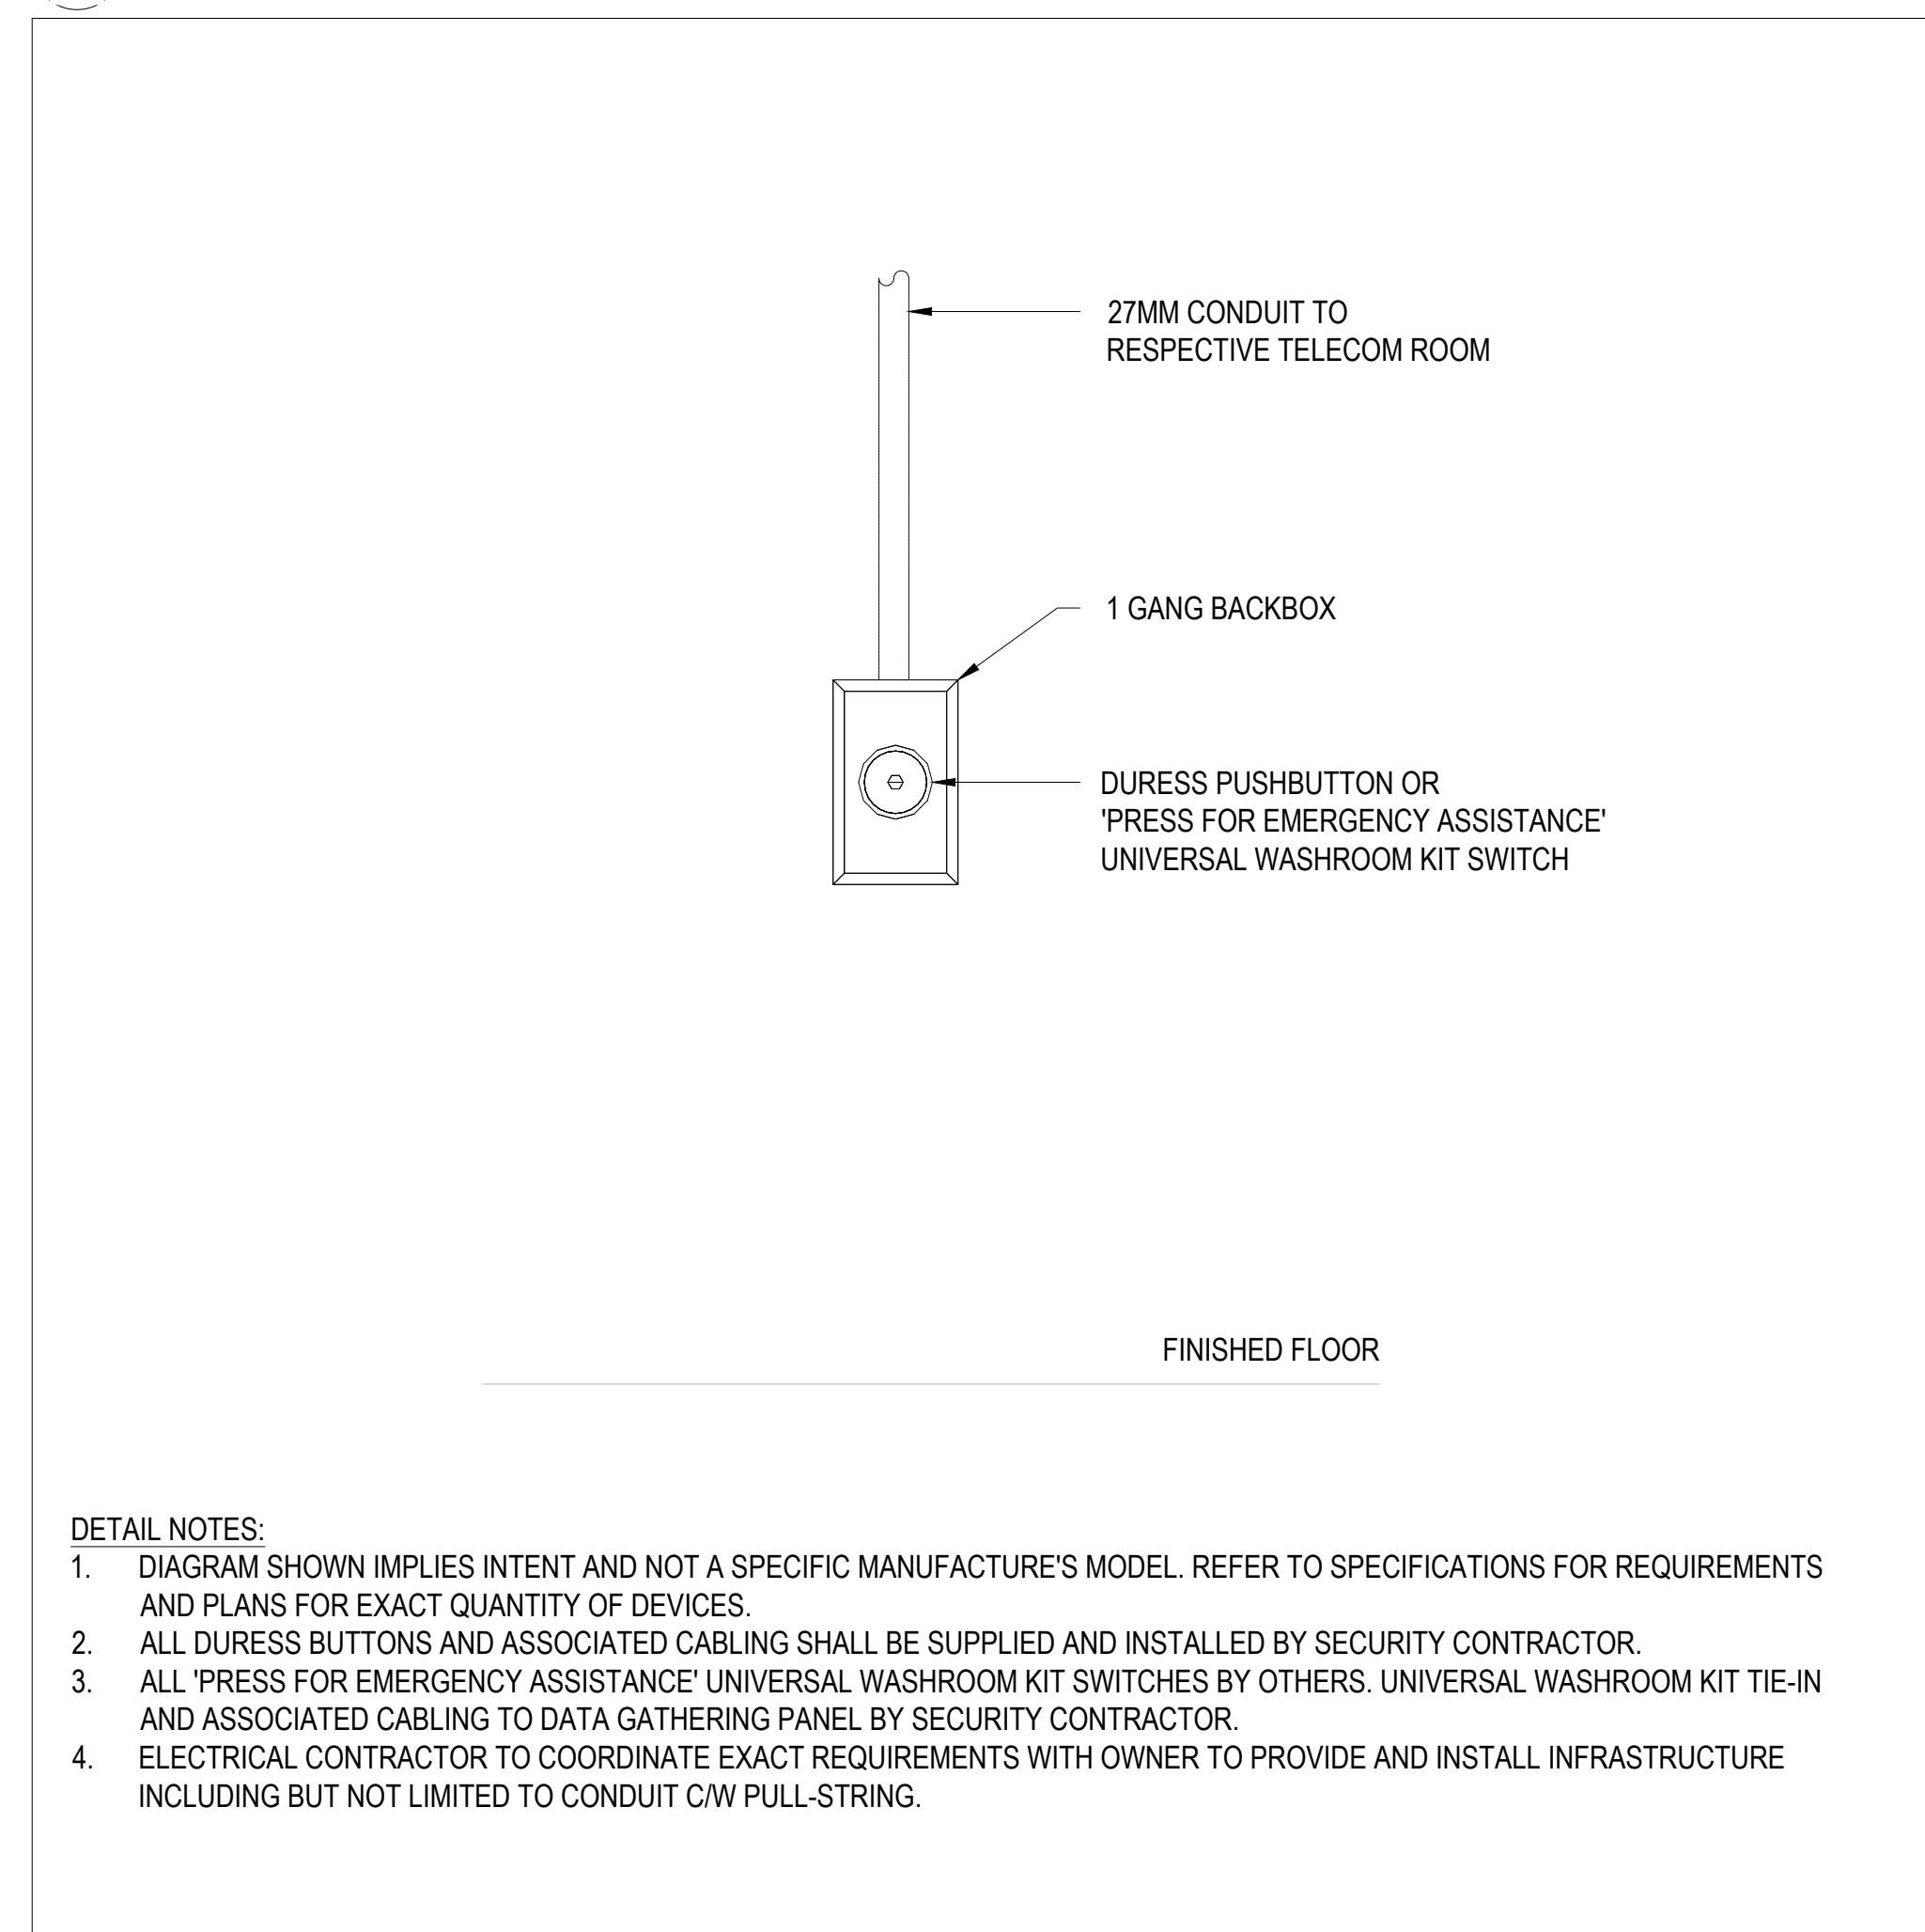

3 DURESS BUTTON DETAIL
E312 NTS

[illegible]

5.	ISSUED FOR TENDER	2026.05.01
4.	ISSUED FOR BUILDING PERMIT	2026.04.08
3.	ISSUED FOR 100% CLIENT REVIEW	2026.03.31
2.	ISSUED FOR 66% CLIENT REVIEW	2026.01.09
1.	ISSUED FOR COSTING REVIEW	2025.11.24
NO.	DESCRIPTION	DATE

PROJECT



REGION OF PEEL

EMIL V. KOLB CENTRE
PEEL REGIONAL POLICE FACILITY
INTERIOR RENOVATION PROJECT
180 DERRY ROAD EAST, MISSISSAUGA, ON L5T 2Y5



The contractor shall check and verify all dimensions and report all errors and omissions to the architect and the design professional whose seal is affixed to this drawing. Do not scale the drawings.

This drawing shall not be used for construction purposes until issued for construction by the design professional whose seal is affixed to this drawing and whose signature is below.

NORTH	ISSUED FOR CONSTRUCTION	DATE
	STRUCTURAL CONSULTANT	
	Stephenson Engineering	
	MECHANICAL CONSULTANT	
SOUTH	EXP Services Inc.	
	ELECTRICAL CONSULTANT	
	EXP Services Inc.	

SHEET TITLE

TECHNOLOGY DETAILS

SHEET NO.	DRAWN BY	CHECKED
	SS/1	M

E312	DATE	FILE
	PROJECT NO.	

E312	MRK-25008951-A0
	SCALE

	SCALE
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PANEL NAME: PB-3				PHASE VOLTAGE [V]				120/LOAD A [KW]			
LOCATION: ELEC CLOSE B0297 - BASEMENT FLOOR				LINE VOLTAGE [V]				LOAD B [KW]			
FED FROM: PANEL PPB-1				PHASE				LOAD C [KW]			
				WIRE:				TOTAL KW			
				MANS (A)				222 CURRENT A (A)			
				MAIN BREAKER (A)				CURRENT B (A)			
				LC (CA)				CURRENT C (A)			
DESCRIPTION	CONN (NO)	D (NO)	DEMAND LOAD	BKR (NO)	CCT (A)	CCT (NO)	BKR (NO)	DEMAND LOAD	CONN (NO)	D (NO)	DESCRIPTION
EXISTING LOAD	0	100	0	15	1	A	2	15	0	100	EXISTING LOAD
TOILETS, WR B0130	0	100	0	15	3	A	5	15	0	100	EXISTING LOAD
SNKS, WR B0131	0	100	0	15	5	C	6	15	0	100	EXISTING LOAD
GR RECEP TABLES, WR B0131	0	100	0	15	7	A	8	15	0	100	EXISTING LOAD
HAND DRYER	0	100	0	15	9	B	10	15	0	100	HAND DRYER
HAND DRYER	0	100	0	15	11	C	12	15	0	100	HAND DRYER
SPARE	0	100	0	15	13	A	14	15	0	100	SPARE
SPARE	0	100	0	15	15	B	16	15	0	100	SPARE
SPARE	0	100	0	15	17	C	18	15	0	100	SPARE
SPARE	0	100	0	15	19	A	20	15	0	100	SPARE
SPARE	0	100	0	15	21	B	22	15	0	100	SPARE
SPARE	0	100	0	15	23	C	24	15	0	100	SPARE
SPARE	0	100	0	15	25	A	26	15	0	100	SPARE
EXISTING LOAD	0	100	0	15	27	B	28	15	0	100	SPARE
EXISTING LOAD	0	100	0	15	29	C	30	15	0	100	SPARE
EXISTING LOAD	0	100	0	15	31	A	32	15	0	100	SPARE
EXISTING LOAD	0	100	0	15	33	B	34	20	0	100	EXISTING LOAD
EXISTING LOAD	0	100	0	20	35	C	36	15	0	100	EXISTING LOAD
EXISTING LOAD	0	100	0	20	37	A	38	15	0	100	EXISTING LOAD
EXISTING LOAD	0	100	0	20	39	B	40	15	0	100	EXISTING LOAD
EXISTING LOAD	0	100	0	20	41	C	42	15	0	100	EXISTING LOAD
TOILETS, WR B0130	0	100	0	15	43	A	44	15	0	100	EXISTING LOAD
EXISTING LOAD	0	100	0	15	45	B	46	15	0	100	EXISTING LOAD
GR RECEP TABLES, WR B0131/B0130	0	100	0	15	47	C	48	15	0	100	EXISTING LOAD
EXISTING LOAD	0	100	0	15	49	A	50	15	0	100	EXISTING LOAD
EXISTING LOAD	0	100	0	15	51	B	52	15	0	100	EXISTING LOAD
EXISTING LOAD	0	100	0	15	53	C	54	15	0	100	EXISTING LOAD
EXISTING LOAD	0	100	0	20	55	A	56	15	0	100	GR RECEP TABLES, WR B0134/B0130
EXISTING LOAD	0	100	0	15	57	B	58	15	0	100	TOILETS, WR B0134/B0130
TOILETS AND SNKS, WR B0134/B0130	0	100	0	15	59	C	60	15	0	100	SNKS, WR B0134
EXISTING LOAD	0	100	0	15	61	A	62	15	0	100	TOILETS, WR B0134
EXISTING LOAD	0	100	0	15	63	B	64	15	0	100	EXISTING LOAD
EXISTING LOAD	0	100	0	15	65	C	66	15	0	100	EXISTING LOAD
EXISTING LOAD	0	100	0	15	67	A	68	15	0	100	EXISTING LOAD
EXISTING LOAD	0	100	0	15	69	B	70	15	0	100	EXISTING LOAD
EXISTING LOAD	0	100	0	15	71	C	72	15	0	100	SPARE
SPARE	0	100	0	15	73	A	74	0	0	100	SPACE
SPARE	0	100	0	15	75	B	76	0	0	100	SPACE
SPARE	0	100	0	15	77	C	78	0	0	100	SPACE
SPARE	0	100	0	15	79	A	80	0	0	100	SPACE
SPARE	0	100	0	15	81	B	82	0	0	100	SPACE
SPARE	0	100	0	15	83	A	84	0	0	100	SPACE

3	PANEL PB3
E402	SCALE: N.T.S.

PANEL NAME: P73		PHASE VOLTAGE [V]		120/LOAD A [KW]								
LOCATION: SECOND FLOOR		VIN LINE VOLTAGE [V]		208/LOAD B [KW]								
FED FROM: PANEL P72		PHASE WIRE:		240/LOAD C [KW]								
		MAINS [A]		TOTAL [KW]								
		MAIN BREAKER [A]		CURRENT A [A]								
		I.C. [N/A]		CURRENT B [A]								
				CURRENT C [A]								
DESCRIPTION	CONC LOADS	D [%]	LOADS	D [%]	DESCRIPTION							
EXISTING LOAD	0	100	0	15	1	A	2	15	0	0	100	EXISTING LOAD
EXISTING LOAD	0	100	0	15	3	B	4	15	0	0	100	EXISTING LOAD
EXISTING LOAD	0	100	0	15	5	C	6	15	0	0	100	EXISTING LOAD
EXISTING LOAD	0	100	0	15	7	A	8	15	0	0	100	EXISTING LOAD
EXISTING LOAD	0	100	0	15	9	B	10	15	0	0	100	EXISTING LOAD
EXISTING LOAD	0	100	0	15	11	C	12	15	0	0	100	EXISTING LOAD
EXISTING LOAD	0	100	0	15	13	A	14	15	0	0	100	EXISTING LOAD
EXISTING LOAD	0	100	0	15	15	B	16	15	0	0	100	EXISTING LOAD
EXISTING LOAD	0	100	0	15	17	C	18	15	0	0	100	EXISTING LOAD
EXISTING LOAD	0	100	0	15	19	A	20	15	0	0	100	EXISTING LOAD
EXISTING LOAD	0	100	0	15	21	B	22	15	0	0	100	EXISTING LOAD
EXISTING LOAD	0	100	0	15	23	C	24	15	0	0	100	EXISTING LOAD
EXISTING LOAD	0	100	0	15	25	A	26	15	0	0	100	EXISTING LOAD
EXISTING LOAD	0	100	0	15	27	B	28	15	0	0	100	EXISTING LOAD
EXISTING LOAD	0	100	0	15	29	C	30	15	0	0	100	EXISTING LOAD
EXISTING LOAD	0	100	0	15	31	A	32	15	0	0	100	GFI RECEPTACLES
EXISTING LOAD	0	100	0	15	33	B	34	15	0	0	100	GFI RECEPTACLE
EXISTING LOAD	0	100	0	15	35	C	36	15	0	0	100	EXISTING LOAD
EXISTING LOAD	0	100	0	15	37	A	38	15	0	0	100	EXISTING LOAD
EXISTING LOAD	0	100	0	15	39	B	40	15	0	0	100	EXISTING LOAD
EXISTING LOAD	0	100	0	15	41	C	42	15	0	0	100	WIR 400
EXISTING LOAD	0	100	0	15	43	A	44	15	0	0	100	EXISTING LOAD
WIR 300	0	100	0	15	45	B	46	15	0	0	100	WIR 300S
WIR 400	0	100	0	15	47	C	48	15	0	0	100	EXISTING LOAD
HAND DRYER	0	100	0	15	49	A	50	15	0	0	100	SPARE
HAND DRYER	0	100	0	15	51	B	52	15	0	0	100	SPARE
HAND DRYER	0	100	0	15	53	C	54	15	0	0	100	SPARE
SPARE	0	100	0	15	55	A	56	15	0	0	100	SPARE
SPARE	0	100	0	15	57	B	58	15	0	0	100	SPARE
SPARE	0	100	0	15	59	C	60	20	0	0	100	SPARE
SPARE	0	100	0	15	61	A	62	15	0	0	100	SPARE
SPARE	0	100	0	15	63	B	64	15	0	0	100	SPARE
SPARE	0	100	0	15	65	C	66	15	0	0	100	SPARE
SPARE	0	100	0	15	67	A	68	15	0	0	100	SPARE
SPARE	0	100	0	15	69	B	70	15	0	0	100	SPARE
SPARE	0	100	0	15	71	C	72	15	0	0	100	SPARE
SPARE	0	100	0	15	73	A	74	15	0	0	100	SPARE
SPARE	0	100	0	15	75	B	76	15	0	0	100	SPARE
SPARE	0	100	0	15	77	C	78	15	0	0	100	SPARE
SPACE	79		A	80								SPACE
SPACE	81		B	82								SPACE
SPACE	83		C	84								SPACE

2	PANEL PT3
E402	SCALE: N.T.S.

PANEL NAME: PG-1 LOCATION: ELEC ROOM 1185 - FIRST FLOOR FED FROM: PANEL PPG-1				PHASE VOLTAGE [V] LINE VOLTAGE [V] PHASE WIRE MANS [A] MAIN BREAKER [A]				120(LAO) A (KW) 208(LAO B) (KW) 3 LOAD C (KW) TOTAL (KW) 228 CURRENT [A] CURRENT [A] CURRENT [A]				DESCRIPTION			
DESCRIPTION	CONN LOADS [W]	D.F [N]	DEMAND LOAD [A]	BKR NO	CCT [A]	CCT NO	BKR LOADS [W]	CONN LOADS [W]	D.F [N]	DEMAND LOAD [A]	BKR NO	CCT [A]	CCT NO	BKR LOADS [W]	DESCRIPTION
EXISTING LOAD	0	100	0	15	1	A	2	15	0	0	100	SPARE			
EXISTING LOAD	0	100	0	15	3	B	8	4	0	0	100	SPARE			
EXISTING LOAD	0	100	0	15	5	C	6	15	0	0	100	SPARE			
EXISTING LOAD	0	100	0	15	7	A	8	15	0	0	100	EXISTING LOAD			
EXISTING LOAD	0	100	0	15	9	B	10	15	0	0	100	EXISTING LOAD			
EXISTING LOAD	0	100	0	15	11	C	12	15	0	0	100	EXISTING LOAD			
SINKS, WR 1138	0	100	0	15	13	A	14	15	0	0	100	TOILETS, WR 1138			
EXISTING LOAD	0	100	0	15	15	B	16	15	0	0	100	TOILETS, WR 1138			
GR RECEPTACLES, WR 1137/1138	0	100	0	15	17	C	18	15	0	0	100	EXISTING LOAD			
EXISTING LOAD	0	100	0	15	19	A	20	15	0	0	100	EXISTING LOAD			
EXISTING LOAD	0	100	0	15	21	B	22	15	0	0	100	EXISTING LOAD			
EXISTING LOAD	0	100	0	15	23	C	24	15	0	0	100	EXISTING LOAD			
EXISTING LOAD	0	100	0	15	25	A	26	15	0	0	100	RECEPTACLES, G-16 TREATMENT ROOM			
EXISTING LOAD	0	100	0	15	27	B	28	15	0	0	100	RECEPTACLES, G-16 HEALTH ROOM			
SINKS, WR 1137	0	100	0	15	29	C	30	15	0	0	100	EXISTING LOAD			
RECEPTACLES, G-16 FITNESS UNIT	0	100	0	15	31	A	32	15	0	0	100	EXISTING LOAD			
RECEPTACLES, G-16 FITNESS UNIT	0	100	0	15	33	B	34	15	0	0	100	RECEPTACLES, G-16 FITNESS UNIT			
RECEPTACLES, G-16 BREAKFAST ROOM	0	100	0	15	35	C	36	15	0	0	100	RECEPTACLES, G-16G-16			
RECEPTACLES, G-16 FITNESS UNIT	0	100	0	15	37	A	38	15	0	0	100	RECEPTACLES, KITCHENETTE 1096			
GR RECEPTACLES, KITCHENETTE 1096	0	100	0	15	39	B	40	15	0	0	100	GR RECEPTACLES, LUNCH ROOM 1095			
RECEPTACLES, KITCHENETTE 1096	0	100	0	15	41	C	42	15	0	0	100	EXISTING LOAD			
EXISTING LOAD	0	100	0	15	43	A	44	15	0	0	100	RECEPTACLES, LUNCH ROOM 1095			
DISPLAY RECEPTACLES, LUNCH ROOM 1095	0	100	0	15	45	B	46	15	0	0	100	RECEPTACLES, LUNCH ROOM 1095			
FRIDGE RECEPTACLE, LUNCH ROOM 1095	0	100	0	15	47	C	48	15	0	0	100	FRIDGE RECEPTACLE, LUNCH ROOM 1095			
WR ADD	0	100	0	15	49	A	50	15	0	0	100	HAND DRYER			
WR ADD	0	100	0	15	51	B	52	15	0	0	100	HAND DRYER			
WR ADD	0	100	0	15	53	C	54	15	0	0	100	HAND DRYER			
SPARE	0	100	0	15	55	A	56	15	0	0	100	HAND DRYER			
SPARE	0	100	0	15	57	B	58	15	0	0	100	SPARE			
SPARE	0	100	0	15	59	C	60	15	0	0	100	SPARE			
SPARE	0	100	0	15	61	A	62	15	0	0	100	SPARE			
SPARE	0	100	0	15	63	B	64	15	0	0	100	SPARE			
SPARE	0	100	0	15	65	C	66	15	0	0	100	SPARE			
SPARE	0	100	0	15	67	A	68	15	0	0	100	SPARE			
SPARE	0	100	0	15	69	B	70	15	0	0	100	SPARE			
SPARE	0	100	0	15	71	C	72	15	0	0	100	SPARE			
SPARE	0	100	0	15	73	A	74	15	0	0	100	SPARE			
SPARE	0	100	0	40	75	B	76	20	0	0	100	SPARE			
SPARE	0	100	0	41	77	C	78	20	0	0	100	SPARE			
SPARE	0	100	0	15	79	A	80	15	0	0	100	SPARE			
SPARE	0	100	0	15	81	B	82	15	0	0	100	SPARE			
SPARE	0	100	0	15	83	C	84	15	0	0	100	SPARE			

1	PANEL PG1
E402	SCALE: N.T.S.

PANEL NAME: PG2 LOCATION: ELECTRICAL CLOSET 1178 FED FROM: PANEL PPG-1				PHASE VOLTAGE [V]: LINE VOLTAGE [V] PHASE WIRE: MAINS [A] MAIN BREAKER [A] C [A]				120[LOAD A [KW]] 204[LOAD B [KW]] 300[LOAD C [KW]] 4 TOTAL [KW] 222 CURRENT A [A] CURRENT B [A] CURRENT C [A]				D [T] DESCRIPTION [N]			
DESCRIPTION	CONN [LOAD/V]	D [%]	DEMAND [LOAD]	BKRS [A]	CCT [A]	Ø	CCT	Ø	BKRS [A]	DEMAND [CONN [LOAD/V]	D [%]	DESCRIPTION [N]			
EXISTING LOAD	0	100	0	15	1	A	2	20	0	0	100	EXISTING LOAD			
SPARE	0	100	0	15	3	B	4	15	0	0	100	EXISTING LOAD			
SPARE	0	100	0	15	5	C	6	15	0	0	100	EXISTING LOAD			
EXISTING LOAD	0	100	0	15	7	A	8	15	0	0	100	RECEPTACLES - G-22/G-23/G-24			
EXISTING LOAD	0	100	0	15	9	B	10	15	0	0	100	RECEPTACLES - G-20/G-23/G-24			
EXISTING LOAD	0	100	0	20	11	C	12	12	0	0	100	EXISTING LOAD			
EXISTING LOAD	0	100	0	20	13	A	14	15	0	0	100	EXISTING LOAD			
EXISTING LOAD	0	100	0	15	15	B	16	15	0	0	100	EXISTING LOAD			
RECEPTACLES - G-20	0	100	0	15	17	C	18	15	0	0	100	RECEPTACLES - G-20a			
EXISTING LOAD	0	100	0	15	19	A	20	15	0	0	100	EXISTING LOAD			
EXISTING LOAD	0	100	0	15	21	B	22	15	0	0	100	EXISTING LOAD			
RECEPTACLES - G-20	0	100	0	15	23	C	24	15	0	0	100	EXISTING LOAD			
RECEPTACLES - G-20	0	100	0	15	25	A	26	15	0	0	100	EXISTING LOAD			
EXISTING LOAD	0	100	0	15	27	B	28	15	0	0	100	EXISTING LOAD			
EXISTING LOAD	0	100	0	15	29	C	30	15	0	0	100	EXISTING LOAD			
EXISTING LOAD	0	100	0	15	31	A	32	15	0	0	100	SPARE			
EXISTING LOAD	0	100	0	15	33	B	34	15	0	0	100	EXISTING LOAD			
EXISTING LOAD	0	100	0	15	35	C	36	15	0	0	100	EXISTING LOAD			
EXISTING LOAD	0	100	0	15	37	A	38	15	0	0	100	EXISTING LOAD			
EXISTING LOAD	0	100	0	15	39	B	40	15	0	0	100	EXISTING LOAD			
SPARE	0	100	0	15	41	C	42	15	0	0	100	SPARE			
EXISTING LOAD	0	100	0	15	43	A	44	15	0	0	100	EXISTING LOAD			
EXISTING LOAD	0	100	0	15	45	B	46	15	0	0	100	EXISTING LOAD			
SPARE	0	100	0	15	47	C	48	15	0	0	100	EXISTING LOAD			
SPARE	0	100	0	15	49	A	50	15	0	0	100	SPARE			
SPARE	0	100	0	15	51	B	52	15	0	0	100	SPARE			
SPARE	0	100	0	15	53	C	54	15	0	0	100	SPARE			
EXISTING LOAD	0	100	0	15	55	A	56	15	0	0	100	SPARE			
EXISTING LOAD	0	100	0	15	57	B	58	15	0	0	100	SPARE			
EXISTING LOAD	0	100	0	15	59	C	60	15	0	0	100	SPARE			
SPARE	0	100	0	15	61	A	62	15	0	0	100	SPARE			
SPARE	0	100	0	15	63	B	64	15	0	0	100	SPARE			
SPARE	0	100	0	15	65	C	66	15	0	0	100	SPARE			
SPARE	0	100	0	15	67	A	68	15	0	0	100	SPARE			
SPARE	0	100	0	15	69	B	70	15	0	0	100	SPARE			
SPARE	0	100	0	15	71	C	72	15	0	0	100	SPARE			
SPARE	0	100	0	15	73	A	74	15	0	0	100	SPARE			
SPARE	0	100	0	15	75	B	76	15	0	0	100	SPARE			
SPARE	0	100	0	15	77	C	78	15	0	0	100	SPARE			
SPARE	0	100	0	15	79	A	80	15	0	0	100	SPARE			
EXISTING LOAD	0	100	0	15	81	B	82	15	0	0	100	EXISTING LOAD			
					83	C	84								

6	PANEL PG2
E402	SCALE: N.T.S.

PANEL NAME: UPS-G1 LOCATION: ELECTRICAL CLOSET 1185 FED FROM: PANEL UPS-PP1										PHASE VOLTAGE (V) LINE VOLTAGE (V) PHASE WIRE: MANS (A) MAIN BREAKER (A) IC (KA)										120 208 3 4 100 CURRENT (A) CURRENT C (A)										LOAD A (KW) LOAD B (KW) LOAD C (KW) TOTAL (KW) CURRENT A (A) CURRENT B (A) CURRENT C (A)									
DESCRIPTION	CONN LOAD(W)	D F [%]	DEMAND LOAD	BKR [A]	CC1 NO	D	CC2 NO	BKR [A]	DEMAND LOAD(W)	CONN LOAD(W)	D F [%]	DESCRIPTION	CONN LOAD(W)	D F [%]	DEMAND LOAD	BKR [A]	CC1 NO	D	CC2 NO	BKR [A]	DEMAND LOAD(W)	CONN LOAD(W)	D F [%]	DESCRIPTION															
EXISTING LOAD	0	100	0	15	1	A	2	15	0	0	0	100	EXISTING LOAD	0	100	0	15	1	A	2	15	0	0	100	EXISTING LOAD														
EXISTING LOAD	0	100	0	15	3	B	4	15	0	0	0	100	EXISTING LOAD	0	100	0	15	3	B	4	15	0	0	100	EXISTING LOAD														
EXISTING LOAD	0	100	0	15	5	C	6	15	0	0	0	100	EXISTING LOAD	0	100	0	15	5	C	6	15	0	0	100	EXISTING LOAD														
UPS RECEPTACLES, G-16 FITNESS UNIT	0	100	0	15	7	A	8	15	0	0	0	100	EXISTING LOAD	0	100	0	15	7	A	8	15	0	0	100	EXISTING LOAD														
UPS RECEPTACLES, G-16 FITNESS UNIT	0	100	0	15	9	B	10	15	0	0	0	100	EXISTING LOAD	0	100	0	15	9	B	10	15	0	0	100	EXISTING LOAD														
EXISTING LOAD	0	100	0	15	11	C	12	15	0	0	0	100	EXISTING LOAD	0	100	0	15	11	C	12	15	0	0	100	EXISTING LOAD														
EXISTING LOAD	0	100	0	15	13	A	14	20	0	0	0	100	EXISTING LOAD	0	100	0	15	13	A	14	20	0	0	100	EXISTING LOAD														
EXISTING LOAD	0	100	0	20	15	B	16																																
						C	16																																
EXISTING LOAD	0	100	0	20	19	A	20	15	0	0	0	100	EXISTING LOAD	0	100	0	20	19	A	20	15	0	0	100	EXISTING LOAD														
						B	22	20	0	0	0	100	EXISTING LOAD	0	100	0	20																						
EXISTING LOAD	0	100	0	15	25	A	26	20	0	0	0	100	EXISTING LOAD	0	100	0	15	25	A	26	20	0	0	100	EXISTING LOAD														
						B	26																																
EXISTING LOAD	0	100	0	15	29	C	30	15	0	0	0	100	EXISTING LOAD	0	100	0	15	29	C	30	15	0	0	100	EXISTING LOAD														
EXISTING LOAD	0	100	0	15	31	A	32	15	0	0	0	100	EXISTING LOAD	0	100	0	15	31	A	32	15	0	0	100	EXISTING LOAD														
UPS RECEPTACLES, G-16 FITNESS UNIT	0	100	0	15	33	B	34	15	0	0	0	100	SPARE	0	100	0	15	33	B	34	15	0	0	100	SPARE														
UPS RECEPTACLES, G-16 FITNESS UNIT	0	100	0	15	35	C	36	15	0	0	0	100	SPARE	0	100	0	15	35	C	36	15	0	0	100	SPARE														
SPARE	0	100	0	15	37	A	38	15	0	0	0	100	SPARE	0	100	0	15	37	A	38	15	0	0	100	SPARE														
SPARE	0	100	0	15	39	B	40	15	0	0	0	100	SPARE	0	100	0	15	39	B	40	15	0	0	100	SPARE														
SPARE	0	100	0	15	41	C	42	15	0	0	0	100	SPARE	0	100	0	15	41	C	42	15	0	0	100	SPARE														

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PANEL UPS-G1

E402 SCALE N.T.S.

PANEL NAME: UPS-G2 LOCATION: ELECTRICAL CLOSET 178-179 FED FROM: PANEL UPS-PP1				PHASE VOLTAGE [V]: 120 LINE VOLTAGE [V]: 208 LOAD A [KW]: 2 LOAD B [KW]: 4 LOAD C [KW]: 6 4 TOTAL [KW] 100 CURRENT A [A]: CURRENT B [A]: CURRENT C [A]						
DESCRIPTION	CONN LOAD[W]	D F [%]	DEMAND LOAD	BKR [A]	DCT NO	B	CT [A]	BKR DEMAND LOAD[W]	D F [%]	DESCRIPTION
EXISTING LOAD	0	100	0	15	1	A	2	15	0	100 UPS RECEPTACLES, G-20
EXISTING LOAD	0	100	0	15	3	B	4	15	0	100 EXISTING LOAD
EXISTING LOAD	0	100	0	15	5	C	6	15	0	100 EXISTING LOAD
UPS RECEPTACLES, G-22a	0	100	0	15	7	A	8	15	0	100 EXISTING LOAD
EXISTING LOAD	0	100	0	15	9	B	10	15	0	100 EXISTING LOAD
EXISTING LOAD	0	100	0	15	11	C	12	15	0	100 EXISTING LOAD
EXISTING LOAD	0	100	0	15	13	A	14	15	0	100 EXISTING LOAD
UPS RECEPTACLES, G-22	0	100	0	15	15	B	16	15	0	100 UPS RECEPTACLES, G-20
UPS RECEPTACLES, G-20	0	100	0	15	15	B	16	15	0	100 UPS RECEPTACLES, G-20
SPARE	0	100	0	15	17	C	18	15	0	100 SPARE
SPARE	0	100	0	15	19	A	20	15	0	100 SPARE
SPARE	0	100	0	15	21	B	22	15	0	100 EXISTING LOAD
SPARE	0	100	0	15	23	C	24	15	0	100 SPARE
SPARE	0	100	0	15	25	A	26	15	0	100 SPARE
SPARE	0	100	0	15	27	B	28	15	0	100 SPARE
SPARE	0	100	0	15	29	C	30	15	0	100 SPARE
SPARE	0	100	0	15	31	A	32	15	0	100 SPARE
SPARE	0	100	0	15	33	B	34	15	0	100 SPARE
SPARE	0	100	0	15	35	C	36	15	0	100 SPARE
SPARE	0	100	0	15	37	A	38	15	0	100 SPARE
SPARE	0	100	0	15	39	B	40	15	0	100 SPARE
SPARE	0	100	0	15	41	C	42	15	0	100 SPARE

4	PANEL UPS-G2
E402	SCALE N.T.S.

[illegible]

5.	ISSUED FOR TENDER	2026.05.01
4.	ISSUED FOR BUILDING PERMIT	2026.04.08
3.	ISSUED FOR 100% CLIENT REVIEW	2026.03.31
2.	ISSUED FOR 66% CLIENT REVIEW	2026.01.09
1.	ISSUED FOR COSTING REVIEW	2025.11.24
NO.	DESCRIPTION	DATE



REGION OF PEEL

EMIL V. KOLB CENTRE
PEEL REGIONAL POLICE FACILITY
INTERIOR RENOVATION PROJECT
180 DERRY ROAD EAST, MISSISSAUGA, ON L5T 2Y5



NORTH	ISSUED FOR CONSTRUCTION	DATE
	STRUCTURAL CONSULTANT Stephenson Engineering	
	MECHANICAL CONSULTANT EXP Services Inc.	
	ELECTRICAL CONSULTANT EXP Services Inc.	

SHEET TITLE	
PANEL SCHEDULES	

SHEET NO. E402	DRAWN BY SS/LL	CHECKED KE
	PROJECT NO. MRK-25008951-A0	
	SCALE	